PHASE

1" TYPE K COPPER WATER (STA 1+28±)

INSPECTOR KRABEY (1310)

PLAN NOTES

THE PROPERTY LINE AND TOPOGRAPHIC INFORMATION SHOWN ON THIS PLAN IS BASED ON AN ACTUAL INSTRUMENT SURVEYS PERFORMED BY NORWOOD ENGINEERING COMPANY, INC. BETWEEN MAY OF 2018 AND JUNE OF 2019 ALONG WITH RECORD INFORMATION OBTAINED FROM THE CITY OF BOSTON ASSESSING AND ENGINEERING DEPARTMENTS, THE SUFFOLK AND NORFOLK COUNTY REGISTRY OF DEEDS, THE NASSACHUSETTS LAND COURT AND THE BOSTON WATER AND SEWER COMMISSION.

SURVEYS IN THIS AREA AND WILL BE UPDATED WHEN THE TOPOGRAPHIC SURVEY OF THE SITE AND ROADWAY ARE COMPLETED. THE LOCATION O UNDERGROUND UTILITIES ARE APPROXIMATE ONLY, AND ARE NOT WARRANTED TO BE CORRECT. UNDERGROUND UTILITIES ARE SHOWN BASED ON RECORD DATA PROVIDED BY THE OPERATING AUTHORITIES, AND HAVE BEEN FIELD INSPECTED WHERE POSSIBLE. ADDITIONAL UTILITIES MAY EXIST WHICH ARE NOT INDICATED ON THESE PLANS. ALL EXISTING UTILITIES SHALL BE VERIFIED FOR SERVICE, SIZE, INVERT ELEVATION, LOCATIONS, ETC. PRIOR TO NEW CONNECTIONS TO OR RELOCATION OF SAME CONTRACTOR MUST NOTIFY DIG-SAFE AT 1-888-344-7233 AT LEAST 72 HOURS PRIOR TO ANY CONSTRUCTION. NOTIFY THIS FIRM IN WRITING OF ANY AND ALL DISCREPANCIES PRIOR TO COMMENCING ANY WORK. THE BOSTON WATER AND SEWER COMMISSION IS NOT PART OF DIG SAFE THEREFORE, FIELD LOCATIONS OF WATER AND SEWER LINES MUST BE MARKED BY THE COMMISSION. CALL 1-617-330-9400 FORTY EIGHT HOURS IN ADVANCE OF ANY EXCAVATION.

THE EXISTING WATER AND SEWER LOCATIONS SHOWN ARE FROM AVAILABLE BWSC RECORD DATA AND ARE APPROXIMATE ONLY. IT IS THE RESPONSIBILITY OF THE CONTRACTOR TO ACCURATELY LOCATE THE EXISTING WATER AND SEWER LINES. IF THE EXISTING SEWER SERVICE IS TO BE USED THE CONTRACTOR SHALL VISUALLY INSPECT THE LINE BY EXCAVATION AND OR BY VIDEO OF THE PIPE AS REQUIRED BY THE COMMISSION

OWNER INFORMATION FOR THE ABUTTING LOTS SHOWN ON THIS PLAN IS FROM CITY OF BOSTON ASSESSOR'S RECORDS IN JUNE, 2018.

THE NORTON STREET PROJECT WAS ENTERED INTO THE CITY OF BOSTON COBUCS PROGRAM ON SEPTEMBER 21, 2018. THERE WAS A CONFLICT WITH AN ASPHALT RESURFACING PROJECT SCHEDULED FROM JANUARY OF 2016 TO JANUARY OF 2021. THE COMMISSION ALLOWED THE WATER SERVICE TO BE INSTALLED AND THE NEW CURB CUT AND SIDEWALK TO BE BUILT SO PUBLIC WORKS COULD MOVE FORWARD WITH THE PAVING OF NORTON STREET. THE EXCAVATION AREA FOR THE WATER SERVICE IN NORTON STREET WAS APPROXMATELY 60 SQUARE FEET. A GAS SERVICE STUB WAS ALSO RUN ONTO THE SITE TO THE RIGHT OF THE WATER SERVICE. ALL CONSTRUCTION IN THE STREET FOR THE SITE HAS BEEN COMPLETED AND

SEE PLAN PREPARED BY THOMAS WIRTH ASSOCIATES LANDSCAPE ARCHITECTURE ENTITLED "WE GROW MICROGREENS, NORTON ST., HYDE PARK" DATED OCTOBER 10, 2018 FOR PROPOSED BUILDING DIMENSIONS. FARM LAYOUT AND SITE GRADES. THE PROPOSED COMMUNITY WALKING PATH SHOWN ON THE PLAN IS APPROXIMATE ONLY. THE ACTUAL LAYOUT OF THE STONE PATH WILL BE DETERMINED IN THE FIELD BASED ON THE EXISTING TERRAIN AND EXISTING TREE LOCATIONS. THE ABOVE MENTIONED PLAN WAS REVISED AND A NEW PLAN ENTITLED "WE GROW MICROGREENS, NORTON ST., HYDE PARK" DATED APRIL 18, 2019 WAS PREPARED. THE LANDSCAPING PLAN REVISIONS ARE REFLECTED ON THE LATEST SITE PLAN.

THE PROPOSED GREENHOUSE HAS A FLOOR AREA OF 4,850 SQUARE FEET. THE PROPOSED RETAIL BUILDING (50 GAL. PER 1000 S.F.) WILL GENERATE APPROXIMATELY 250 GALLONS OF SEWERAGE PER DAY.

THE BUILDING WILL HAVE A 1" TYPE K COPPER WATER SERVICE THAT RUNS TO A 5/8" METER LOCATED IN A CONCRETE METER PIT INSIDE THE GREENHOUSE. THE PROJECT WILL REQUIRE TWO BACKFLOW PREVENTERS. A 3/4" IRRIGATION LINE WILL FROM RUN AN ABATEMENT METER TO A WATTS 800 BACKFLOW PREVENTER LOCATED OUTSIDE NEAR THE FRONT RIGHT CORNER OF THE BUILDING. THE 3/4" DOMESTIC LINE WILL CONNECT TO A WATTS LF009 BACKFLOW AND RUN TO FACILITIES IN THE WORK AREA AT THE RIGHT REAR CORNER OF THE BUILDING. THE WATER LINES AND BACKFLOW PREVENTERS WERE PROPOSED BY BRIAN CUNNINGHAM OF BC PLUMBING AND HEATING LLC, 17 ATKINS STREET, DEHAM, MA 02062 (P) 781-726-2270.

BENCHMARKS

X-CUT FOUND IN SIDEWALK NEAR THE FRONT LEFT PROPERTY

CONSTRUCTION BENCHMARK: DRILL HOLE "B"


OWNER/APPLICANT: 21 NORTON STREET HYDE PARK MA 02131

CONTACTS: LISA EVANS 617-792-5424 TIM SMITH 617-877-0465

10-30-19

PLAN REFERENCE: SUFFOLK REGISTY BOOK 5662 PAGE END (LOT 295 TO LOT 301)

REVISIONS 08 - 28 - 1909-02-19 09-03-19 10-28-19 REVISIONS PER CLIENT - FOOT PATH, ACCESS ROAD, BACKWATER VALVES

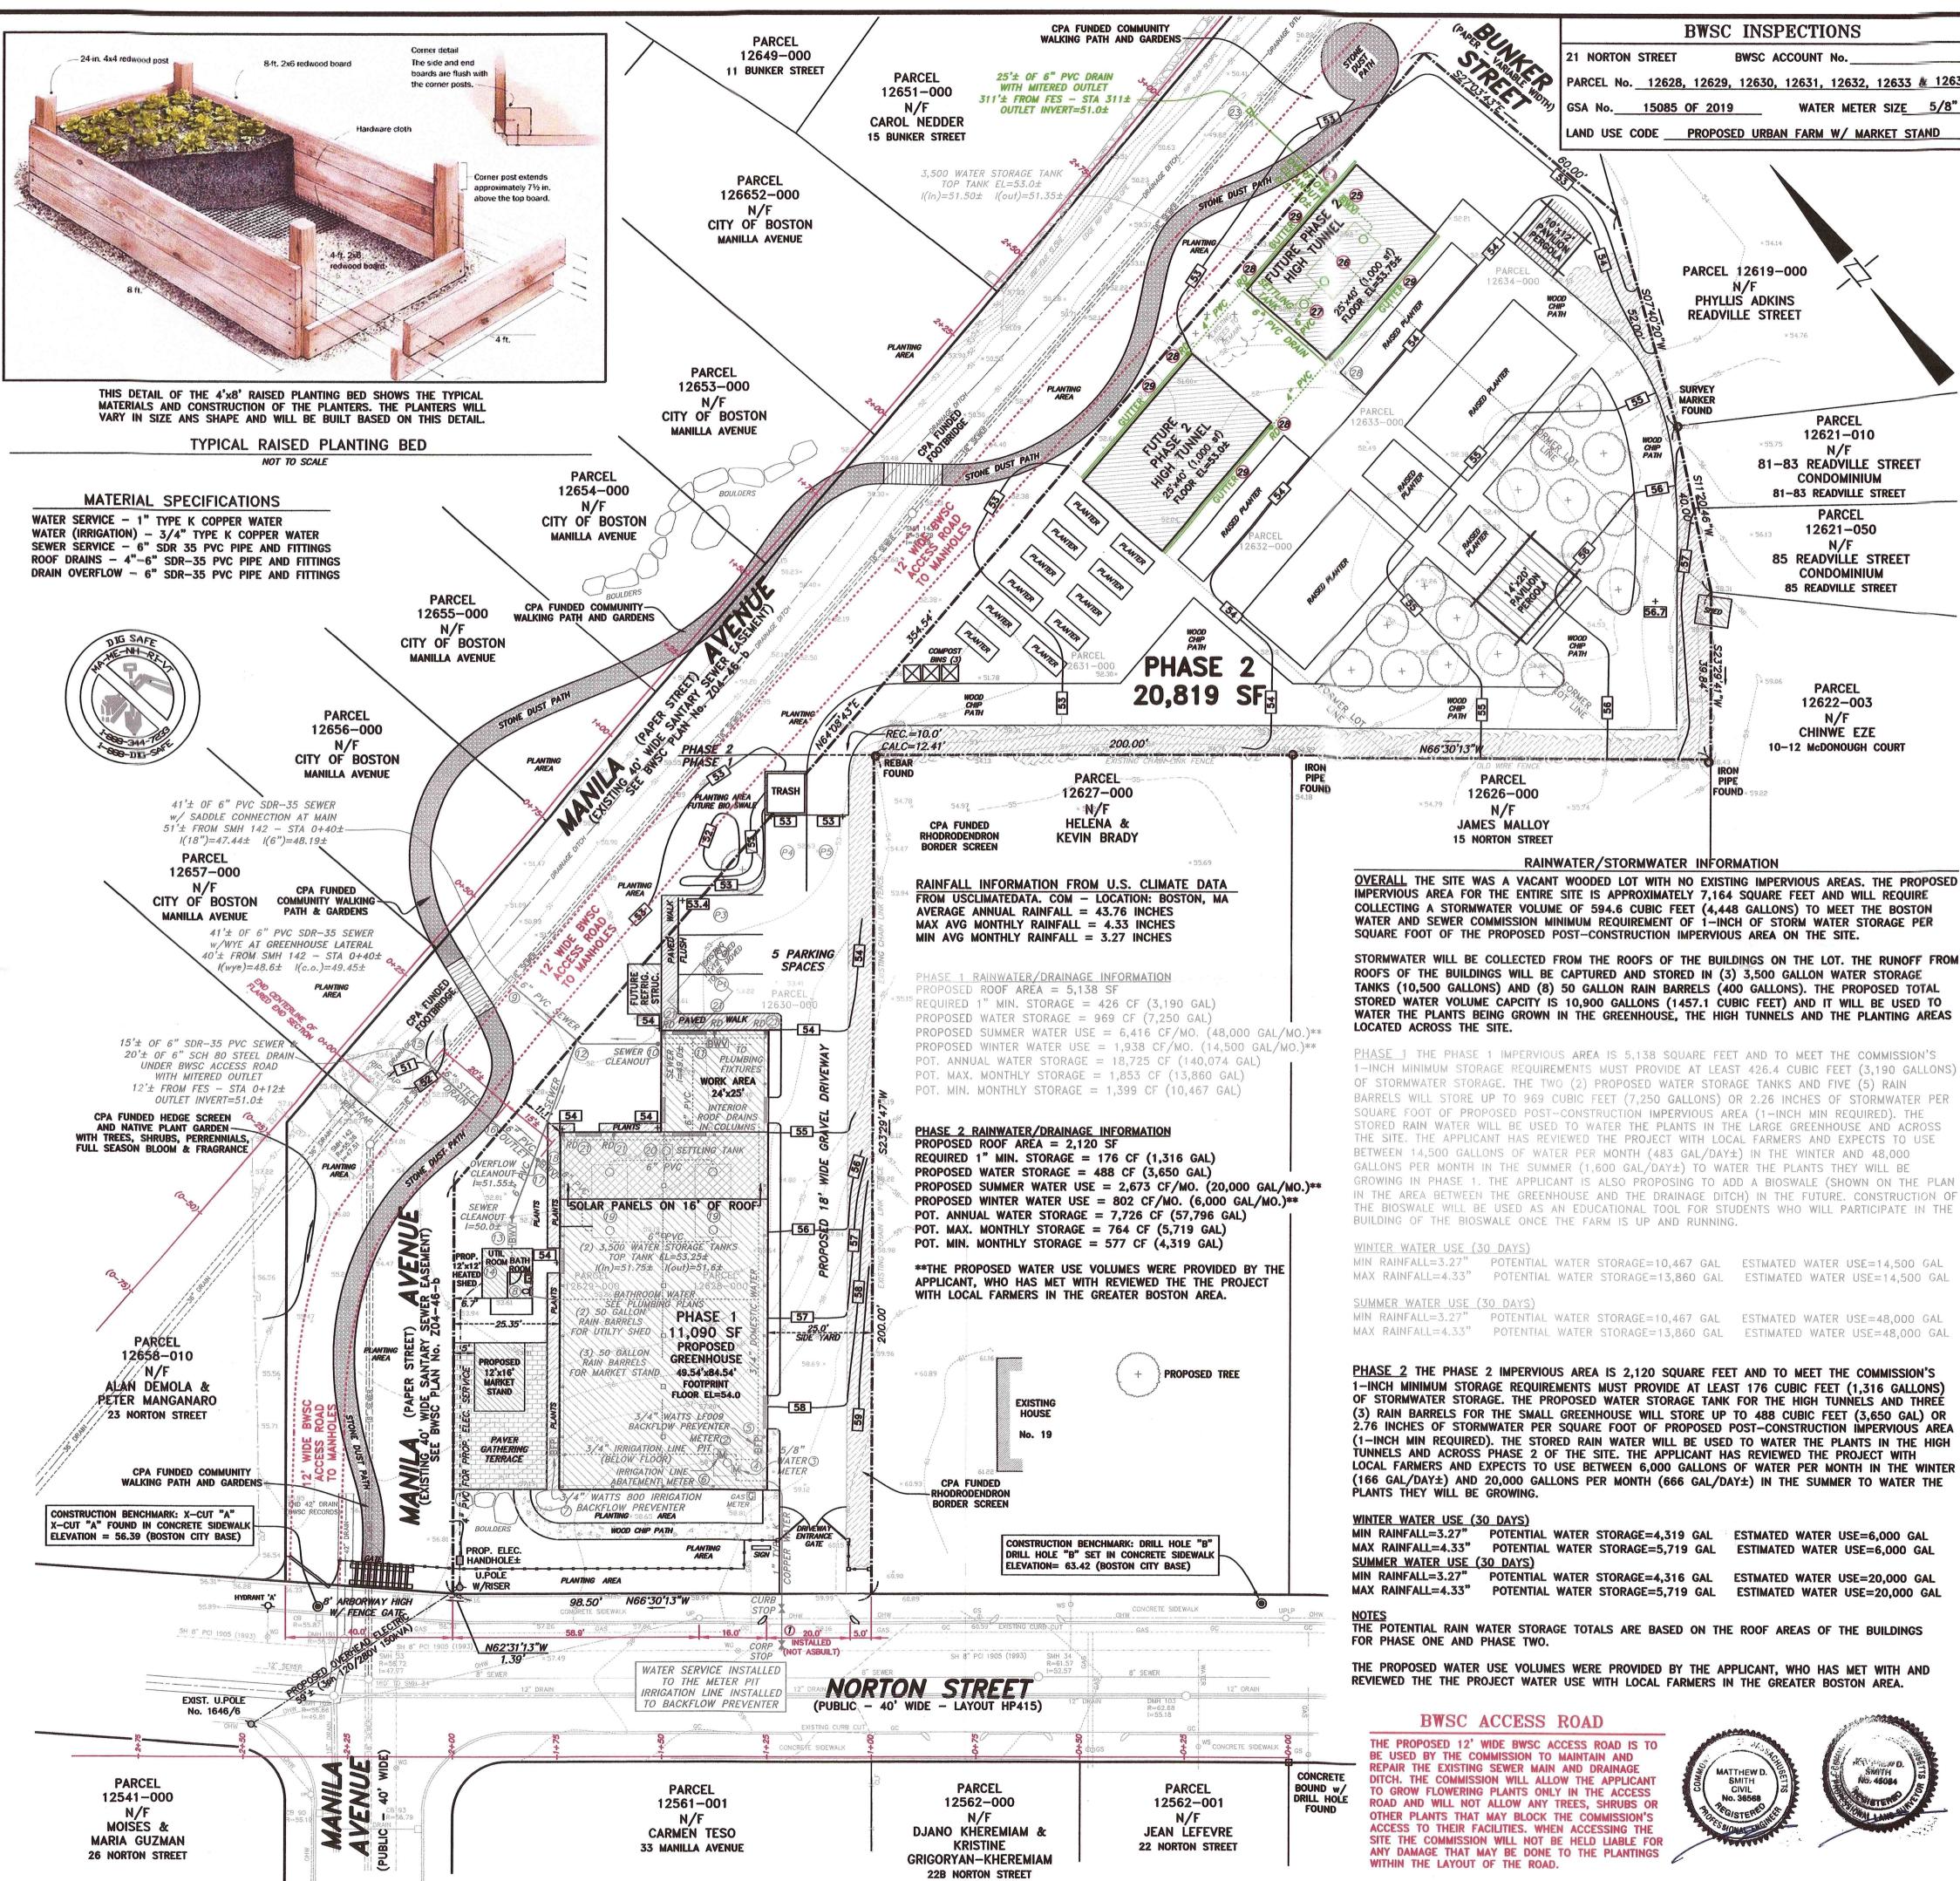

IRRIGATION ABATEMENT METER & MTU (IN METER PIT) 3/4" WATTS LF900 DOMESTIC BACKFLOW PREVENTER (G.HOUSE) 3/4" TYPE K COPPER DOMESTIC PIPE (GREENHOUSE) PARCEL 12619-000 WATER CONNECTION TO HEATED UTILITY SHED (w/BATHROOM) PHYLLIS ADKINS READVILLE STREET 3/4" TYPE K COPPER IRRIGATION PIPE (GREENHOUSE) 41' OF 6" PVC SDR-35 SEWER w/SADDLE CONN. (STA 0+40±) SEWER CLEANOUT/DYE TEST (AT GREENHOUSE) 12621-010 SEWER BACKWATER VALVE (GREENHOUSE) 81-83 READVILLE STREET SEWER CONNECTION TO HEATED UTILITY SHED (w/BATHROOM) CONDOMINIUM 81-83 READVILLE STREET SEWER CLEANOUT/DYE TEST (AT UTILITY SHED w/BATHROOM) PARCEL 12621-050 SEWER BACKWATER VALVE (AT UTILITY SHED W/BATHROOM) 85 READVILLE STREET CONDOMINIUM | 20' OF 6" SCH-80 STEEL DRAIN w/MITERED OUTLET (STA 0+12± **85 READVILLE STREET** 15' OF 6" SDR-35 PVC DRAIN TO GREENHOUSE DRAIN CLEANOUT/DYE TEST (AT GREENHOUSE) BACKWATER VALVE FOR RAIN STORAGE TANK (AT GREENHOUSE) 12622-003) INFILTRATION SYSTEM A - (4) CULTEC 330XLHD CHAMBERS CHINWE EZE NOTE: REVISION - INFILTRATION SYSTEM REMOVED FROM PLAN N66'30'13' 10-12 McDONOUGH COURT) 1500 GAL. RAIN WATER STORAGE TANK (REAR) NOTE: REVISION - LARGER RAIN STORAGE TANK IN GREENHOUSE PARCEL 3500 GAL. RAIN WATER STORAGE TANKS (GREENHOUSE) 12626-000 INSPECTOR KRABEY (1310) DATE 05-06-19 1500 GAL. RAIN WATER STORAGE TANK (REAR) JAMES MALLOY NOTE: REVISION - LARGER RAIN STORAGE TANK IN GREENHOUSE 15 NORTON STREET 3500 GAL. RAIN WATER STORAGE TANKS (GREENHOUSE) RAINWATER/STORMWATER INFORMATION OVERALL THE SITE WAS A VACANT WOODED LOT WITH NO EXISTING IMPERVIOUS AREAS. THE PROPOSED CONCRETE ROOF DRAINS TO SETTLING TANK (GREENHOUSE) MPERVIOUS AREA FOR THE ENTIRE SITE IS APPROXIMATELY 7,164 SQUARE FEET AND WILL REQUIRE COLLECTING A STORMWATER VOLUME OF 594.6 CUBIC FEET (4,448 GALLONS) TO MEET THE BOSTON WATER AND SEWER COMMISSION MINIMUM REQUIREMENT OF 1-INCH OF STORM WATER STORAGE PER ROOF DOWNSPOUT CONNECTIONS (GREENHOUSE) SQUARE FOOT OF THE PROPOSED POST-CONSTRUCTION IMPERVIOUS AREA ON THE SITE. BWSC ASBUILT PLAN (PHASE 1) ROOFS OF THE BUILDINGS WILL BE CAPTURED AND STORED IN (3) 3,500 GALLON WATER STORAGE TANKS (10,500 GALLONS) AND (8) 50 GALLON RAIN BARRELS (400 GALLONS). THE PROPOSED TOTAL STORED WATER VOLUME CAPCITY IS 10,900 GALLONS (1457.1 CUBIC FEET) AND IT WILL BE USED TO FUTURE PHASE 2 WATER THE PLANTS BEING GROWN IN THE GREENHOUSE, THE HIGH TUNNELS AND THE PLANTING AREAS LOCATED ACROSS THE SITE. 11) 52' OF 6" SDR-35 DRAIN w/FLARED END SECTION (STA 2+18) PHASE 1 THE PHASE 1 IMPERVIOUS AREA IS 5,138 SQUARE FEET AND TO MEET THE COMMISSION'S NOTE: REVISION - NEW LOCATION FOR HIGH TUNNELS 1-INCH MINIMUM STORAGE REQUIREMENTS MUST PROVIDE AT LEAST 426.4 CUBIC FEET (3,190 GALLONS) (11) 25' OF 6" PVC SDR-35 DRAIN w/MITERED OUTLET (STA 3+11) OF STORMWATER STORAGE. THE TWO (2) PROPOSED WATER STORAGE TANKS AND FIVE (5) RAIN BARRELS WILL STORE UP TO 969 CUBIC FEET (7,250 GALLONS) OR 2.26 INCHES OF STORMWATER PER SQUARE FOOT OF PROPOSED POST-CONSTRUCTION IMPERVIOUS AREA (1-INCH MIN REQUIRED). THE 2) INFILTRATION SYSTEM B - (2) CULTEC 280HD CHAMBERS STORED RAIN WATER WILL BE USED TO WATER THE PLANTS IN THE LARGE GREENHOUSE AND ACROSS NOTE: REVISION - INFILTRATION SYSTEM REMOVED FROM PLAN THE SITE. THE APPLICANT HAS REVIEWED THE PROJECT WITH LOCAL FARMERS AND EXPECTS TO USE (12A) RAIN STORAGE TANK CLEANOUT / DYE TEST (HIGH TUNNEL 2) BETWEEN 14,500 GALLONS OF WATER PER MONTH (483 GAL/DAY±) IN THE WINTER AND 48,000 GALLONS PER MONTH IN THE SUMMER (1,600 GAL/DAY±) TO WATER THE PLANTS THEY WILL BE (12B) BACKWATER VALVE FOR RAIN STORAGE TANK (HIGH TUNNEL 2) GROWING IN PHASE 1. THE APPLICANT IS ALSO PROPOSING TO ADD A BIOSWALE (SHOWN ON THE PLAN IN THE AREA BETWEEN THE GREENHOUSE AND THE DRAINAGE DITCH) IN THE FUTURE. CONSTRUCTION OF THE BIOSWALE WILL BE USED AS AN EDUCATIONAL TOOL FOR STUDENTS WHO WILL PARTICIPATE IN THE (13) 1500 GALLON RAIN WATER STORAGE TANK (HIGH TUNNEL 2) BUILDING OF THE BIOSWALE ONCE THE FARM IS UP AND RUNNING. NOTE: REVISION - LARGER RAIN STORAGE TANK HIGH IN TUNNEI (13) 3500 GALLON RAIN WATER STORAGE TANK (HIGH TUNNEL 2) WINTER WATER USE (30 DAYS) MIN RAINFALL=3.27" POTENTIAL WATER STORAGE=10,467 GAL ESTMATED WATER USE=14,500 GAL

BWSC INSPECTIONS

PARCEL No. 12628, 12629, 12630, 12631, 12632, 12633 & 12634

AND USE CODE PROPOSED URBAN FARM W/ MARKET STAND

BWSC ACCESS ROAD

MATTHEW D.

BWSC ACCOUNT No.

(13A) CONCRETE ROOF DRAIN SETTLING TANK (HIGH TUNNEL 2)

(4) ROOF DOWNSPOUT CONNECTIONS (AT HIGH TUNNELS 1 & 2) 15) ROOF GUTTERS (AT HIGH TUNNELS 1 & 2)

6) BWSC ASBUILT PLAN (PHASE 2) INSPECTOR

THIS PLAN IS BEING SUBMITTED FOR PHASE 2 ONLY, PHASE 1 HAS BEEN SUBMITTED TO THE COMMISSION.

SEE ATTACHED LANDSCAPING PLAN FOR THE PROPOSED FOOT BRIDGE DETAILS.

BWSC SITE PLAN No. 18509R URBAN FARM - PHASE 2 21 NORTON STREET BOSTON, MASS.

(HYDE PARK - 02136-1414)

SCALE: 1"=20'

OCTOBER 16, 2018

NORWOOD ENGINEERING CO., INC. CIVIL ENGINEERS & LAND SURVEYORS 1410 ROUTE ONE, NORWOOD, MA 02062 PHONE: 781-762-0143 FAX 781-762-8595

20 SHEET No. 1 OF 2 10440-01

REFERENCE BENCHMARK: SMH 33 (FROM BWSC G.I.S. MAPS) SMH 33 AT INTERSECTION OF NORTON STREET & MANILLA AVENUE

CONSTRUCTION BENCHMARK: X-CUT "A" CORNER OF No. 21 NORTON STREET - ELEVATION= 56.39 (BCB)


DRILL HOLE SET IN SIDEWALK NEAR THE FRONT RIGHT PROPERTY CORNER OF No. 19 NORTON STREET - ELEVATION= 63.42 (BCB)


WE GROW MICROGREENS, LLC

DEED REFERENCE: SUFFOLK REGISTY BOOK 60885 PAGE 29

REVISIONS PER BWSC REVIEW COMMENTS ADD HEATED UTILITY SHED W/BATHROOM REVISIONS PER BWSC REVIEW COMMENTS


INSPECTION SIGN-OFF LIST REVISED

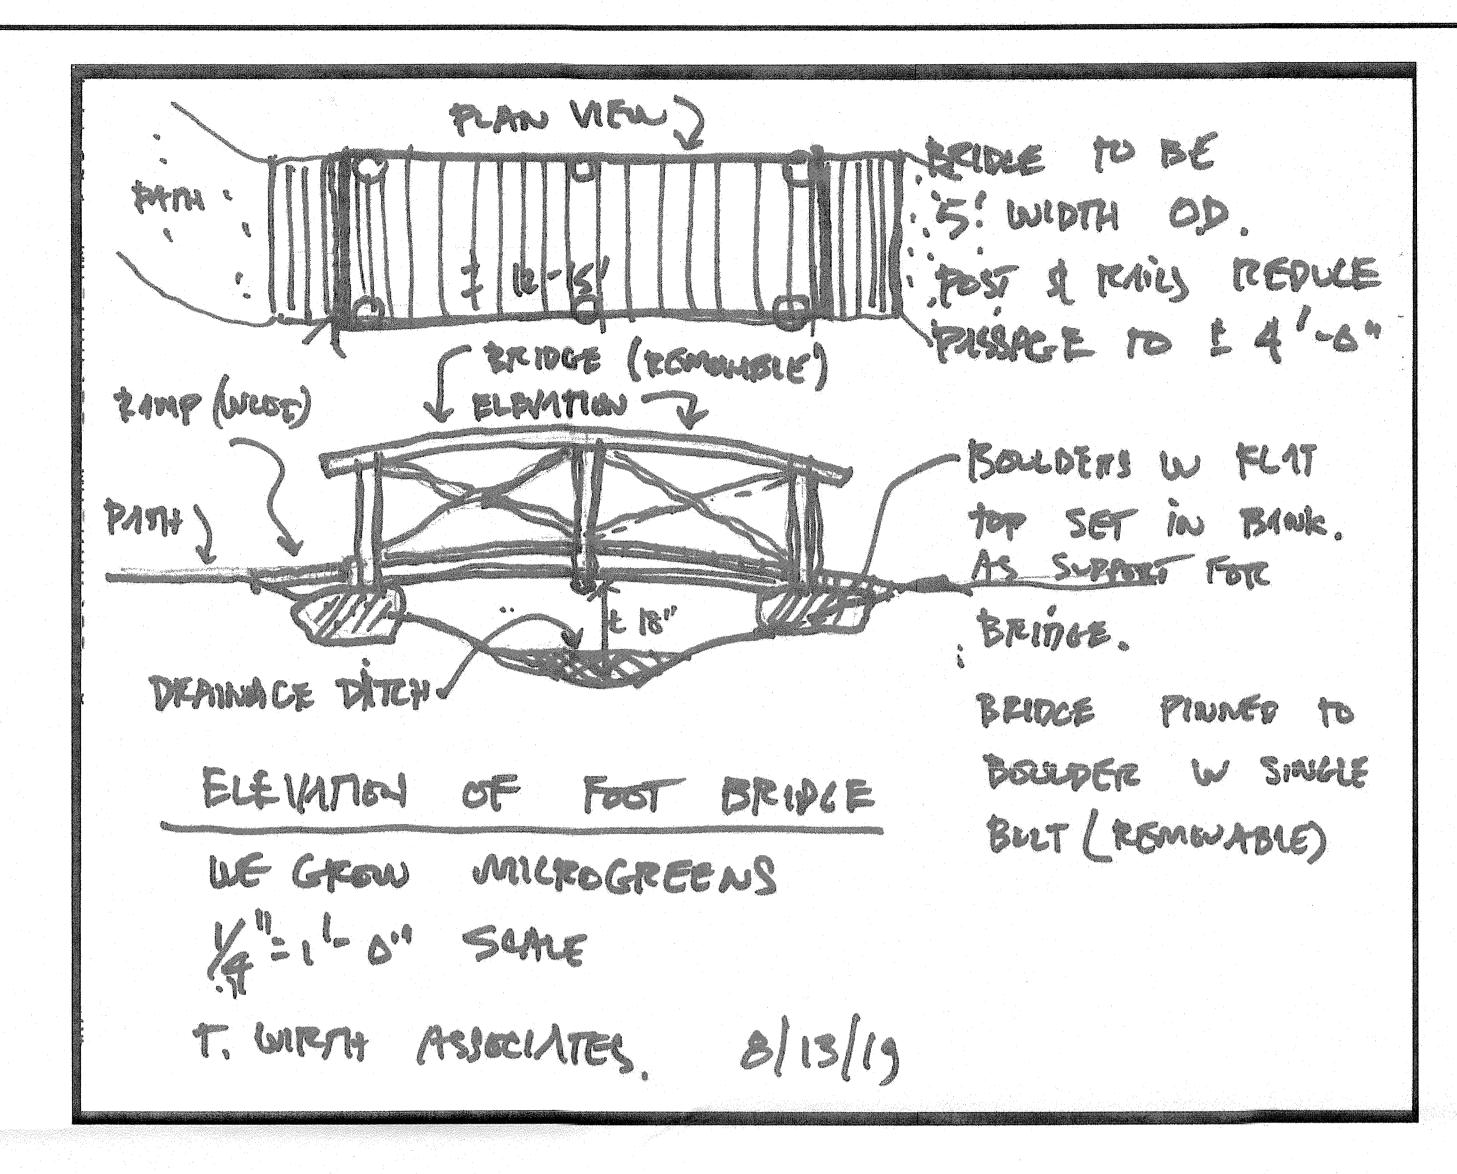


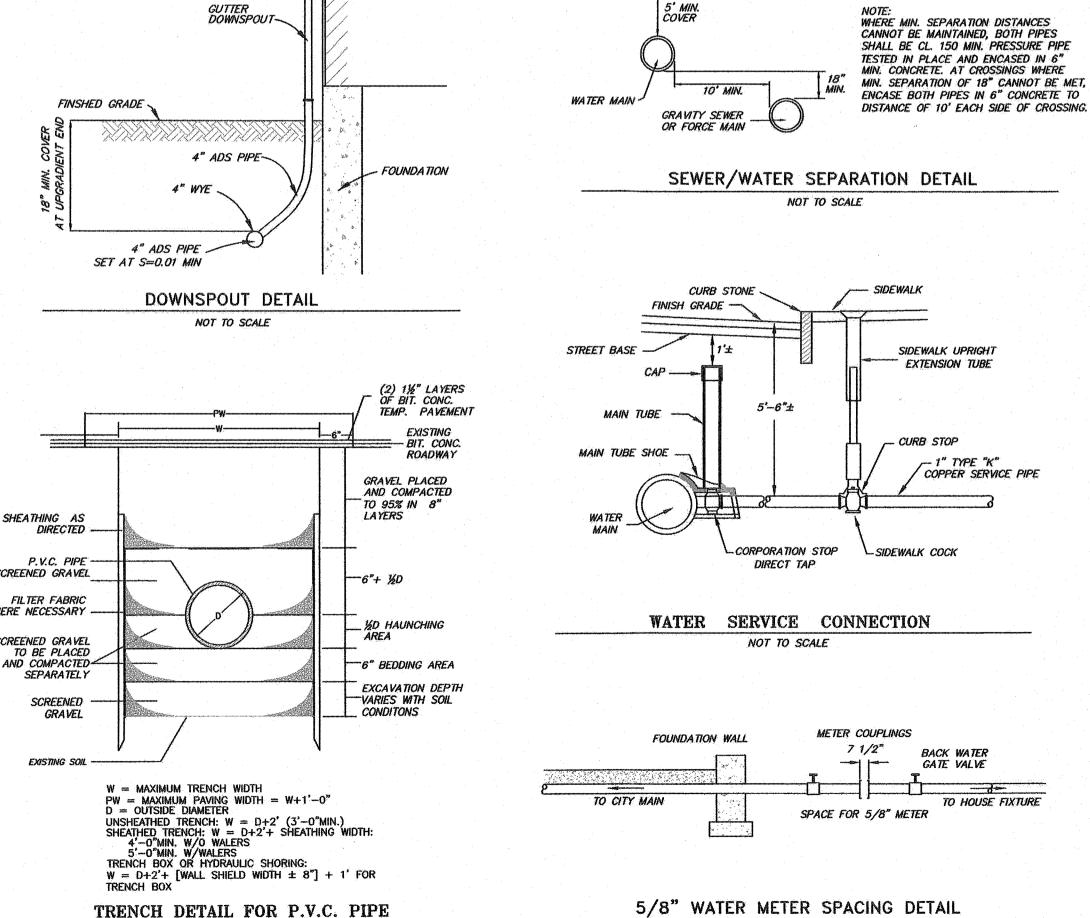

NOT TO SCALE


(BWSC DETAIL)

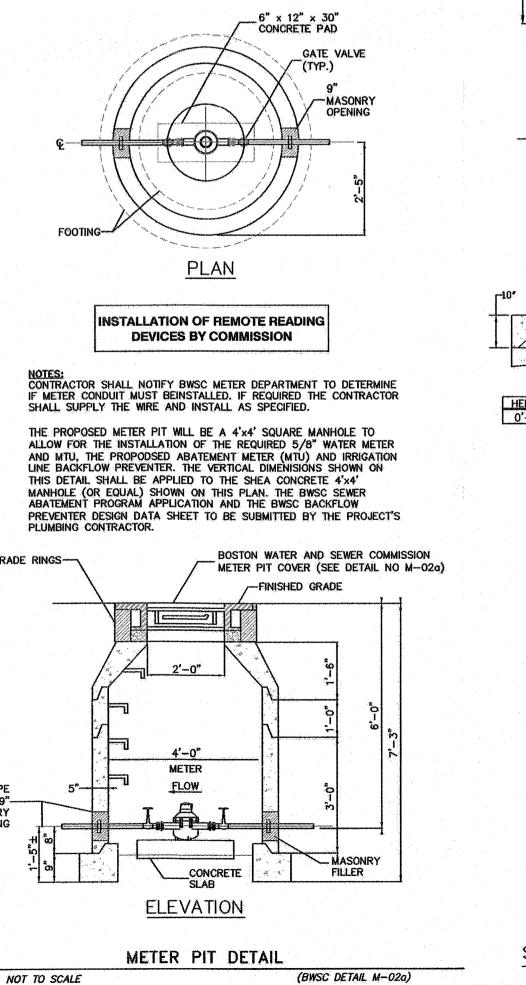

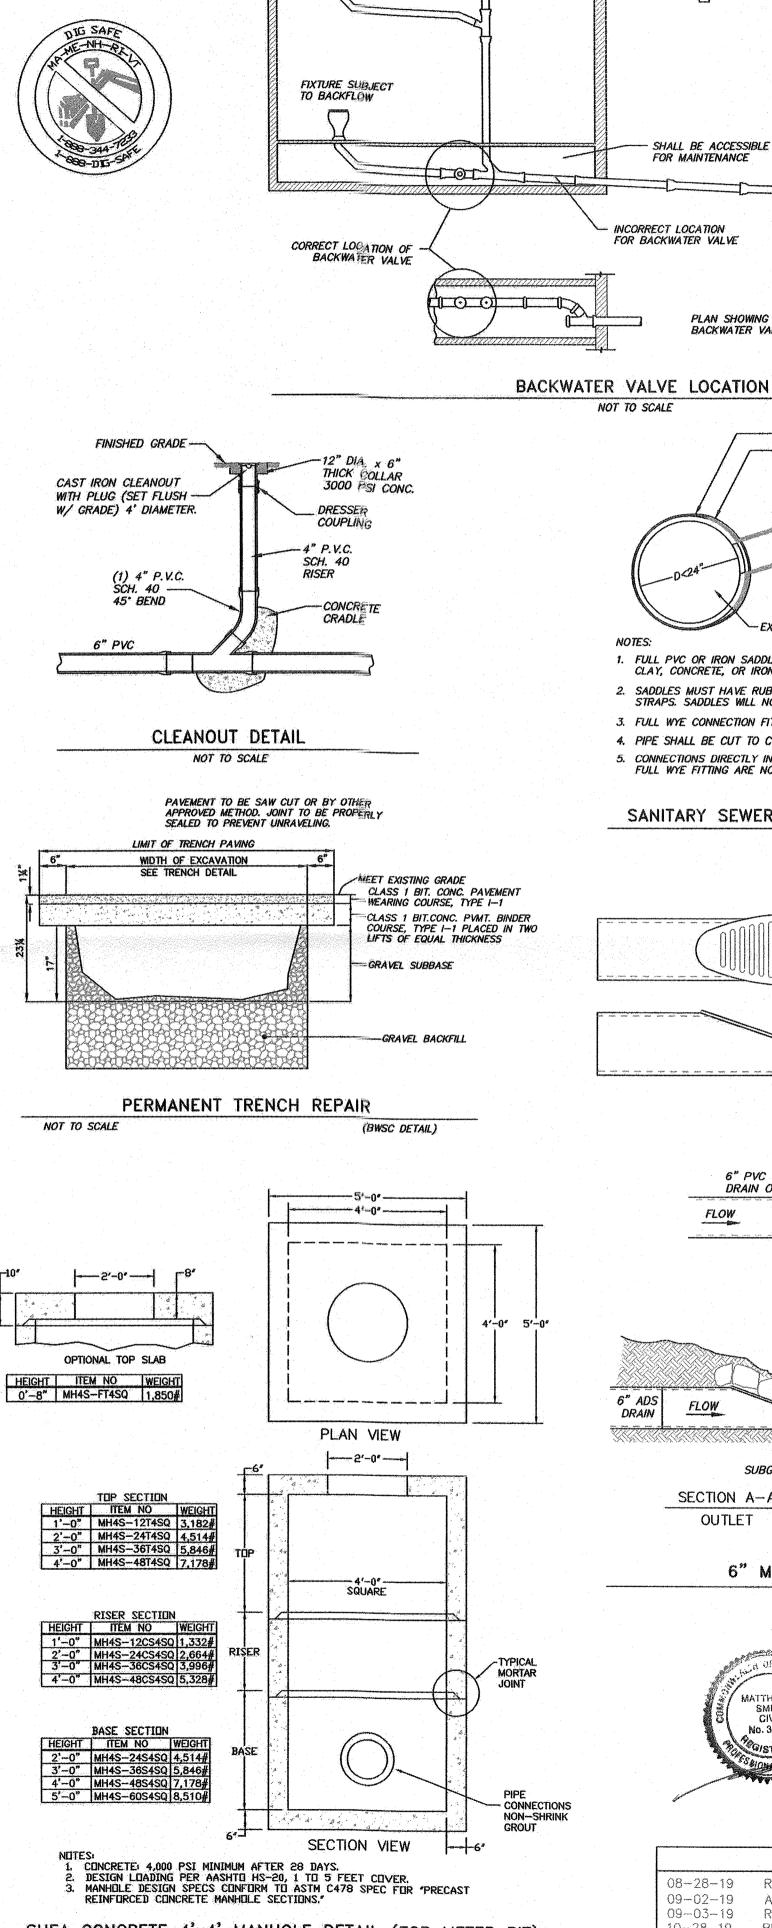

FIXTURE NOT SUBJECT

TO BACKFLOW

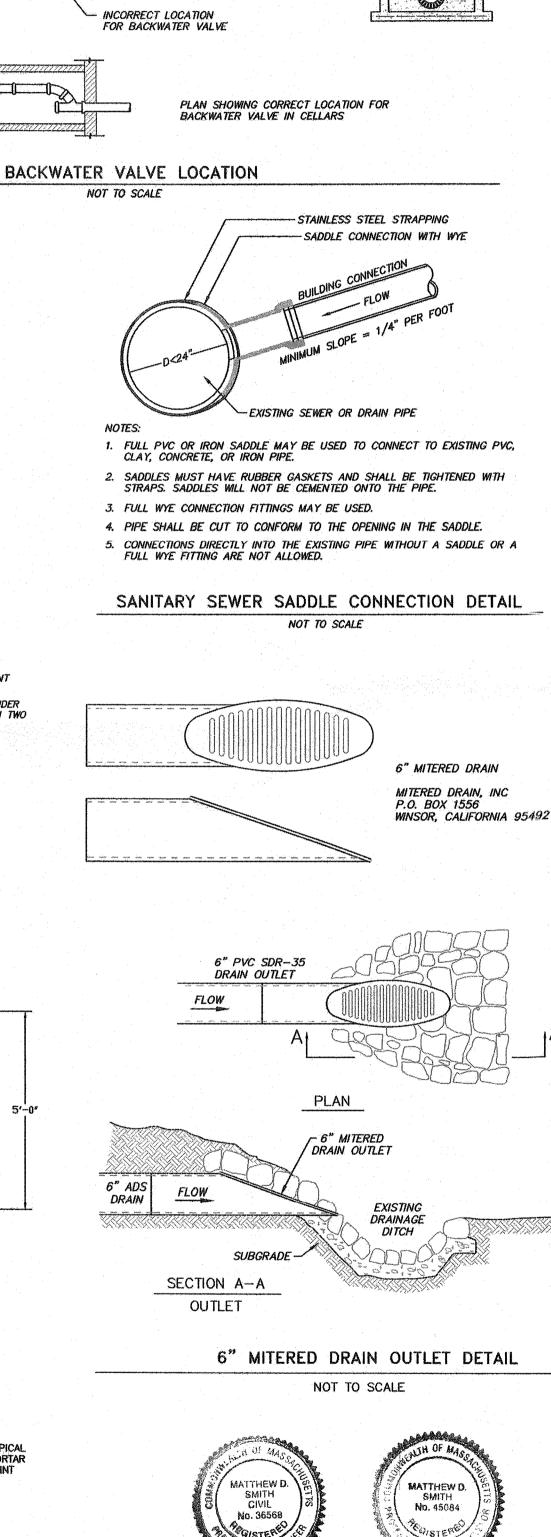

REVISIONS

REVISIONS PER BWSC REVIEW COMMENTS

ADD HEATED UTILITY SHED W/BATHROOM REVISIONS PER BWSC REVIEW COMMENTS

REVISIONS PER CLIENT - FOOT PATH,

ACCESS ROAD, BACKWATER VALVES

INSPECTION SIGN-OFF LIST REVISED

08-28-19

10-28-19

10-30-19

NOTE: ALL PLUMBING FIXTURES BELOW THE LEVEL OF THE TOP

SUPPLIED WITH BACKWATER VALVES.

VALVES 248 CMR SECTION 209: (4)

OF THE MANHOLE OF THE SEWER SERVICING THE FIXTURE(S) SHALL BE CONSIDERED AS BEING SUBJECT TO BACKFLOW AND SHALL BE

BUILDING SEWER AND BUILDING DRAIN PIPES FROM FIXTURES LIABLE TO BACKFLOW FROM A SEWER SHALL BE SUPPLIED WITH BACKWATER

AND ARE NOT WARRANTED TO BE CORRECT. UNDERGROUND UTILITIES ARE SHOWN BASED ON RECORD DATA PROVIDED BY THE OPERATING AUTHORITIES, AND HAVE BEEN FIELD INSPECTED WHERE POSSIBLE. ADDITIONAL UTILITIES MAY EXIST WHICH ARE NOT INDICATED ON THESE PLANS. ALL EXISTING UTILITIES SHALL BE VERIFIED FOR SERVICE, SIZE, INVERT ELEVATION, LOCATIONS, ETC. PRIOR TO NEW CONNECTIONS TO OR RELOCATION OF SAME. CONTRACTOR MUST NOTIFY DIG-SAFE AT 1-888-344-7233 AT LEAST 72 HOURS PRIOR TO ANY CONSTRUCTION. NOTIFY THIS FIRM IN WRITING OF ANY AND ALL DISCREPANCIES PRIOR TO COMMENCING ANY WORK. THE BOSTON WATER AND SEWER COMMISSION IS NOT PART OF DIG SAFE THEREFORE, FIELD LOCATIONS OF WATER AND SEWER LINES MUST BE MARKED BY THE COMMISSION. CALL 1-617-330-9400 FORTY EIGHT HOURS IN ADVANCE OF ANY **EXCAVATION.** THE EXISTING WATER AND SEWER SERVICE LOCATIONS SHOWN ARE FROM AVAILABLE BWSC RECORD DATA AND ARE APPROXIMATE ONLY. IT IS THE RESPONSIBILITY OF THE CONTRACTOR TO ACCURATELY LOCATE THE EXISTING WATER AND SEWER LINES. IF THE EXISTING SEWER SERVICE IS TO BE USED THE CONTRACTOR SHALL VISUALLY INSPECT THE LINE BY EXCAVATION AND OR BY VIDEO OF THE PIPE AS REQUIRED BY THE COMMISSION. THIS PLAN HAS BEEN PREPARED FOR APPROVAL OF THE WATER, SEWER AND DRAIN CONNECTIONS TO BWSC FACILITIES. IT IS UNDERSTOOD THAT THE RESPONSIBILITY OF OWNERSHIP AND MAINTENANCE OF THE SEWER AND DRAIN CONNECTIONS ON PRIVATE PROPERTY AND/OR PRIVATE AND PUBLIC WAYS SHALL BE THE RESPONSIBILITY OF THE OWNER. IT IS ALSO UNDERSTOOD THAT THE WATER CONNECTION ON PRIVATE PROPERTY INCLUDING PRIVATE WAYS IS ALSO THE RESPONSIBILITY OF THE OWNER. THE CROSSING POINT.

A MINIMUM OF 18 INCHES OF VERTICAL SEPARATION IS REQUIRED WHERE A SEWER LINE PASSES A WATER OR DRAIN LINE. OTHERWISE, THE WATER, SEWER AND DRAIN LINES SHALL BE ENCASED IN CONCRETE FOR A MINIMUM OF 10 FEET FROM

GENERAL NOTES

THE CONTRACTOR SHALL SUPPLY THE COPPER SERVICE AND SHALL PERFORM THE TAP AS PART OF HIS CONTRACT. NEW WATER LINES SHALL BE A MINIMUM OF TEN FEET AWAY FROM ALL SEWER LINES, EXISTING OR PROPOSED.

IT IS RECOMMENDED THAT DIGGING WITHIN ONE FOOT OF THE MAIN BE DONE WITH HAND TOOLS ONLY.

IT IS THE CONTRACTOR'S RESPONSIBILITY TO TAKE FIELD NOTES WITH TIES TO THE LOCATION AND ELEVATIONS OF ALL UTILITIES INSTALLED WHEN SURVEYORS ARE NOT AVAILABLE TO RECORD THIS INFORMATION. THE CONTRACTOR SHALL PROVIDE THE FIELD NOTES TO THE PROJECT ENGINEER OR LAND SURVEYOR TO BE USED FOR THE PREPARATION OF ANY REQUIRED ASBUILT PLANS.

THE CONTRACTOR SHALL PROVIDE APPROPRIATE EROSION AND SEDIMENTATION CONTROL MEASURES AT ALL TIMES TO PREVENT IMPACT ON WATER BODIES, BORDERING VEGETATED WETLANDS. CITY DRAINAGE SYSTEMS AND ABUTTING PROPERTIES.

ANY PROPOSED GAS, ELECTRIC, STEAM, TELEPHONE, CABLE OR OTHER UTILITY LINES ARE TO BE LOCATED AND SIZED BY OTHERS. ALL SERVICES SHALL BE INSTALLED IN ACCORDANCE WITH THE REQUIREMENTS OF THE RESPECTIVE UTILITY.

ALL NEW CONSTRUCTION WILL REQUIRE A ROUGH CONSTRUCTION SIGN OFF DOCUMENT FROM THE CITY OF BOSTON INSPECTIONAL SERVICES DEPARTMENT BEFORE FILING FOR A GENERAL SERVICE APPLICATION.

THE SANITARY SEWER SHALL BE CONSTRUCTED IN ACCORDANCE WITH THE SPECIFICATIONS OF THE BOSTON WATER AND SEWER COMMISSION. CONNECTIONS SHALL BE MADE IN ACCORDANCE WITH APPLICABLE PERMITS OBTAINED BY THE CONTRACTOR.

IF PLUMBING FIXTURES ARE TO BE INSTALLED IN THE BASEMENT THEY WILL REQUIRE THE PROTECTION OF A BACKWATER VALVE. (SEE DETAIL)

IT IS REQUIRED THAT A DYE TEST WILL BE PERFORMED BY THE BOSTON WATER AND SEWER COMMISSION INSPECTOR BEFORE THE STRUCTURE IS OCCUPIED.

THE WATER SERVCE SHALL BE CONSTRUCTED IN ACCORDANCE WITH THE SPECIFICATIONS OF THE BOSTON WATER AND SEWER COMMISSION. CONNECTIONS SHALL BE MADE IN ACCORDANCE WITH APPLICABLE PERMITS OBTAINED BY THE CONTRACTOR. UNLESS DIRECTED OTHERWISE, ALL WATER LINES SHALL BE INSTALLED 5' TO 6' BELOW GRADE. WHERE REQUIRED THRUST RESTAINTS SHALL BE INSTALLED PER THE COMMISSION'S STANDARD DETAILS. THE ACTUAL METHOD OF RESTRAINT WILL BE DETERMINED BY ACTUAL FIELD CONDITIONS.

> WE GROW MICROGREENS, LLC 21 NORTON STREET HYDE PARK MA 02131

CONTACTS: LISA EVANS 617-792-5424 TIM SMITH 617-877-0465

BWSC SITE PLAN No. 18509R PROPOSED URBAN FARM

21 NORTON STREET

(HYDE PARK - 02136-1414)


OCTOBER 16, 2018 SCALE: 1"=20"

NORWOOD ENGINEERING CO., INC. CIVIL ENGINEERS & LAND SURVEYORS 1410 ROUTE ONE, NORWOOD, MA 02062

10440-01


FAX 781-762-8595 SHEET No. 2 OF 2

SHEATHING AS DIRECTED — SCREENED GRAVEL FILTER FABRIC WHERE NECESSARY SCREENED GRAVEL NOT TO SCALE

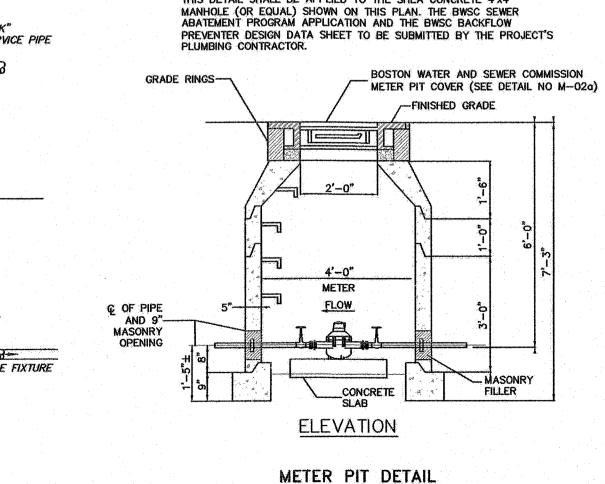

(BWSC DETAIL)

SHEA CONCRETE 4'x4' MANHOLE DETAIL (FOR METER PIT) NOT TO SCALE

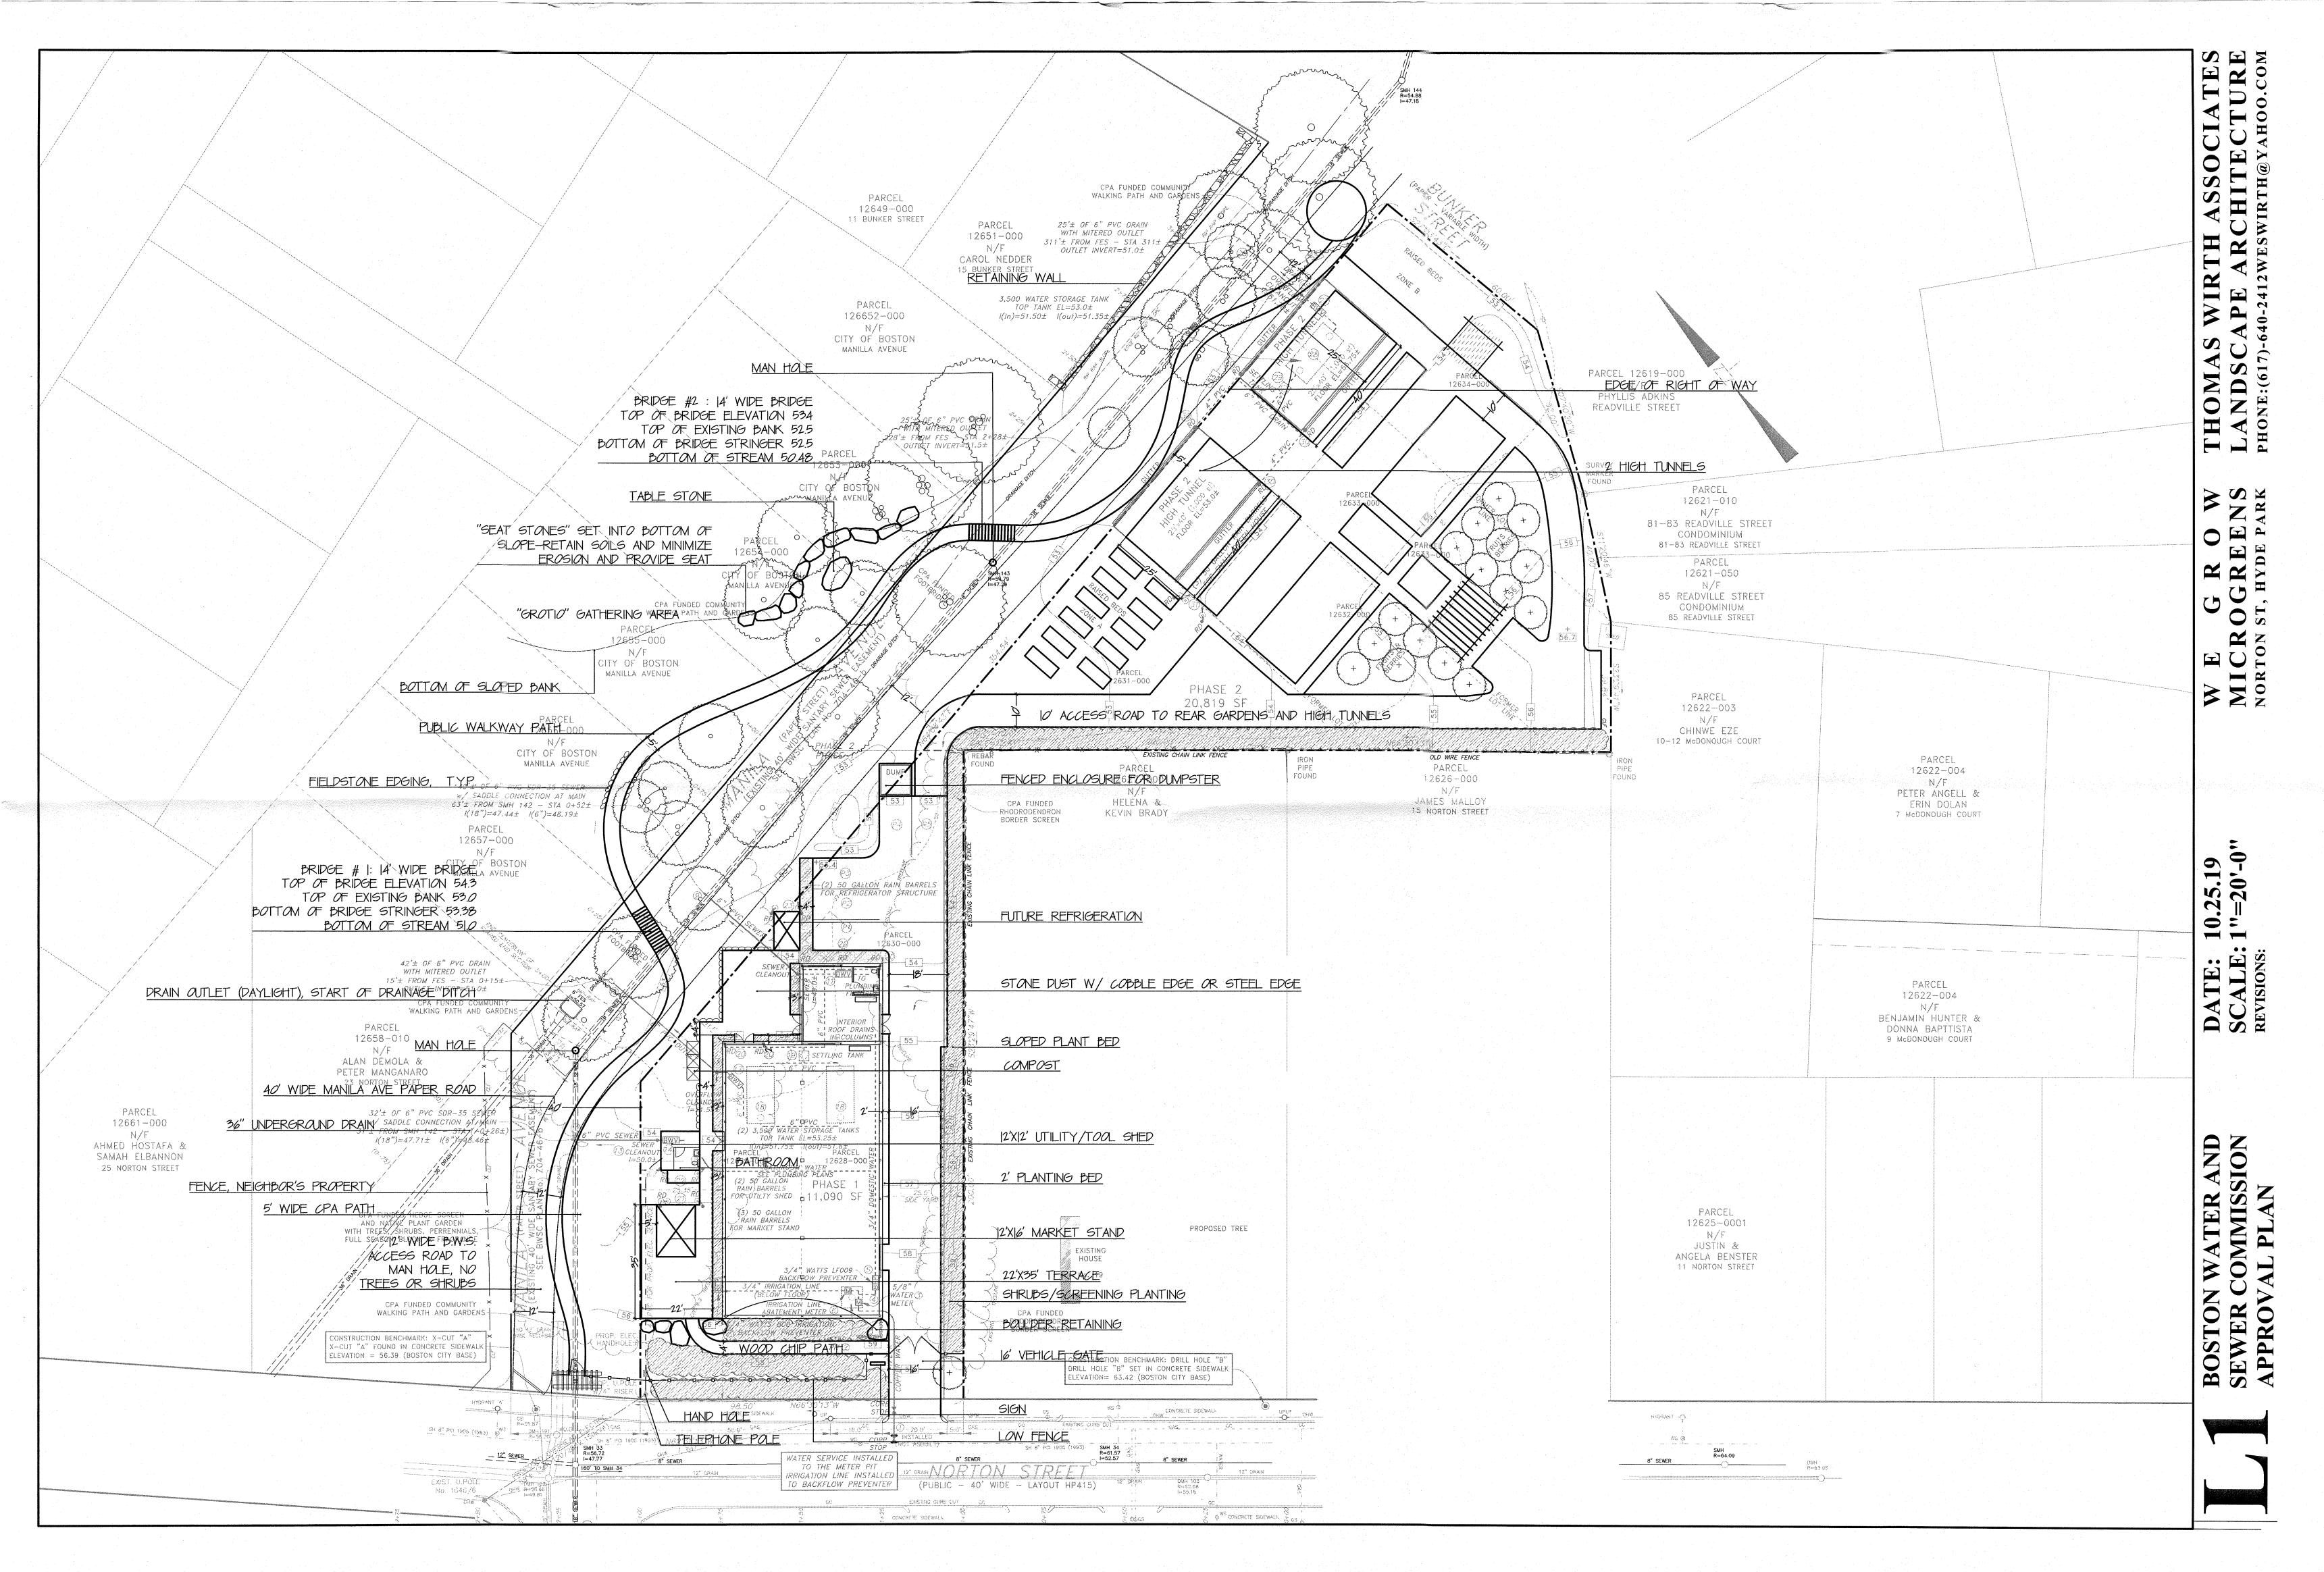




-5/4"X6" WHITE OAK PLANKS


-3"XIO" STRINGERS

GRANITE CURB SEAT

3 END SECTION OF BRIDGE SCALE: 1/2"=1'-0"



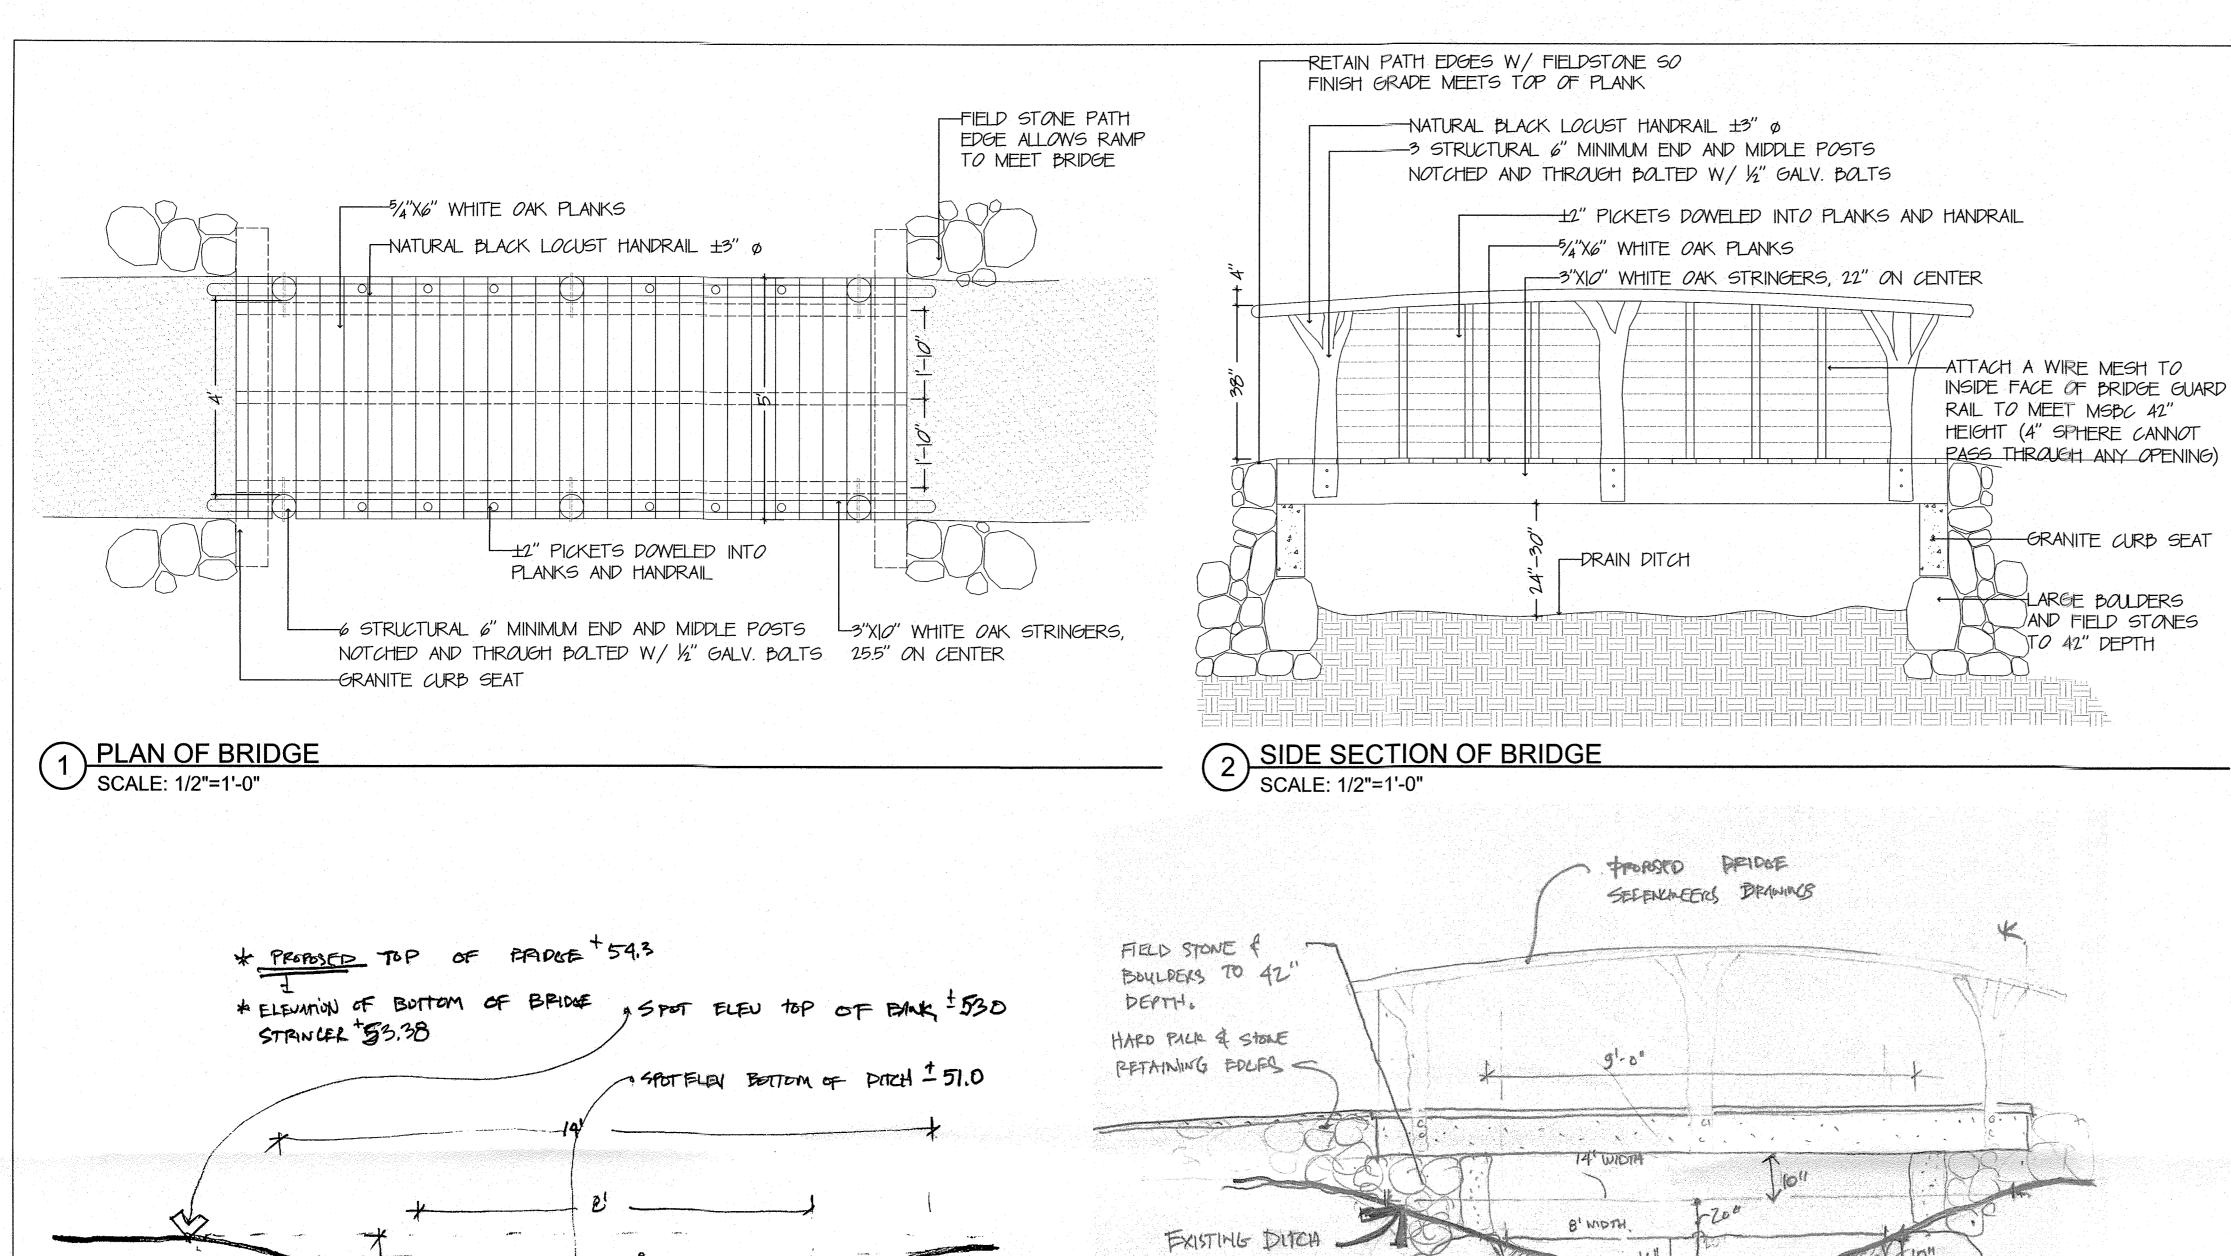

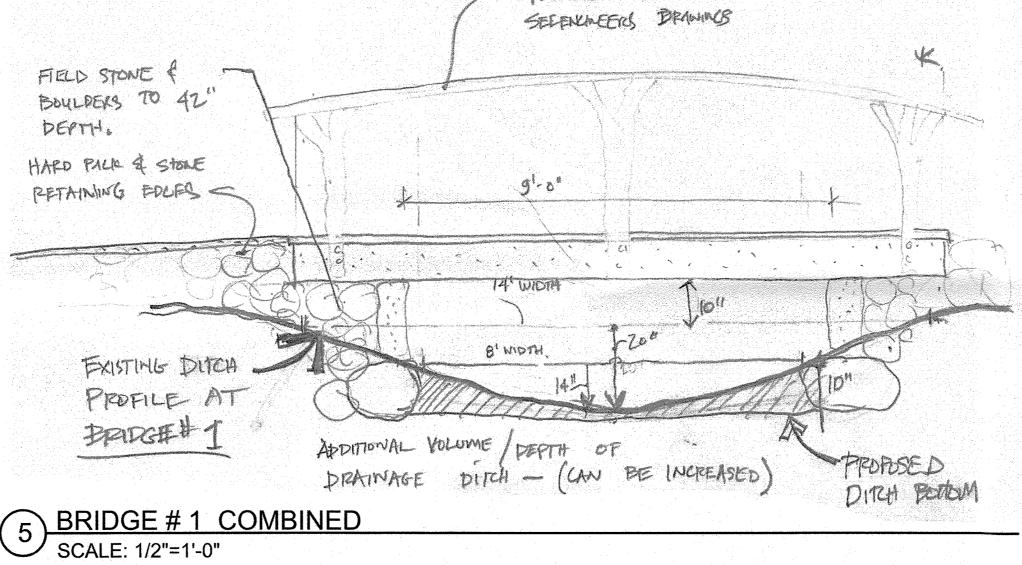


-ATTACH A WIRE MESH TO

-GRANITE CURB SEAT

JAND FIELD STONES


TO 42" DEPTH

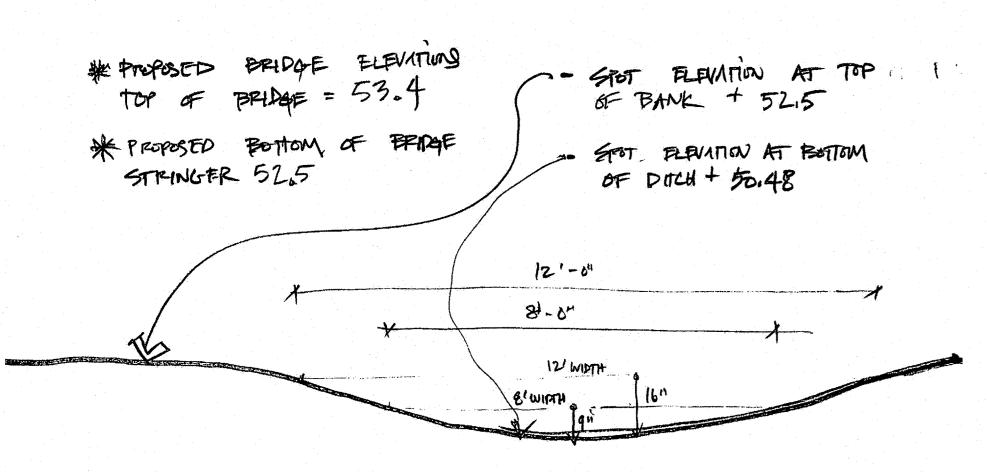

124" to TOP OF BANK

4 EXISTING DRAIN DITCH PROFILE AT BRIDGE # 1 SCALE: 1/2"=1'-0"

6 EXISTING DRAIN DITCH PROFILE AT BRIDGE # 2 SCALE: 1/2"=1'-0"

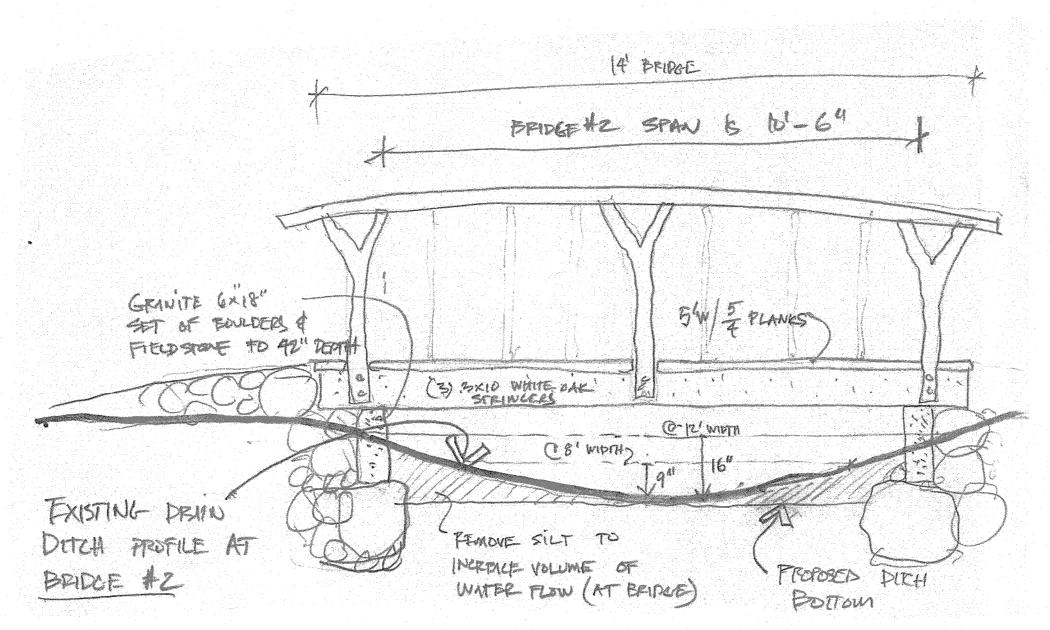

7 BRIDGE # 2 COMBINED
SCALE: 1/2"=1'-0"