
STREET

## STOUGHTON

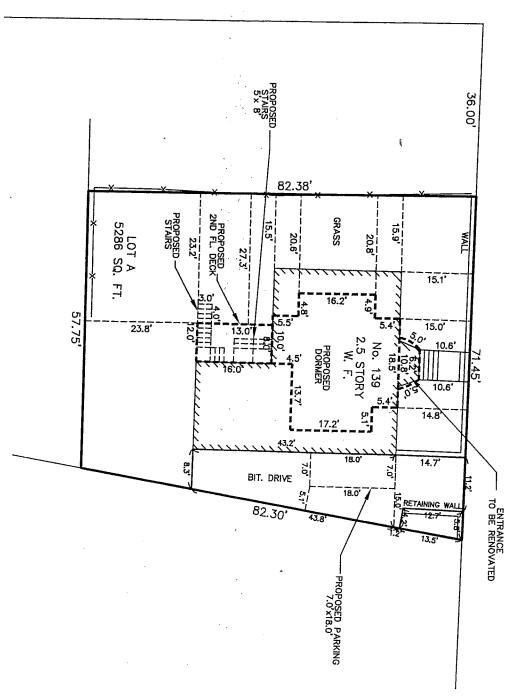

STREET

SALCOMBRE

PLAN

139 STOUGHTON STREET

SEPTEMBER 14, 2016

166 WATER STREET STOUGHTON, MA 02072 PHONE: (781)344—2386

# Z F A M I L Y D W E L L I N G A D D I T I D N & A L T E R A T I D N S F D R N I C D Y A P A R T N E R S


139 STOUGHTON STREET

DORCHESTER BOSTON, MA



\*\*\*\* CONSTRUCTION SET ISSUED FOR PERMIT 05/10/16 \*\*\*\*



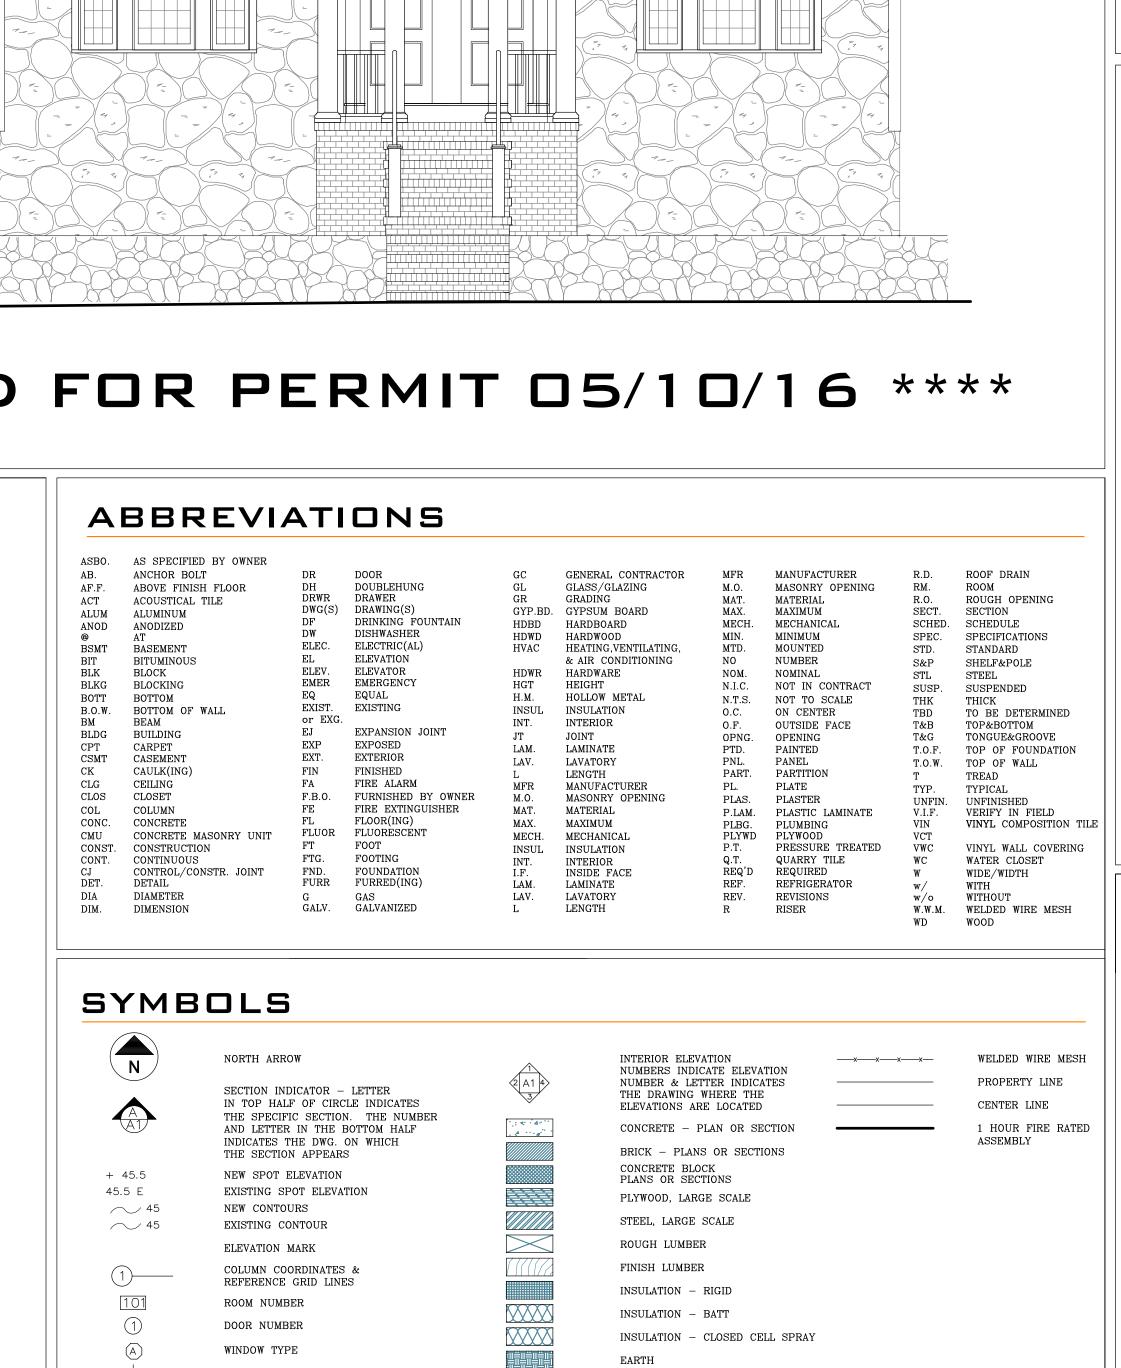

COMPACT GRAVEL

WALL TYPE

# SCHEDULE OF DRAWINGS T1 TITLE SHEET & FAR CALCULATIONS T2 CODE SUMMARY & GENERAL NOTES T3 DRAFT STOPPING DETAILS

- E1 BASEMENT LEVEL & FIRST
- FLOOR EXISTING PLANS
  E2 SECOND & THIRD FLOOR
- EXISTING PLANS
- E3 EXISTING ELEVATIONS
- E4 EXISTING SECTIONS
- D1 DEMOLITION PLANS
- A1 BASEMENT FOUNDATION & FIRST FLOOR CONSTRUCTION PLANS
- A2 SECOND & THIRD FLOOR CONSTRUCTION PLANS
- A3 SECOND FLOOR + HIGH & LOW ROOF FRAMING PLANS
- A4 ELEVATIONS
- A5 SYSTEM NOTES & BUILDING SECTIONS

#### DO NOT SCALE FROM DRAWINGS

### FAR AREA CALCULATIONS

TOTAL LOT AREA = 5,286 SF

FAR ALLOWABLE SF = 5,286 x 0.5 = 2,643 GSF

FIRST FLOOR GSF = 1,294 GSF

LAUNDRY & STORAGE CLOSET DEDUCTION - 123

TOTAL FIRST FLOOR ADJUSTED AREA = 1171 SF

SECOND FLOOR GSF = 1162 GSF

LAUNDRY & STORAGE CLOSET DEDUCTION- 130 NETSF

TOTAL SECOND FLOOR ADJUSTED AREA = 1129 SF

THIRD FLOOR GSF PER UNIT = 581 GSF

STORAGE CLOSET & STAIR OPENING DEDUCTION - 239 NETSF

TOTAL THIRD FLOOR ADJUSTED AREA = 342 SF

TOTAL ADJUSTED AREA = 2633 COMPLIES WITH FAR REQUIREMENTS: 2642 < 2643

## THE BUILDING SHALL BE IN COMPLIANCE WITH THE FOLLOWING:

- 180 CMR MASS, STATE BUILDING CODE, 8TH
- EDITION, AS AMENDED.

  2009 IRC AS AMENDED
- 527 CMR: 2008 BOARD OF FIRE PREVENTION REGULATIONS
- 2008 NATIONAL ELECTRIC CODE W/ AMENDMENTS± 2008 MASS. ELEC. CODE 527 CMR 12.00 LATEST ISSUE, AS AMENDED
- THE MASS FUEL & GAS PLUMBING CODE, AS AMENDED/ AND NFPA 54 NATIONAL FUEL GAS CODE LATEST EDITION AND AMENDMENTS
- NFPA 13 2007 EDITION
- 2009 IECC W/ STRETCH ENERGY CODE

DO NOT SCALE FROM DRAWINGS

RAWN BY:

LAURIN & LANGLAIS

DIEWBURY STREET

DISTON, MA 02116

DRAWING TITLE:

TITLE SHEET & FAR CALCULATIONS

DATE: 05/10/16

CONSTRUCTION SET ISSUED FOR PERMIT 05/10/1

1613

PROJECT No.

SHEET No.

**T1** 

GENERAL REQUIREMENTS 1. ALL WORK SHALL COMPLY WITH FEDERAL AND LOCAL BUILDING CODES \$ REGULATIONS

2. MECHANICAL, ELECTRICAL AND PLUMBING WORK REQUIRED OF THIS PERMIT APPLICATION TO BE PERFORMED BY SUBCONTRACTOR LICENSED IN THE STATE IN WHICH WORK IS BEING PERFORMED

3. SUBCONTRACTOR SHALL PROVIDE VERIFICATION OF GENERAL LIABILITY INSURANCE AND WORKMAN'S COMPENSATION COVERAGE, AS REQUIRED BY GENERAL CONTRACTOR

4. CONTRACTOR SHALL COORDINATE AND/OR OBTAIN ALL BUILDING PERMITS REQUIRED FOR CONSTRUCTION AND CERTIFICATES OF OCCUPANCY 5. CONTRACTOR SHALL BE SOLELY RESPONSIBLE FOR ALL CONSTRUCTION

6. CONTRACTOR SHALL BE RESPONSIBLE FOR ALL ASPECTS OF SAFETY DURING CONSTRUCTION AND SHALL PROVIDE ADEQUATE SHORING AND BRACING TO ENSURE SUCH SAFETY

MEANS, METHODS, TECHNIQUES, AND PROCEDURES

1. ALL DIMENSIONS AND SITE CONDITIONS TO BE FIELD VERIFIED AND SHALL BE THE RESPONSIBILITY OF THE CONTRACTOR, NOTIFY ARCHITECT OF ANY DISCREPANCIES BEFORE THE START OF WORK

8. IT SHALL BE THE RESPONSIBILITY OF THE CONTRACTOR TO LOCATE ALL EXISTING UTILITIES, WHETHER INDICATED ON THE PLANS OR NOT, AND PROTECT THEM FROM DAMAGE

9. ALL DETAILS, SECTIONS, NOTES, OR REFERENCE TO OTHER DRAWINGS ARE INTENDED TO BE TYPICAL

10. DURING CONSTRUCTION, AND PRIOR TO THE INCORPORATION OF ANY CHANGES, REVISIONS, MODIFICATIONS, AND/OR DEVIATIONS FROM THE CONTRACT DOCUMENTS. THE CONTRACTOR SHALL BRING TO THE ATTENTION OF THE ARCHITECT AND OBTAIN APPROVAL FROM THE GOVERNING BUILDING OFFICIAL BEFORE PROCEEDING WITH THE WORK

11. THE MANUFACTURER'S PRODUCTS AND EQUIPMENT LISTED ESTABLISH PERFORMANCE REQUIREMENTS. SUBSTITUTIONS OF EQUAL PERFORMANCE MAY BE SUBMITTED FOR THE ARCHITECTS APPROVAL

12. ALL MATERIALS SHALL BE INSTALLED PER MANUFACTURER'S SPECIFICATIONS & RECOMMENDATIONS UNLESS OTHERWISE SPECIFIED BY THE ARCHITECT

13. SPECIFIC NOTES AND DETAILS ON THE DRAWINGS SHALL TAKE PRECEDENCE OVER GENERAL NOTES AND TYPICAL DETAILS

#### GENERAL CIVIL NOTES

- REMOVE ALL DEBRIS WITHIN 2'-0" OF THE BUILDING

- SLOPE EXTERIOR GRADE MIN. 5% TO DRAIN AWAY FROM BUILDING

- ALL WALLS, ROOF, AND FLOORS IN CONTACT WITH THE GROUND SHALL BE CONSTRUCTED TO RESIST THE LEAKAGE OF SOIL GAS FROM THE GROUND TO THE BUILDING, PASSIVE SUB-SLAB DEPRESSURIZED SYSTEM IN ACCORDANCE WITH THE SUPPLEMENTARY GUIDELINES SHALL BE PROVIDED: I VENT PIPE, MIN. 3" DIAMETER, PER 1500 SQUARE FOOT OF FLOOR AREA YENTED STRAIGHT UP THROUGH ROOF

#### GENERAL MECHANICAL & ELECTRICAL NOTES

1. ALL MECHANICAL SYSTEMS, LIGHTING, AND MAJOR APPLIANCES MUST MEET OR EXCEED THE REQUIRED EFFICIENCIES SCHEDULE ON THE HOME ENERGY RATING CERTIFICATE ATTACHED TO THIS SHEET

2. ALL COMBUSTION APPLIANCES (EXCEPT GAS STOVE RANGE, COOKTOP OR OVEN) IN THE CONDITION SPACE MUST BE SEALED COMBUSTION. SPECIFICALLY, ANY FURNACE INSIDE CONDITIONED SPACE MUST BE SEALED COMBUSTION, ANY WATER HEATER INSIDE CONDITIONED SPACE MUST BE DIRECT-POWER-VENTED. ANY BOILER INSIDE CONDITIONED SPACE MUST BE SEALED COMBUSTION

3. GAS RANGE TOPS MUST BE ACCOMPANIED BY A DIRECT-VENTED HOOD OR EQUAL

4. ALL DUCTS AND AIR HANDLING EQUIPMENT MUST BE IN THE CONDITIONED SPACE

5. CARBON MONOXIDE DETECTORS (HARD WIRED UNITS) MUST BE INSTALLED AT ONE PER EVERY APPROXIMATE 1000 SQUARE FEET IN ANY HOUSE CONTAINING COMBUSTION APPLIANCES OR ATTACHED

6. ALL MECHANICAL SYSTEMS, LIGHTING, AND MAJOR APPLIANCES MUST MEET OR EXCEED THE REQUIRED EFFICIENCIES REQUIRED BY THE STRETCH ENERGY CODE

EXHAUST FANS - VENT TO EXTERIOR

RANGE HOODS - VENT TO EXTERIOR W/ NON COMBUSTIBLE DUCT

<u>DRYER VENT</u> - CAPPED AND SCREWED DRYER VENT, DUCTING INSTALLED TO SLOPE TO EXTERIOR

SMOKE DETECTORS - LOCATE ON EACH FLOOR LEVEL AND INTERCONNECTED

CARBON MONOXIDE DETECTORS - LOCATE IN EACH BEDROOM

#### GENERAL ARCHITECTURAL NOTES

- PROVIDE I" DRIP EDGE ON FLASHING OVER OPENINGS IN EXTERIOR WALLS

WOOD PROTECTION

- WOOD FRAMING MEMBERS THAT ARE NOT PRESSURE TREATED WITH A WOOD PRESERVATIVE AND WHICH ARE SUPPORTED ON CONCRETE IN CONTACT WITH THE GROUND SHALL BE SEPARATED FROM THE CONCRETE BY AT LEAST 6 MIL. POLY FILM OR EQUAL

STAIR DIMENSIONS (ALL INTERIOR AND EXTERIOR STAIRS -REFER TO DRAWINGS FOR ACTUAL STAIR DIMENSIONS)

-MAX RISE: 8 1/4" - MIN TREAD: 9"

- MAX NOISING: 1 /4"

- MIN WIDTH: 3'-0"

- MIN. HEADROOM 6'-8"

HANDRAILS & GUARDS - MIN. HEIGHT - 2'-10" (HANDRAILS), 3'-0" (GUARDS) - MAX HEIGHT - 3'-2" (HANDRAILS) - A CLEARANCE OF NOTE LESS THAN 1 1/2" SHALL BE PROVIDED

BETWEEN HANDRAILS AND ANY SURFACE BEHIND IT.

<u>COAT CLOSET</u> - (1) ROD AND (1) SHELF - LINEN CLOSET (4) SHELVES MIN

- 6'-4" BELOW ALL BEAMS, & DUCTS

#### LIFE SAFETY SUMMARY FIRE PROTECTION SYSTEMS

R313.2 AMENDED

EMERGENCY ESCAPE

3Ø3.8

R308 GLAZING

308.1 - 308.6.9

311.7

R315 CARBON

MONOXIDE

REQUIRED: ONE-HOUR FIRE SEPARATION BETWEEN UNITS WHEN TESTED IN ACCORDANCE WITH ASTM E-119 OR UL 263 SPRINKLER SYSTEM NOT REQUIRED: ONE AND TWO FAMILY DWELLINGS WITH AN

AGGREGATE BUILDING AREA LESS THAN 14,400 SF, ARE NOT REQUIRED TO INSTALL

A SPRINKLER SYSTEM. CONCEALED FIREBLOCKING AND DRAFTSTOPPING SPACES AS PER SECTION R302.11 AND R302.12

EGRESS/OCCUPANCY UNIT #1 = 1131 SF/200 = 6 OCCUPANTS UNIT #2 = 1502 SF/200 = 8 OCCUPANTS 8(.15)=1.2" - LESS THAN 36" DOORS 36"/0.15=240 PEOPLE PER LEAF (2 DOORS @ LEVEL OF EXIT DISCHARGE) x 240 =480 OCC. MAX 480 IS GREATER THAN 8 OCCUPANTS.

EMERGENCY ESCAPE AND RESCUE OPENINGS ARE BEING INSTALLED.

R301 DESIGN DESIGN TO COMPLY W/ IRC DESIGN CRITERIA. SEE STRUCTURAL CRITERIA R302 FIRE RATING 302.3 - TWO FAMILY TWO FAMILY DWELLINGS TO BE TREATED AS SEPARATE BLDGS, DWELLING WALLS RATED PER TABLE 302.1

EXT WALL LESS THAN 5' SEPARATION = 1 HR RATED. TABLE 302.1 302.2.1 RATING TO EXTEND TO EXTERIOR SHEATHING.

3Ø2.2.4 ONE HOUR SEPARATION PROVIDED PER TABLE 302.1 AND R302.3 PENETRATIONS THROUGH RATED ASSEMBLIES SHALL COMPLY WITH THIS SECTION 3Ø2.4 3Ø2.5 WALL AND CEILING FINISHES - FLAME SPREAD INDEX NOT GREATER THAN 200

302.6 - SMOKE-DEVELOPED INDEX NOT GREATER THAN 450 302.9 FIREBLOCKING TO BE PROVIDED IN COMPLIANCE WITH THIS SECTION. DRAFTSTOPPING TO BE PROVIDED IN COMPLIANCE WITH THIS SECTION. 302.11 PROVIDE COMBUSTIBLE INSULATION W/ 3" CLEARANCE FOR AT HEAT PRODUCING FIXTURES

3Ø2.12 3Ø2.13 R303 LIGHT / HYAC

3Ø3.1 HABITABLE ROOMS TO PROVIDE GLAZING AT 8% FLOOR AREA. 4% SHALL BE OPERABLE. 3Ø3.3 TOILET ROOMS SHALL BE MECHANICALLY VENTED 3Ø3.4 INTAKE AND EXHAUST OPENINGS SHALL COMPLY

3Ø3.5 OPENING PROTECTION SHALL BE PROVIDED 3Ø3.6 STAIRWAYS SHALL BE ILLUMINATED. CONTROLS TO BE LOCATED PER THIS SECTION 3Ø3.7 GLAZED OPENINGS SHALL OPEN TO A PUBLIC ALLEY OR YARD.

A HEATING SYSTEM SHALL BE INSTALLED IN COMPLIANCE WITH THIS CODE. COORD W/ D/B HEATING SUB-CONTRACTOR R304 MIN AREA

R305 CEILING HT MIN. HABITABLE CEILING HEIGHTS WILL CONFORM WITH THIS SECTION - 1'-0" HABITABLE SPACE - 5'-0" MIN AT SLOPED ROOFS - 6'-8" AT RESTROOMS AND BASEMENT

PROJECT COMPLIES

- 6'-4" B.O. BEAMS, GIRDERS, OR DUCTS R307 SANITATION TOILET FIXTURE CLEARANCES SHALL CONFORM W/ FIGURE R307.1 COORD. W/ 248 CMR 10 NON-ABSORBANT SHOWER ENCLOSURES SHALL EXTEND TO 6'-0" AFF. 3Ø7.2

R309 GARAGE GARAGE FLOOR TO BE NON-COMBUSTIBLE AND SLOPED TO DRAIN TOWARD CAR 3Ø9.1 GARAGES IN FLOOD HAZARD AREAS SHALL CONFORM W/ THIS SECTION 309.3

GLAZING TO CONFORM WITH THESE SECTIONS

R310 EMERGENCY BASEMENTS, HABITABLE ATTICS, AND EVERY SLEEPING ROOM SHALL HAVE AN ESCAPE EMERGENCY EXIT IN CONFORMANCE WITH THIS SECTION AS AMENDED. R311 EGRESS EACH DWELLING TO PROVIDE TWO MEANS OF EGRESS - 2 PROVIDED 311.1

MIN CLEAR EGRESS DOOR WIDTH: 32" 311.2 MIN CLEAR INTERIOR DOOR WIDTH: 30" (6'-8") 311.3 36" LANDING AT EACH SIDE OF DOOR MIN. 311.4 VERTICAL EGRESS TO CONFORM WITH R311.7 AND R311.8 (STAIR OR RAMP) 311.6

HALLWAYS: 36" MIN WIDTH STAIRWAYS SHALL BE MIN. 36" & CONFORM W/ THIS SECTION THE EXISTING UNIT # 2 ENTRY STAIRS ARE PROPOSED TO BE EXISTING NON CONFORMING TO REMAIN, THE EXISTING STAIR WIDTHS AND WINDER TREADS ARE INCOMPLIANT WITH REQUIREMENTS OF THE 2009 IRC AS AMENDED, THE STAIR WIDTHS ARE 2" & 1" TOO NARROW. THE EXISTING BEARING WALL LOCATIONS TO REMAIN IMPEDE THE ALTERATIONS TO COMPLY WITH THE 36" MIN. REQUIREMENT, CONSIDERING THE EXISTING BEARING WALL LOCATIONS & OCCUPANT LOAD OF UNIT #2 WE WOULD LIKE TO PROPOSE TO LEAVE THE NONE COMPLYING STAIRS AS EXISTING TO REMAIN.

R312 GUARDS GUARD: REQUIRED AT STAIRS, LANDINGS, PORCHES, ECT GREATER THAN 30" HIGH 312.2 GUARD: 36" MIN. HIGH TYP. GUARD: 34" MIN. AT OPEN STAIR, 34" TO 38" WHEN USED AS HANDRAIL. 312.3 4" MAX OPENING IN GUARD TYP. (SEE EXCEPTIONS) R314 SMOKE ALARM

PROVIDE PHOTOELECTRIC SMOKE ALARMS IN COMPLIANCE WITH THIS SECTION 314.3 TYP. LOCATIONS: IN EACH SLEEPING ROOM OUTSIDE, IN THE VICINITY OF, EACH SLEEPING AREA AT EACH HABITABLE LEVEL AT BASE OF STAIRS LEADING TO A HABITABLE AREA

PROVIDE ALARMS IN COMPLIANCE WITH THIS SECTION

FOR EACH 1,200 S.F. OF AREA.

#### SCOPE / ZONING SUMMARY

		•				
DEFINITION	TWO FAMILY DWELLING					
780 CMR 101.2	DETACHED ONE AND TWO-FAMILY DWELLINGS AND MULTIPLE SINGLE-FAMILY DWELLINGS (TOWNHOUSES) NOT MORE THAN THREE STORIES ABOVE GRADE PLANE IN HEIGHT WITH A SEPARATE MEANS OF EGRESS AND THEIR ACCESSORY STRUCTURES SHALL COMPLY WITH THE INTERNATIONAL RESIDENTIAL CODE. (R-3 USE GROUP PER MA AMENDMENTS)					
SCOPE OF WORK SUMMARY	THE EXISTING VACANT FUNERAL HOME IS TO BE CONVERTED INTO A 2 FAMILY DWELLING WITH HORIZONTALLY DIVIDED UNITS. THE STRUCTURE IS EXISTING TO REMAIN WITH ALTERATIONS. THERE IS TO BE AN ADDITION IN THE REAR OVER THE EXISTING KITCHEN, & TWO 3RD FLOOR DORMER ADDITIONS, THE EXISTING VESTIBULE WILL BE ALTERED TO SERVE AS AN ENTRY PORTICO FOR THE TWO DWELLINGS. A 2ND FLOOR DECK WILL BE ADDED IN THE REAR AND SERVE AS A SECOND MEANS OF EGRESS					
	REQUIRED	ACTUAL				
LOT AREA MINIMUM	5,000 SF FOR 1 OR 2	5,286 SF COMPLIES				
	REQUIRED	ACTUAL				
LOT WIDTH MINIMUM	40'	57' COMPLIES				
	REQUIRED	ACTUAL				
LOT FRONTAGE MINIMUM	40'	TI' COMPLIES				
FLOOR AREA RATIO MAXIMUM	ALLOWED	PROPOSED	SEE FAR CALCS ON TITLE SHEET			
	2643'	2642' COMPLIES				
	ALLOWED	ACTUAL	HALF STORY REQUIREMENTS = FLOOR AREA AT 4' ABOVE			
BUILDING STORIES	2 1/2	2 1/2 COMPLIES	FLOOR IS LESS THAN ½ FLOOR AREA BELOW  & FLOOR AREA AT 1'-4" ABOVE FLOOR IS MORE THAN ½ THE HALF STORY AREA  2ND FLOOR NET SF = 1111 1111 X .5 = 588  568 = 3RD FLOOR NET SF AT 4' ABOVE FLOOR 568 IS LESS THAN 588 = PROJECT COMPLIES  208 = 3RD FLOOR NET SF AT 1-4' ABOVE FLOOR 568X .33 = 181 = ½ 3RD FLOOR AREA 208 IS GREATER THAN 181 = PROJECT COMPLIES			
	ALLOWED	ACTUAL				
BUILDING HEIGHT MAXIMUM	35	30'-3" COMPLIES				
	REQUIRED	PROPOSED				
USABLE OPEN SPACE PER DWELLING	750 PER DWELLING	1183 EACH COMPLIES				
		A C # 11 A 1	/PPOPOSED			

		DWELLING	COMPLIES		
		REQUIRED	ACTUAL/PROPOSED		
	FRONT YARD MIN DEPTH	15'	EXISTING MAIN B EXISTING NON CO		
			REMAIN & SERVE = 9.5'	ULE FOUNDATION TO AS ENTRY PORTICO  ONFORMING TO REMAIN	
-	SIDE YARD MIN WIDTH	REQUIRED	ACTUAL	/PROPOSED	
		100'	14.8'-8.2'	Y MAIN BUILDING = ONFORMING TO REMAIN	
			NEW SECOND FLO = 15' COMPLIES	DOR ADDITION	

WIDIT		14.8'-8.2' EXISTING NON CONEW SECOND FLOE = 15' COMPLIES	ONFORMING TO REMAIN DOR ADDITION
	ALLOWED	ACTUAL	
REAR YARD MIN	2Ø	23.6 COMPLIES	

	ALLOWED	ACTUAL	
REAR YARD MAX OCCUPANCY	25 PERCENT	EXISTING COMPLIES	
	REQUIRED	PROVIDED	
PARKING	2	2	


DRAWING TITLE:

CODE SUMMARY & GENERAL REQUIREMENTS

DATE: 05/10/16

CONSTRUCTION SET ISSUED FOR PERMIT 05/10/16

ROJECT No.

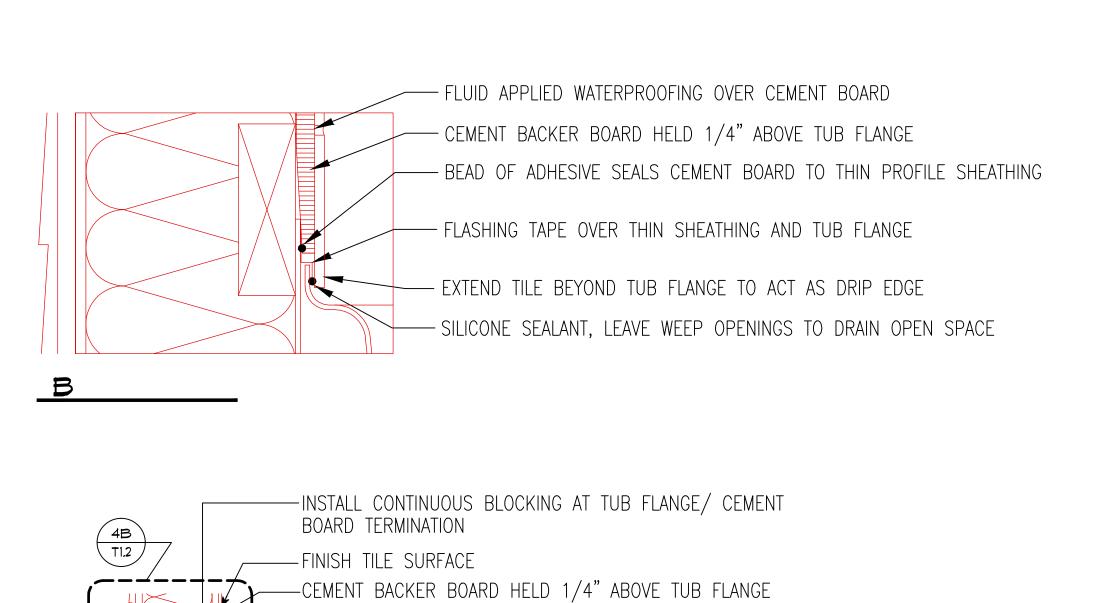

-BEAD OF ADHESIVE SEALS CEMENT BOARD TO THIN PROFILE SHEATHING

-EXTEND TILE BEYOND TUB FLANGE TO ACT AS DRIP EDGE

— THIN PROFILE SHEATHING AS DRAFTSTOP BEHIND TUB —

NOTE: AT FULL HEIGHT TUB ENCLOSURES, EXTEND

CONTINUOUS BEAD OF SEALANT BY GYPSUM BOARD INSTALLER

THIN PROFILE SHEATHING TO TOP PLATE OF FRAMED WALL.

- SEAL AROUND ROUGH OPENINGS DF WINDOWS AND DOORS, SEALANT BY SEAL ALONG TOP PLATE ON EXTERIOR WALLS, GYPSUM BOARD INSTALLER SEALANT BY GYPSUM BDARD INSTALLER — - SEAL DRYWALL TO FIRST STUD IN WALL, SEALANT BY GYPSUM BOARD INSTALLER PARTITIONS: SEAL AT TOP PLATE WHERE — ADJACENT TO AN UNCONDITIONED SPACE (SUCH AS VENTED ATTIC), SEALANT BY GYPSUM BOARD INSTALLER SEAL ALONG BOTTOM PLATE ON EXTERIOR WALLS, SEALANT BY GYPSUM BOARD INSTALLER —— ----- SEAL ALONG INSIDE OF BOTTOM OF FIRST STUD IN INTERIOR WALL, SEALANT BY GYPSUM BOARD INSTALLER

DRYWALL CAULKED, GLUED
OR GASKETED TO TOP PLATE

CEILING DRYWALL TAPED TO
WALL DRYWALL TAPED TO
WALL DRYWALL TAPED TO
WALL DRYWALL TAPED TO
OR GASKETED TO BOTTOM
PLATE
BOTTOM PLATE CAULKED OR
GASKETED TO SIB FLOOR

SUBFLOOR GLUED, CAULKED
OR GASKETED TO RIM
JOIST/RIM CLOSURE
CAULKED OR GASKETED TO
TOP PLATE

DRYWALL CAULKED, GLUED
OR GASKETED TO TOP PLATE

AIR BARRIER @ TUB ENCLOSURE

—FLASHING TAPE


—SILICONE SEALANT

EXTEND 2" ABOVE TUB FLANGE

SCALE: NTS

SCALE: NTS

2 GMB AIR BARRIER @ WALLS & CEILING PERSPECTIVE

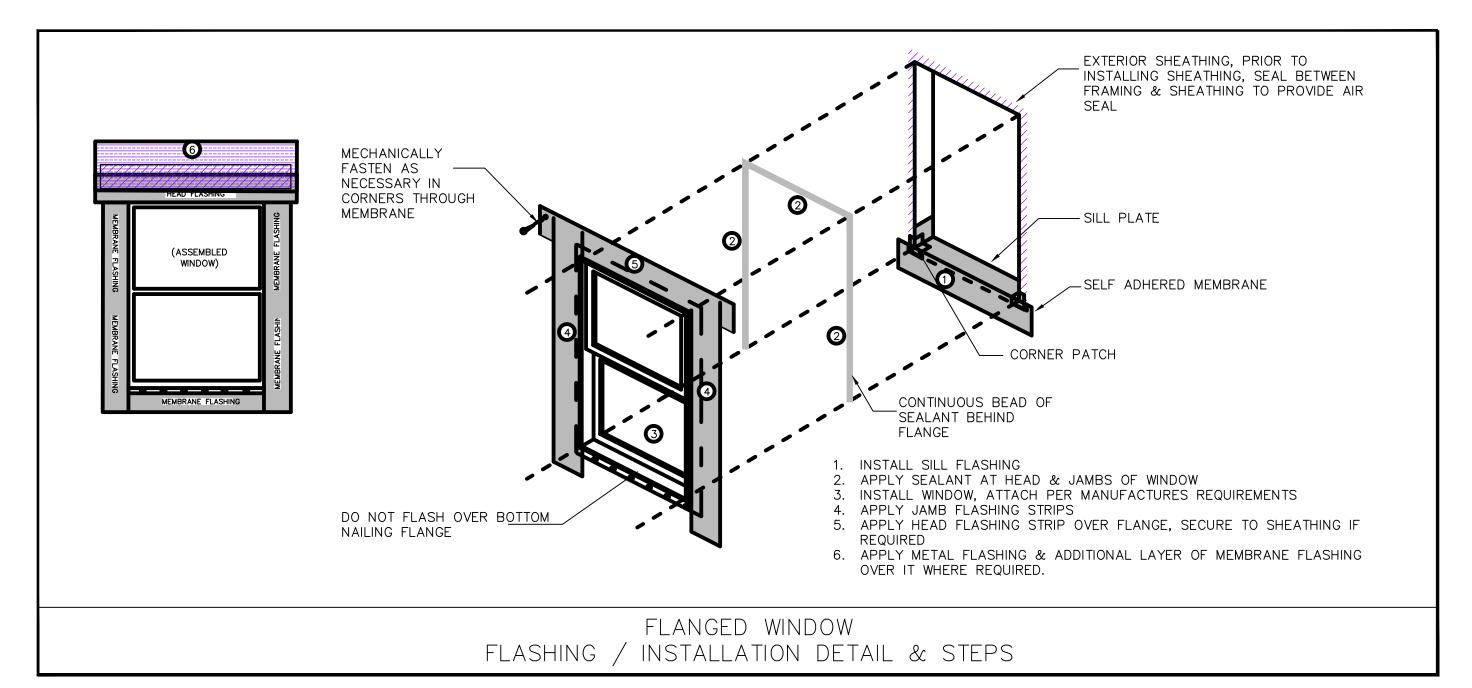

S GWB AIR BARRIER @ WALLS & CEILING PERSPECTIVE

ADDITION SEALANT / DRAFT STOPPING LOCATIONS

I. REFER TO ARCHITECTURAL DRAWINGS FOR DETAILED SEALANT/ DRAFT STOPPING LOCATIONS

- 2. ALL DOORS TO UNCONDITIONED SPACE SHALL BE INSULATED AND WEATHER-STRIPPED
- 3. CAULK THE BOTTOM PLATES OF EXTERIOR WALLS, KNEE WALLS, AND GARAGE WALLS,
- 4. SEAL ALL DUCT BOOTS TO SUBFLOOR AND CEILING
- 5. SEAL ALL PIPES TO INTERSECTING ROUGH FRAMING
- 6. TAPE ALL FLANGED VENTS TO SHEATHING
- 7. SEAL THE FLANGE OF ALL RECESSED LIGHTING FIXTURES TO AIR

8. SEAL ALL WIRING AND ELECTRICAL BOXES TO ROUGH FRAMING & AIR BARRIER

BOTTOM PLATE CAULKED OR GASKETED TO SUB FLOOR
RIM JOIST/CLOSURE CAULKED OR GASKETED TO SILL PLATE

\*\*\*\* NOTES: WALL SECTION FOR TYPICAL INTERIOR DRAFT STOPPING REFERENCE ONLY \*\*\*\*

EXAMPLE EXTERIOR WALL SECTION SHOWING TYP. SEALANT LOCATIONS

SCALE: 3/4"= 1'-0"

DRYWALL CAULKED, GLUED OR -

GASKETED TO BOTTOM PLATE

NOTES: (1) PROVIDE BLOCKING & SHEATHING AS REQUIRED FOR SEALING SURFACE  $\bigsqcup_{\text{30 Newbury Street}} + \text{assoc}_{\text{116}}$ 

DRAWING TITLE:

TYPICAL DRAFT STOPPING DETAILS


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**T3** 



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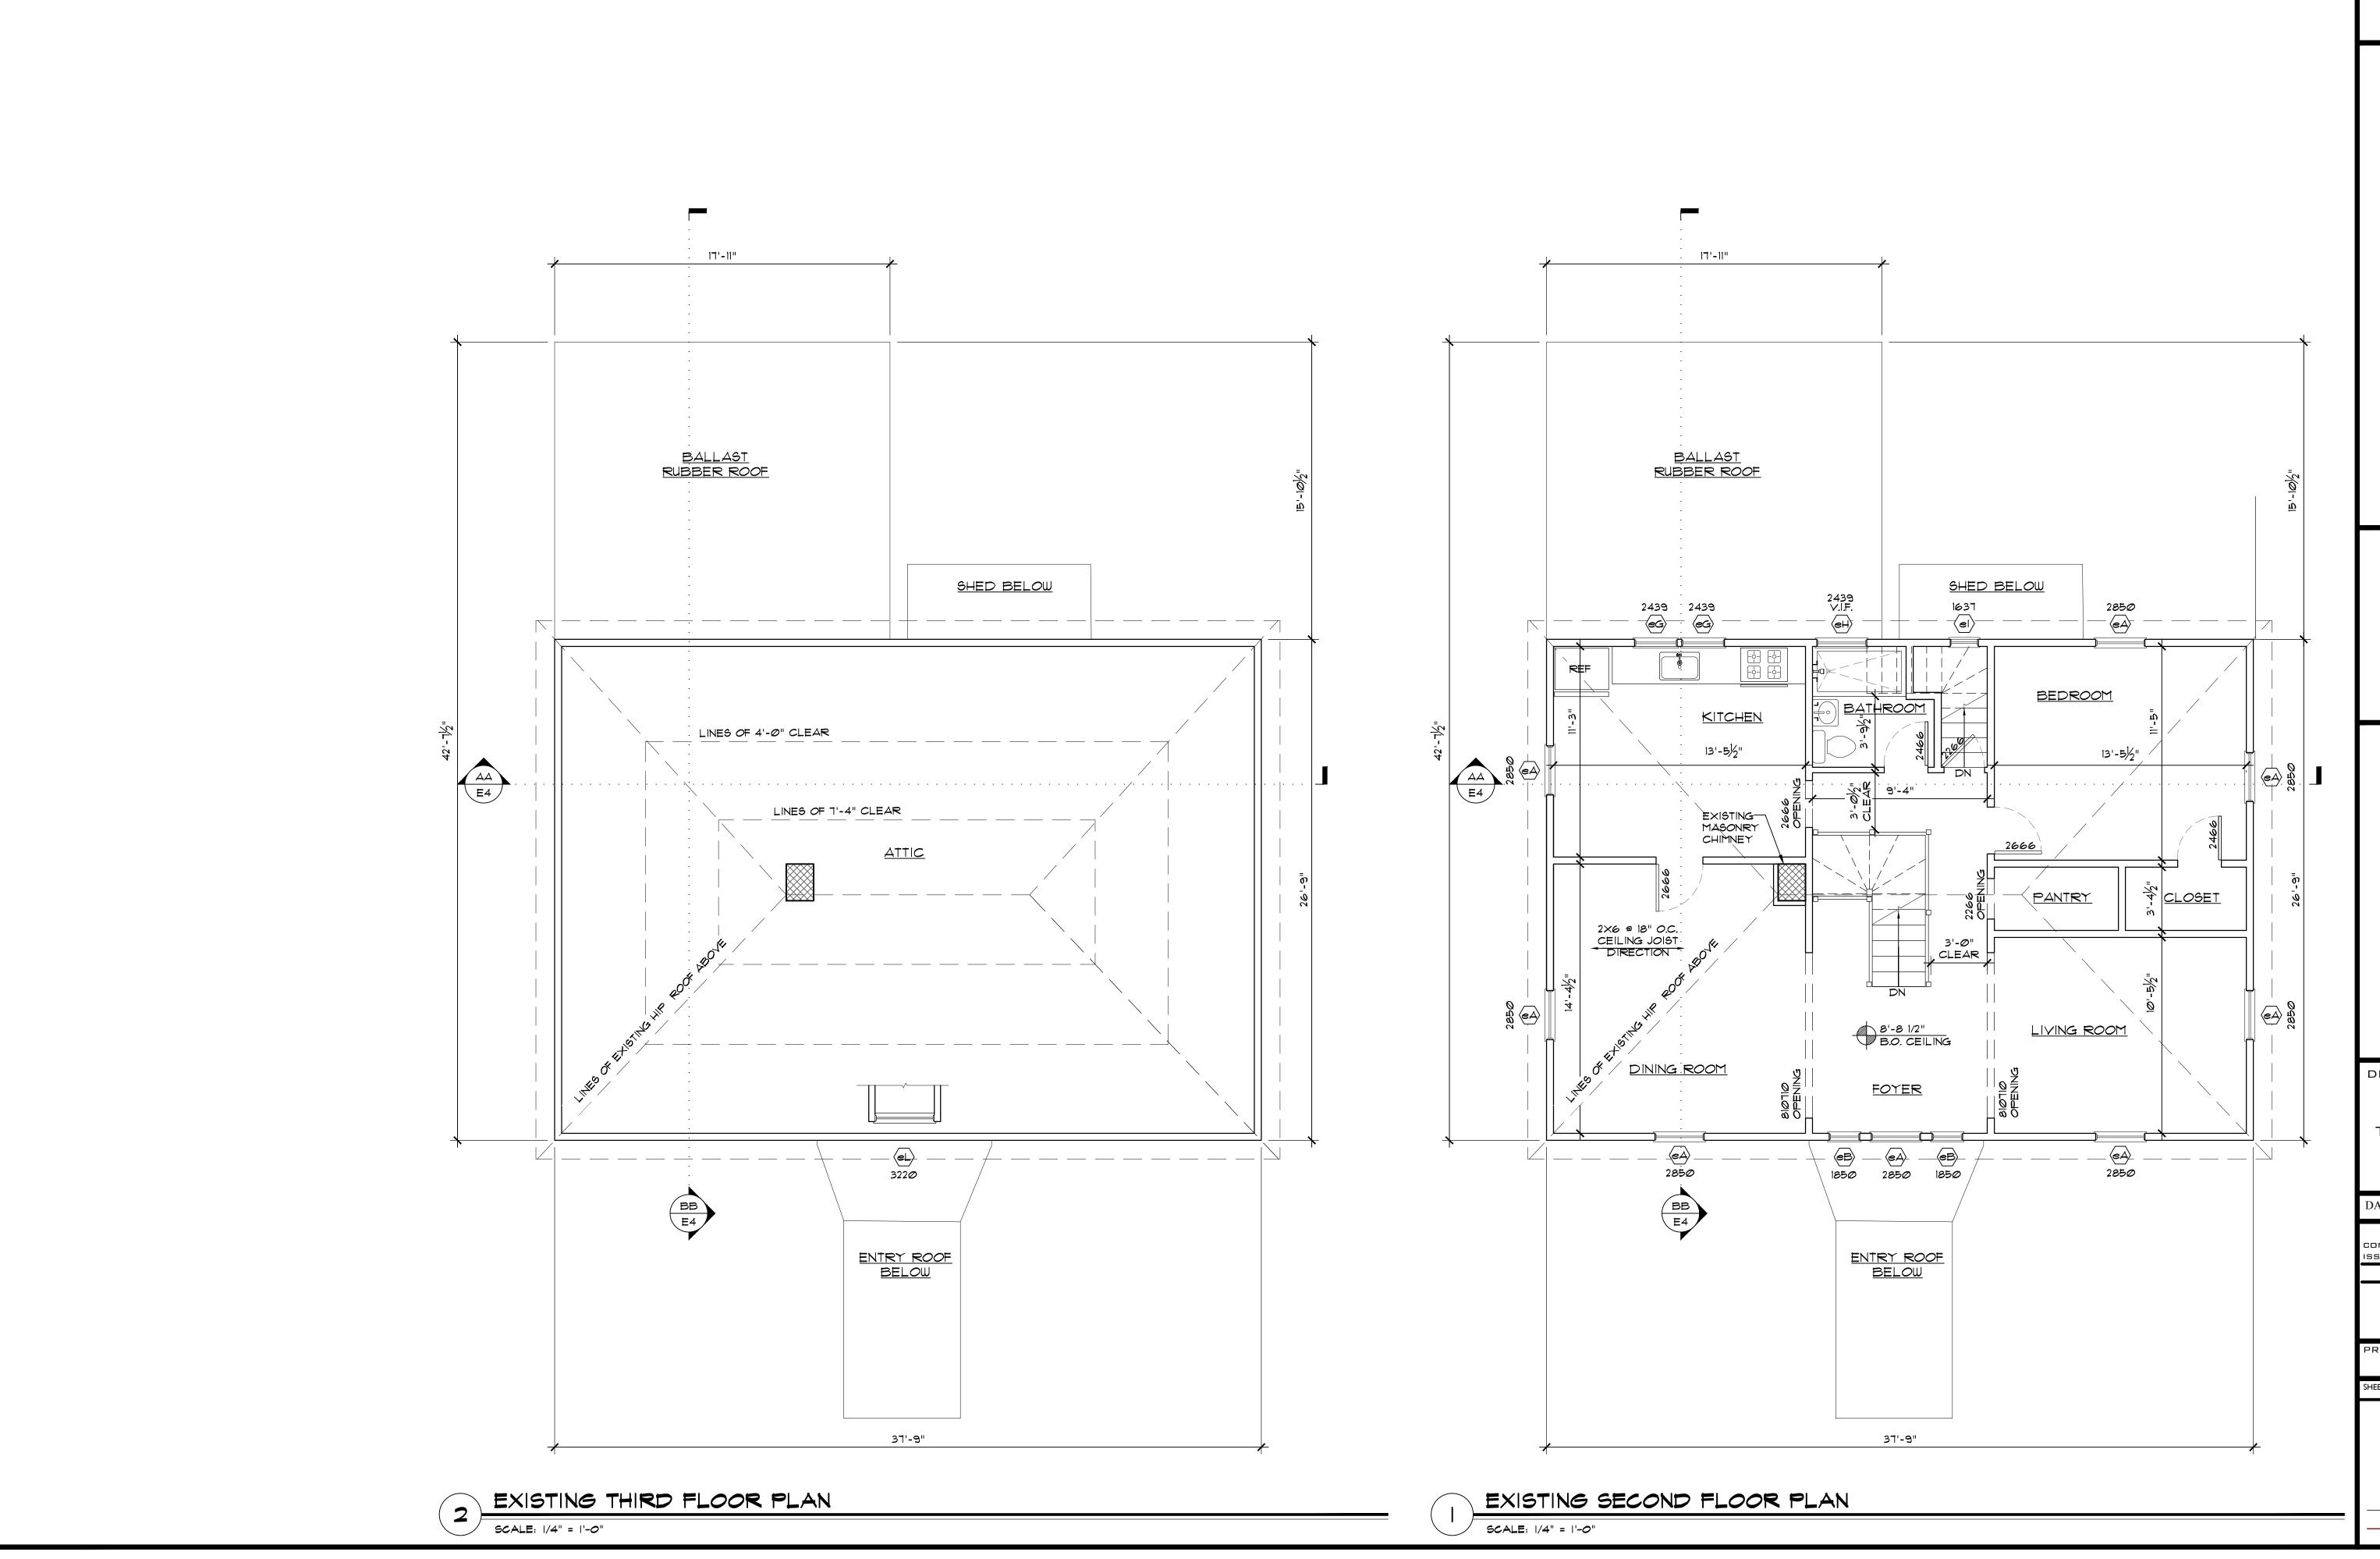
DRAWING TITLE: EXISTING BASEMENT LEVEL & FIRST FLOOR PLAN

DATE: 05/10/16

CONSTRUCTION SET ISSUED FOR PERMIT 05/10/16

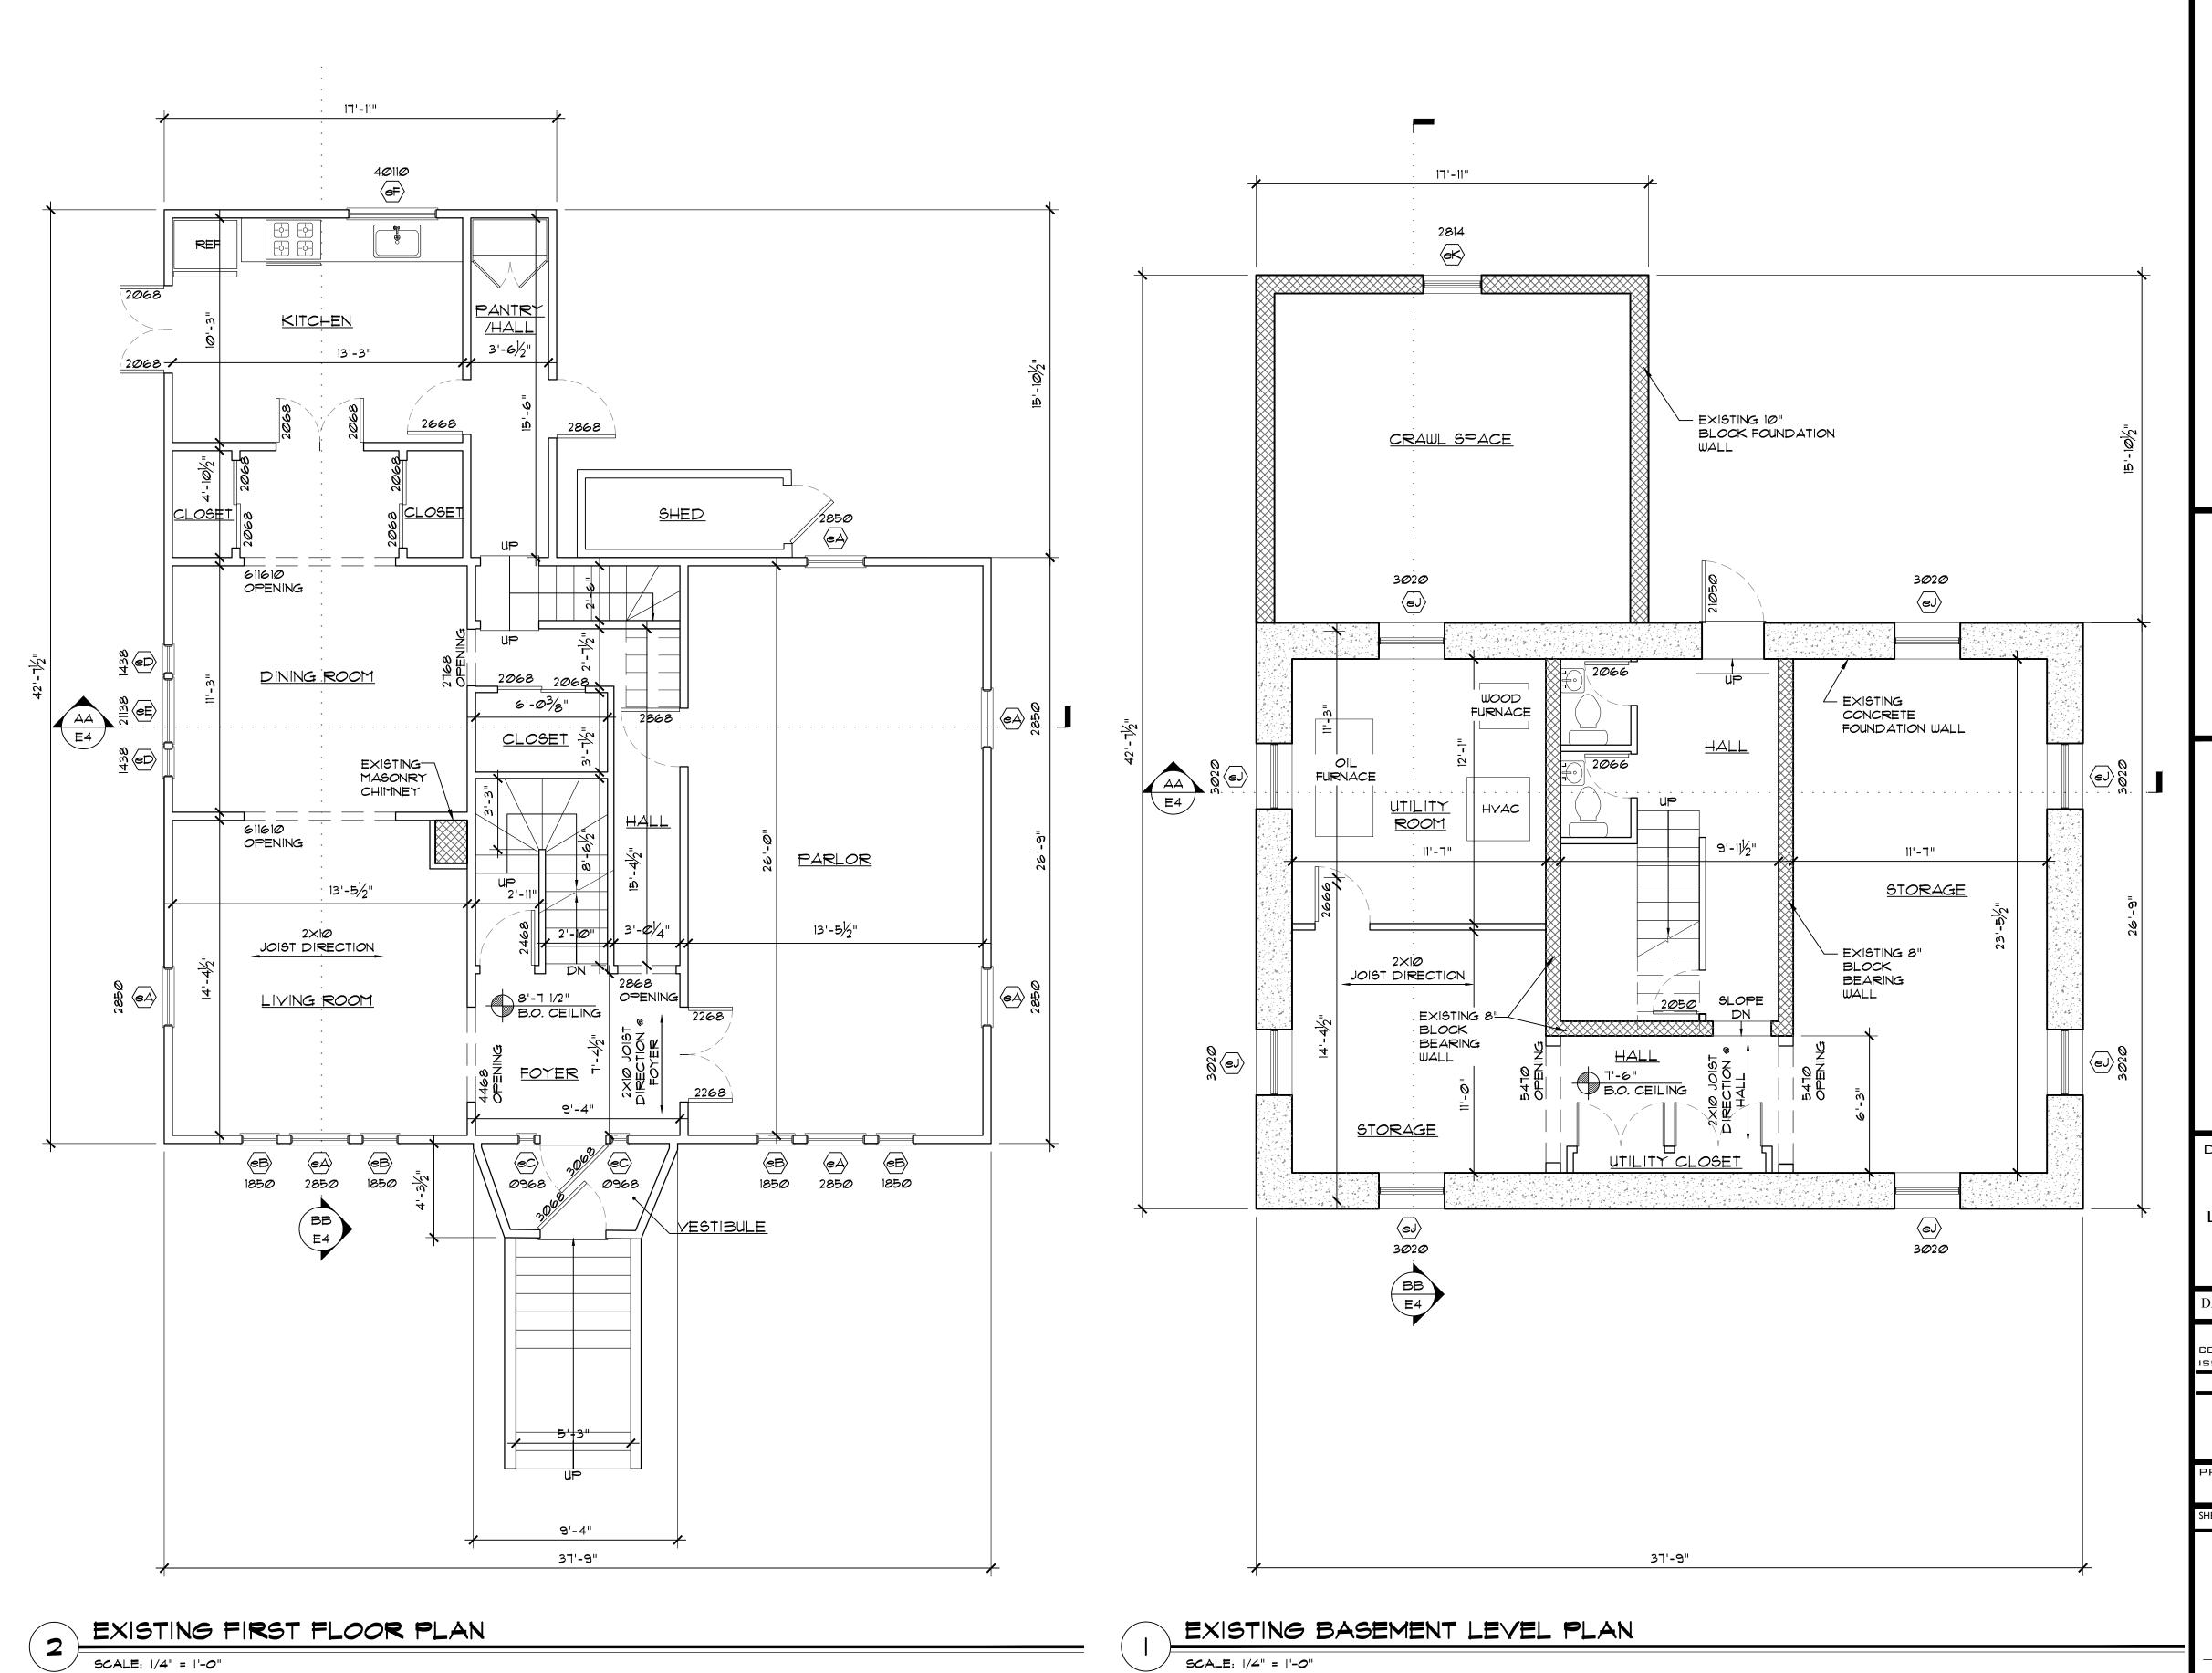PROJECT No.

SCALE: 1/4" = 1'-0"



2 FAMILY DWELLING FOR NICOYA PARTNERS 139 STOUGHTON AVE

 $\square L^2 + \text{associated}$ 

EXISTING
SECOND &
THIRD FLOOR
PLAN


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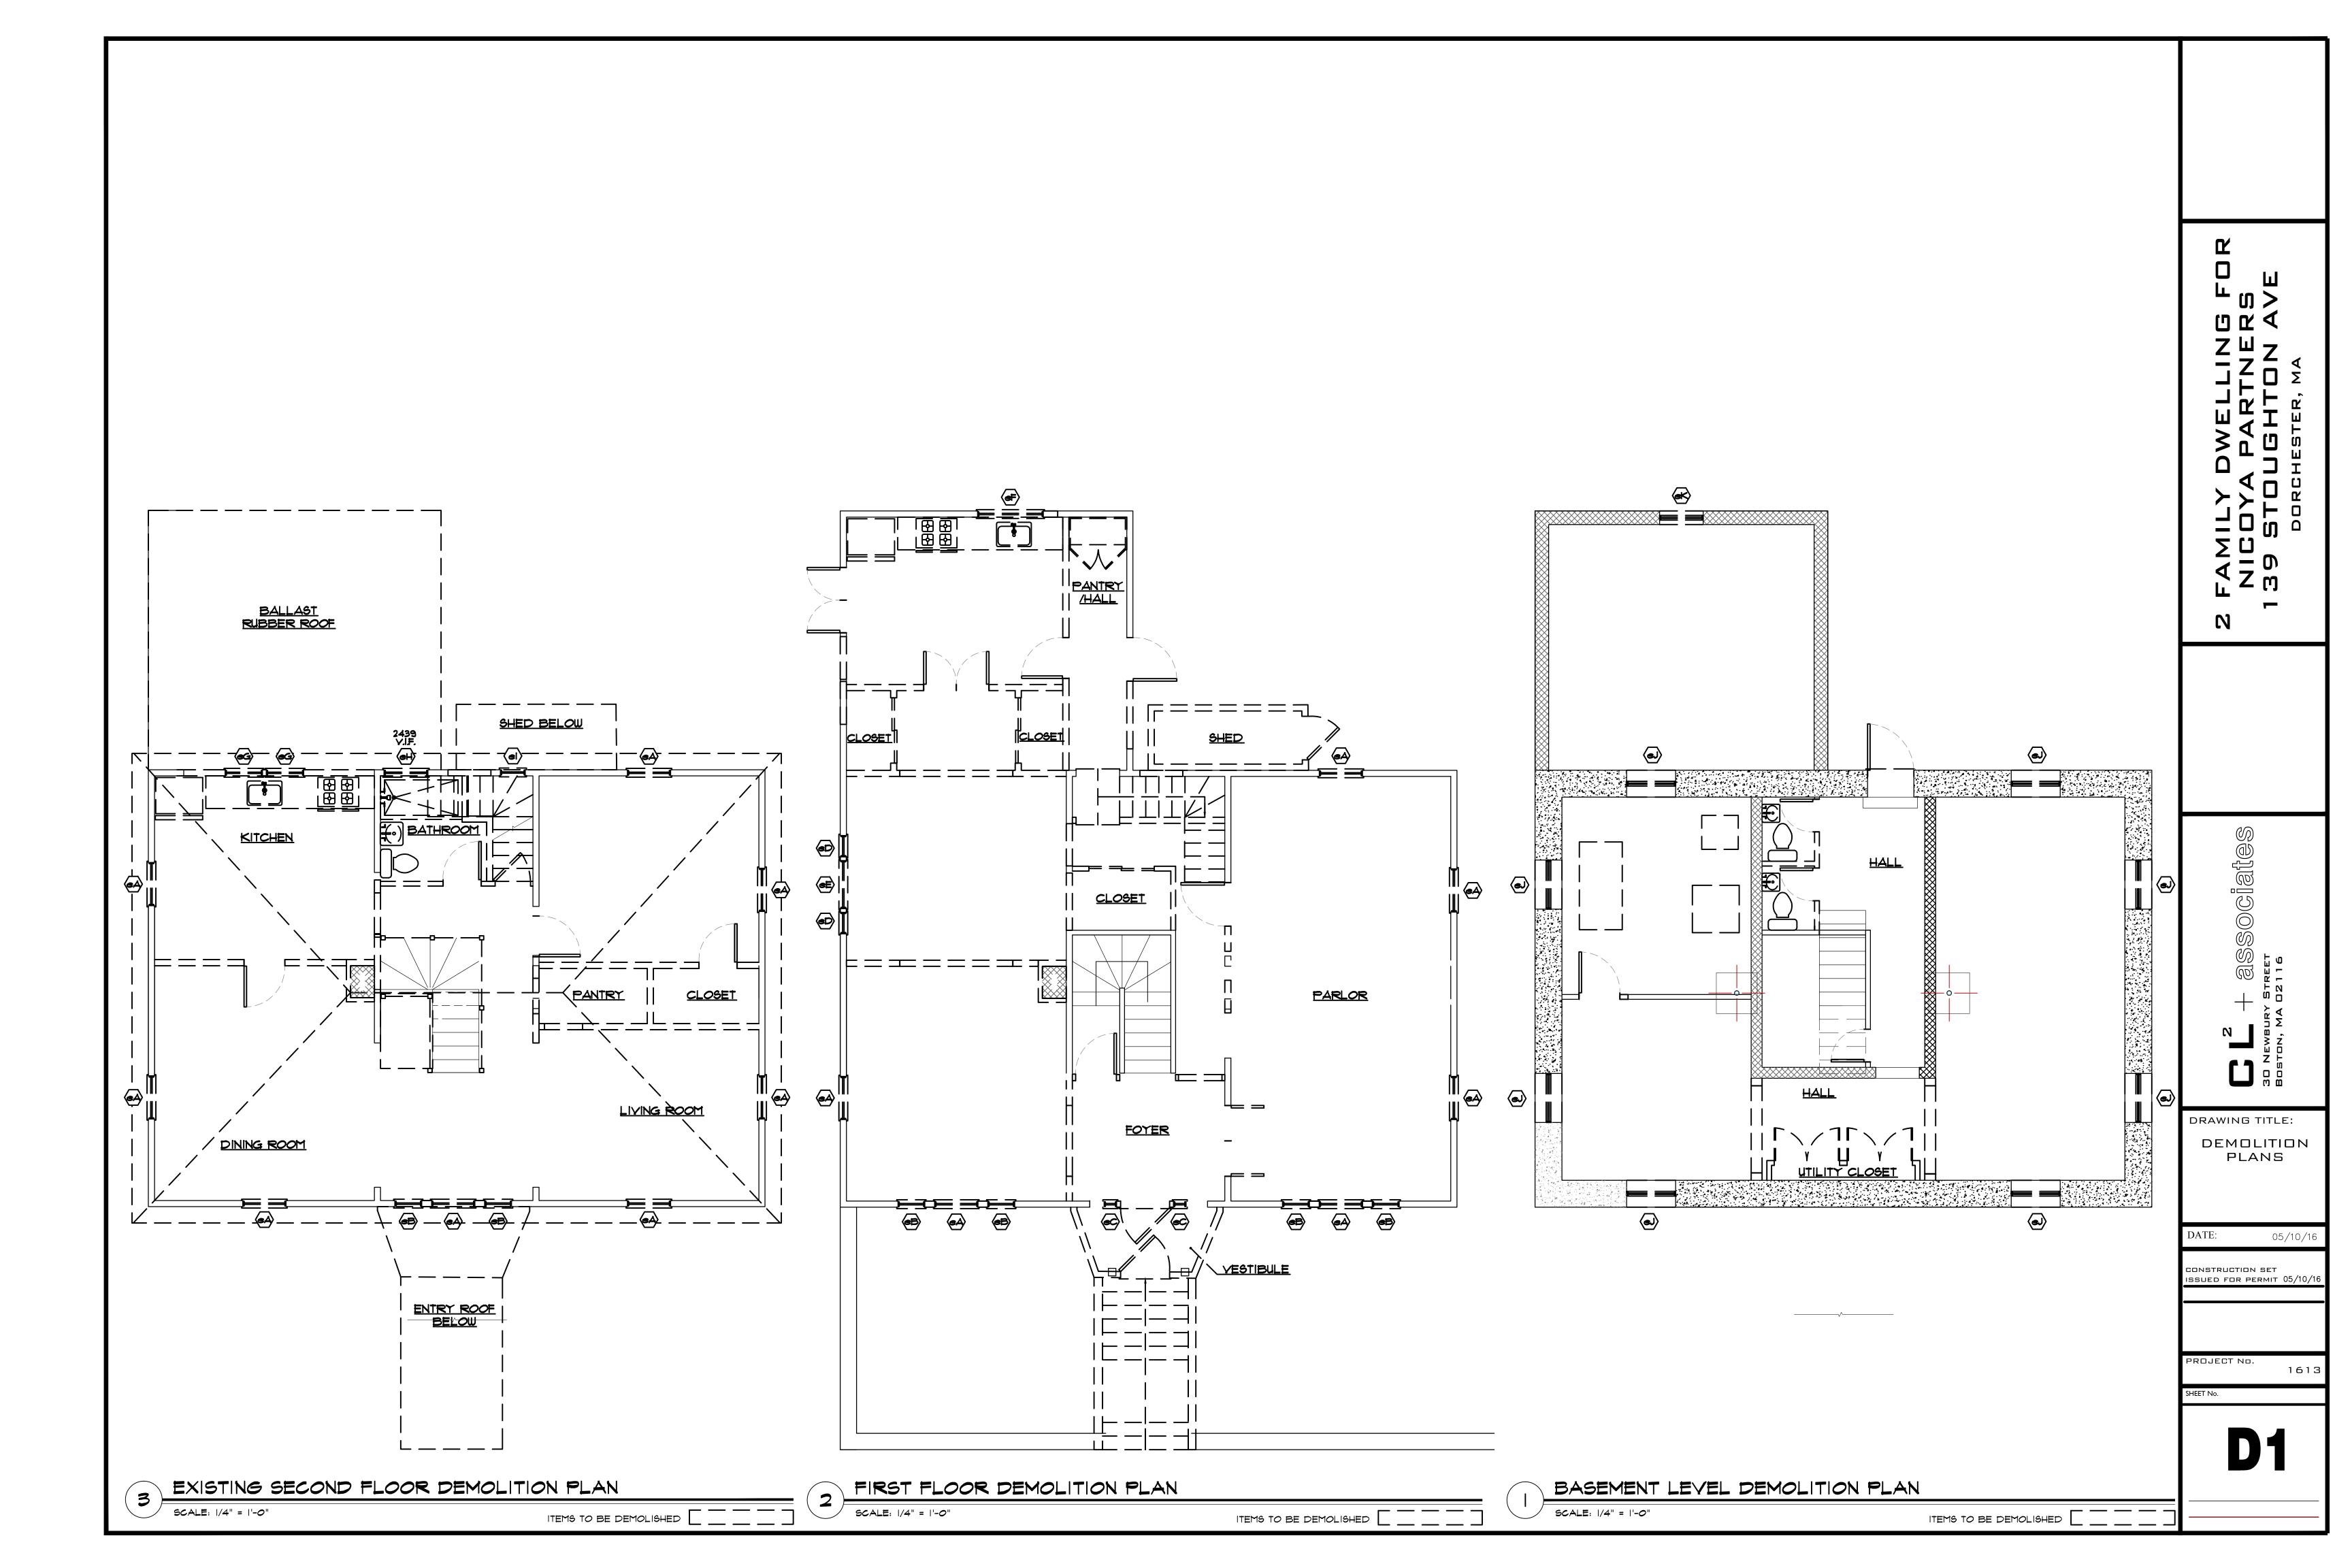
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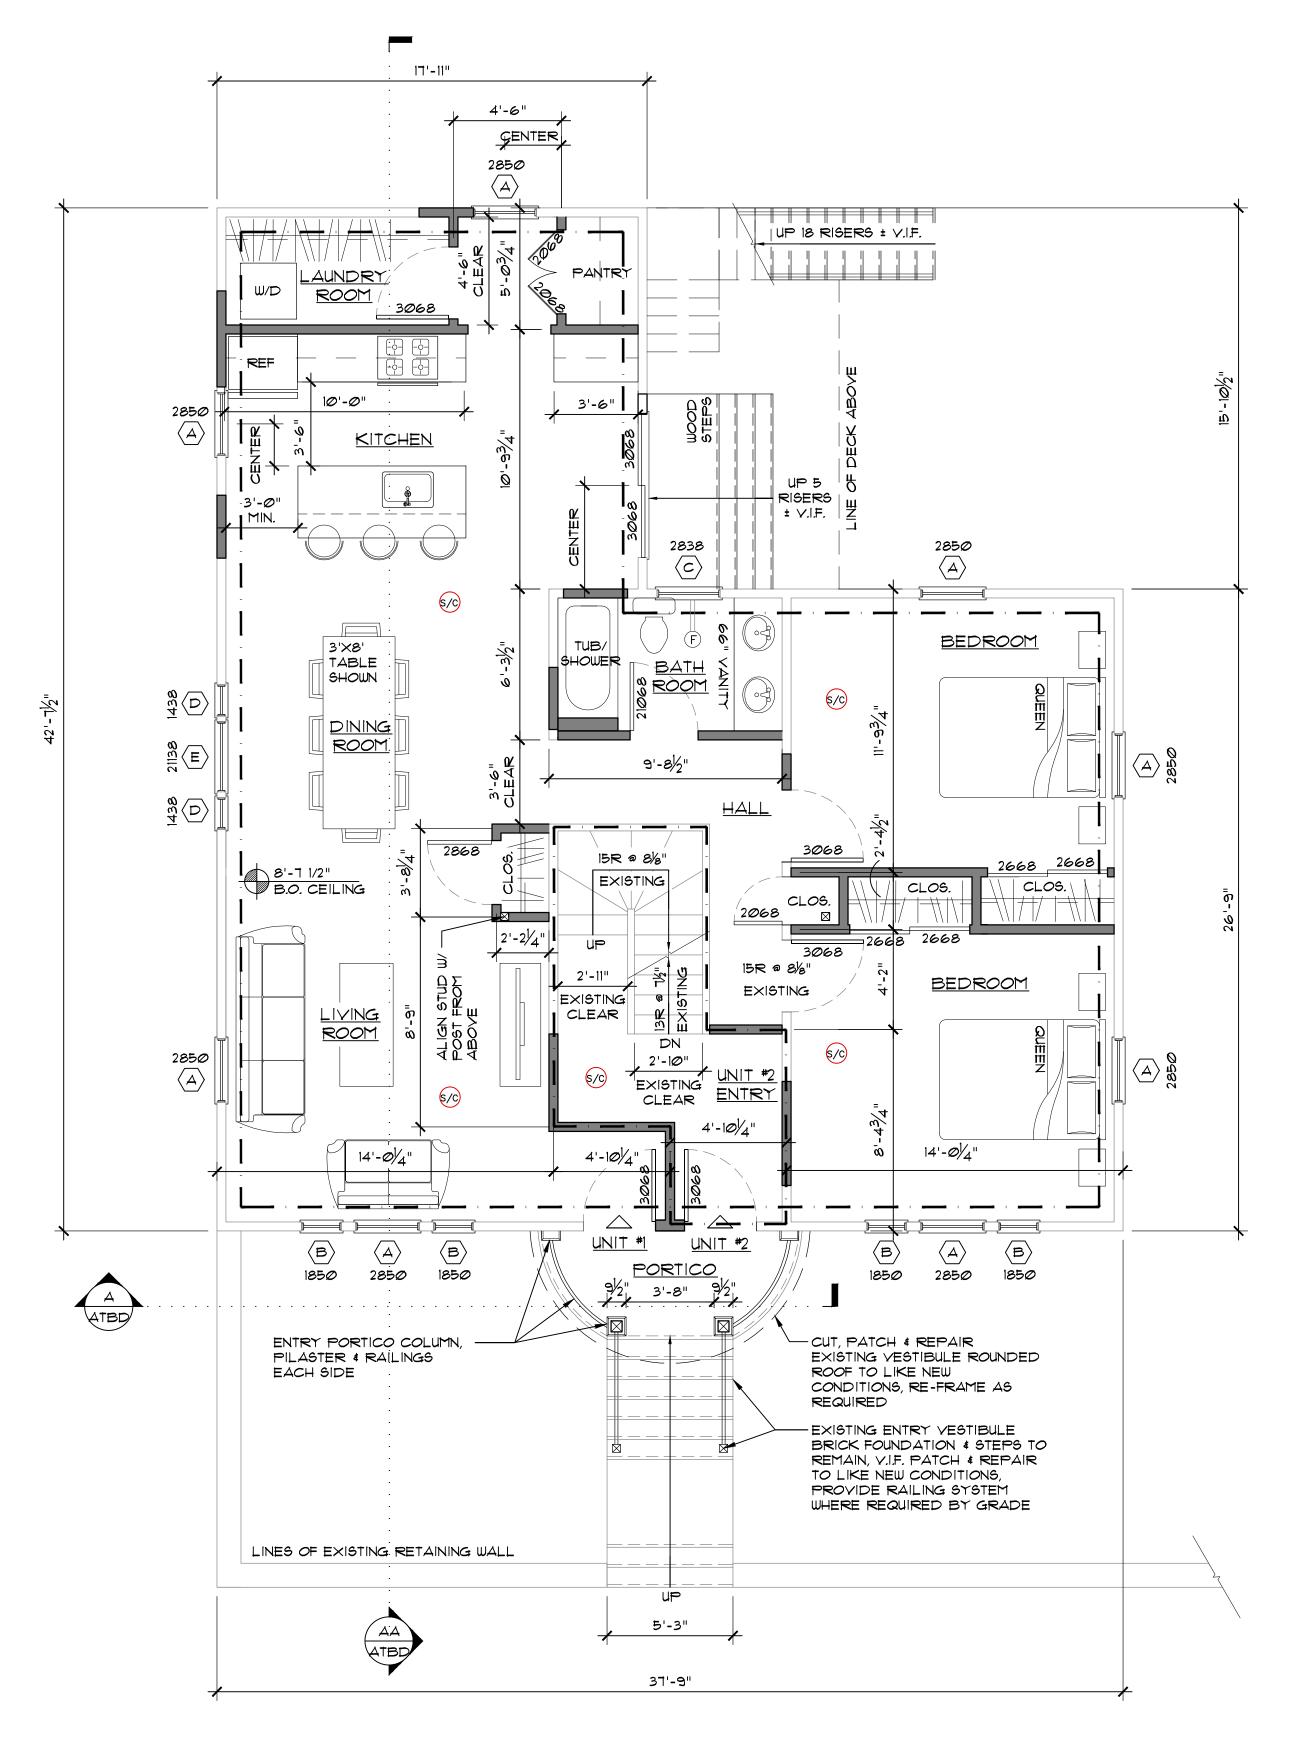
PROJECT No. 161

**E2** 








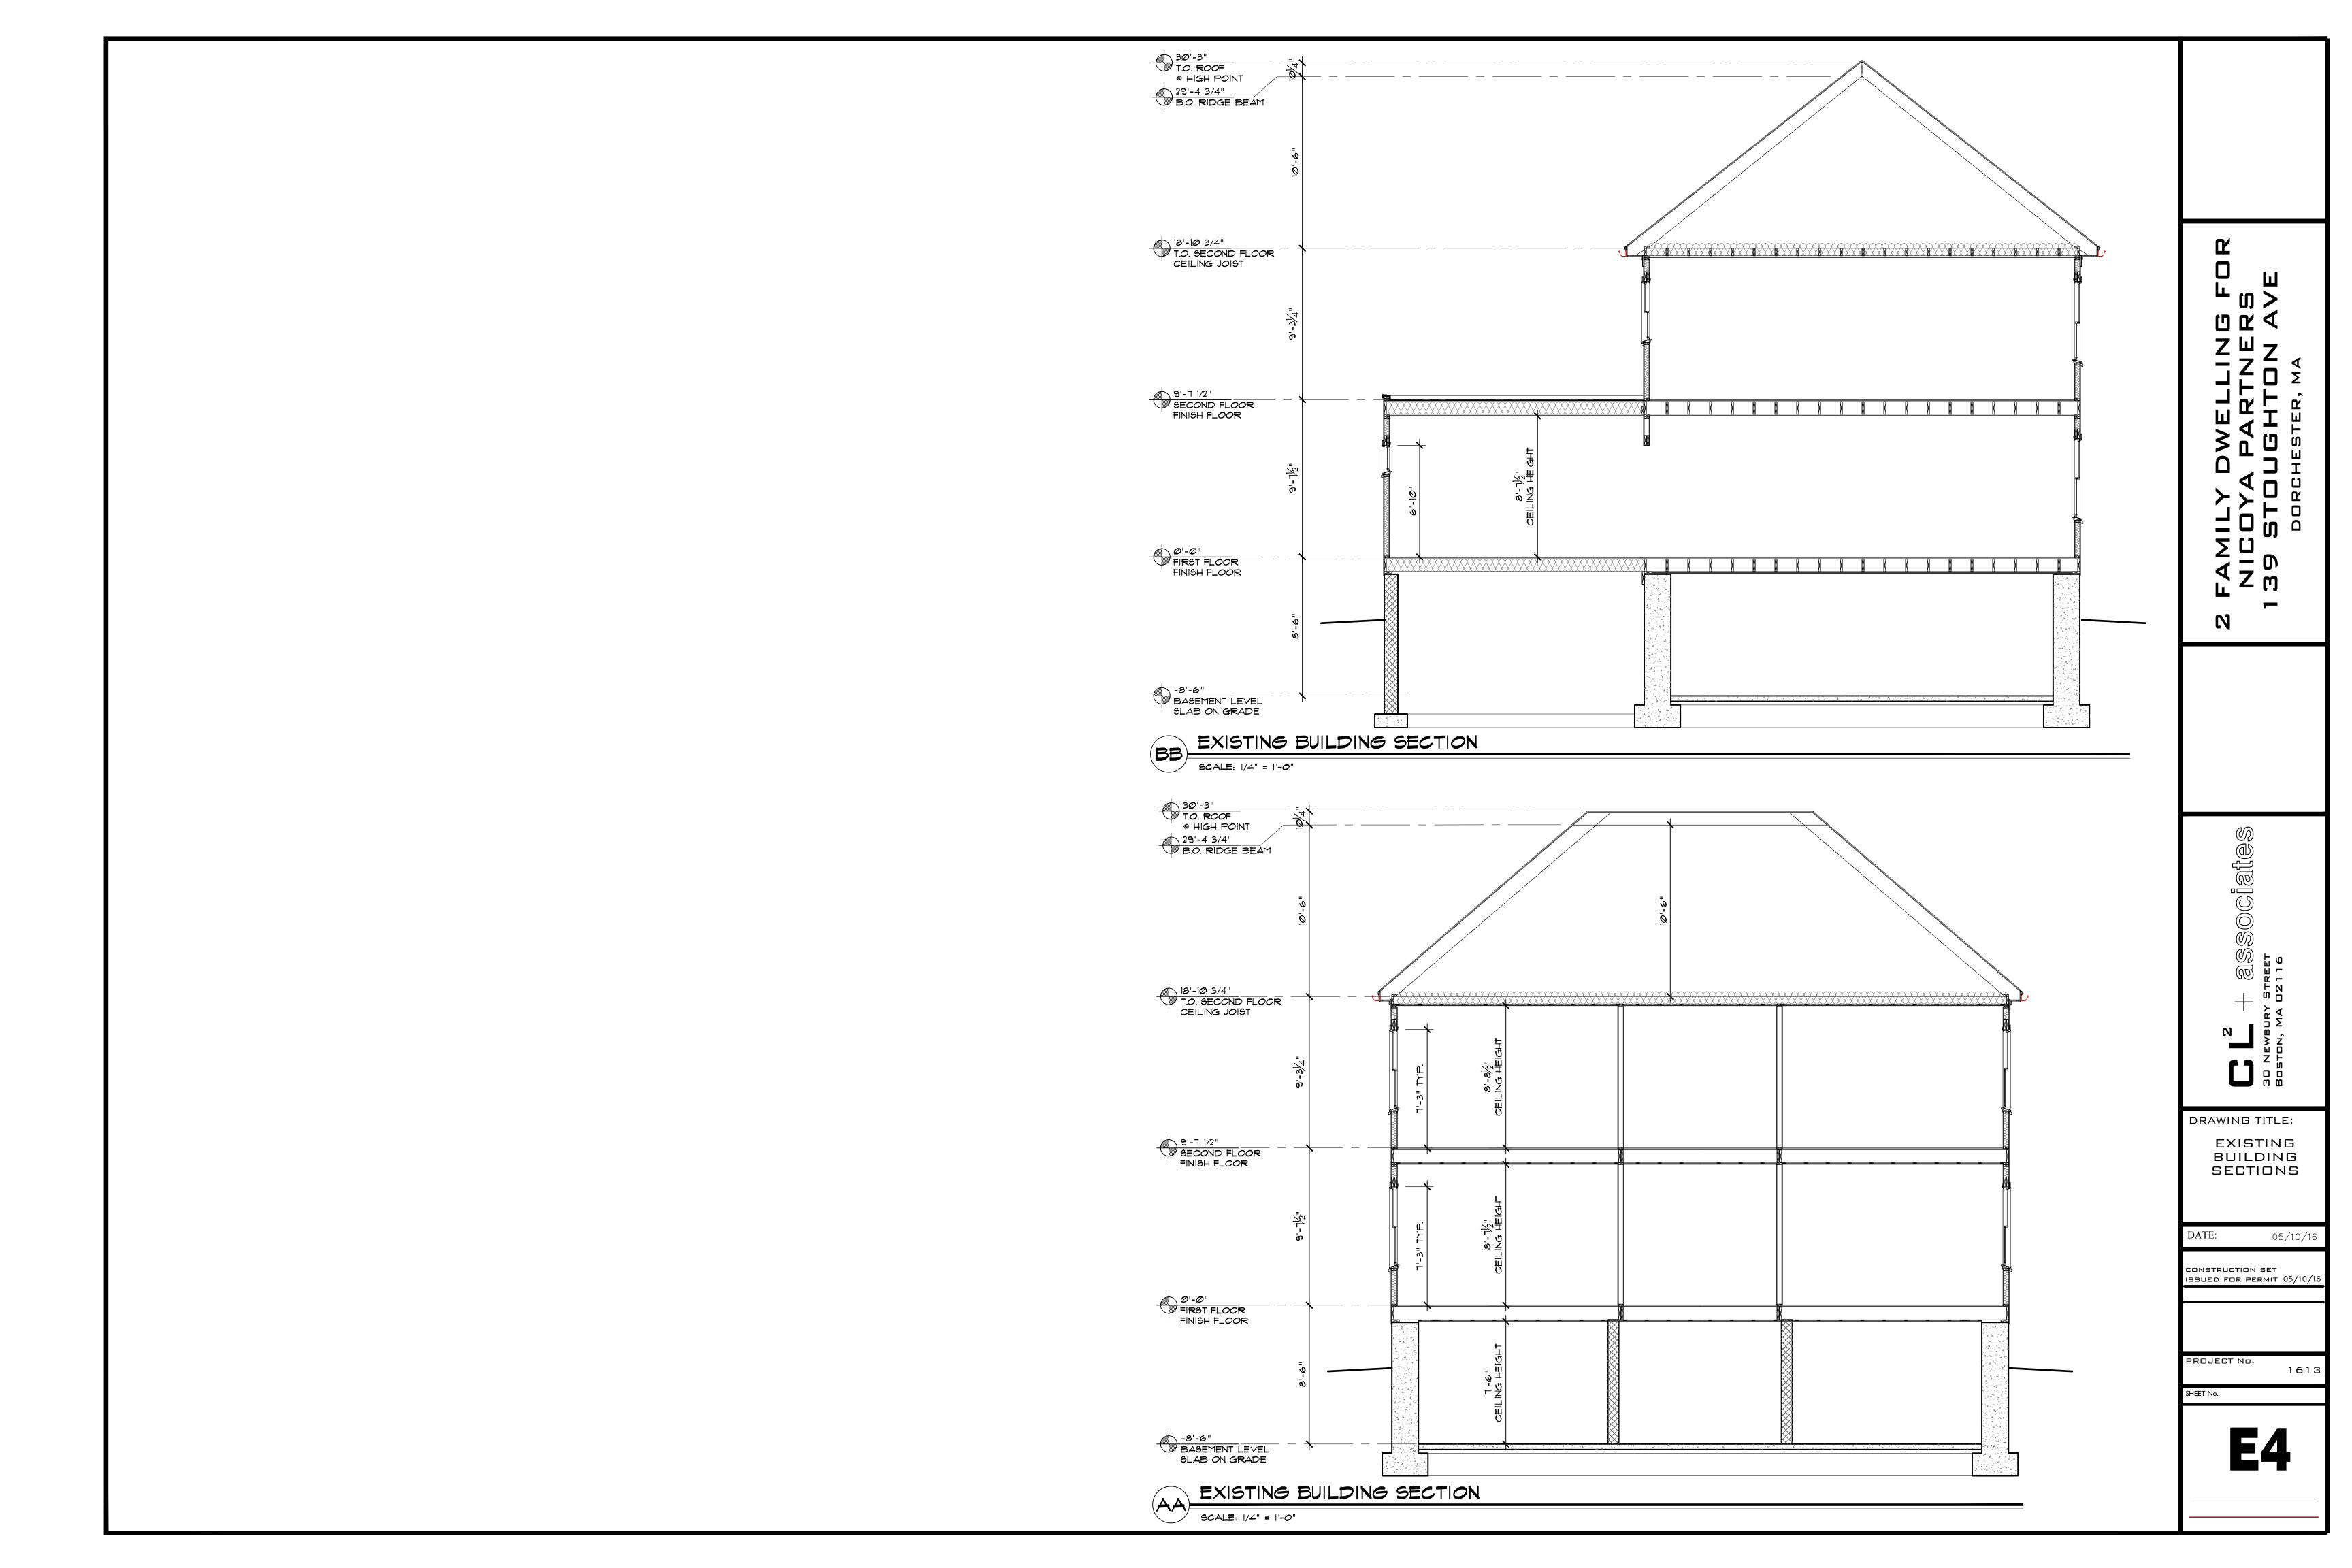

2 FIRST FLOOR CONSTRUCTION PLAN

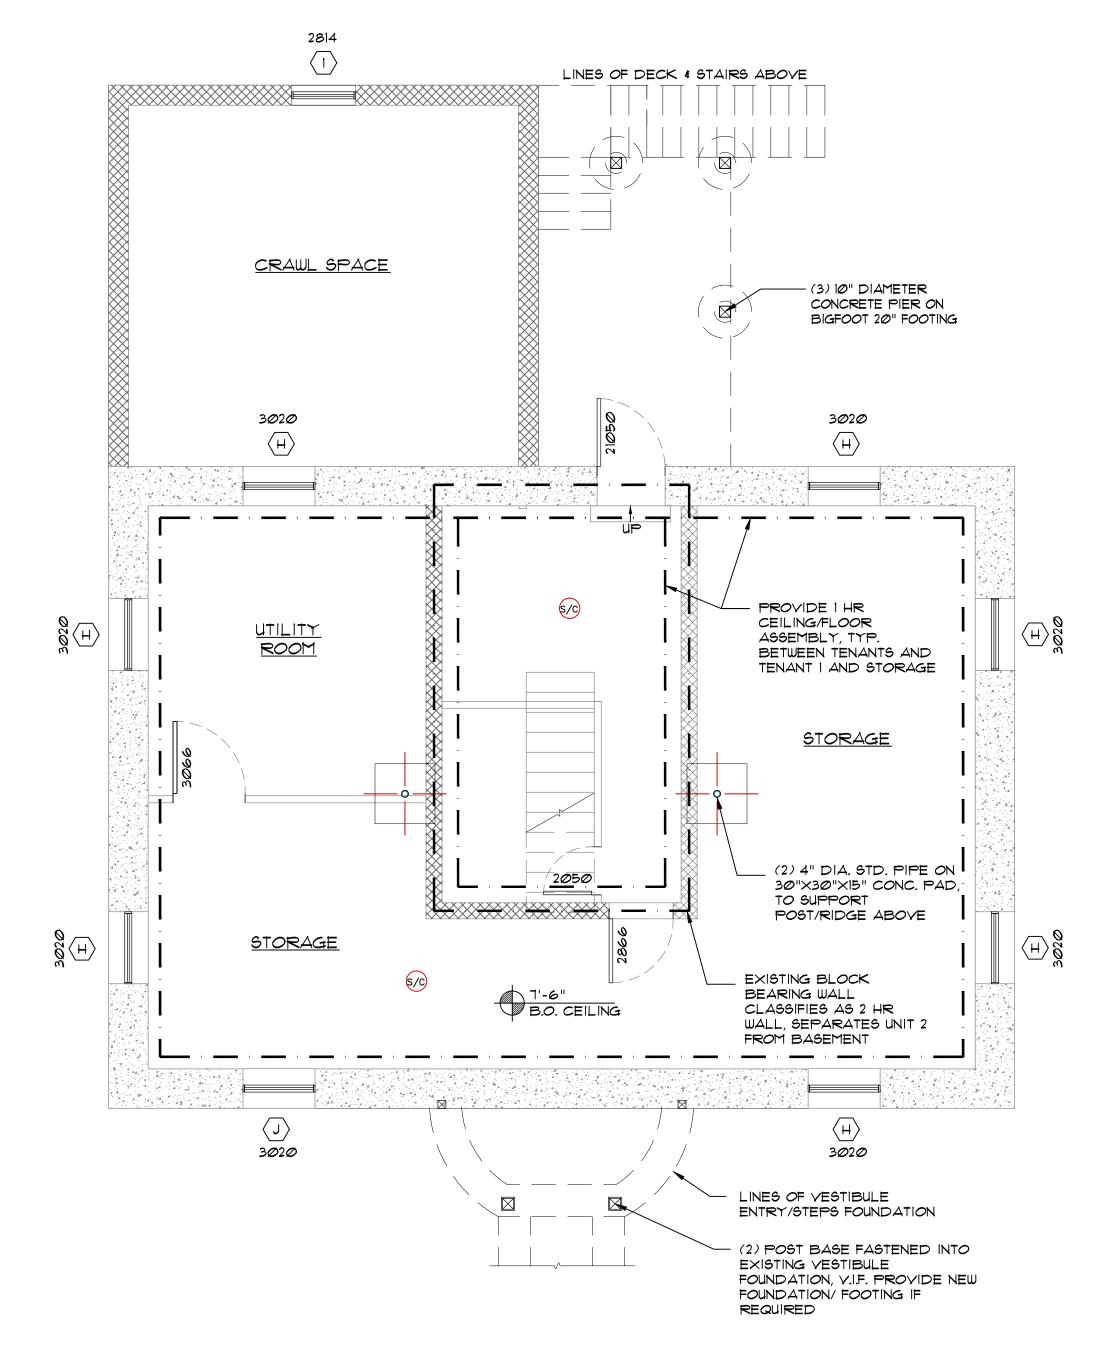

BASEMENT LEVEL/ FOUNDATION CONSTRUCTION PLAN

NEW CONSTRUCTION

SO SMOKE/CARBON MONOXIDE DETECTOR

EXISTING
CONSTRUCTION TO
REMAIN, PATCH &
REPAIRED AS
REQUIRED

NEW DOOR

F FAN VENT

NEW DOOR

CALL OUT

NOTES:

SCALE: 1/4" = 1'-0"

ALL NEW WINDOWS & DOORS ARE TO MEET ENERGY STAR QUALIFICATION CRITERIA FOR RESIDENTIAL WINDOWS & DOORS (ATTACHED) AS PER THE MASSACHUSETTS STRETCH CODE (780 CMR 115.4A) & SECTION 401.5 PRESCRIPTIVE OPTION FOR ALTERATIONS, RENOVATIONS OR REPAIRS

2 FAMILY DWELLING FO NICOYA PARTNERS 139 STOUGHTON AVE

 $\square = \square + \text{association}$ 

DRAWING TITLE:

FIRST FLOOR &

BASEMENT/

FOUNDATION

CONSTRUCTION

PLANS

DATE: 05/10/16


- - - IHR RATED ASSEMBLY

CONSTRUCTION SET ISSUED FOR PERMIT 05/10/16

PROJECT No.

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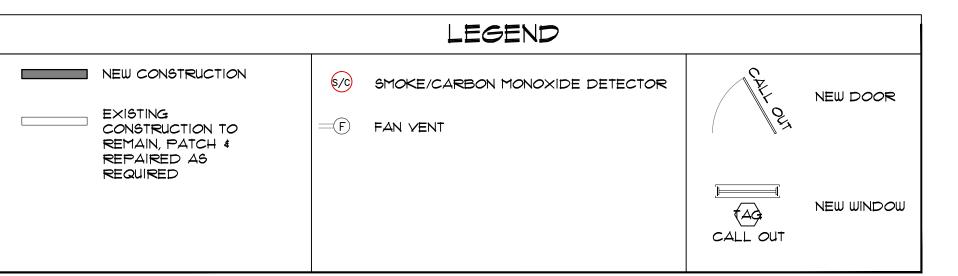
**A1** 

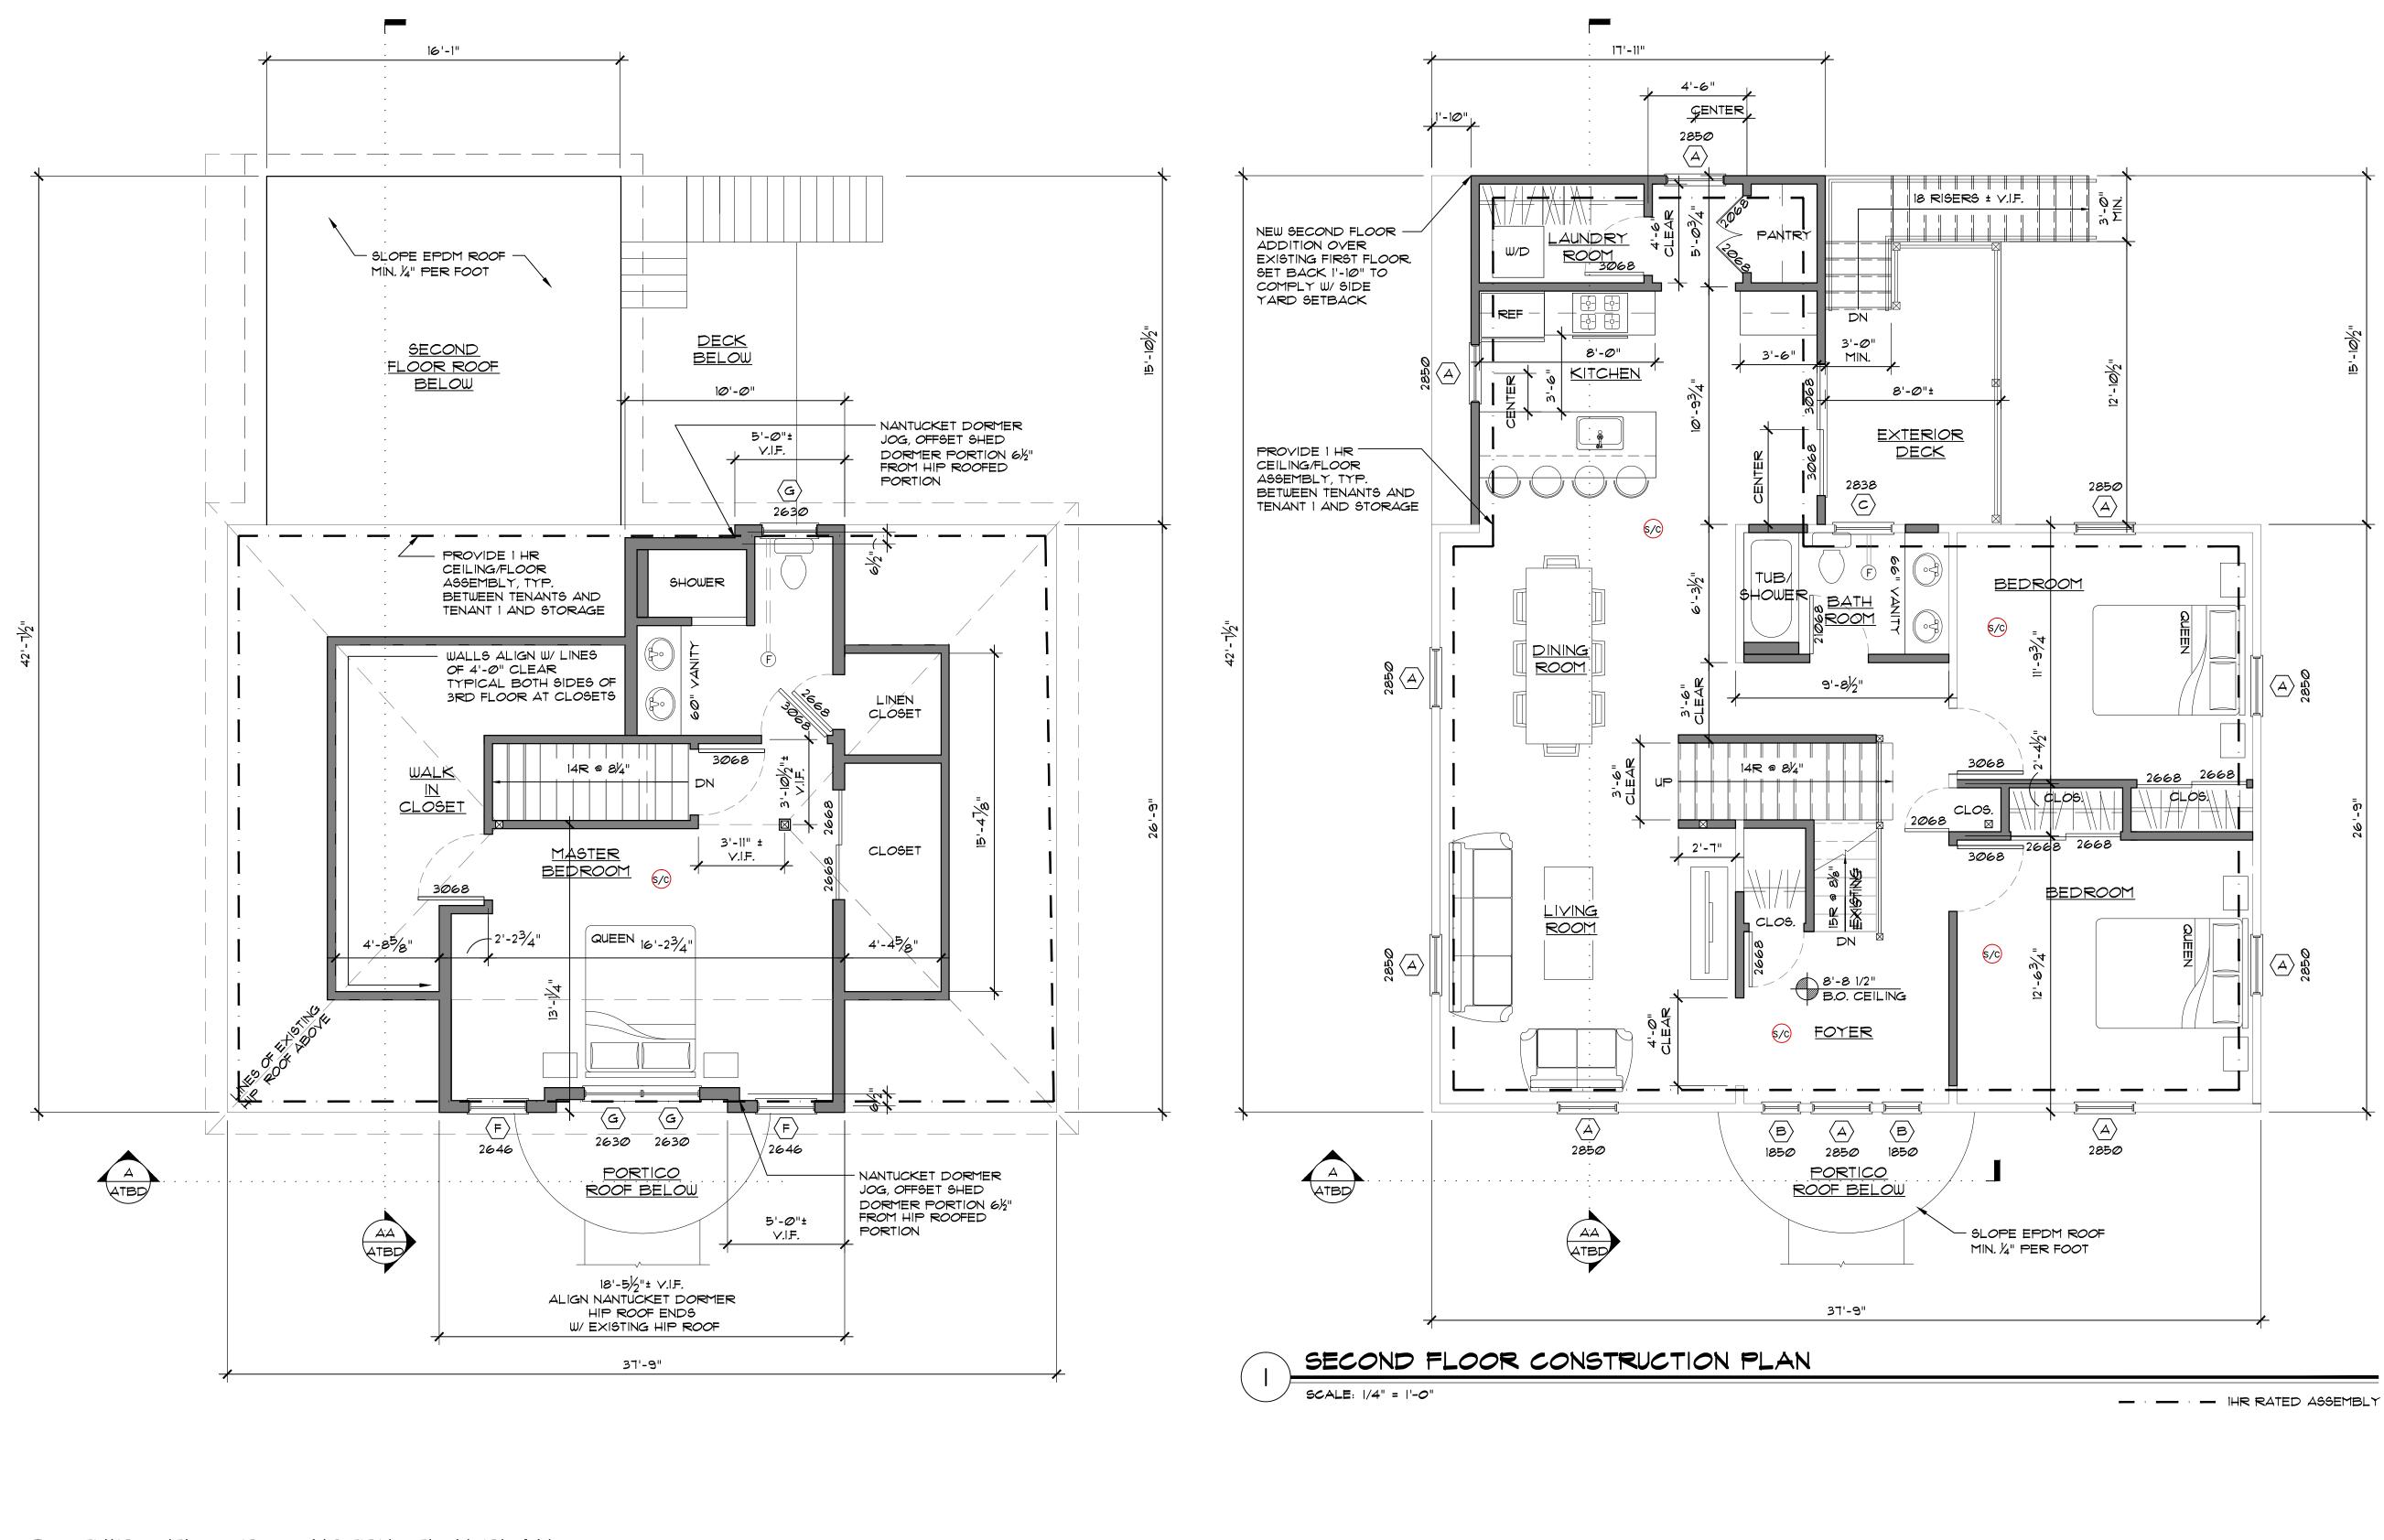

THIRD FLOOR CONSTRUCTION PLAN

SCALE: 1/4" = 1'-0"

- - - IHR RATED ASSEMBLY



NOTES:

ALL NEW WINDOWS & DOORS ARE TO MEET ENERGY STAR QUALIFICATION CRITERIA FOR RESIDENTIAL WINDOWS & DOORS (ATTACHED) AS PER THE MASSACHUSETTS STRETCH CODE (180 CMR 115.AA) & SECTION 401.5 PRESCRIPTIVE OPTION FOR ALTERATIONS, RENOVATIONS OR REPAIRS

2 FAMILY DWELLING FO NICOYA PARTNERS 139 STOUGHTON AVE

 $\bigsqcup_{\text{30 Newbury Street}} + \text{asso}_{\text{116}}$ 

DRAWING TITLE:
SECOND &

THIRD FLOOR

CONSTRUCTION PLANS


**DATE**: 05/10/16


CONSTRUCTION SET
ISSUED FOR PERMIT 05/10/16

SHEET No.

PROJECT No.

**A2** 

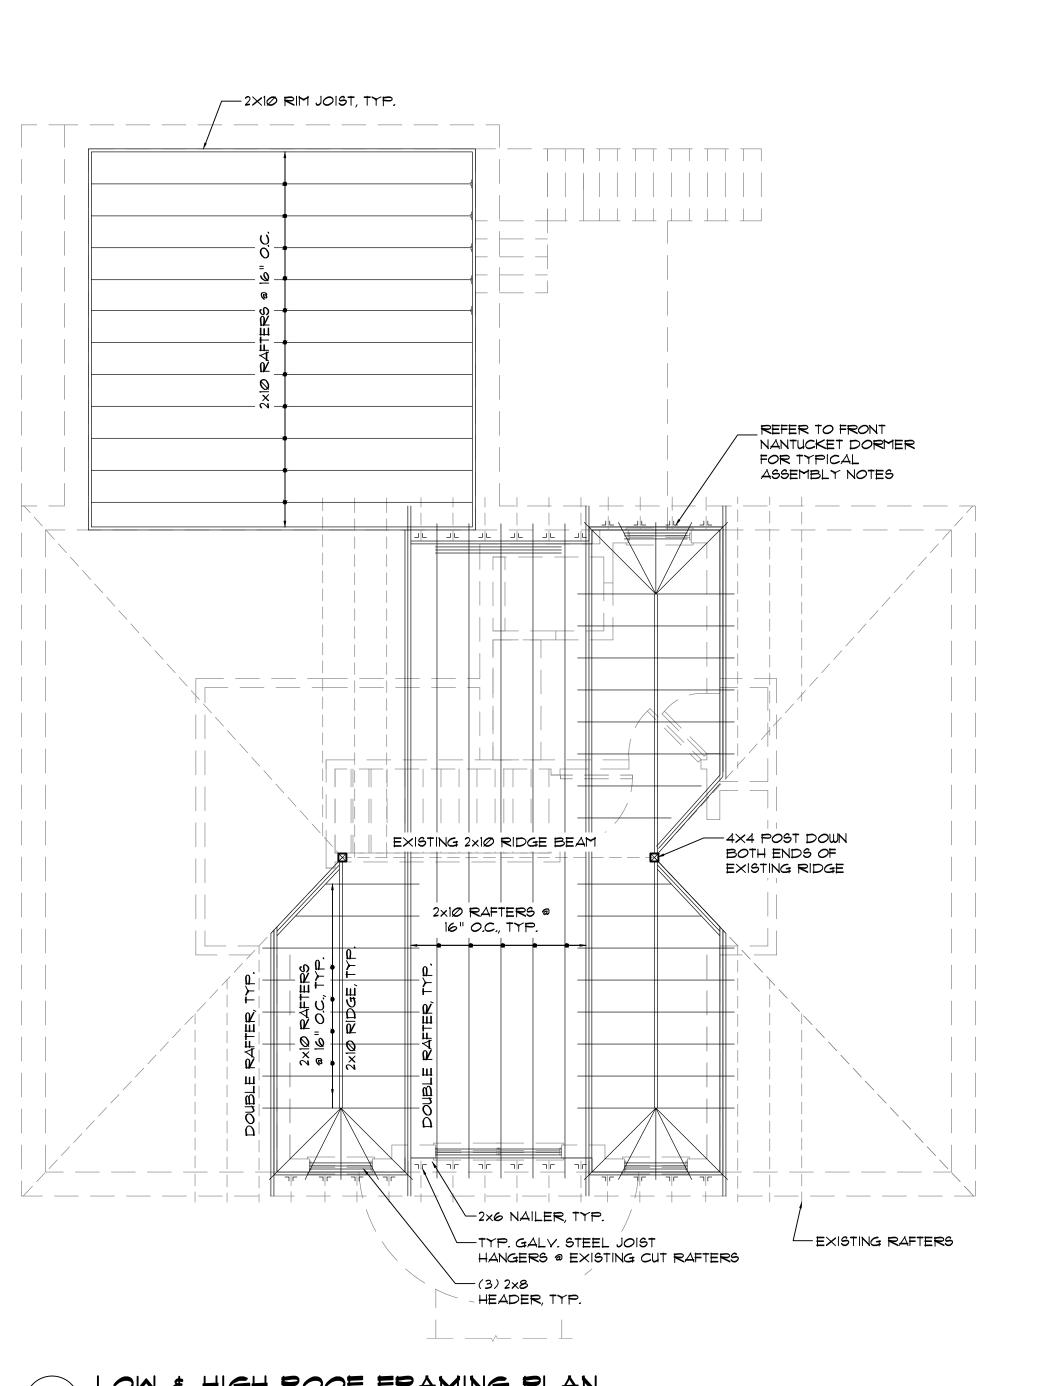

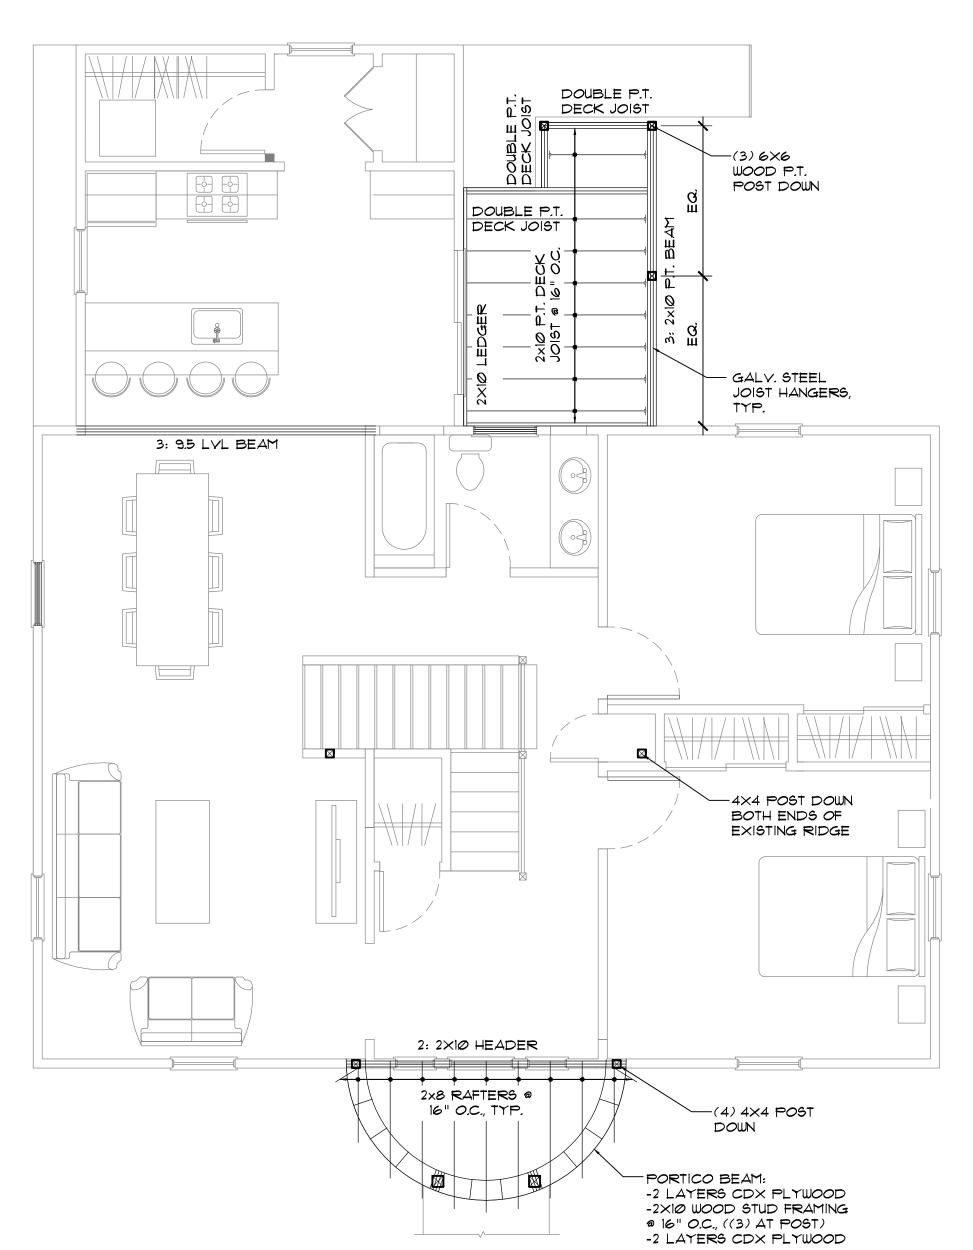

2 LOW & HIGH ROOF FRAMING PLAN

SCALE: 1/4" = 1'-0"

SECOND FLOOR FRAMING PLAN

2116

DRAWING TITLE: SECOND FLOOR + LOW & HIGH ROOF FRAMING PLANS

DATE: 05/10/16


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PROJECT No.



SECTION @ PORTICO

SCALE: 1/4" = 1'-0"

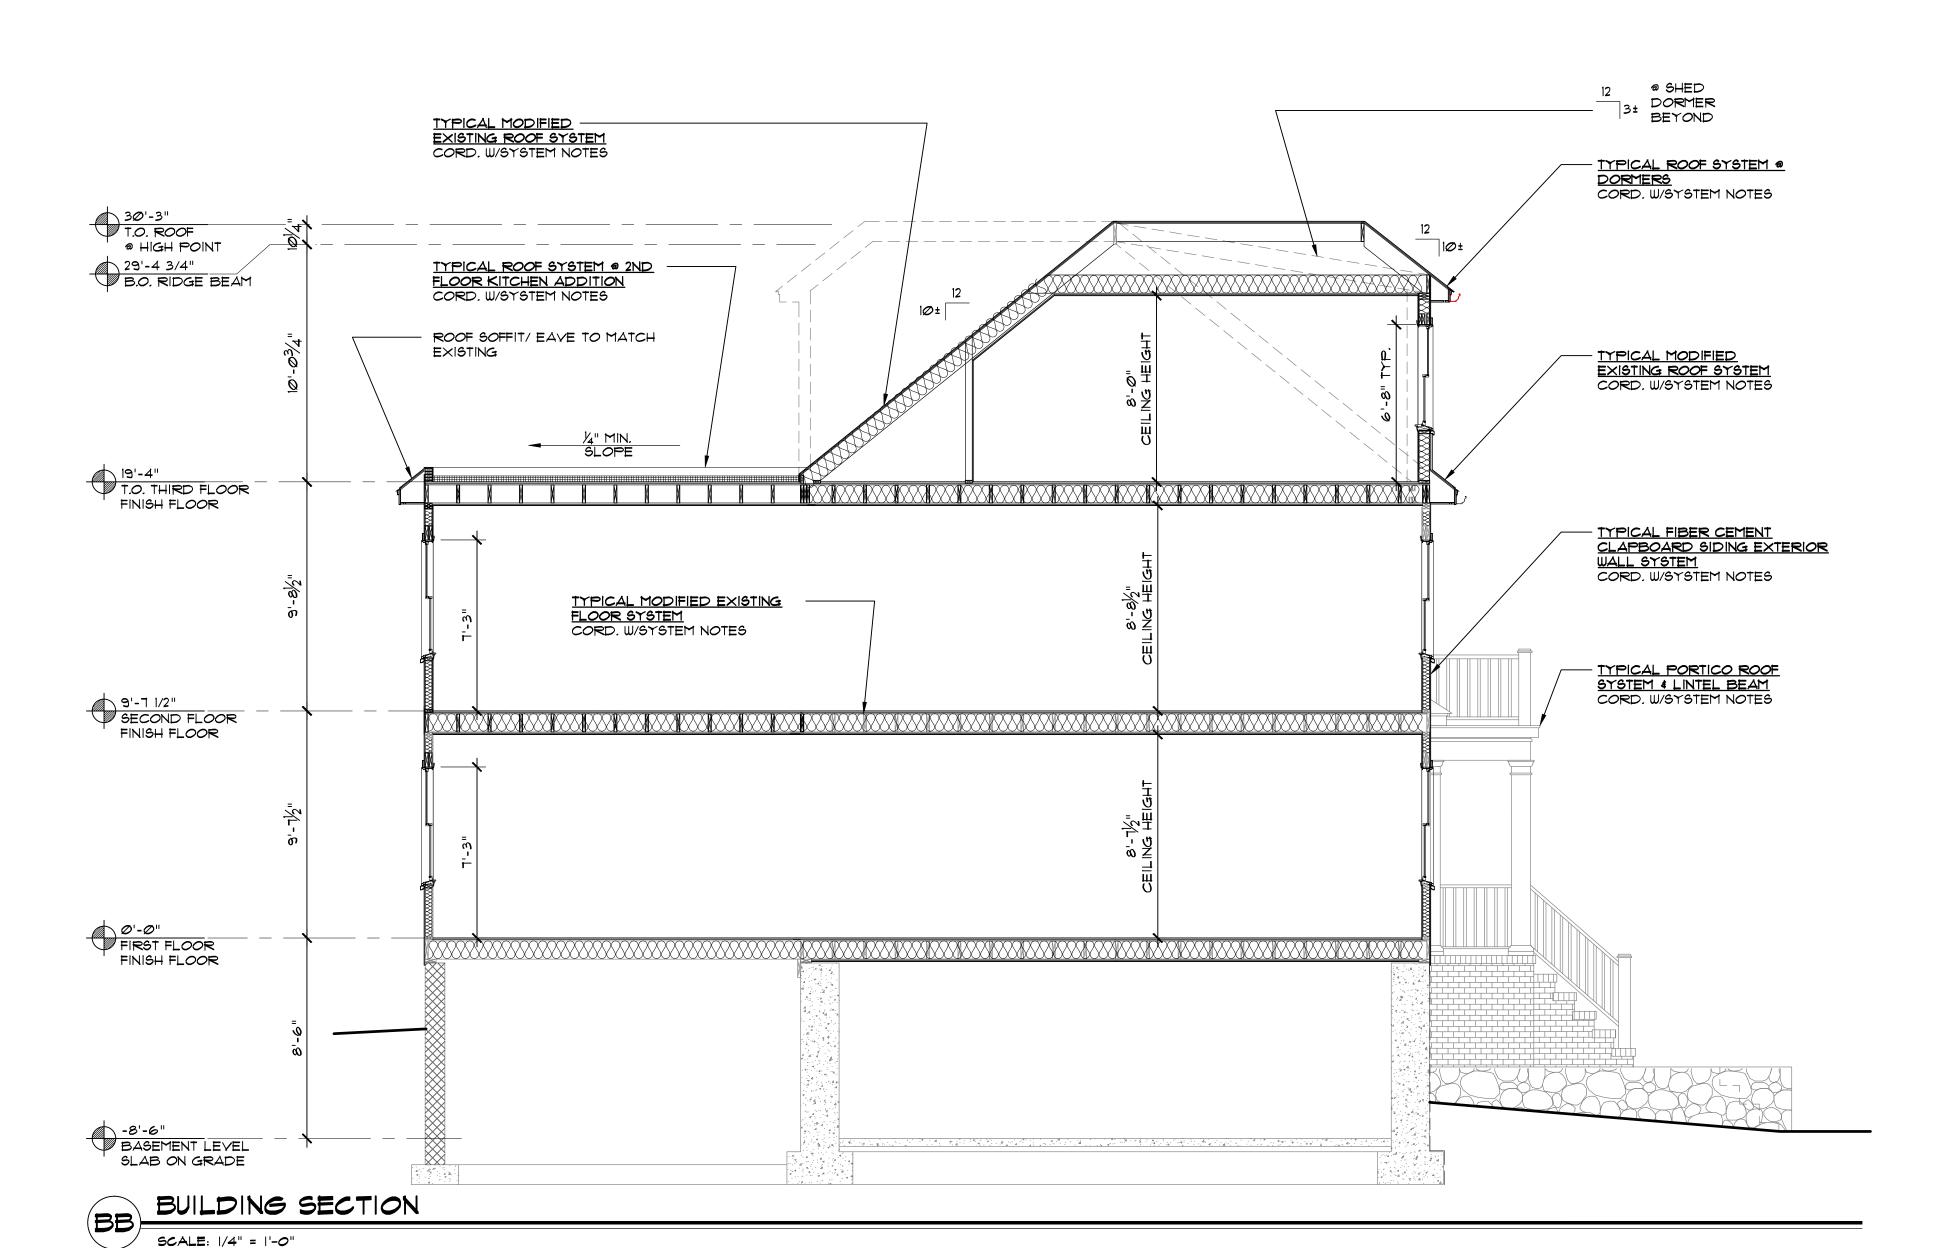

#### SYSTEM NOTES

• CONTRACTOR TO VERIFY ALL DIMENSIONS ON SITE & COORDINATE W/ DESIGNER PRIOR TO CONSTRUCTION.

• CONTRACTOR TO VERIFY ALL BEARING LINES ARE CONTINUOUS \$

PROPERLY TRANSFERRED TO FOUNDATION.

• ALL DIMENSIONAL FRAMING LUMBER USED SHALL BE SPF NO. 2

WITH MIN. E= 1.4E6 OR AS FURTHER SPECIFIED • DOUBLE ALL JOISTS UNDER PARTITIONS.

 ALL FASTENING SHALL COMPLY WITH PERMIT DRAWINGS. ANY CONNECTION NOT SPECIFICALLY DETAILED SHALL BE INSTALLED IN COMPLIANCE WITH THE REQUIREMENTS OF THE 8TH EDITION MASSACHUSETTS RESIDENTIAL BUILDING CODE, IRC 2009 WITH MASSACHUSETTS AMMENDMENTS)

TYPICAL FIBER CEMENT CLAPBOARD EXTERIOR WALL SYSTEM

- HARDIE BOARD CLAPBOARD SIDING - CLOSED CELL PVC TRIM

- TYVEK HOUSE WRAP O.A.E.

- 1/2" CDX PLYWOOD SHEATHING - @ EXISTING EXISTING 2X4 STUD FRAMING WITH 3.5 W/

FIBERGLASS BATTS INSULATION PER INCH PER STRETCH CODE - @ NEW 2X6 STUD FRAMING TO BE #2 GRADE SPRUCE PINE-FIR OR BETTER @ 16" O.C. W/R-21 FIBERGLASS BATTS INSULATION - 1/2" BLUE BOARD W/ VENEER PLASTER (SMOOTH), PAINTED TYP. (INTERIOR FINISH)

TYPICAL MODIFIED EXISTING ROOF SYSTEM

- ROOFING SYSTEM TO COMPLY W/110 MPH WIND GUST - MIN. 30 YEAR ARCHITECTURAL ROOF SHINGLES T.M.E.

- 3016 FELT PAPER

- ICE & WATER SHIELD AS RECOMMENDED BY MFGR - EXISTING PLYWOOD SHEATHING PATCH W/ NEW AS REQUIRED

- AIR CIRCULATOR FROM SOFFIT VENT TO ROOF VENT - R32 MIN. ROXUL BATTS INSULATION. AS PER STRETCH CODE

(3.5 PER INCH) - HURRICANE CLIPS AS REQUIRED

- 1X3 WOOD STRAPPING - 1/2" BLUE BOARD W/ VENEER PLASTER (SMOOTH), PAINTED

TYP. (INTERIOR FINISH)

TYPICAL ROOF SYSTEM @ DORMERS

- ROOFING SYSTEM TO COMPLY W/110 MPH WIND GUST - MIN. 30 YEAR ARCHITECTURAL ROOF SHINGLES T.M.E.

- 3016 FELT PAPER

- ICE & WATER SHIELD AS RECOMMENDED BY MFGR

- 5/8" CDX PLYWOOD ROOF SHEATHING - 2x10 ROOF RAFTERS @ 16" O.C. (U.N.O.)

- 2x10 CEILING JOIST @ 16" O.C. (U.N.O.) W/ R38 ROXUL BATTS

INSULATION. AS PER STRETCH CODE - HURRICANE CLIPS AS REQUIRED

- IX3 WOOD STRAPPING - 1/2" BLUE BOARD W/ VENEER PLASTER (SMOOTH), PAINTED TYP.

INTERIOR FINISH)

- PRE-FINISHED ALUMINUM DRIP EDGE

- GUTTERS W/ DOWNSPOUTS (NOT SHOWN), LOCATIONS AS INDICATED BY CONTRACTOR & INSTALLER.

TYPICAL ROOF SYSTEM @ 2ND FLOOR KITCHEN ADDITION ROOFING SYSTEM TO COMPLY W/110 MPH WIND GUST

- EPDM ROOF SYSTEM AS SPECIFIED BY OWNER - R21 TAPERED RIGID INSULATION SLOPPED MIN 1/2" TO DRAIN

AS PER STRETCH CODE - 5/8" CDX PLYWOOD ROOF SHEATHING

- 2×10 ROOF RAFTERS @ 16" O.C. (U.N.O.) - HURRICANE CLIPS AS REQUIRED

- 1X3 WOOD STRAPPING - 1/2" BLUE BOARD W/ YENEER PLASTER (SMOOTH), PAINTED TYP.

(INTERIOR FINISH)

- PRE-FINISHED ALUMINUM DRIP EDGE - GUTTERS W/ DOWNSPOUTS (NOT SHOWN), LOCATIONS AS INDICATED

#### TYPICAL PORTICO ROOF SYSTEM & LINTEL BEAM

- ROOFING SYSTEM TO COMPLY W/110 MPH WIND GUST - EPDM ROOF SYSTEM AS SPECIFIED BY OWNER

- 5/8" CDX PLYWOOD ROOF SHEATHING

- 2x8 ROOF RAFTERS @ 16" O.C. (U.N.O.) SLOPED A MIN 1/4" PER FOOT - HURRICANE CLIPS AS REQUIRED

PRE-FINISHED ALUMINUM DRIP EDGE - GUTTERS W/ DOWNSPOUTS (NOT SHOWN), LOCATIONS AS INDICATED

BY CONTRACTOR & INSTALLER. - PORTICO BEAM

-2 LAYERS CDX PLYWOOD

BY CONTRACTOR & INSTALLER.

-2×10 WOOD STUD FRAMING @ 16" O.C., ((3) AT POST) -2 LAYERS CDX PLYWOOD

#### TYPICAL MODIFIED EXISTING FLOOR SYSTEM - FINISH FLOOR AS SPECIFIED BY OWNER

- <u>V.I.F. EXTENT OF REQUIRED NEW SUBFLOOR</u> T&G ADVANTECH

"VIP+" SUB-FLOOR, GLUED & NAILED - MODIFIED EXISTING 2XIØ FLOOR FRAMING AS REQUIRED BY NEW

- IX3 WOOD STRAPPING - TYPE X FIRE CORE G.W.B. CEILING SHEATHING

- FORMALDEHYDE FREE FIBERGLASS BATT INSULATION AT ALL WOOD FLOORS 3.5R PER INCH AS PER STRETCH CODE

\*\*\* PROVIDE REQUIRED LAYERS & THICKNESS OF FLOOR COMPONENTS AS REQUIRED BY I HR UL ASSEMBLY CHOSEN, CORD. W/ ARCHITECT FOR APPROVAL\*\*\*

#### TYPICAL INTERIOR WALL SYSTEM

- 2×4 SILL W/ (2) 2×4 TOP PLATE \$ 2×4 WALL STUDS @ 16" O.C

- REFER TO CONSTRUCTION PLAN NOTES FOR ADDITIONAL REQUIREMENTS

- FORMALDEHYDE FREE FIBERGLASS SOUND BATT INSULATION AT ALL INTERIOR BATHROOM & INTERIOR BEDROOM WALLS - 1/2" BLUE BOARD W/ VENEER PLASTER (SMOOTH), PAINTED TYP.

- PROVIDE %" TYPE X FIRE CORE G.W.B. SHEATHING AT ALL 1 HR WALL ASSEMBLIES, INSTALL AS PER UL ASSEMBLY REQUIREMENTS

DRAWING TITLE:

SYSTEM NOTES & BUILDING SECTIONS

DATE: 05/10/16

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