# NEW TWO FAMILY DWELLING

# at 14 OAK STREET CHARLESTOWN, MA.

### **GENERAL NOTES**

#### i. General requirements

1. All work shall conform to the IBC 2009, IRC 2009, Massachusetts amendments to IBC /IRC,

the City of Boston bylaws and all applicable OSHA standards. 2. Utilities may be in the vicinity of the excavations. prior to excavating the excavation contractor shall comply with the local "dig-safe" requirements and obtain all existing utility information from the owner.

- 3. The Contractor shall verify all dimensions and conditions at the site and report any discrepancy to the Architect before ordering material and proceeding with the work.
- 4. The Contractor shall provide temporary bracing and shoring to support existing surrounding structures and against wind forces and all construction loads throughout the work.
- 5. The contractor shall coordinate all work with the drawings of other disciplines for the location and dimensions of all related items.
- 6. The contractor shall coordinate all framing dimensions with the approved drawings of all purchased window and door dimensions.

#### **HVAC** general notes

- 1. Install sheet metal ductwork and equipment for new hvac system and new bathroom exhaust fans as required by the Massachusetts Mechanical Code. Plumbing General notes:
- 1. Install all plumbing and equipment to meet the requirements of the Mass. State Plumbing code. 2. Install all new fixtures complete with all req required copper water supply lines & pvc waste & vents. connect to existing or new waste & vent stacks.
- **Electrical Notes:**
- 1. Install all new fixtures and devices to meet the requirements of the Mass Electrical Code.
- 2. The Electrical Subcontractor shall provide and submit drawings to Boston Inspectional Services as required for approval.
- All drawings by all Subcontractors shall be submitted to the Contractor & Architect for coordination with the work of other trades.
- All Subcontractors to submit stamped drawings as req'd by Authority having jurisdiction.

SITE LAYOUT / LANDSCAPING PLAN

|  | CARPARK FOR LOT B.  O BOLLARD,  LINE OF EXISTING HOUSE TO BE REM.                 | #16       |   |
|--|---|-----------|---|
|  | #16 E O BOLLARD  O BOLLARD  O BOLLARD  O BOLLARD  O BOLLARD  O BOLLARD  O BOLLARD | BOLLARD O | EXISTING CURB CUT TO REMAIN  CAK STREET |
| PING SCHEDULE:  G DOGWOOD W/ WULCH BED AN CHERRY M SILLA D STONE VERS EEDED GLASS NE STEPS / LANDING D STONE | TRASH / RECYCLE 12  | #14       |   |

#### **CHARLESTOWN 3F-2000 ZONE**

|                            | REQ'D/ MIN.<br>ALLOWED | EXISTING | PROPOSED                                | PROPOSED       |
|----------------------------|------------------------|----------|---|----------------|
| LOT SIZE 'A' - 2 dwellings | 2,000 S.F.             | N/A      | 2436 sf                                 |                |
| F.A.R. 2.0, LOT 'A'        | MAX (4872 SF)          | N/A      | 3660 SF                                 |                |
| LOT 'A' WIDTH & FRONTAGE   | 20'                    | N/A      | 34.01' (front), 27'-8" (rear)           |                |
| HEIGHT OF BUILDINGS        | 35'                    | N/A      | 34'                                     |                |
| USABLE OPEN SPACE, 'A'     | 818 SF                 | N/A      | 634 SF(ground) +530(decks) = 1164 total | See notes 1 &2 |
| FRONT YARDS SETBACKS       | STREET AVG.            | 0'-0"    | 0'-0"                                   |                |
| SIDE YARDS SETBACKS        | 2'-6"                  | N/A      | 3'-0" (except at party walls)           |                |
| REAR YARDS SETBACKS        | 20'                    | N/A      | 20'                                     |                |
| PARKING SPACES             | 2                      | N/A      | 2 for this lot = 4 TOTAL                |                |

- 1. USABLE OPEN SPACE REQUIREMENT IS CALCULATED AS 350SF/ DWELLING UNIT + 25% OF LOT AREA IN EXCESS OF REQUIRED LOT SIZE. 75% OF THIS AREA IS REQUIRED TO BE IN THE YARDS.
- 2. ON BOTH LOT 'A' & LOT 'B', MORE THAN 75% OF THE REQUIRED USABLE OPEN SPACE IN THE YARDS IS OPEN TO THE SKY, AND MORE THAN 75% OF THE TOTAL REQUIRED **USABLE OPEN SPACE IS OPEN TO THE SKY,**

THE EXISTING LOT AT 16 OAK STREET, CHARLESTOWN WILL BE SUB-DIVIDED INTO TWO LOTS.

## **BUILDING TYPE**

**VB - UNPROTECTED COMBUSTIBLE USE GROUP- R-3** 

NOTE: THE BUILDING IS PROVIDED THROUGHOUT WITH A FULLY **AUTOMATIC FIRE PROTECTED** 

#### **DRAWING LIST**

**CS COVER SHEET** 

### **CERTIFIED PLOT PLAN**

- **A1.1 FLOOR PLANS A2.1 FLOOR PLANS**
- A3.1 FLOOR PLANS A4.1 ELEVATIONS
- **A5.1 ELEVATIONS**
- **A6.1 ENLARGED ELEVATIONS**
- A7.1 SECTIONS
- A8.1 SECTIONS
- STRUCTURAL NOTES
- FOUNDATION PLAN **GARDEN LEVEL FRAMING**
- SECOND FLOOR FRAMING
- THIRD FLOOR FRAMING
- **ROOF FRAMING**
- **SCHEDULES & DETAILS**



**OAK STREET ELEVATION** 

**CS.1** 

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FAMILY RESIDENC K STREET ESTOWN, MA.


NEW 2 | 14 OAK CHARLE

PROJECT NO.: SCALE: AS NOTED

**PERMIT SET 7-31-15 REV'D 9-9-15 REV'D 9-25-15** 

DATE:6-16-15 **DRAWN BY: REVISIONS:** 

**A-4.1** 

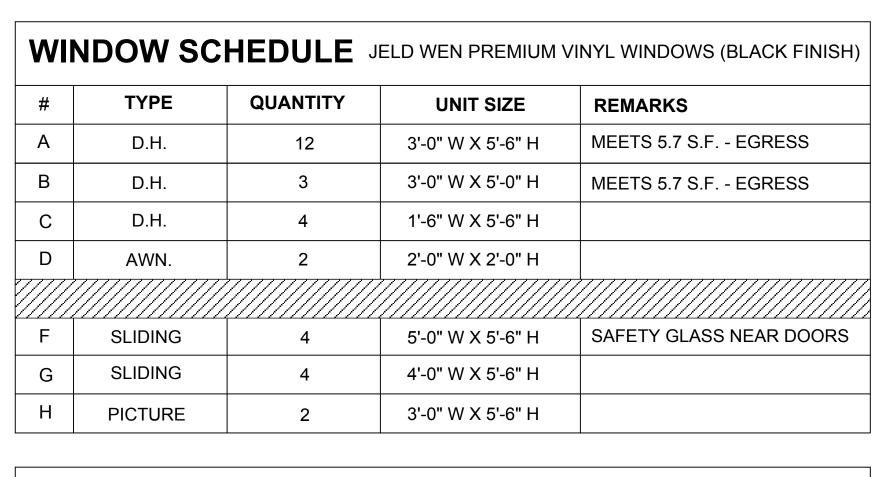

| EXT. DOOR SCHEDULE FIBERGLASS / INSULATED DOORS (BLACK FINISH) |            |   |                   |                                   |  |  |
|--|------------|---|-------------------|-----------------------------------|--|--|
| I  | ENTRY DOOR | 1 | 3'-0" W X 7'-0" H | F.G. W/ (2) 1'-0" W X 7-0" H S.L. |  |  |
| ٦  | REAR DOOR  | 1 | 2'-8" W X 6'-8" H | F.G.                              |  |  |
| K  | STORAGE    | 3 | 2'-8" W X 6'-8" H | INSULATED METAL                   |  |  |
| L  | DECK DOOR  | 2 | 2'-8" W X 6'-8" H | SAFETY GLASS                      |  |  |

\* DOUBLE STUD POCKET AT DOUBLE WINDOWS \* LOW E4 SMART SUN GLASS (DUAL-PANE, TINTED LOW-E, ARGON BLEND GLASS, MIN U.30)

### **EXTERIOR MATERIALS / NOTES:**

- SYNTHETIC TRIM (AZEK OR SIMILAR)
- PREMIUM CLAD WOOD WINDOW
- CEMENTITIOUS CLAPBOARD SIDING (5" EXP) COLOR T.B.D.
- MTL. DRIP EDGE
- AZEK DRIP CAP W/ FLASHING
- 6) CAST IRON GUARD (42") / (BLACK FINISH)
- 30 YEAR BONDED EPDM ROOF
- (8) PARGED CONCRETE FOUNDATION WALL
- 9) FULLY SHIELDED EXTERIOR LIGHT FIXTURE
- (10) CEMENTITIOUS PANEL
- SYNTHETIC TREADS / RISERS
- 12) F.G. DOOR STYLE T.B.D. / SYNTHETIC TRIM / PANEL
- 12" x 12" F.G. COLUMN
- ALUMINUM (WHITE) DOWNSPOUT & GUTTERS
- GRANITE STEP
- WROUGHT IRON GATE
- ) WHITE FIBERGLASS / AZEK LATTICE
- 18) WOOD DECK WITH SYNTHETIC RAIL SYSTEM
- 9 STEEL STAIR
- 20 PARGED & PAINTED CMU

\* BOTH RESIDENCES WILL BE EQUIPPED WITH A FULLY AUTOMATIC NH13D SPRINKLER SYSTEM (SEE FIRE PROTECTION DRAWINGS)

DTE:

Table 705.8+ note d allows 25% unprotected openings in a sprinklered building, Type R-3, with minimum 3' fire separation distance wall area this side facade = 860 sf unprotected wall area openings allowed= 860 sf x.25 = 215 sf

unprotected windows open area = 52 sf (6%) unprotected garage open area = 104 sf= (12%) total unprotected open area = 156 sf= 18%

LEFT SIDE CARPORT ELEVATION

2'-6"

OAK STREET ELEVATION

34'-0" TO TOP -----OF ROOF BEAM

34'-0" TO TOP -OF ROOF BEAM


LANDING

SEE SECTIONS

20

15

**A-5.**1

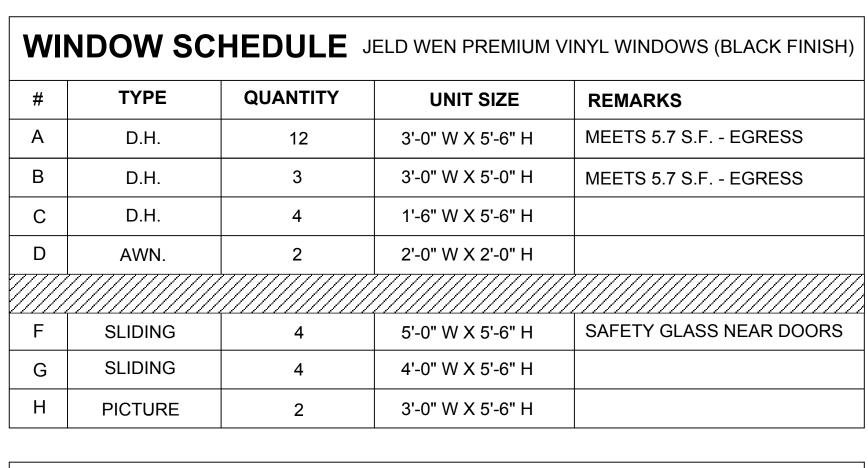


| EXT. DOOR SCHEDULE FIBERGLASS / INSULATED DOORS (BLACK FINISH) |            |   |                   |                                   |  |  |
|--|------------|---|-------------------|-----------------------------------|--|--|
| 1  | ENTRY DOOR | 1 | 3'-0" W X 7'-0" H | F.G. W/ (2) 1'-0" W X 7-0" H S.L. |  |  |
| J  | REAR DOOR  | 1 | 2'-8" W X 6'-8" H | F.G.                              |  |  |
| K  | STORAGE    | 3 | 2'-8" W X 6'-8" H | INSULATED METAL                   |  |  |
| L  | DECK DOOR  | 2 | 2'-8" W X 6'-8" H | SAFETY GLASS                      |  |  |


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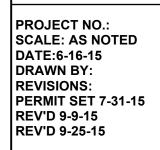
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|---------------|---|
| )             | PREMIUM CLAD WOOD WINDOW                            |
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| )             | MTL. DRIP EDGE                                      |
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| ?             | 30 YEAR BONDED EPDM ROOF                            |
|               | PARGED CONCRETE FOUNDATION WALL                     |
| )             | FULLY SHIELDED EXTERIOR LIGHT FIXTURE               |
| )             | CEMENTITIOUS PANEL                                  |
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| 3             | 12" x 12" F.G. COLUMN                               |
| j)            | ALUMINUM (WHITE) DOWNSPOUT & GUTTERS                |
|               | GRANITE STEP  |
| 6             | WROUGHT IRON GATE                                   |
|               | WHITE FIBERGLASS / AZEK LATTICE                     |
| 3             | WOOD DECK WITH SYNTHETIC RAIL SYSTEM                |
|               | STEEL STAIR   |
| )             | PARGED & PAINTED CMU                                |

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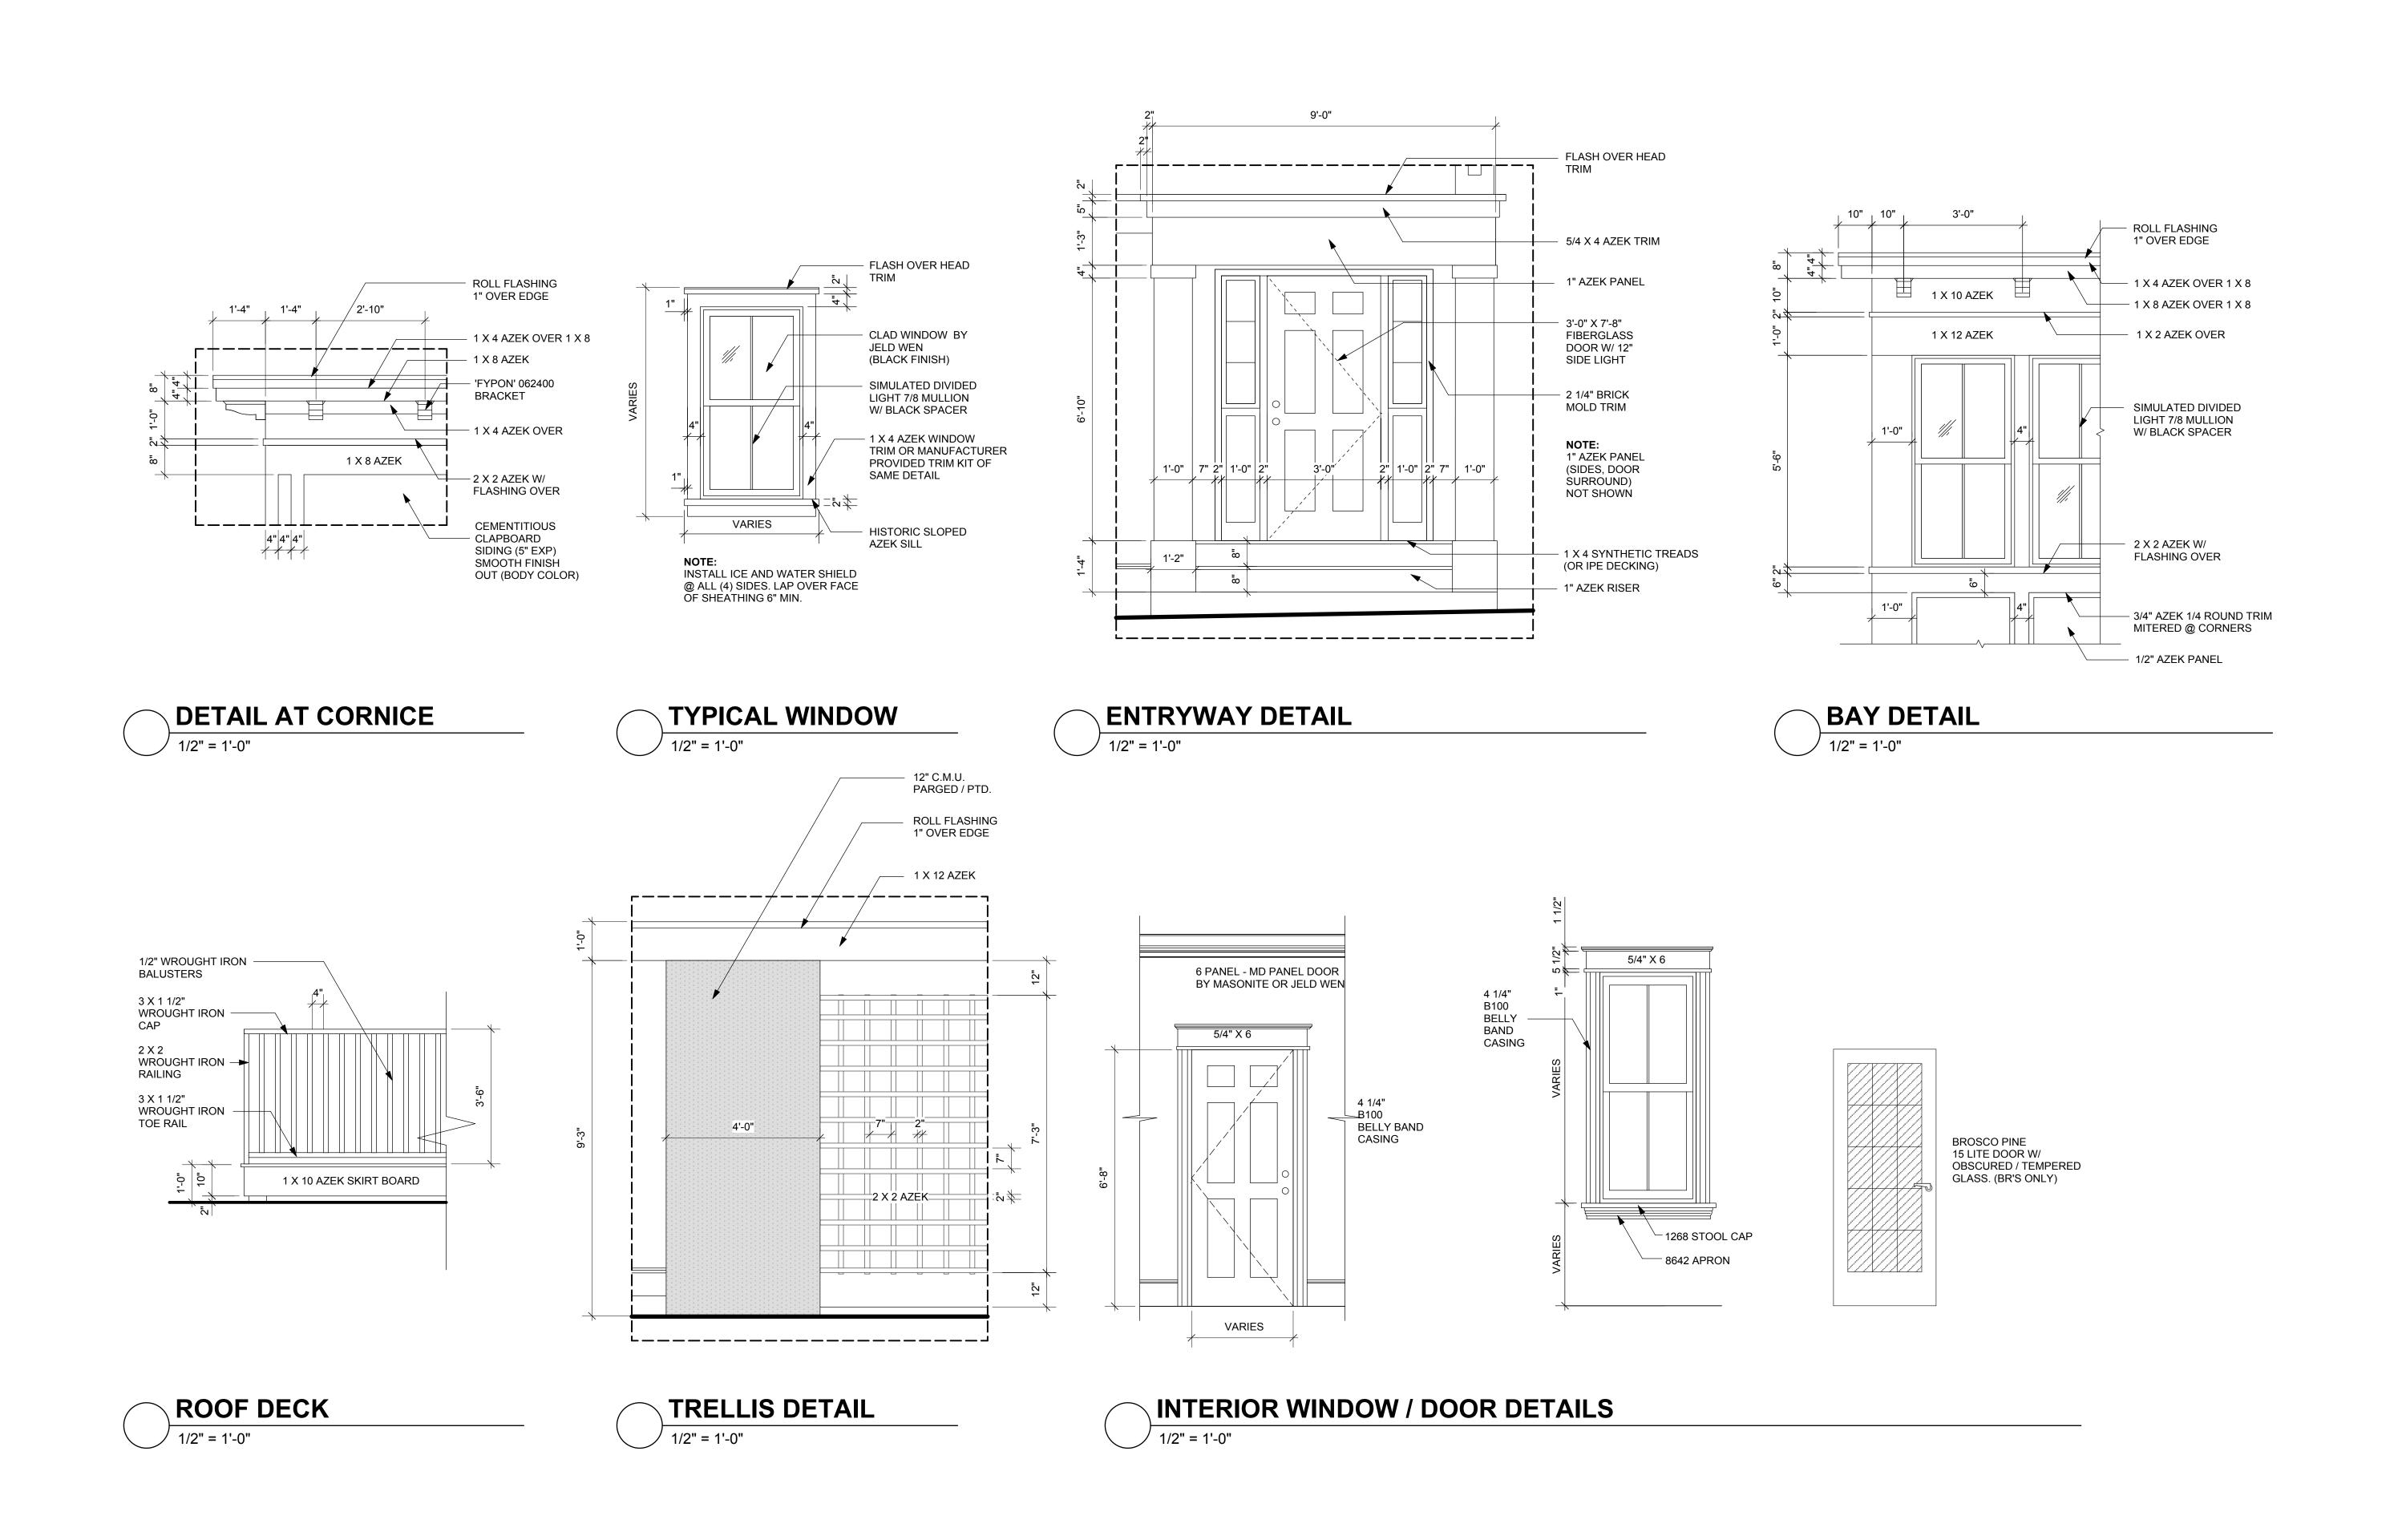
NOTE:
Table 705.8+ note d allows 25% unprotected openings in a sprinklered building, Type R-3, with minimum 3' fire separation distance wall area this side facade = 1842 sf unprotected wall area openings allowed= 1842 sf x.25 = 460.5 sf unprotected windows open area = 131.4 sf (7.13%) unprotected garage open area = 181 sf= (9.82%) total unprotected open area = 312.4 sf= 17%





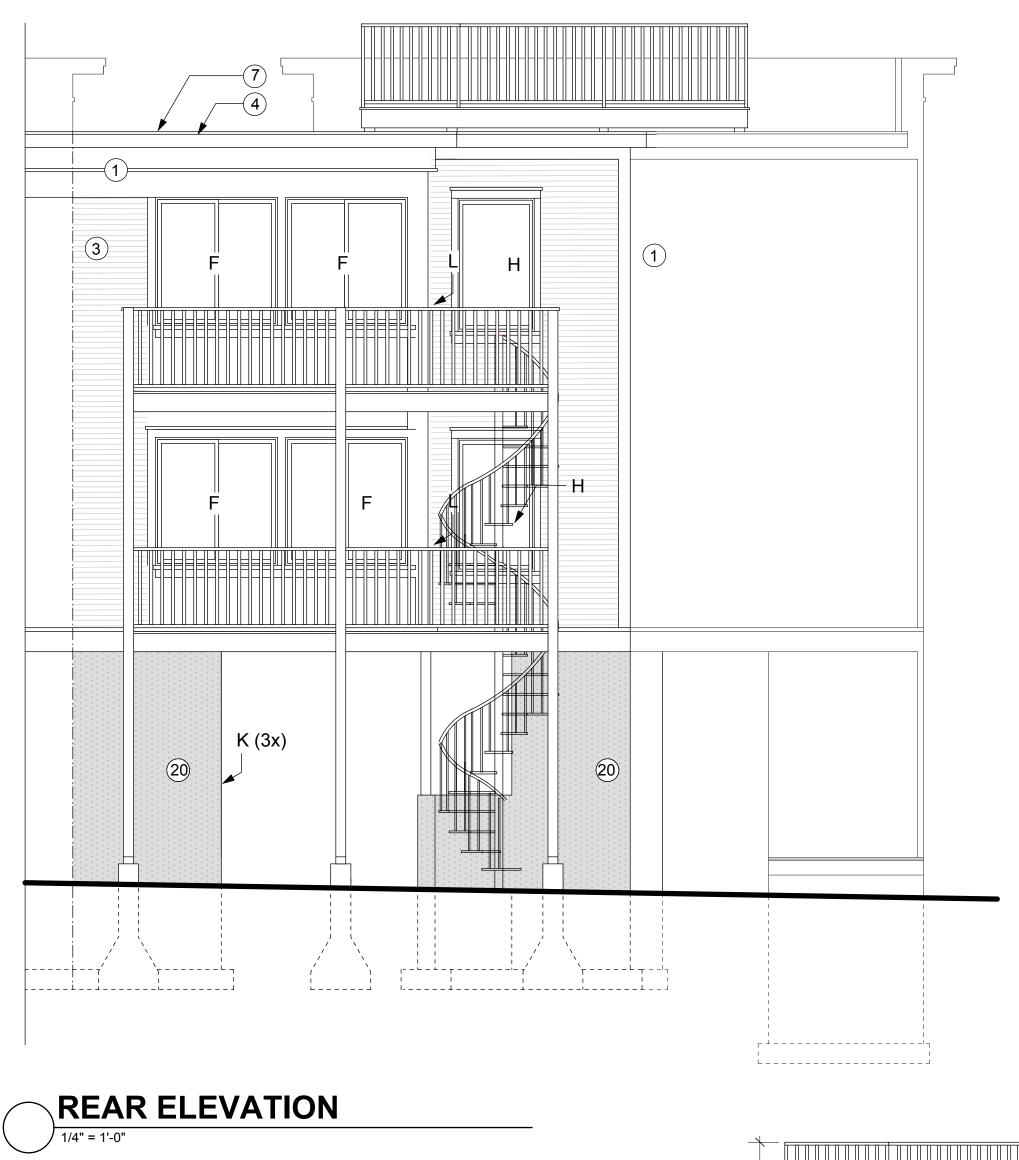

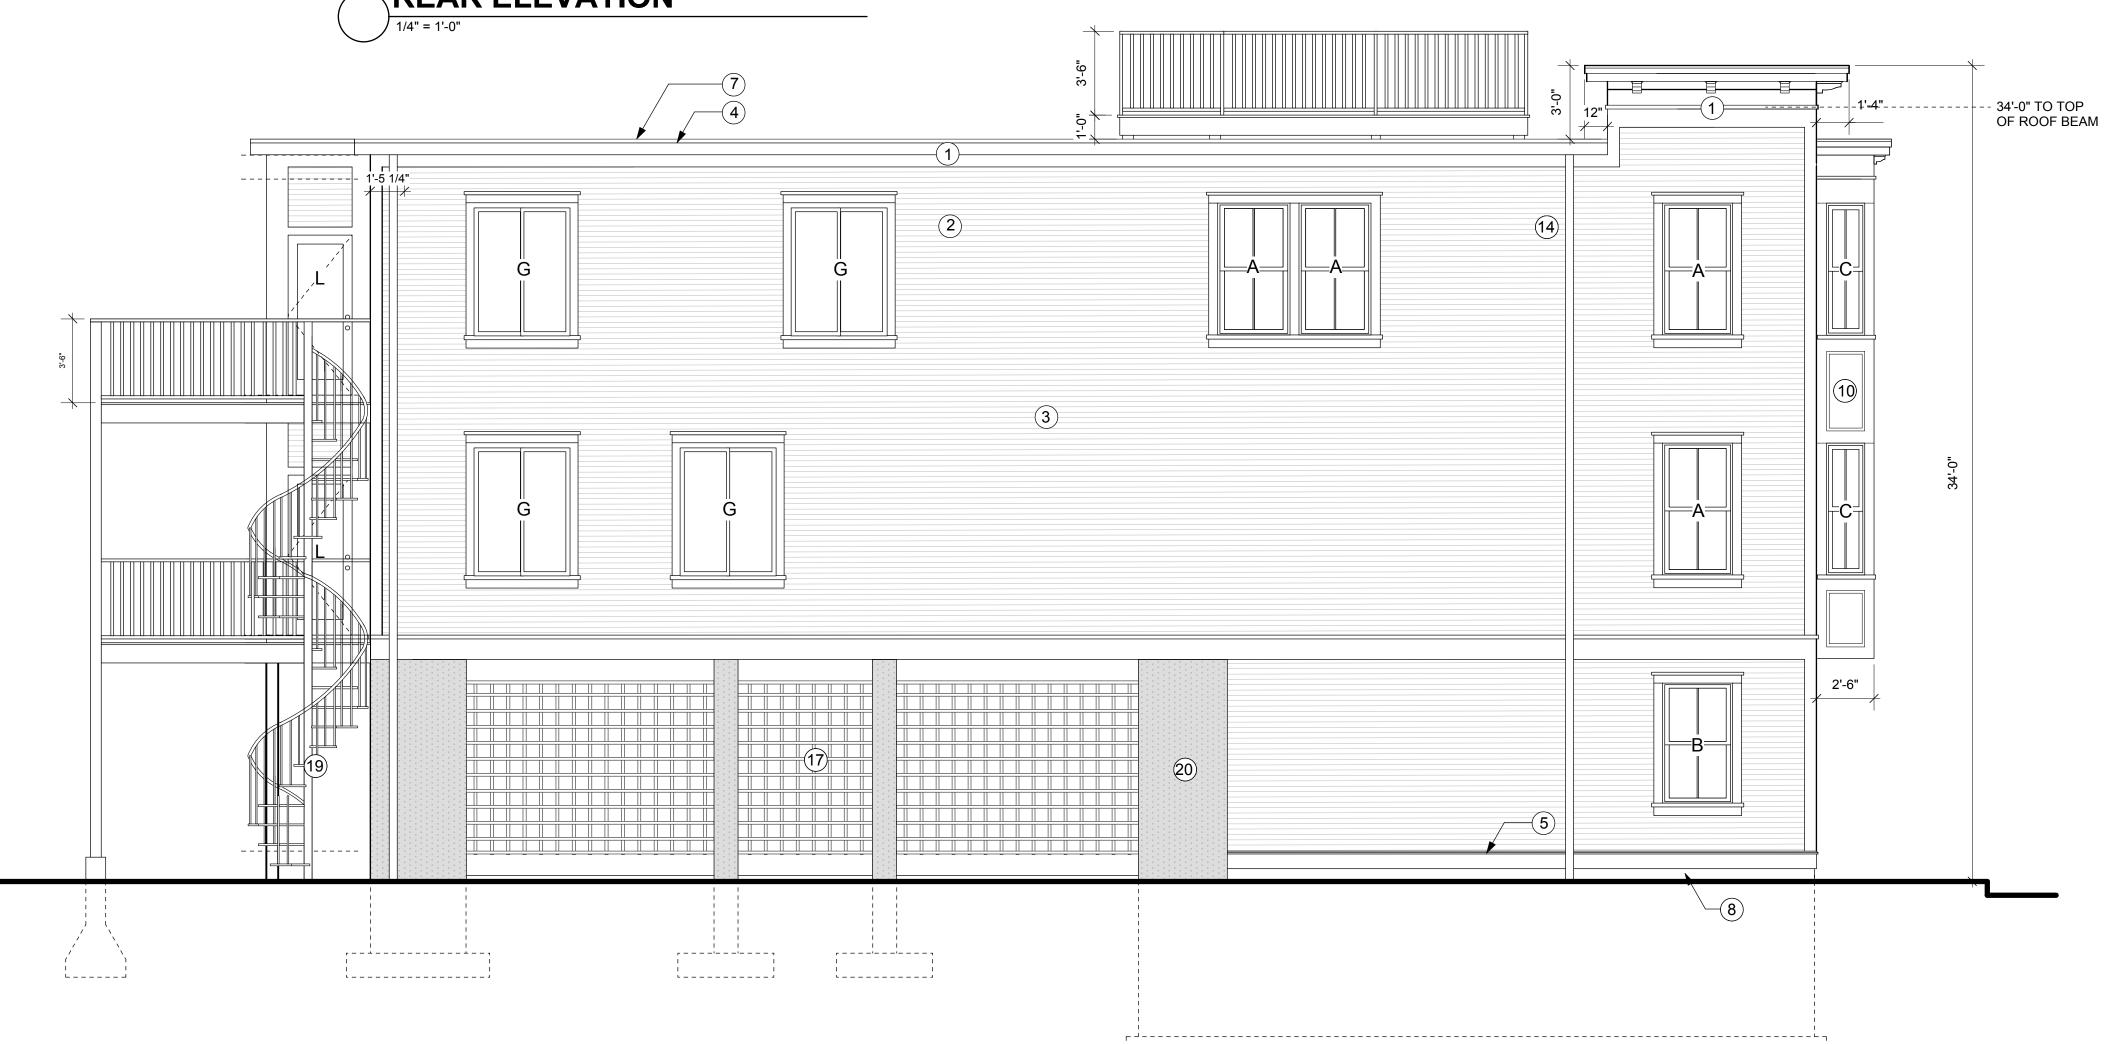



# NEW TWO FAMILY DWELLING

# at 16 OAK STREET CHARLESTOWN, MA.

### **GENERAL NOTES**

#### i. General requirements

- 1. All work shall conform to the IBC 2009, IRC 2009, Massachusetts amendments to IBC /IRC,
- the City of Boston bylaws and all applicable OSHA standards. 2. Utilities may be in the vicinity of the excavations.
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# #16 #14 1) RED TWIG DOGWOOD W/ 5'-0" DIA. MULCH BED 2) CORNELIAN CHERRY 4) FOTHERGILLA 5) CRUSHED STONE 7) HYDRO SEEDED GLASS 8) FLAGSTONE STEPS / LANDIN 9) CRUSHED STONE 11) VINCA 12) JUNIPER

#### **CHARLESTOWN 3F-2000 ZONE**

|                            | REQ'D/ MIN.<br>ALLOWED | EXISTING | PROPOSED                                | PROPOSED       |
|----------------------------|------------------------|----------|---|----------------|
| LOT SIZE 'B' - 2 dwellings | 2,000 S.F.             | N/A      | 2623 sf                                 |                |
| F.A.R. 2.0, LOT 'B'        | MAX (5236 SF)          | N/A      | 3660 SF                                 |                |
| LOT 'B' WIDTH & FRONTAGE   | 20'                    | N/A      | 31'-6" (front), 27'-8" (rear)           |                |
| HEIGHT OF BUILDINGS        | 35'                    | N/A      | 33'                                     |                |
| USABLE OPEN SPACE, 'B'     | 856 SF                 | N/A      | 816 SF(ground) +610(decks) = 1426 total | See notes 1 &2 |
| FRONT YARDS SETBACKS       | STREET AVG.            | 0'-0"    | 0'-0"                                   |                |
| SIDE YARDS SETBACKS        | 2'-6"                  | N/A      | 3'-0" (except at party walls)           |                |
| REAR YARDS SETBACKS        | 20'                    | N/A      | 20'                                     |                |
| PARKING SPACES             | 2                      | N/A      | 2 per lot = 4 TOTAL                     |                |

- 1. USABLE OPEN SPACE REQUIREMENT IS CALCULATED AS 350SF/ DWELLING UNIT + 25% OF LOT AREA IN EXCESS OF REQUIRED LOT SIZE. 75% OF THIS AREA IS REQUIRED TO BE IN THE YARDS.
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#### **BUILDING TYPE**

**VB - UNPROTECTED COMBUSTIBLE USE GROUP R-3** 

#### NOTE:

THE BUILDING IS PROVIDED THROUGHOUT WITH A FULLY **AUTOMATIC FIRE PROTECTED** 

#### **DRAWING LIST**

**CS COVER SHEET** 

#### **CERTIFIED PLOT PLAN**

- A1.1 FLOOR PLANS **A2.1 FLOOR PLANS**
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- **S2 GARDEN LEVEL FRAMING**
- S3 SECOND FLOOR FRAMING **S4 THIRD FLOOR FRAMING**
- **S5 ROOF FRAMING**
- **S6 SCHEDULES & DETAILS**



SITE LAYOUT / LANDSCAPING PLAN

**OAK STREET ELEVATION** 

**PROJECT NO.:** 

DATE:6-16-15

**REV'D 9-25-15** 

DRAWN BY: **REVISIONS:** 


SCALE: AS NOTED

**PERMIT SET 7-31-15 REV'D 9-9-15** 

C

FAMILY RESIDENC STREET
-ESTOWN, MA.

A-4.1

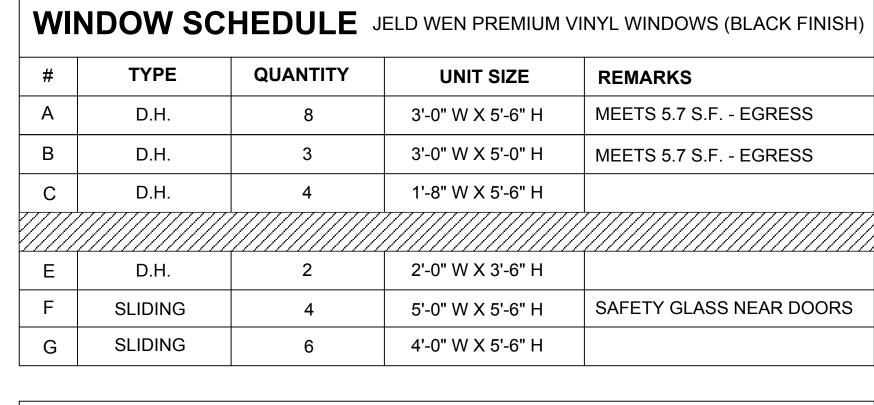

| EX | LATED DOORS (BLACK FINISH) |   |                   |                                   |
|----|----------------------------|---|-------------------|-----------------------------------|
| ı  | ENTRY DOOR                 | 1 | 3'-0" W X 7'-0" H | F.G. W/ (2) 1'-0" W X 7-0" H S.L. |
| J  | REAR DOOR                  | 1 | 2'-8" W X 6'-8" H | F.G.                              |
| K  | STORAGE                    | 3 | 2'-8" W X 6'-8" H | INSULATED METAL                   |
| L  | DECK DOOR                  | 2 | 2'-8" W X 6'-8" H | SAFETY GLASS                      |

\* DOUBLE STUD POCKET AT DOUBLE WINDOWS \* LOW E4 SMART SUN GLASS (DUAL-PANE, TINTED LOW-E, ARGON BLEND GLASS, MIN U.30)


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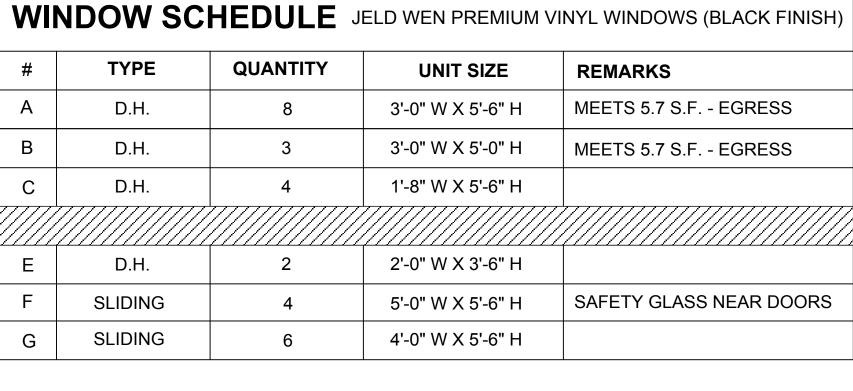
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PROJECT NO.: SCALE: AS NOTED DATE:6-16-15 DRAWN BY: REVISIONS: PERMIT SET 7-31-15 REV'D 9-9-15 REV'D 9-25-15

A-5.1



#### **EXT. DOOR SCHEDULE** FIBERGLASS / INSULATED DOORS (BLACK FINISH) **ENTRY DOOR** F.G. W/ (2) 1'-0" W X 7-0" H S.L. 3'-0" W X 7'-0" H REAR DOOR 2'-8" W X 6'-8" H STORAGE 2'-8" W X 6'-8" H **INSULATED METAL** SAFETY GLASS DECK DOOR 2'-8" W X 6'-8" H

\* DOUBLE STUD POCKET AT DOUBLE WINDOWS \* LOW E4 SMART SUN GLASS (DUAL-PANE, TINTED LOW-E, ARGON BLEND GLASS, MIN U.30)
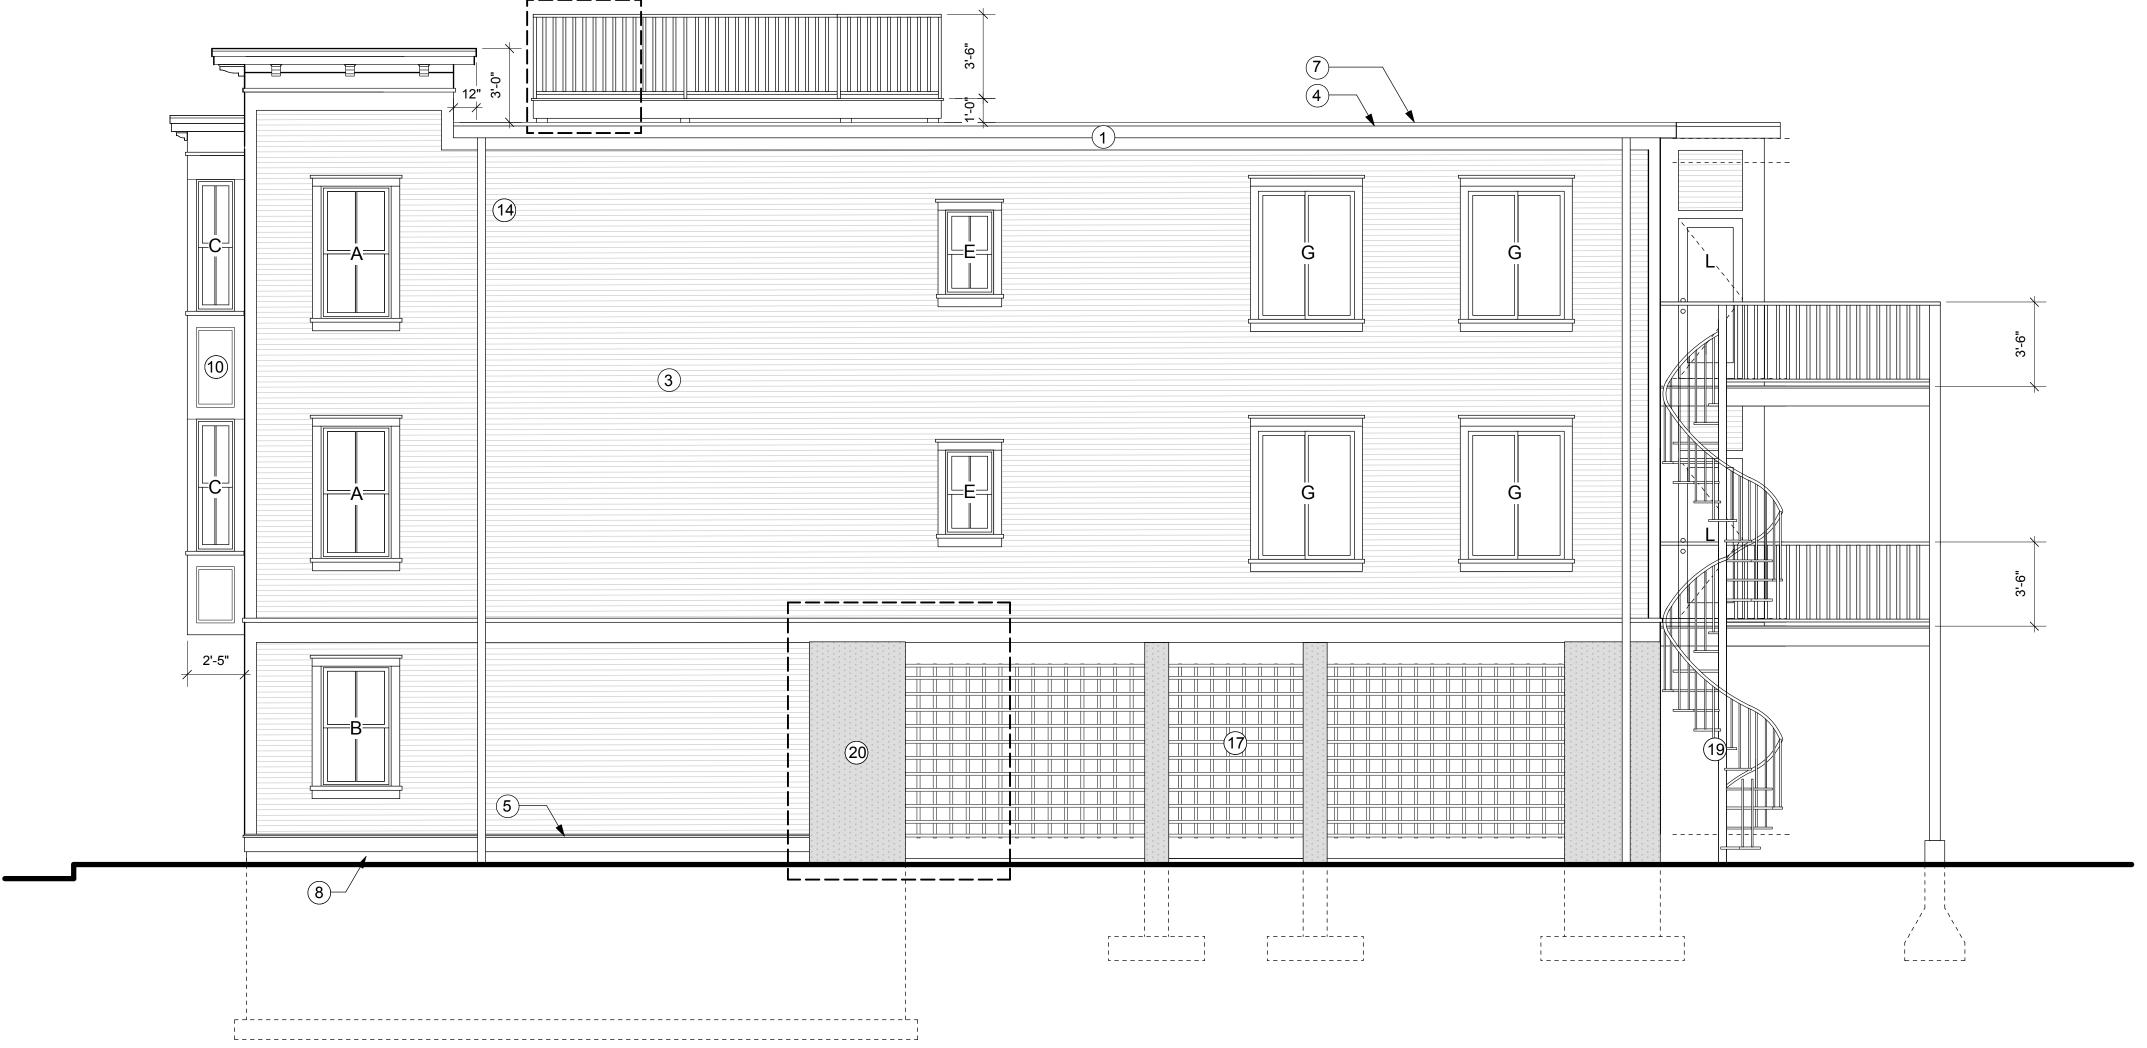
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unprotected windows open area = 52 sf (6%) unprotected garage open area = 104 sf= (12%) total unprotected open area = 156 sf= 18%

RIGHT SIDE CARPORT ELEVATION

K (3x)

**REAR ELEVATION** 

SEE SECTIONS

20

20

3

10'-0"

PERMIT SET REV'D 9-25-15

