

**PREPARED FOR:**  
FRASER ALLEN  
200 FALCON STREET  
EAST BOSTON, MA 02128


**REFERENCES:**  
OWNER OF RECORD:  
KEVIN A. DEVER  
BARBARA D. DEVER  
6 NEAREN ROW  
CHARLESTOWN, MA 02129

**DEED:** BK 8635, PG 421  
BK 9155, PG 164  
**PLAN:** BK 4267, PG 261  
BK 8292, PG 434  
BK 8354, PG 158  
BK 8404, PG 714  
BK 9155, PG 164  
BK 18633, PG 256  
BK 19939, PG 93  
PL 2008 #489  
PL 2014 #361  
**LCC:** 8038-A  
8038-B  
11099-A

**CITY OF BOSTON ENGINEERING RECORDS:**  
FB 438, PG 30  
FB 490, PG 58-59  
FB 504, PGS 48-49  
FB 593, PG 148  
FB 1159, PGS 32-33


L-7727 FERRIN STREET  
L-7756 NEAREN ROW

**NOTES:**  
PARCEL ID: 0202977000

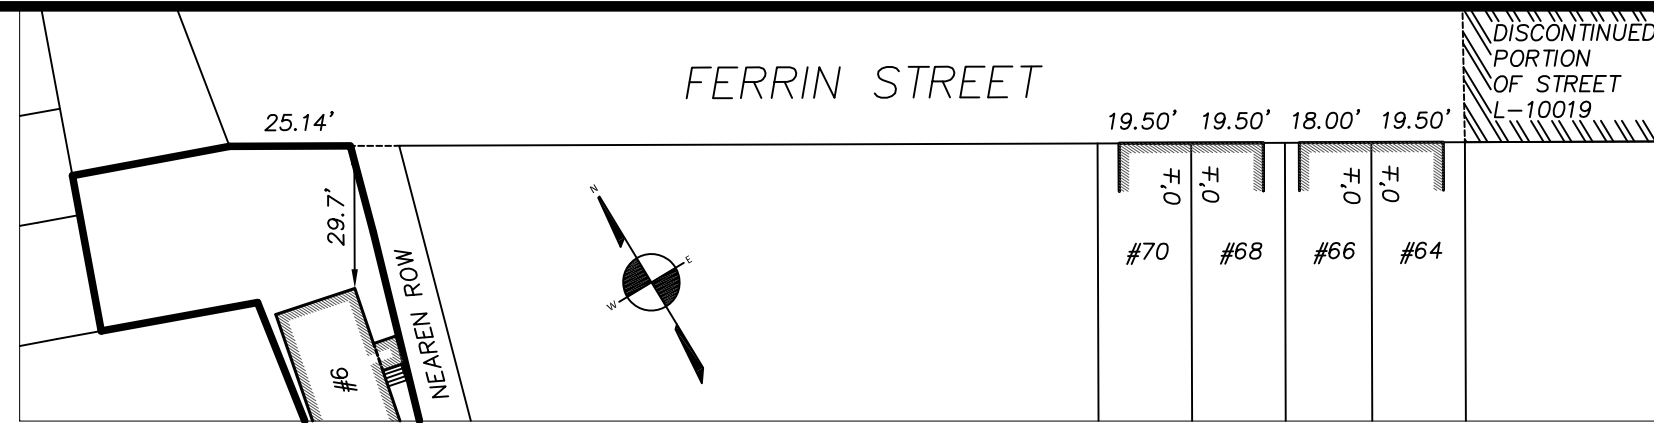


AVERAGE ALIGNMENT	SCALE 1.0' = 40.0'
NEAREN ROW	
COMMON SETBACK	FRONTAGE
0'± (MODAL)	19.50'
	19.50'
	18.00'
	19.50'
TOTAL	76.50'
29.7	25.14'

**BOSTON**  
**SURVEY, INC.**  
UNIT C-4 SHIPWAY PLACE  
CHARLESTOWN, MA 02129  
(617) 242-1313

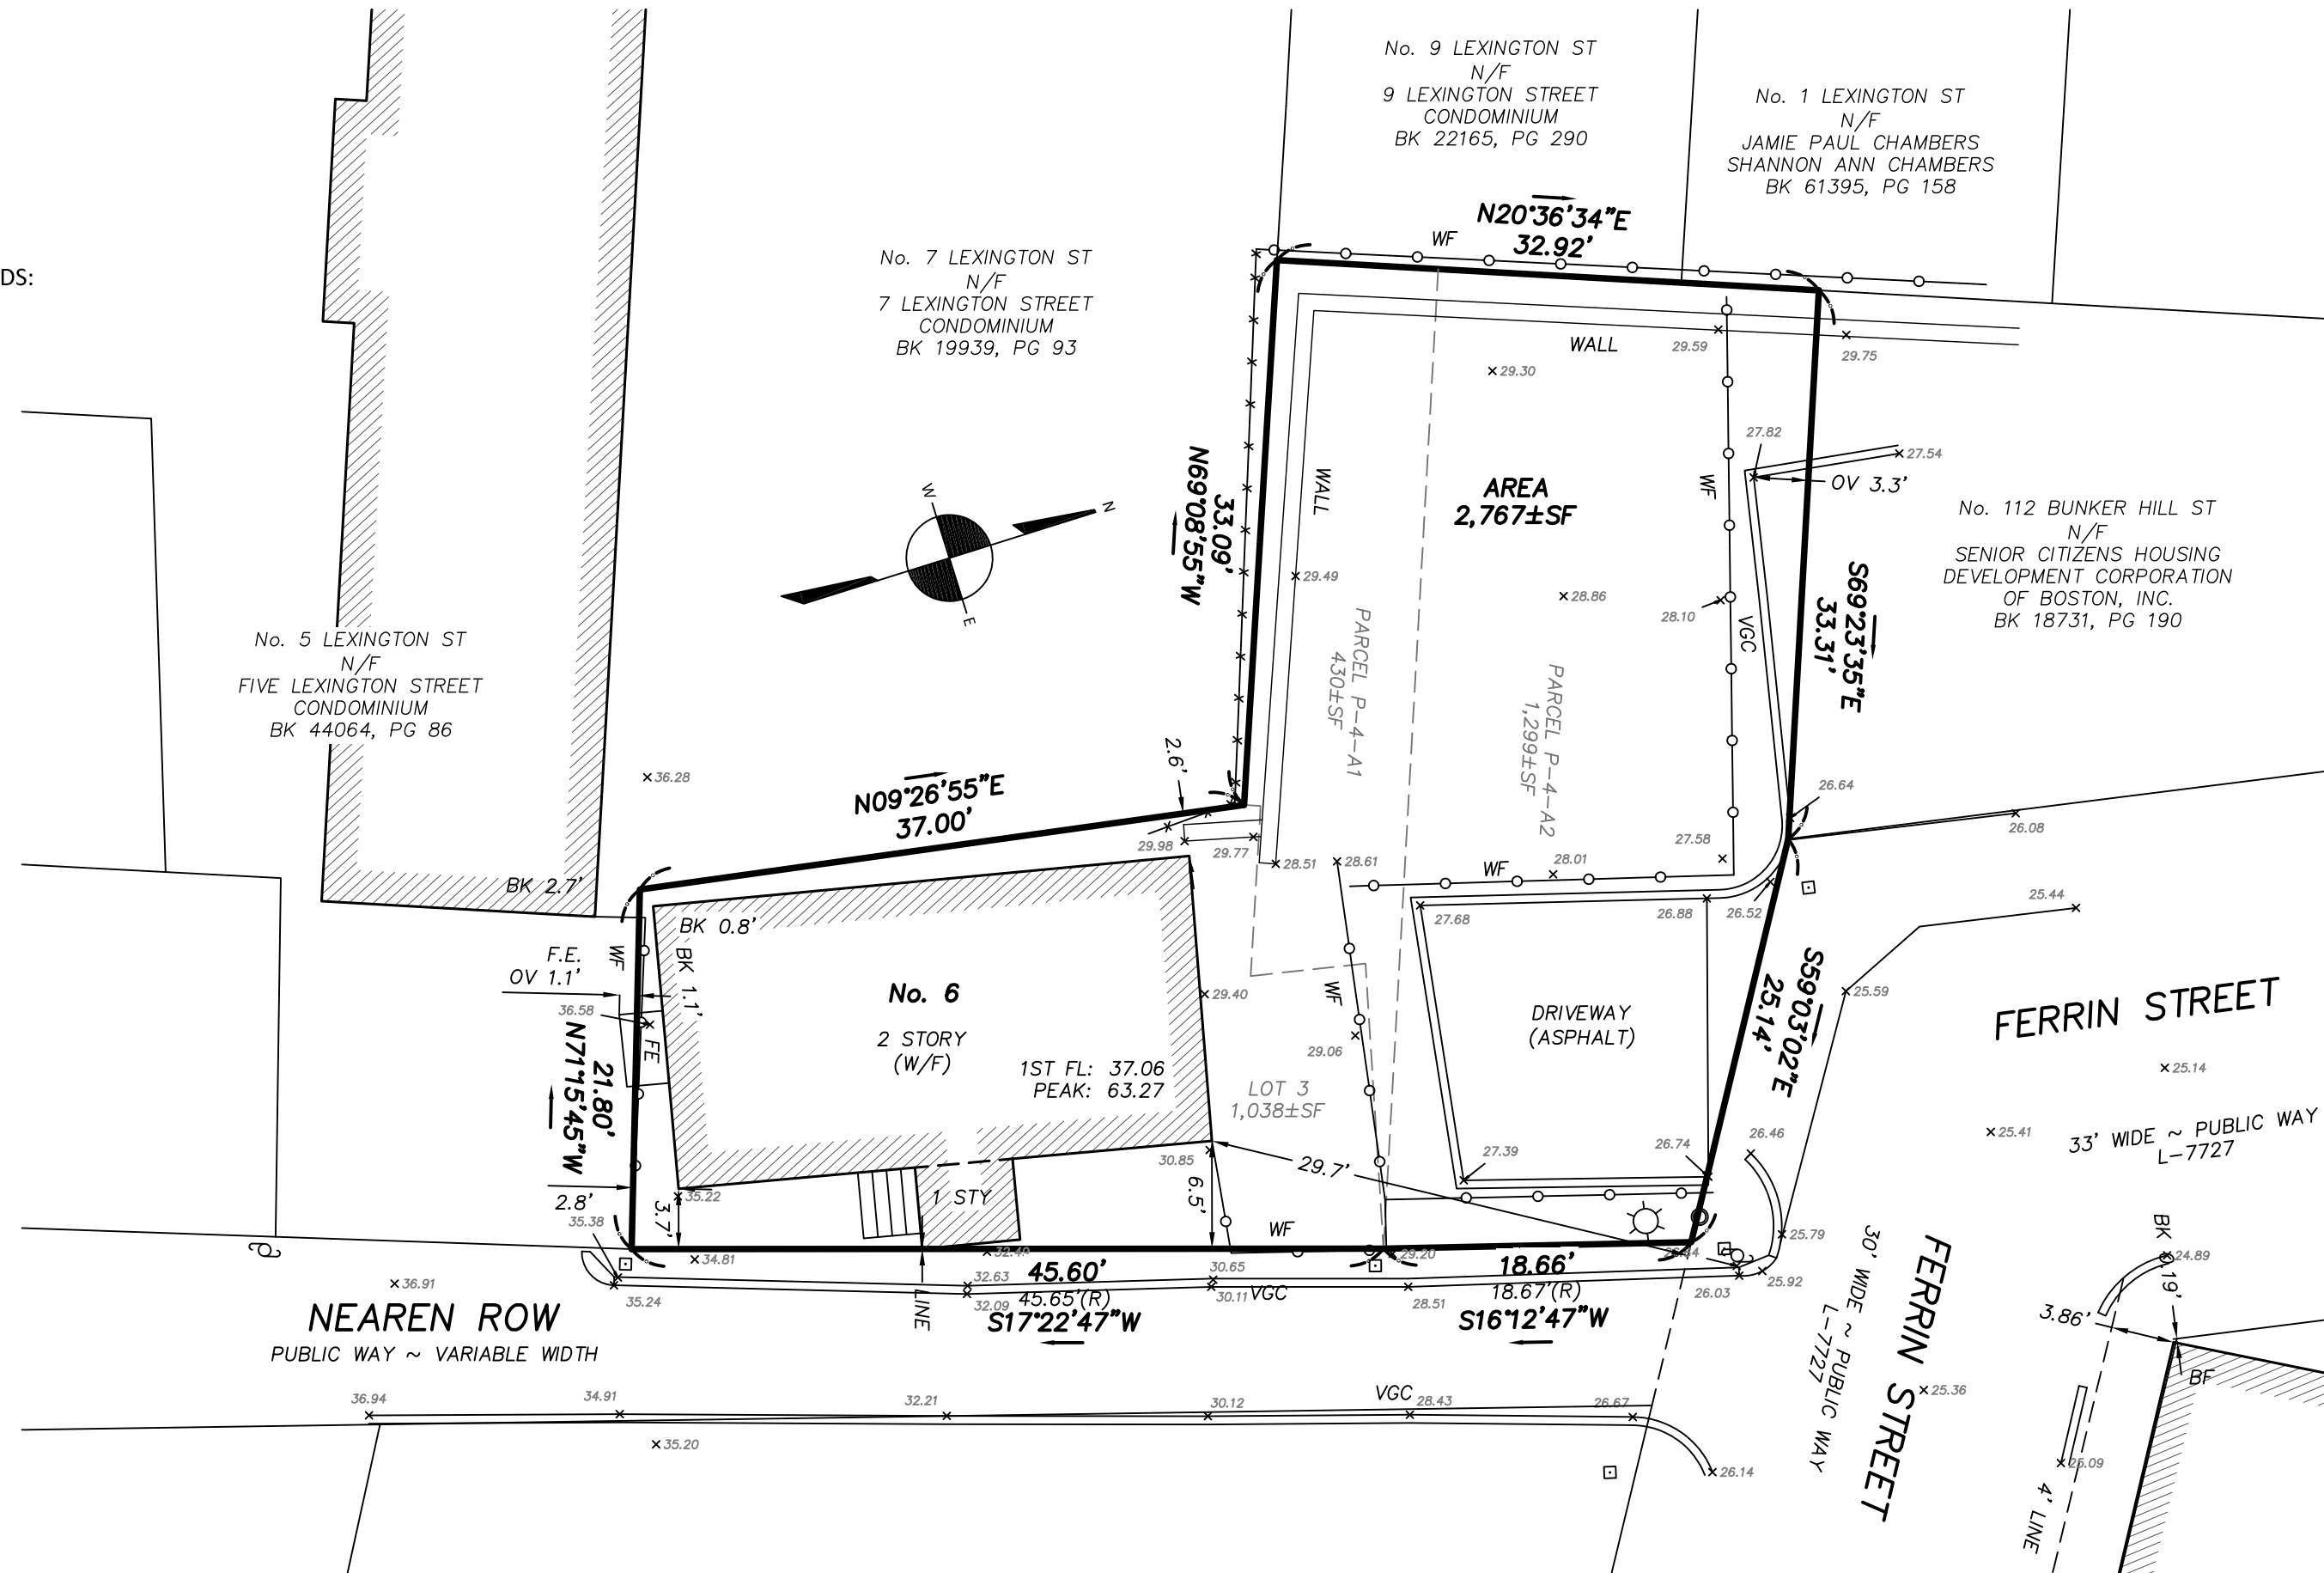


**CERTIFIED PLOT PLAN**

LOCATED AT  
**6 NEAREN ROW**  
**CHARLESTOWN, MA**

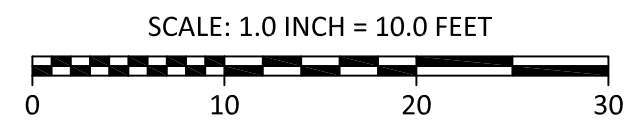


I CERTIFY THAT THIS PLAN WAS MADE FROM AN INSTRUMENT SURVEY ON THE GROUND ON THE DATE OF JUNE 7, 2023 AND ALL STRUCTURES ARE LOCATED AS SHOWN HEREON.

ACCORDING TO THE FEDERAL EMERGENCY MANAGEMENT AGENCY (F.E.M.A.) MAPS, THE MAJOR IMPROVEMENTS ON THIS PROPERTY FALL IN AN AREA DESIGNATED AS  
ZONE: X  
COMMUNITY PANEL: 25025C0018J  
EFFECTIVE DATE: 03/16/2016

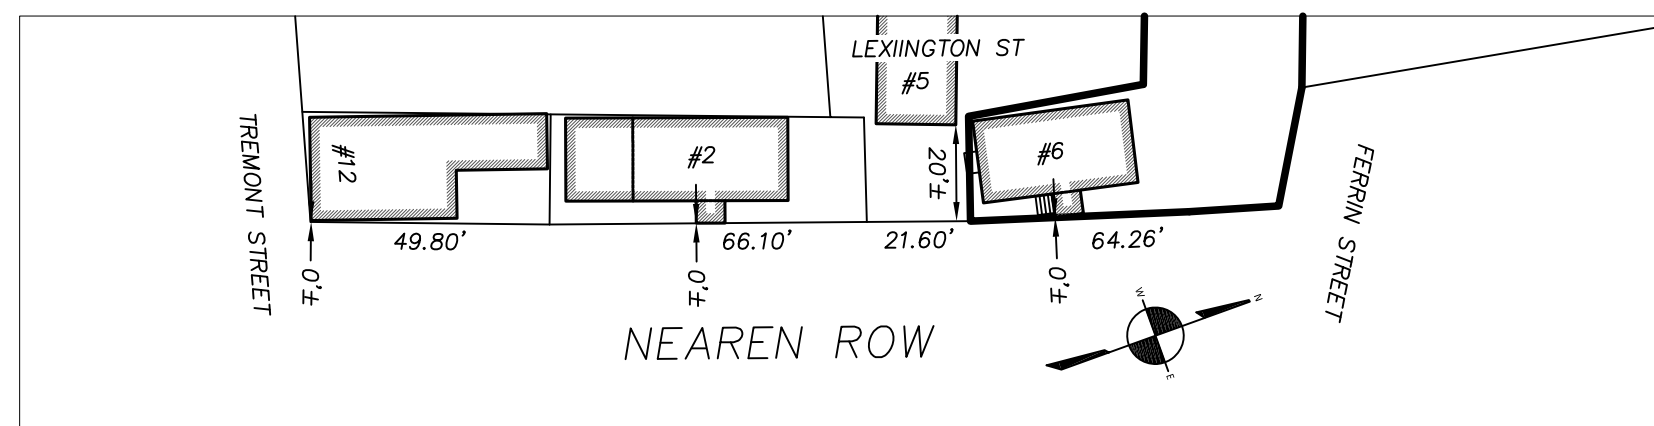

AVERAGE ALIGNMENT	SCALE 1.0' = 40.0'
NEAREN ROW	
COMMON SETBACK	FRONTAGE
0'± (MODAL)	49.60'
	64.26'
	66.10'
TOTAL	179.96'
20'±	21.60

FIELD:	JJH
DRAFT:	RAP
CHECK:	GCC
DATE:	06/16/23
JOB #	23-00360

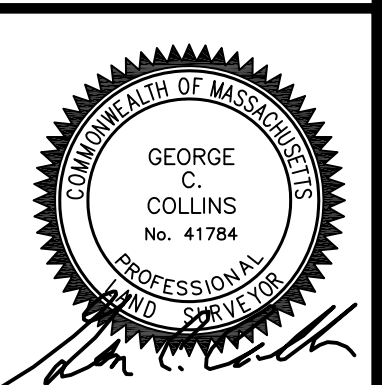

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FRASER ALLEN  
200 FALCON STREET  
EAST BOSTON, MA 02128


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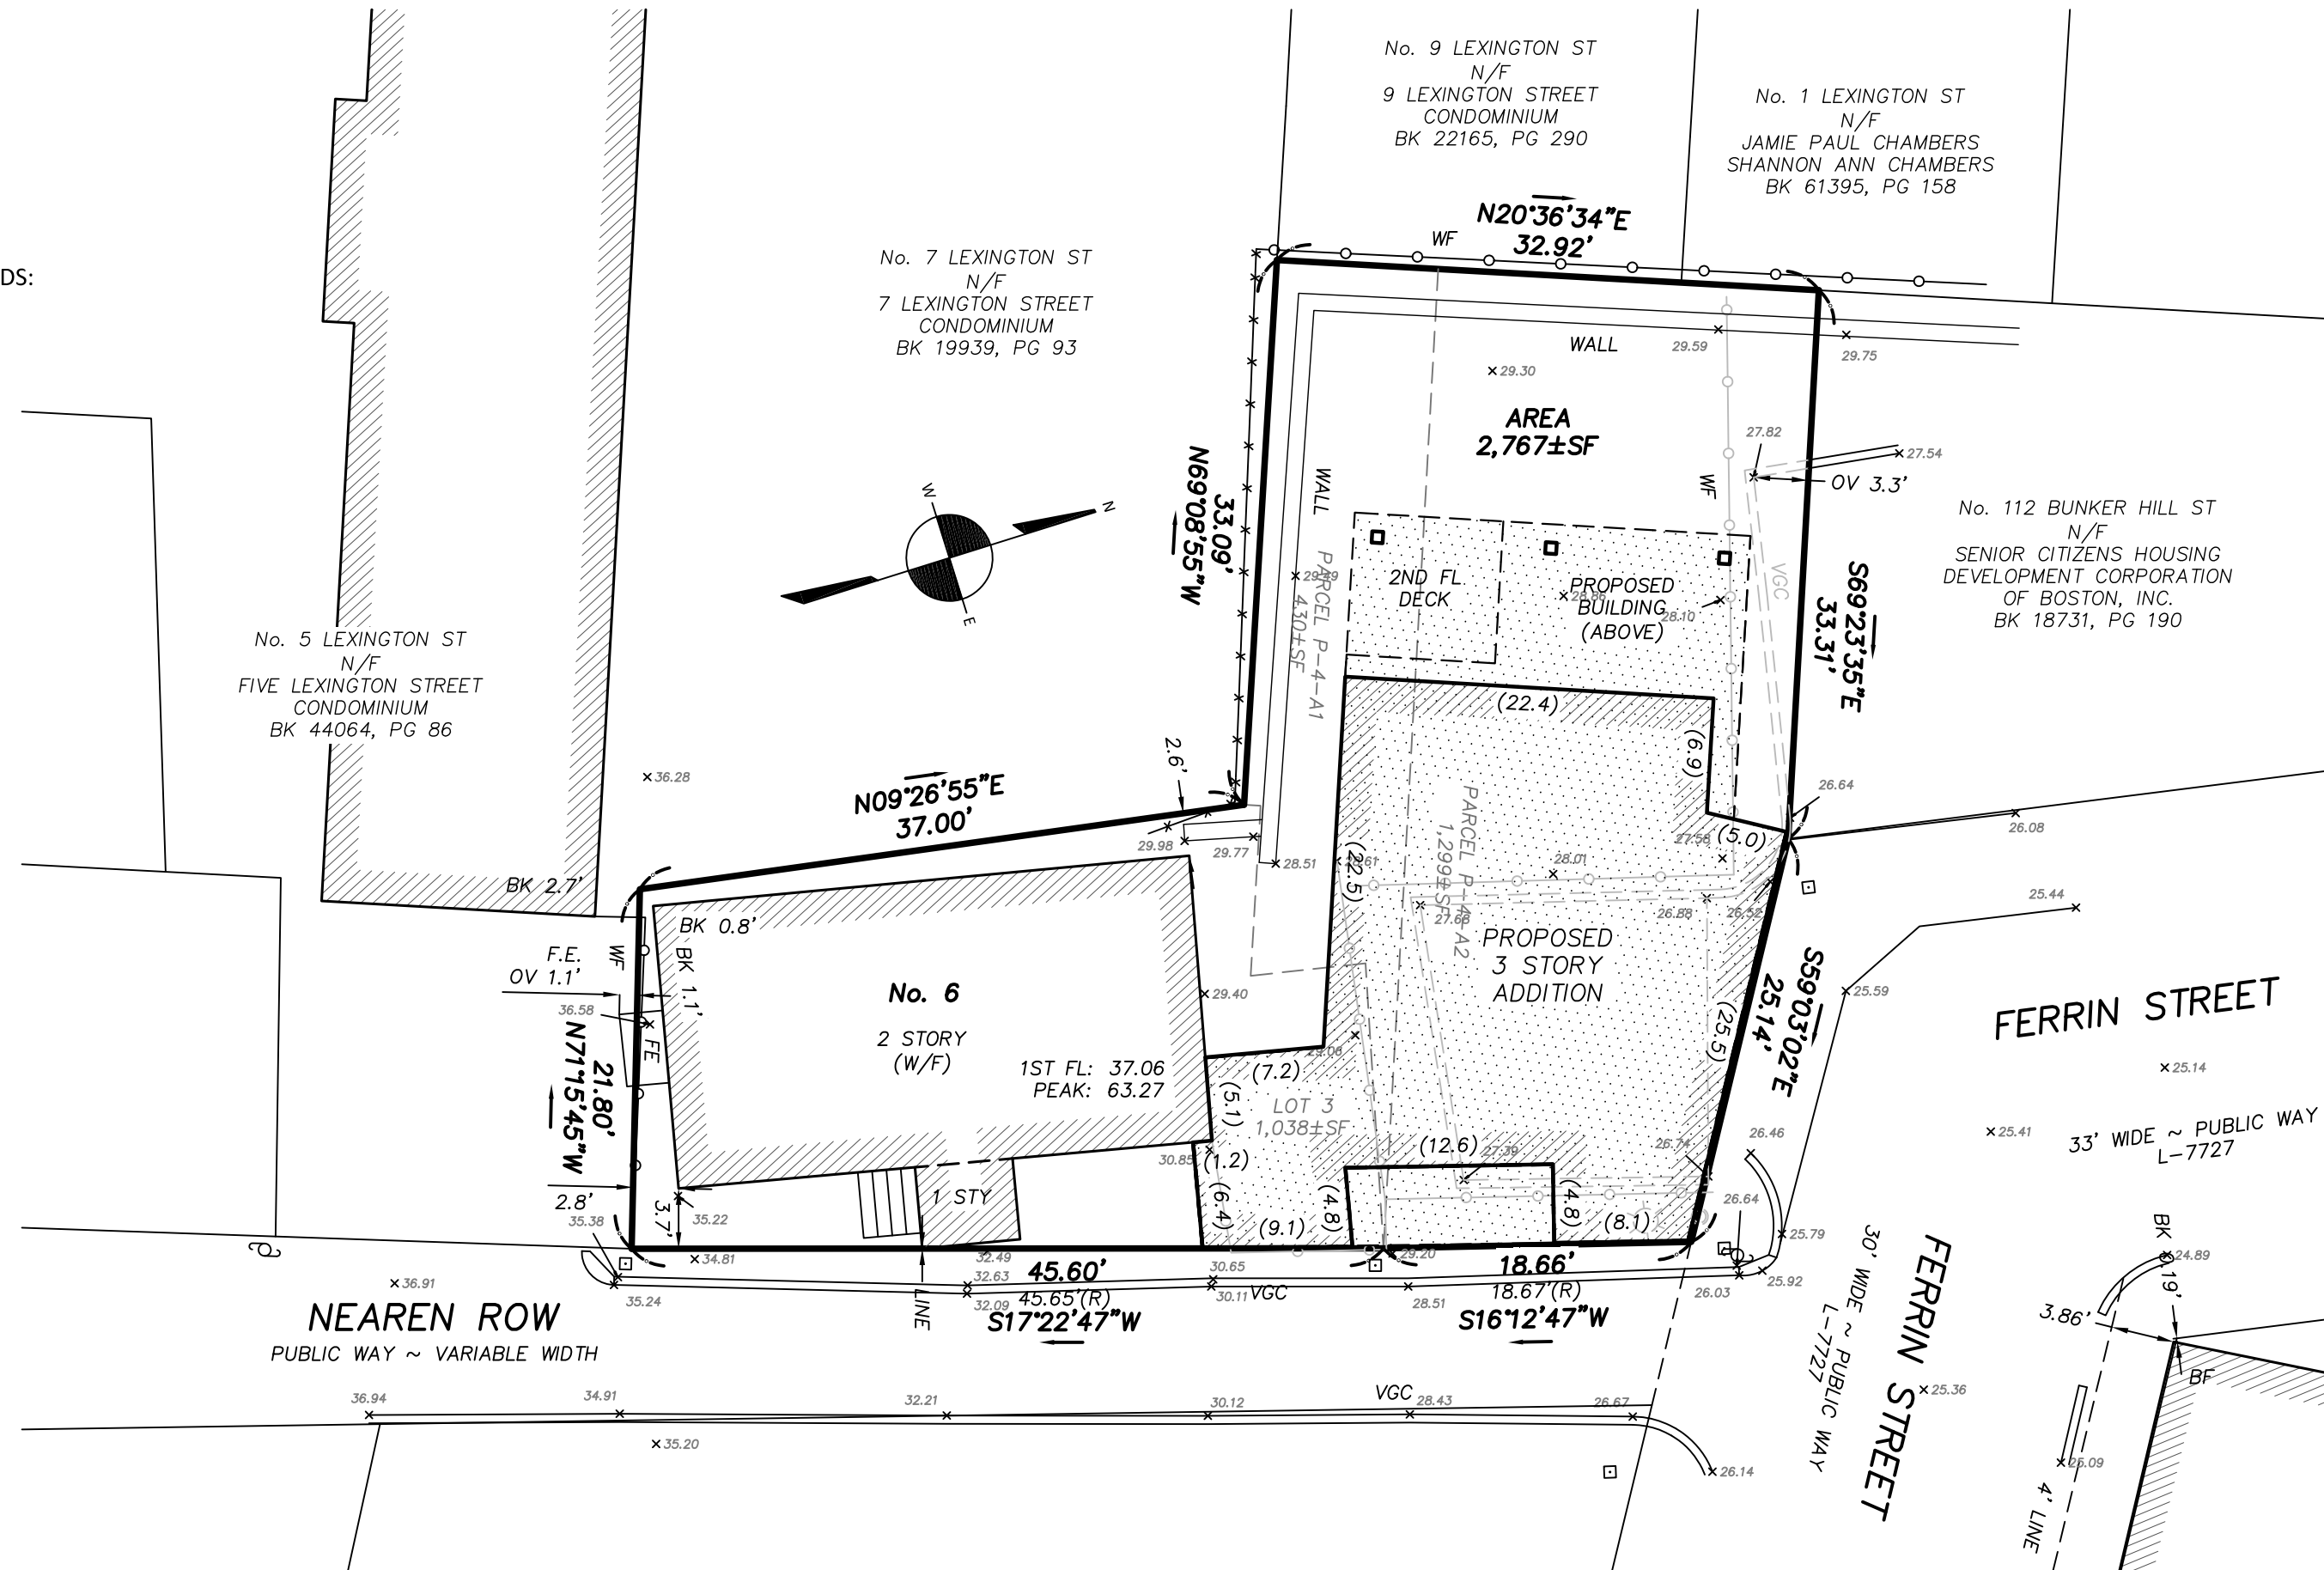
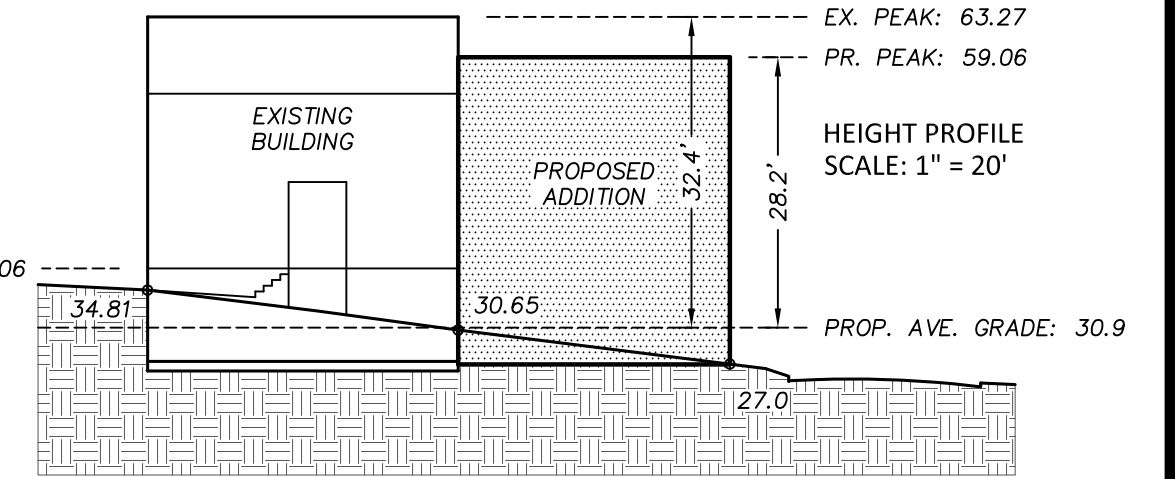
**CITY OF BOSTON ENGINEERING RECORDS:**  
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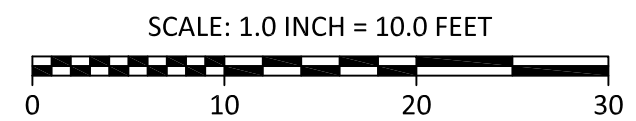


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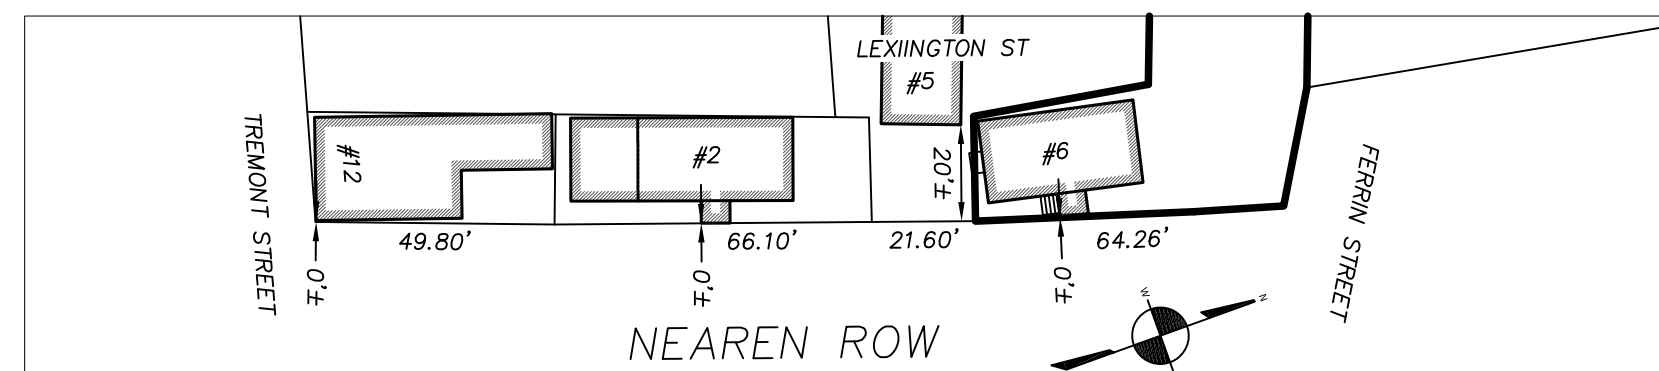
LOCATED AT  
6 NEAREN ROW  
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**BOSTON SURVEY, INC.**  
UNIT C-4 SHIPWAY PLACE  
CHARLESTOWN, MA 02129  
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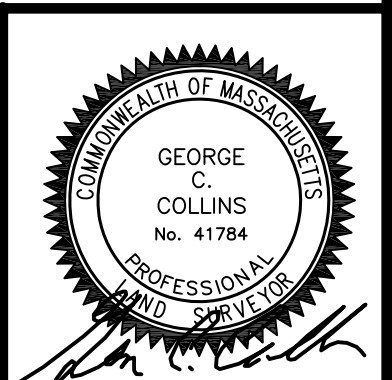
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ZONE: X  
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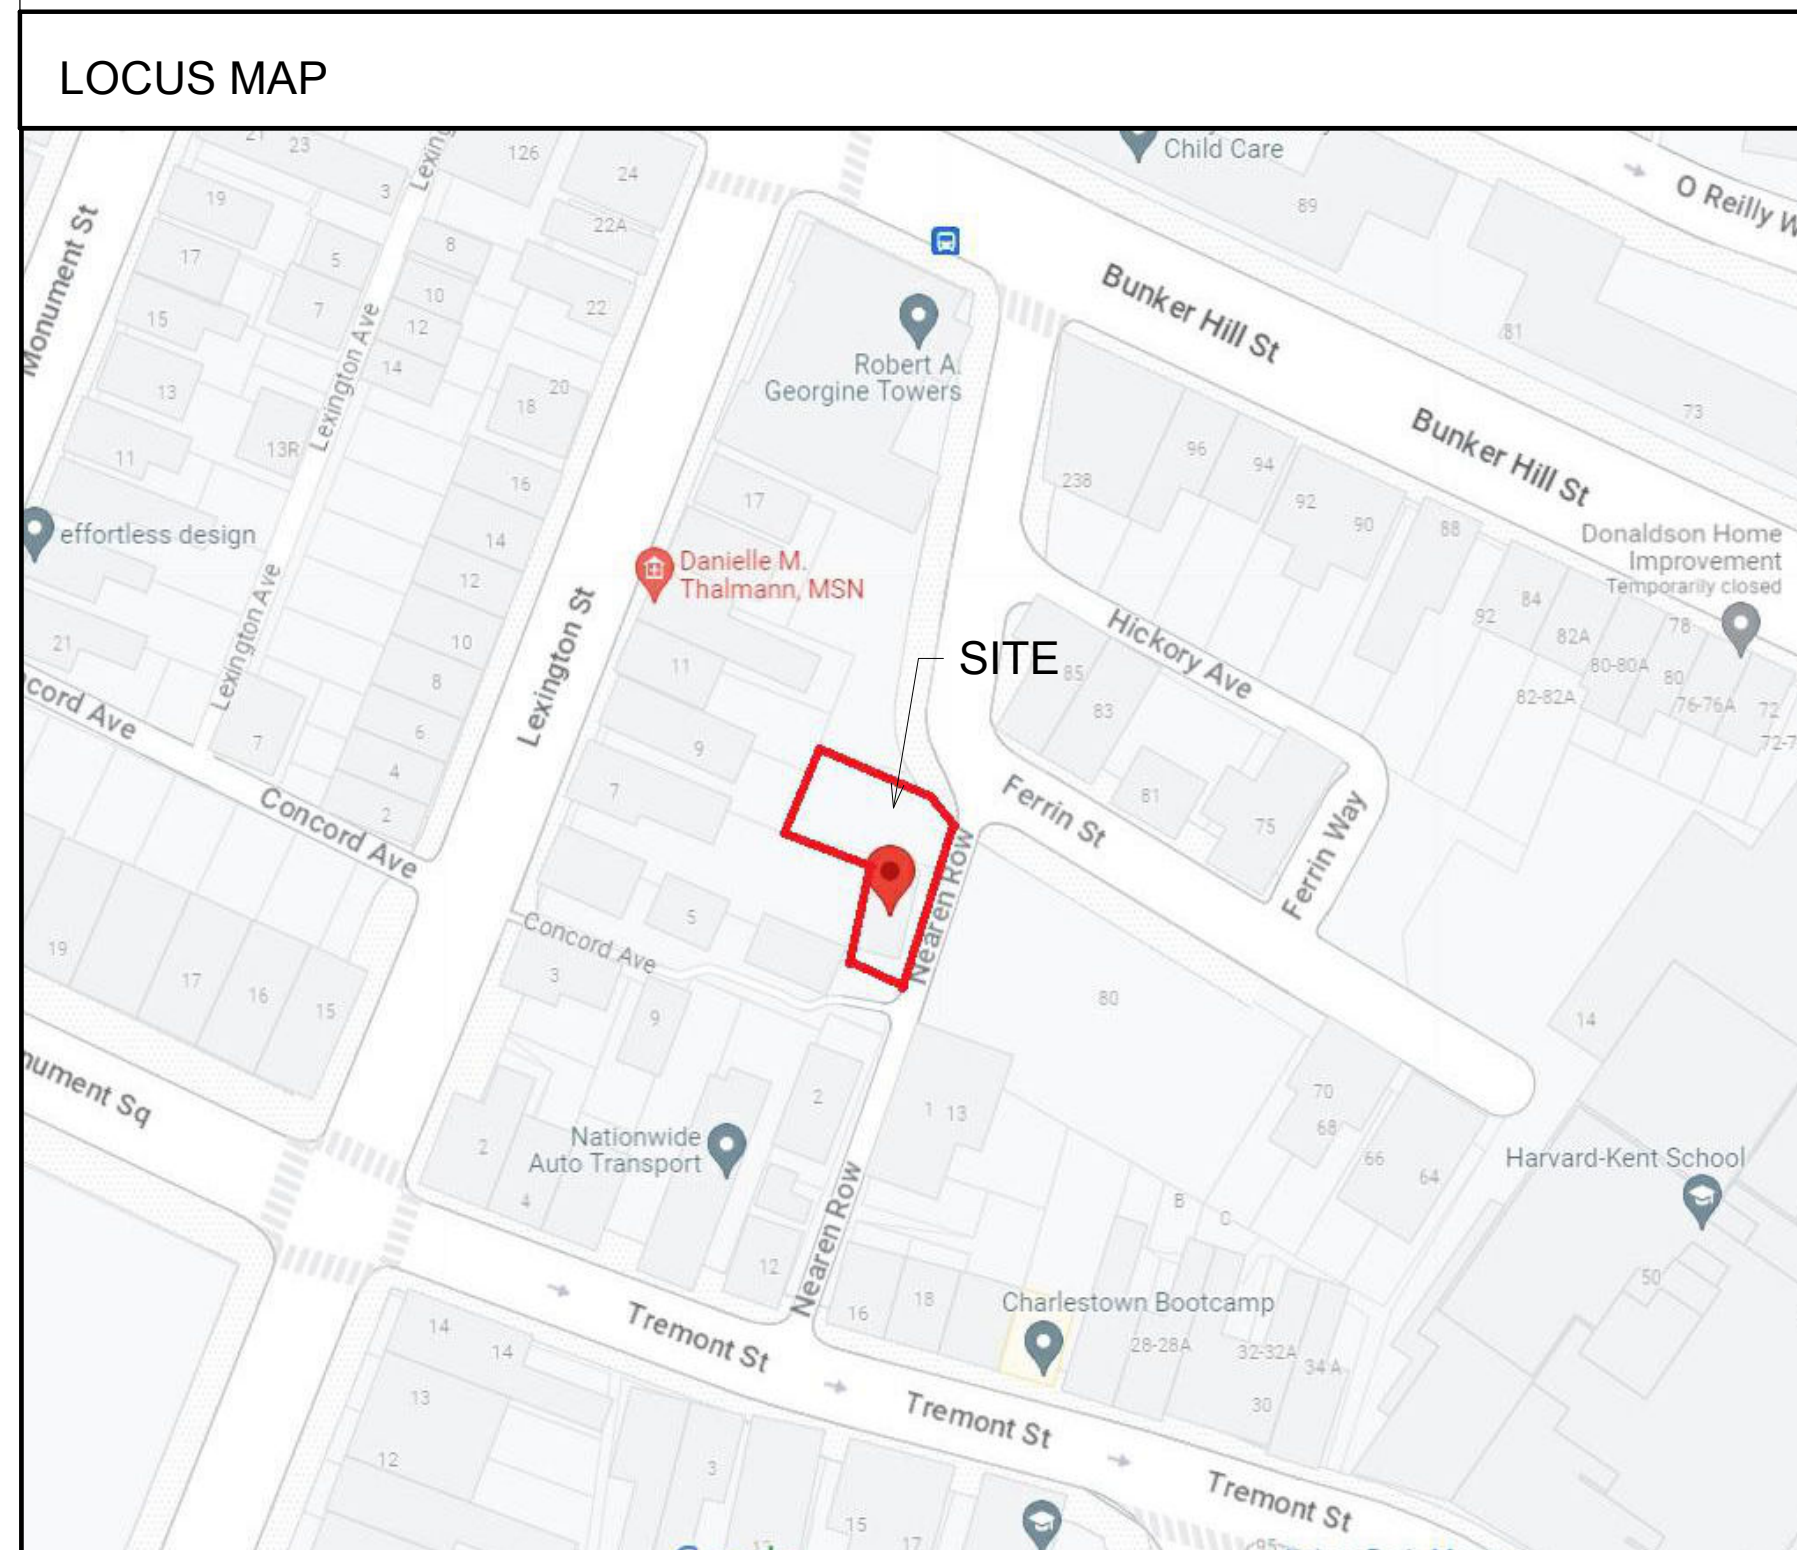
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FIELD:	JJH
DRAFT:	RAP
CHECK:	GCC
DATE:	08/30/23
JOB #	23-00360



# PROPOSED RENOVATION & SEMI-ATTACHED ADDITION

## 6-8 NEAREN ROW. CHARLESTOWN, MA 02129

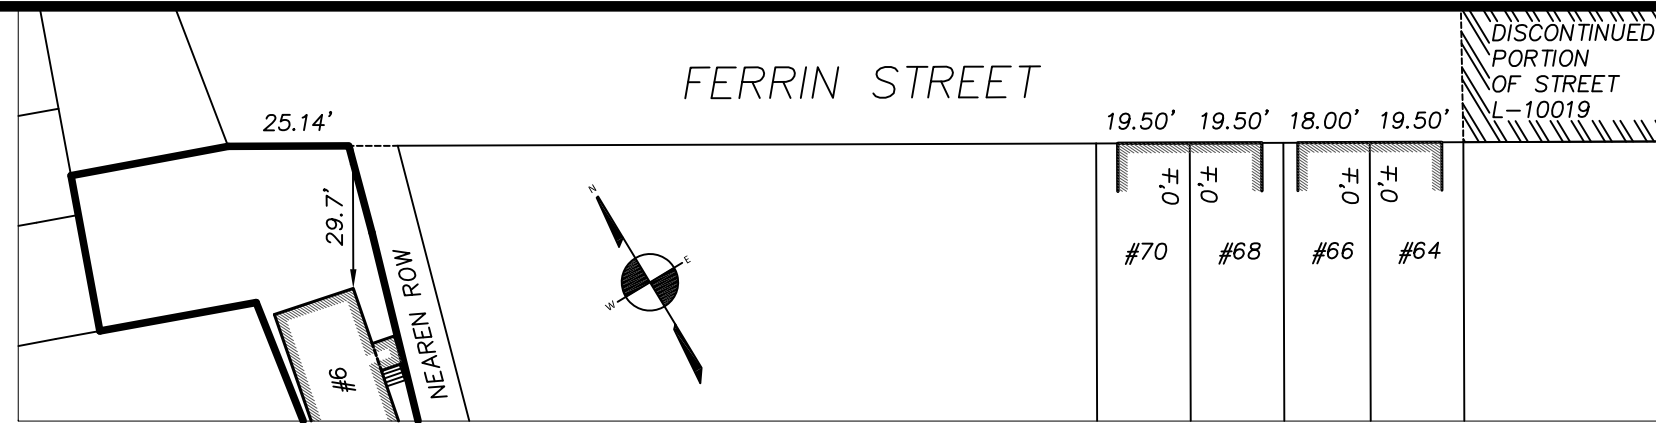

ZONING SUMMARY ART. 62 3F-2000													
	LOT AREA MINIMUM	LOT AREA PER ADD'L UNIT	MIN. LOT SIZE	MIN. LOT WIDTH	MIN. LOT FRONTAGE	F.A.R.	MAX. STORIES	MAX. HEIGHT	SETBACK FRONT	SETBACK EA. SIDE	SETBACK REAR	MIN. OPEN SPACE PER UNIT	MIN. PARKING SPACES PER UNIT
ZONING SUB-DISTRICT 3F-2000	1000 SF / DU	1000 SF	2000 SF	20'	20'	2.0	3	35'	0' MODAL	2.5'	15'	542 SF/DU	1 PS/DU
EXISTING			2767 SF	33' +/-	89.4'	.49	2.5	32.5'	0'	1' +/-	35.6'	1553 SF/DU	1 PS/DU
PROPOSED			2767 SF	33' +/-	89.4'	1.82 (5023 SF)	3	32.5'	0'	3.3'	15'	547 SF/DU	1 PS/DU

\* NOTE:  
VIOLATION

PROPOSED RENOVATION &  
SEMI-ATTACHED ADDITION  
6-8 NEAREN ROW,  
CHARLESTOWN, MA 02129

Choo  
& Company, Inc.

One Billings Road Quincy, MA 02171  
617-786-7727 fax 617-786-7715

No.	Description	Date
2	Revision 2	10-19-2023

Project No: 2023112  
Scale: 1/8" = 1'-0"  
Date: 09-06-2023  
Drawn By: TN / DF

Drawing Name

COVER SHEET

Sheet No.

A-0.00



**GENERAL NOTES:**

**CONTRACTOR RESPONSIBILITY- CONTRACTOR IS SOLELY RESPONSIBLE FOR:**

- 1. VIEWING SITE AND INCLUDING ANY SPECIAL CONDITIONS NECESSARY TO PERFORM THE WORK AS DESCRIBED IN THE DRAWINGS.
2. ESTABLISHING CONTROL OF THE SITE VIA SURVEY, AND LAYOUT.
3. OBTAINING AND PAYING FOR ALL PERMITS.
4. PAYING FOR ALL TEMPORARY UTILITIES AND FACILITIES.
5. CHECKING AND CONFIRMING ALL DIMENSIONS, AND LAYOUTS.
6. SCHEDULING AND SEQUENCING.
7. CONSTRUCTION MEANS, METHODS AND TECHNIQUES
8. MAINTAINING DRAWINGS AND PERMITS ON SITE.
9. JOB SITE SAFETY
10. COORDINATION BETWEEN TRADES, AND SUPPLIERS.
11. PROVIDE SCHEDULE TO OWNER AND ARCHITECT.
12. PROVIDE A SCHEDULE OF VALUES TO THE OWNER AND ARCHITECT.
13. TEMPORARY HEAT, ICE AND SNOWPLOWING IS THE RESPONSIBILITY OF THE CONTRACTOR.
14. SITE CLEANLINESS AND CONFORMANCE TO NFPA 241 REQUIREMENTS.
15. REPAIRING ANY WORK DAMAGED BY HIS FORCES WHILE PERFORMING THIS CONTRACT.
16. GIVING WARRANTY FOR HIS WORK FOR A PERIOD OF ONE YEAR FROM THE DATE OF FINAL COMPLETION.

**REVIEW OF WORK BY DESIGNERS-**

CONTRACTOR SHALL NOTIFY ARCHITECT BEFORE PROJECT STARTS.

CONTRACTOR SHALL NOTIFY ARCHITECT, ONE WEEK PRIOR TO:

- 17. POURING CONCRETE
18. INSULATING
19. INSTALLING DRYWALL
20. FINAL INSPECTION

**SHOP DRAWINGS-**

ALL SHOP DRAWINGS SHALL BE SUBMITTED 30 DAYS AFTER CONTRACT AWARD.

GENERAL CONTRACTOR SHALL APPROVE SHOP DRAWINGS, PRIOR TO SUBMITTING TO ARCHITECT OR ENGINEER.

NON SUBMISSION DOES NOT CONSTITUTE APPROVAL OF ANY WORK.

NO EXCEPTIONS TAKEN DOES NOT RELIEVE THE CONTRACTOR OF PERFORMING ANY OTHER WORK ON THE DRAWINGS.

CONTRACTOR SHALL EXPECT A MINIMUM OF 2 WEEKS FOR DESIGNERS' REVIEW TIME.

ANY VARIANCE FROM THE ORIGINAL DESIGN SHALL BE NOTED.

ANY SUBSTITUTION NOT INDICATED SHALL NOT CONSTITUTE APPROVAL OF A CHANGE.

SHOP DRAWINGS ARE NOT COORDINATION DRAWINGS.

DESIGNERS ARE NOT RESPONSIBLE FOR DIMENSIONS.

CONTRACTOR TO ENSURE MATERIALS AND ASSEMBLIES ARE COMPATIBLE AND ACCEPTABLE TO THE MANUFACTURER. ALL ASSEMBLY MATERIALS SHALL BE FROM A SINGLE SOURCE AS MUCH AS POSSIBLE.

**REQUEST FOR INFORMATION -**

ONLY RFIS SENT THROUGH BY THE OWNER AND AWARDDING CONTRACTOR WILL BE ANSWERED. SUBCONTRACTORS MUST SUBMIT RFIS THROUGH THE GENERAL CONTRACTOR.

BIDDING PHASE - OWNER AND AWARDDING CONTRACTOR ARE RESPONSIBLE FOR COMPILING AND AGGREGATING RFIS AND SUBMITTING TO THE ARCHITECT OR DESIGNER AT ONE TIME ONLY. ARCHITECT OR DESIGNER HAS ONE WEEK TO RESPOND. QUESTIONS MUST BE COMPLETE, NOT PIECEMEAL AND SHOULD BE SUBMITTED BY CSI DIVISION.

**CHANGE ORDERS-**

CONTRACTOR SHALL VISIT THE SITE AND BE THOROUGHLY ACQUAINTED WITH THE PROJECT PRIOR TO SUBMITTING A PRICE. ADDITIONAL MONEY WILL NOT BE GRANTED FOR WORK NOT CLARIFIED PRIOR TO BIDDING.

DESIGNER SHALL BE NOTIFIED OF ANY CHANGE TO THE DRAWINGS, UNFORESEEN FIELD CONDITIONS OR DISCREPANCIES PRIOR TO PERFORMING WORK.

ANY PROPOSED CHANGES SHALL BE ACCOMPANIED WITH A WRITTEN DESCRIPTION OR A SKETCH FOR CLARIFICATION.

ALL CHANGE ORDERS SHALL BE APPROVED PRIOR TO PERFORMING WORK.

CHANGE ORDERS SHALL BE PRICED EITHER LUMP SUM OR UNIT PRICE OR TIME AND MATERIALS.

ANY SUBSTITUTION REQUEST SHALL BE MADE VIA CHANGE ORDER, AND NOT VIA SHOP DRAWINGS UNLESS AGREED TO.

ANY CHANGE SHALL STATE THE CREDIT OR COST ADD AND/OR ANY CHANGE TO THE SCHEDULE.

**REQUISITIONS-**

ANY REQUISITION REQUIRED TO BE SIGNED BY THE ARCHITECT SHALL BE SUBMITTED A MINIMUM OF ONE WEEK PRIOR TO BEING SUBMITTED TO THE BANK FOR REVIEW.

CONTRACTOR SHALL PROVIDE RECEIPTS AND INSURANCE CERTIFICATES FOR ANY MATERIALS FOR PAYMENT FOR ANY UNINSTALLED MATERIALS.

**WOOD NOTES:**

- 1. ALL LUMBER SHALL HAVE A MOISTURE CONTENT OF NOT MORE THAN 19%.
2. ALL FRAMING LUMBER SHALL BE #2 SPF, OR BETTER, HAVING A MINIMUM: FB=875 PSI, FV=135 PSI, E=1,300,000 PSI.
3. ALL JOIST SPANS SHALL HAVE ONE ROW OF 1" X 3: CROSS BRIDGING AT MID SPAN AND NOT MORE THAN 8'-0" O.C.
4. ALL STUD BEARING WALLS SHALL HAVE ONE ROW OF 2X HORIZONTAL BLOCKING AT 1/2 STUD HEIGHT, AND NOT MORE THAN 6'-0" O.C. MAXIMUM.
5. PROVIDE AND INSTALL ALL NECESSARY TIMBER CONNECTORS WITH ADEQUATE STRENGTH.
6. PROVIDE DOUBLE JOIST BELOW PARTITIONS PARALLEL TO JOIST FRAMING.
7. PROVIDE SOLID BRIDGING BELOW PARTITIONS PERPENDICULAR TO JOIST FRAMING.
8. PROVIDE SOLID BRIDGING BETWEEN JOIST FRAMING MEMBERS WHEN BEARING ON STUD PARTITIONS OR BEAMS.
9. PROVIDE A CONTINUOUS BAND JOIST AT EXTERIOR STUD WALLS.
10. PROVIDE DIAGONAL METAL STRAP BRACING AT ALL CORNERS AND WALL INTERSECTIONS, AT THE INSIDE FACE OF STUDS, FROM TOP PLATE TO FLOOR PLATE AT A 45 DEGREE ANGLE WITH A SIMPSON TYPE "RCWB" STRAP, OR EQUAL.
11. ALL BUILT-UP BEAMS SHALL BE BOLTED WITH 1/2" O THRU BOLTS, MEETING A307 STANDARDS, OR, AS NOTED ON DRAWINGS.

**WOOD LINTEL SCHEDULE:**

Lintels over openings in bearing walls shall be as follows;or as noted on drawings.

Table with 3 columns: Span of opening, Size: 2x6 studs, Size: 2x4 studs. Rows include less than 4'-0", up to 6'-0", up to 8'-0", and up to 10'-0".

**DESIGN CRITERIA:**

ALL WORK PERFORMED UNDER THIS CONTRACT SHALL CONFORM TO THE NINTH EDITION OF THE MASSACHUSETTS BUILDING CODE.

- DESIGN LIVE LOAD = 40 POUNDS PER SQUARE FOOT - FLOORS - PRIVATE DECK
DESIGN SNOW LOAD = 40 POUNDS PER SQUARE FOOT WITH SNOW DRIFT WHERE APPLICABLE.
WIND LOAD = 128 MILES PER HOUR
SEISMIC: Ss = 0.217 S1 = 0.069

ALL LUMBER SHALL BE #2 SPF, FB= 875 PSI, Fv=135 PSI.

**FOUNDATION NOTES:**

- 1. THE FOUNDATION HAS BEEN DESIGNED FOR 4000 PSF ALLOWABLE SOIL BEARING CAPACITY.
2. ALL BACKFILL UNDER STRUCTURAL SLABS, MATS, AND FOOTINGS WILL BE ENGINEERED BACKFILL COMPACTED IN SPECIFIC LIFTS TO 95 PERCENT OF MAXIMUM DRY DENSITY, UNLESS OTHERWISE INDICATED OR SPECIFIED.
3. ALL EMBANKMENTS AND BACKFILL COMPACTED IN SPECIFIED LIFTS TO 90 PERCENT OF MAXIMUM DRY DENSITY, UNLESS OTHERWISE INDICATED OR SPECIFIED.
4. PROVIDE SHEETING, BRACING, AND UNDERPINNING AS REQUIRED TO PRESERVE ADJACENT STRUCTURES.
5. FOUNDATIONS SHALL NOT BE POURED IN WATER OR ON FROZEN GROUND.
6. VERIFY LOCATIONS AND REQUIREMENTS FOR INSERTS, SLEEVES, CONDUITS, EMBEDMENT AND PENETRATIONS WITH RESPECTIVE TRADES BEFORE PLACING CONCRETE.
7. DOWELS FROM FOUNDATIONS INTO PIERS, COLUMNS, BUTTRESSES OR WALLS SHALL BE THE SAME SIZE AND NUMBER AS REINFORCEMENT IN PIERS, COLUMNS, BUTTRESSES OR WALLS ABOVE, EXCEPT AS OTHERWISE SHOWN.
8. CONTRACTOR SHALL PROVIDE CONTINUOUS DRAINAGE BY MECHANICAL METHODS TO CONTROL SURFACE AND UNDERGROUND WATER, AS REQUIRED DURING CONSTRUCTION.
9. CONTRACTOR SHALL ENSURE THAT GROUND WATER LEVELS UNDER ADJACENT STRUCTURES AND PROPERTIES ARE NOT ALTERED.
10. ALL FOUNDATION UNITS (PIERS) SHALL BE CENTERED SUPPORT MEMBERS, UNLESS OTHERWISE NOTED ON PLANS.
11. COORDINATE UNDER FLOOR AND PERIMETER DRAIN REQUIREMENTS WITH ARCHITECTURAL, CIVIL AND PLUMBING DRAWINGS AND THE REQUIREMENTS OF THE GEOTECHNICAL ENGINEER.
12. ALL BEARING MATERIALS SHALL BE INSPECTED BY THE INDEPENDENT TESTING AGENCY PRIOR TO CONCRETE PLACEMENT. THE INDEPENDENT TESTING AGENCY SHALL DETERMINE THE SUITABILITY OF THE BEARING MATERIAL. FOOTING ELEVATIONS SHALL BE ADJUSTED AS REQUIRED.
13. BOTTOM OF ALL EXTERIOR FOOTINGS SHALL BEAR A MINIMUM OF 4'-0" BELOW FINAL FINISHED GRADE FOR FROST PROTECTION.
14. FOUNDATION WALLS THAT RETAIN EARTH SHALL BE BRACED AGAINST BACKFILLING PRESSURES UNTIL FLOOR & SLAB AT TOP AND BOTTOM ARE IN PLACE.
15. WHERE FOUNDATION WALLS ARE TO HAVE EARTH PLACED ON EACH SIDE, PLACE FILL SIMULTANEOUSLY SO AS TO MAINTAIN A COMMON ELEVATION ON EACH SIDE OF THE WALL.
16. ALL FOOTING EXCAVATIONS ARE TO BE FINISHED BY HAND.
17. SEE THE REQUIREMENTS OF THE SPECIFICATIONS FOR BACKFILLING UNDER OR ADJACENT TO ANY PORTION OF THE BUILDING.
18. PROTECT IN-PLACE FOUNDATIONS, SLABS AND ADJACENT STRUCTURES, NEW CONSTRUCTION, STREET UTILITIES FROM FROST PENETRATION OR DAMAGE FROM CONSTRUCTION ACTIVITIES UNTIL THE PROJECT IS COMPLETED.
19. SLAB ON GRADE SHALL BEAR DIRECTLY ON A MIN. 12" THICK LAYER OF COMPACTED STRUCTURAL FILL, OR MIN. 6" THICK LAYER OF CRUSHED STONE, PLACED ABOVE PROOFROLLED AND COMPACTED EXISTING FILL, OR ABOVE UNDISTURBED NATURAL TILL. SHOULD BEDROCK BE ENCOUNTERED AT OR WITHIN 12" OF BOTTOM OF SLAB, BEDROCK SHALL BE OVER EXCAVATED A MIN. OF 12" BELOW BOTTOM OF SLAB.
20. WHERE BEDROCK IS ENCOUNTERED AT OR WITHIN 12" OF DESIGN FOOTING GRADE, IT SHOULD BE OVER EXCAVATED A MIN. OF 12" BELOW THE BOTTOM OF PROPOSED FOOTING. BEDROCK EXCAVATIONS SHOULD EXTEND A MIN. OF 12" BEYOND FOOTING EDGE. LOOSE ROCK PIECES SHOULD BE REMOVED WITHIN THE FOOTING BEARING ZONE, AND OPEN BEDROCK JOINTS SHOULD BE CHOKED WITH CRUSHED STONE OR FILLED WITH CONCRETE PRIOR TO PLACING THE SOIL CUSHION.

**CONCRETE NOTES:**

- 1. ALL CONCRETE SHALL ATTAIN A MINIMUM COMPRESSIVE STRENGTH OF: - 3000 PSI FOR FOUNDATION WALL, EXTERIOR WALLS AND OTHER VERTICAL CONCRETE SURFACES EXPOSED TO THE WEATHER.
2. MAXIMUM SLUMP SHALL NOT EXCEED 3"; AND MAXIMUM; COARSE AGGREGATE SIZE SHALL NOT EXCEED 3/4" IN DIAMETER.

**REINFORCING NOTES:**

- 1. ALL REINFORCEMENT, EXCEPT FOR TIES AND STIRRUPS, SHALL CONFORM TO ASTM 615-60.
2. ALL REINFORCEMENT FOR TIES AND STIRRUPS SHALL CONFORM TO ASTM 615-40.
3. ALL WELDED WIRE FABRIC SHALL CONFORM TO ASTM A185-70 SPECIFICATIONS.
4. ALL REINFORCEMENT SHALL BE INSPECTED AND APPROVED BY THE ARCHITECT OR HIS ENGINEER PRIOR TO THE PLACEMENT OF ANY CONCRETE.
5. THE CONTRACTOR SHALL SUBMIT FOUR PRINTS OF SHOP DRAWINGS: SHOWING ALL REINFORCING DETAILS, CHAIR BARS, HIGH CHAIRS, SLAB BOLSTERS, ETC. TO THE ARCHITECT FOR HIS APPROVAL. THE CONTRACTOR SHALL RECEIVE WRITTEN APPROVED SHOP DRAWINGS FROM THE ARCHITECT OR HIS ENGINEER PRIOR TO THE FABRICATION OF REINFORCEMENT.
6. CLEARANCES OF MAIN REINFORCING FROM ADJACENT CONCRETE SURFACES SHALL BE AS FOLLOWS:
A. FOOTINGS 3 INCHES
B. SIDES OF FOUNDATIONS WALLS. EXPOSED FACES OF FOUNDATIONS. SIDES OF COLUMNS/PIERS. SLABS ON GRADE FROM TOP SURFACE 2 INCHES
C. INTERIOR FACES OF FOUNDATIONS, TOP REINFORCING IN SLABS EXPOSED TO THE WEATHER 1-1/2 INCHES
D. TOP STEEL OF INTERIOR SLABS 1 INCHES
7. MAXIMUM DEVIATION FROM THESE REQUIREMENTS SHALL BE 1/4" OF SECTIONS 10" OR LESS, 1/2" FOR SECTIONS GREATER THAN 10".

**REMOVALS NOTES:**





- 1. DEMOLITION CONTRACTOR IS TO ARRANGE FOR SHUT OFF OF EXISTING UTILITIES. CONTRACTOR SHALL ARRANGE ALL TEMPORARY POWER.
2. ALL DEMOLISHED MECHANICAL AND ELECTRICAL ITEMS SHALL BE REMOVED INCLUDING MAIN RUNS AND SERVICE LINES TO SOURCE. ALL SYSTEM LINES ARE NOT SHOWN ON CONSTRUCTION DOCUMENTS.
3. THE EXISTING INTERIOR MAIN STAIR IS TO REMAIN FOR RE-USE. GC TO PROVIDE PROTECTION TO HANDRAIL & BALUSTERS THROUGHOUT CONSTRUCTION. GC TO REPAIR ANY DAMAGE TO ITEMS INDICATED TO REMAIN AS A RESULT OF DEMOLITION AND/OR CONSTRUCTION ACTIVITIES. DEMOLITION NOTES INDICATED ON DRAWINGS MAY NOT BE ALL INCLUSIVE. REMOVE ALL ITEMS REQUIRED FOR RECONSTRUCTION ACTIVITIES.
4. VERIFY EXTENT OF ALL CONDITIONS OF DEMOLITION WITH FLOOR PLANS AND SCHEDULED CONSTRUCTION PRIOR TO DEMOLITION. DISCREPANCIES BETWEEN DESIGN CONDITIONS AND EXISTING CONDITIONS SHALL BE BROUGHT TO THE ATTENTION OF THE OWNER & ARCHITECT.
5. ALL WALLS, SUBSTRUCTURAL FRAMES, PARTITIONS, EQUIPMENT, ETC. INDICATED BY DASHED LINES (----) SHALL BE REMOVED. ALL MECHANICAL, ELECTRICAL, PLUMBING AND OTHER SERVICES WHICH ARE CONTAINED IN THE AREA TO BE REMOVED SHALL ALSO BE REMOVED OR REROUTED. CONTRACTOR SHALL COORDINATE ALL DEMOLITION WITH NEW CONSTRUCTION BEFORE STARTING DEMOLITION.
6. ALL EXISTING UNUSED WALL PENETRATIONS IN INTERIOR AND EXTERIOR WALLS ALONG WITH PENETRATIONS LEFT AFTER SELECTIVE DEMOLITION ACTIVITIES SHALL BE INFILLED TO MATCH ADJACENT WALL FINISHES AND THICKNESS AS DIRECTED.
7. MAINTAIN CLEAR EXIT PATHS DURING DEMOLITION AND CONSTRUCTION ACTIVITIES.
8. ALL STRUCTURAL ELEMENTS SHALL BE PROTECTED DURING DEMOLITION.
9. REMOVE ONLY NON-LOAD BEARING CONSTRUCTION AND PARTITIONS. CONTRACTOR TO VERIFY, PRIOR TO REMOVAL, THAT NO STRUCTURAL COMPONENTS, I.E. BEARING WALLS, BEAMS, HEADERS, ETC., SUPPORTING FLOOR, ROOF OR CEILING JOISTS ARE DESIGNATED FOR REMOVAL. CONTACT THE ARCHITECT PRIOR TO REMOVAL OF ANY CONSTRUCTION IN QUESTION OR DEVIATING FROM THE DESIGN INTENT. CONTRACTOR'S NON-CONTACT OF ARCHITECT PRIOR TO REMOVAL OF ANY WORK INDICATES HIS COMPLETE UNDERSTANDING THAT NO LOAD BEARING OR STRUCTURAL WORK IS BEING ALTERED UNDER THIS CONTRACT.
10. WHERE APPLICABLE LEVEL ALL EXISTING FLOORS AS REQUIRED TO RECEIVE NEW FLOOR FINISHES. INSTALL REQUIRED TRANSITION PIECES BETWEEN VARIOUS FLOOR FINISHES SUITABLE FOR CONDITIONS AND ACCEPTABLE TO THE OWNER.
11. PROTECT ALL EXISTING STRUCTURE, SYSTEMS, FINISHES AND GENERAL CONSTRUCTION THAT ARE TO REMAIN THROUGHOUT THE COURSE OF THE WORK TO PREVENT DAMAGE OR LOSS. ANY SUCH DAMAGE CAUSED DURING THE COURSE OF THIS WORK WILL BE REPAIRED AT THE CONTRACTOR'S EXPENSE BEFORE THIS WORK IS CONCLUDED.
12. CONTRACTOR IS TO VERIFY UTILITY LINE LOCATIONS AND MAINTAIN THOSE THAT SERVE OTHER PARTS OF THE BUILDING THAT ARE NOT AFFECTED BY THE DEMOLITION.
13. ALL WORK WILL BE PERFORMED IN THE BEST WORKMANSHIP POSSIBLE IN ACCORDANCE WITH THAT TRADE'S BEST INDUSTRY STANDARDS.


NOTE: THERE HAS BEEN NO SOIL TESTING PROVIDED TO THIS OFFICE FOR THIS PROJECT. THE DESIGNING ARCHITECT OR STRUCTURAL ENGINEER ACCEPTS NO RESPONSIBILITY FOR EXISTING SOIL CONDITIONS. ANY SOIL BEARING CAPACITY OF THIS FOUNDATION SYSTEM IS DESIGNED BASED ON A 2 TON MINIMUM SOIL BEARING CAPACITY. IT SHALL BE THE CONTRACTORS OR OWNERS' RESPONSIBILITY TO DETERMINE SUITABLE SOIL CONDITIONS AND VERIFY THE BEARING PRESSURE. IF A SUITABLE SOIL THAT CAN WITHSTAND A 2 TON BEARING CAPACITY IS NOT AVAILABLE, THIS OFFICE SHOULD BE CONTACTED BY THE CONTRACTOR OR OWNER FOR A FOUNDATION REDESIGN.

**NOTE:ENERGY CODE COMPLIANCE**

THE CONTRACTOR IS RESPONSIBLE FOR PROVIDING STRETCH/ ENERGY CODE COMPLIANCE PRIOR TO CLOSING OF WALLS. THE PROPER ENERGY CONSULTANT, HEREIN RATER, OR OTHER ALLOWED PROFESSIONAL SHALL PERFORM THE FINAL INSPECTIONS ASSOCIATED WITH THE CONSTRUCTION REQUIREMENTS AT THE DIRECTION OF THE CONTRACTOR.

Location
PROPOSED RENOVATION & SEMI-ATTACHED ADDITION
6-8 NEAREN ROW, CHARLESTOWN, MA 02129
Choo & Company, Inc.
One Billings Road Quincy, MA 02171
617-786-7727 fax 617-786-7715
No. Description Date
Project No: 2023112
Scale: AS NOTED
Date: 09-06-2023
Drawn By: AMF
Drawing Name
REMOVALS & PROJECT NOTES
Sheet No.
A-0.02

PLANTING SCHEDULE		
SYMBOL	QUANTITY	NAME
	---	RHODODENDRON, 5 GAL. POT
	---	OAK LEAF HYDRANGEA, 5 GAL. POT
	---	HOLLY, 5 GALLON (GAL.) POT
	---	SARGENT CRABAPPLE TREE MIN. 3" CALIPER & 12 TALL

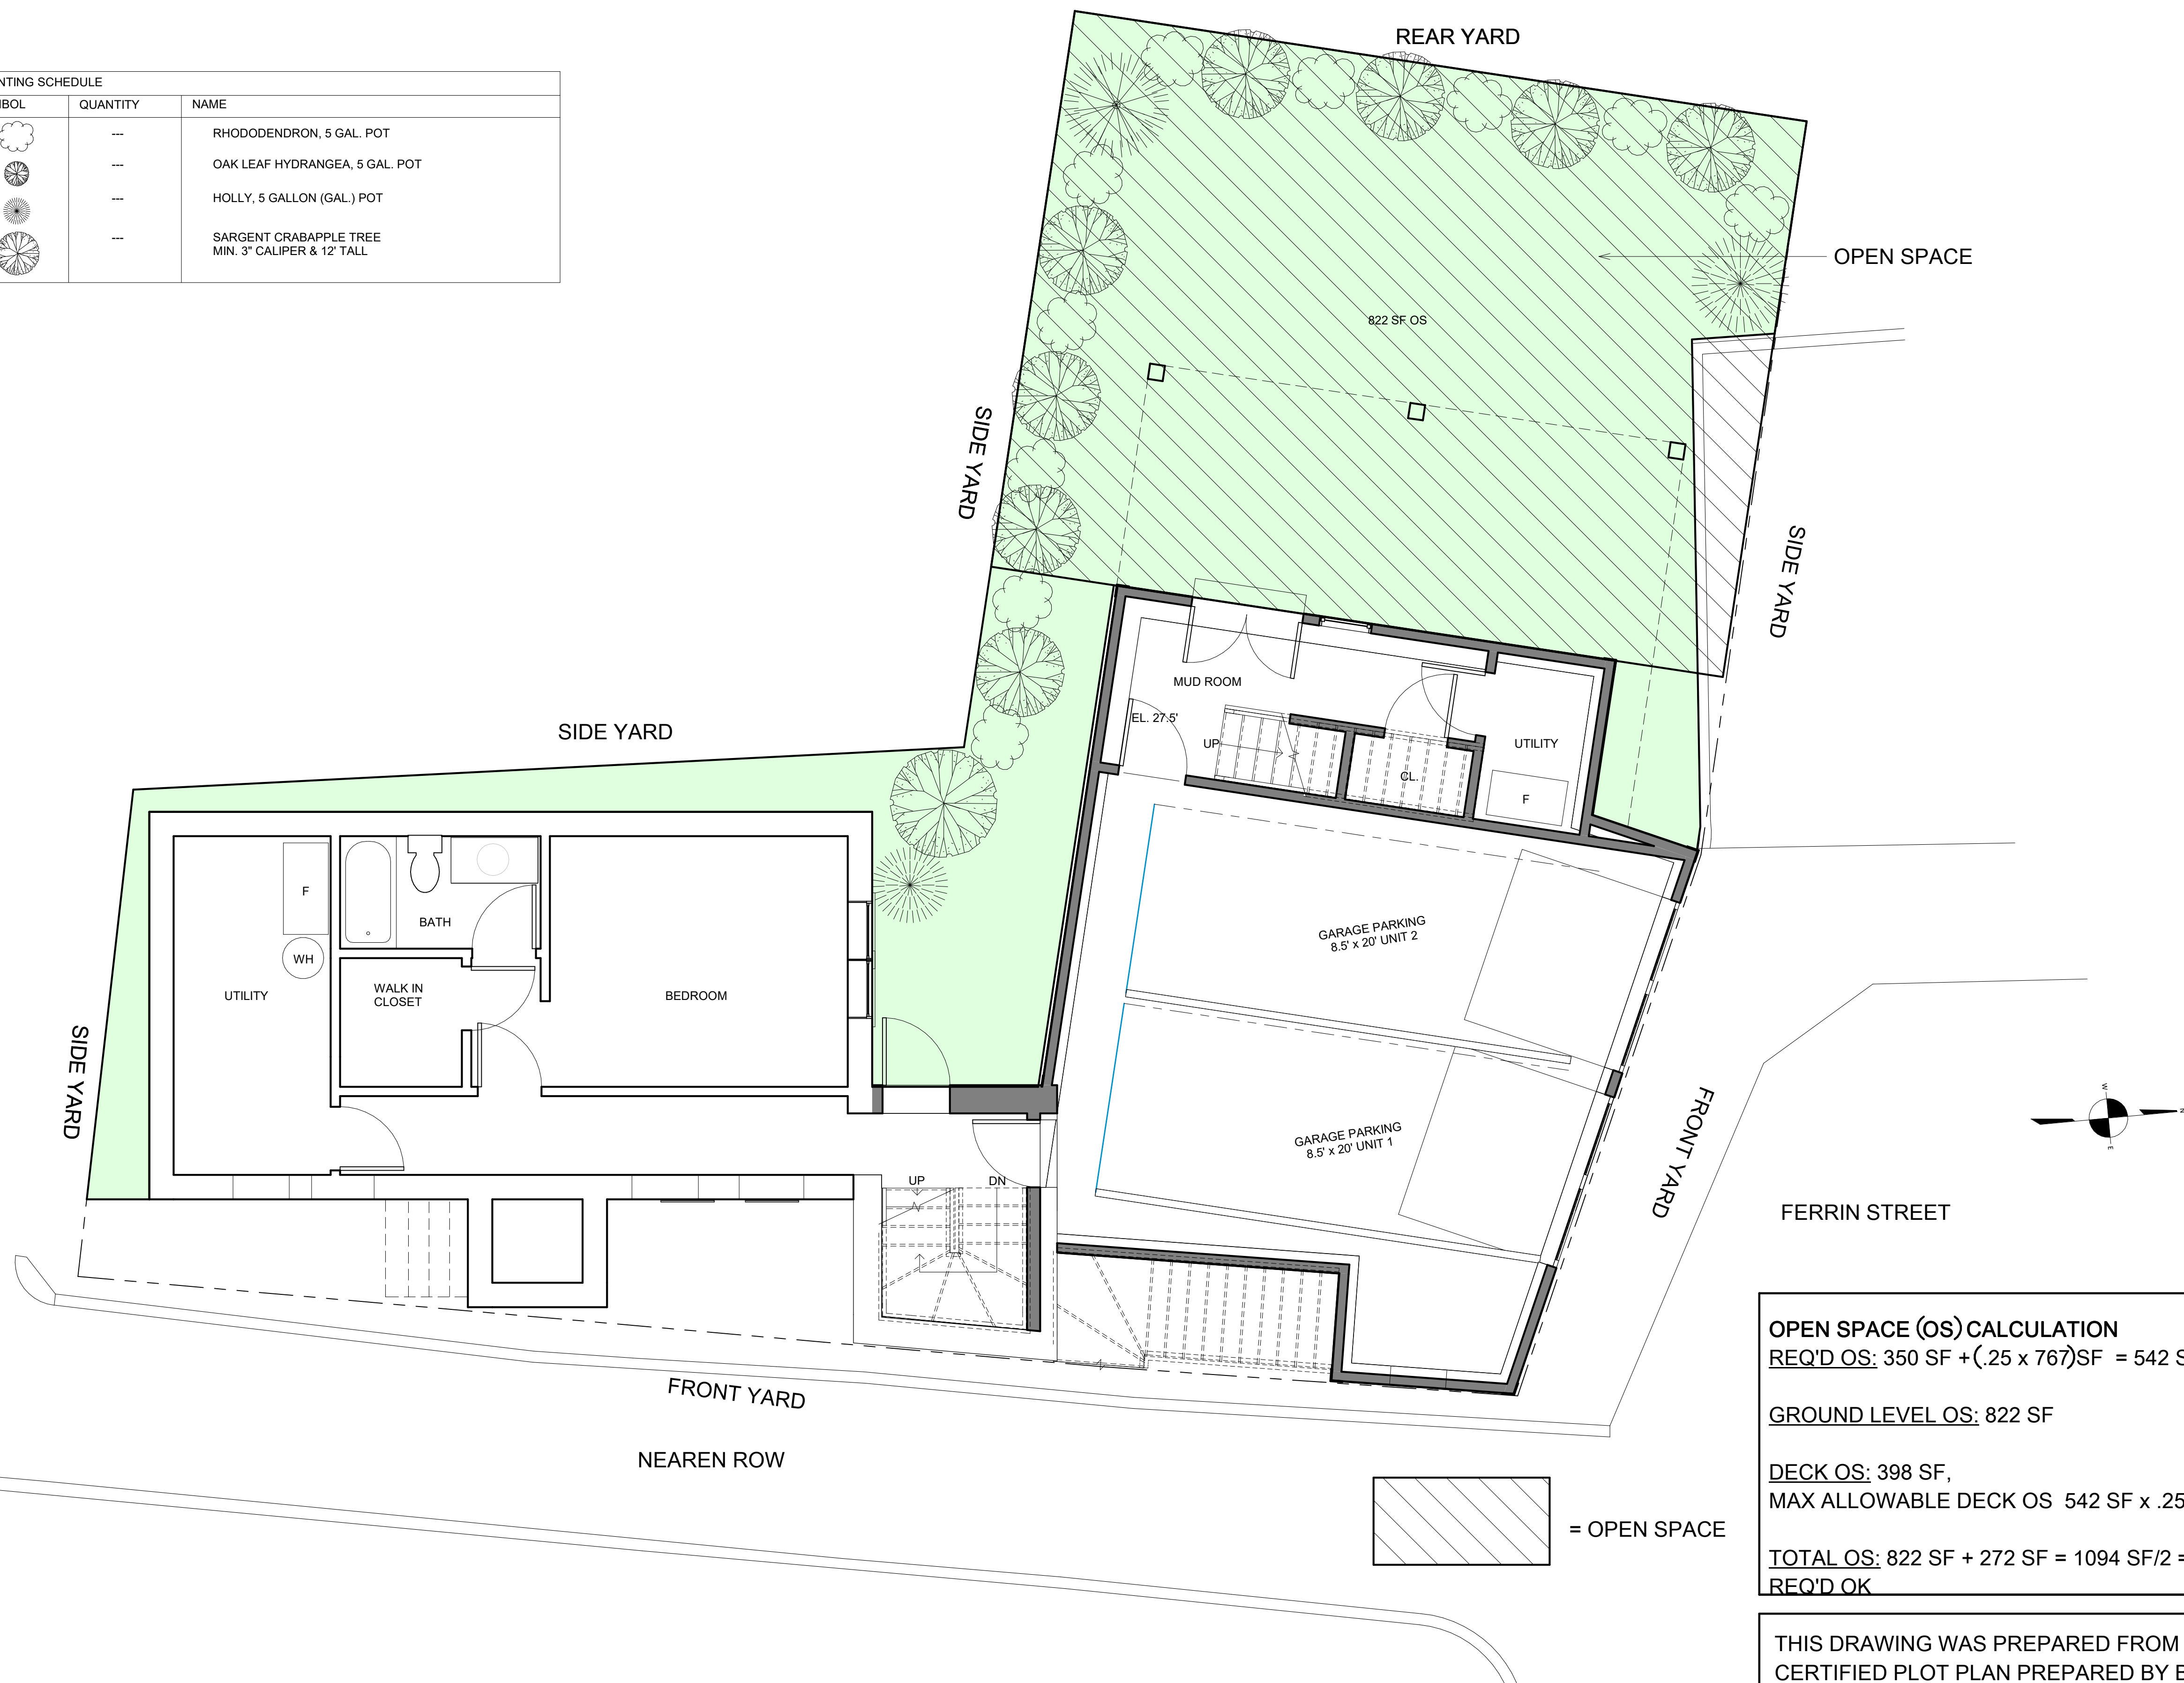

**OPEN SPACE (OS) CALCULATION**  
 REQ'D OS:  $350 \text{ SF} + (.25 \times 767) \text{ SF} = 542 \text{ SF} / \text{UNIT}$   
**GROUND LEVEL OS:** 822 SF  
**DECK OS:** 398 SF,  
 MAX ALLOWABLE DECK OS  $542 \text{ SF} \times .25 = 136 \text{ SF/UNIT}$   
**TOTAL OS:**  $822 \text{ SF} + 272 \text{ SF} = 1094 \text{ SF}/2 = 547 \text{ SF} > 542 \text{ SF}$   
 REQ'D OK

THIS DRAWING WAS PREPARED FROM AN UNDERLAY  
 CERTIFIED PLOT PLAN PREPARED BY BOSTON SURVEY,  
 INC., UNIT C-4 SHIPWAY PLACE,  
 CHARLESTOWN, MA 02129.  
 PROJECT NUMBER 23-00360  
 DATED 08-25-23

1 ARCHITECTURAL SITE PLAN -  
 1/4" = 1'-0"

Location

**PROPOSED RENOVATION &  
 SEMI-ATTACHED ADDITION  
 6-8 NEAREN ROW,  
 CHARLESTOWN, MA 02129**


**Choo  
 & Company, Inc.**  
 One Billings Road Quincy, MA 02171  
 617-786-7727 fax 617-786-7715

No.	Description	Date


Project No: 2023112  
 Scale: As indicated  
 Date: 09-06-2023  
 Drawn By: TN / DF

Drawing Name  
**ARCHITECTURAL  
 SITE PLAN**


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**A-0.03**

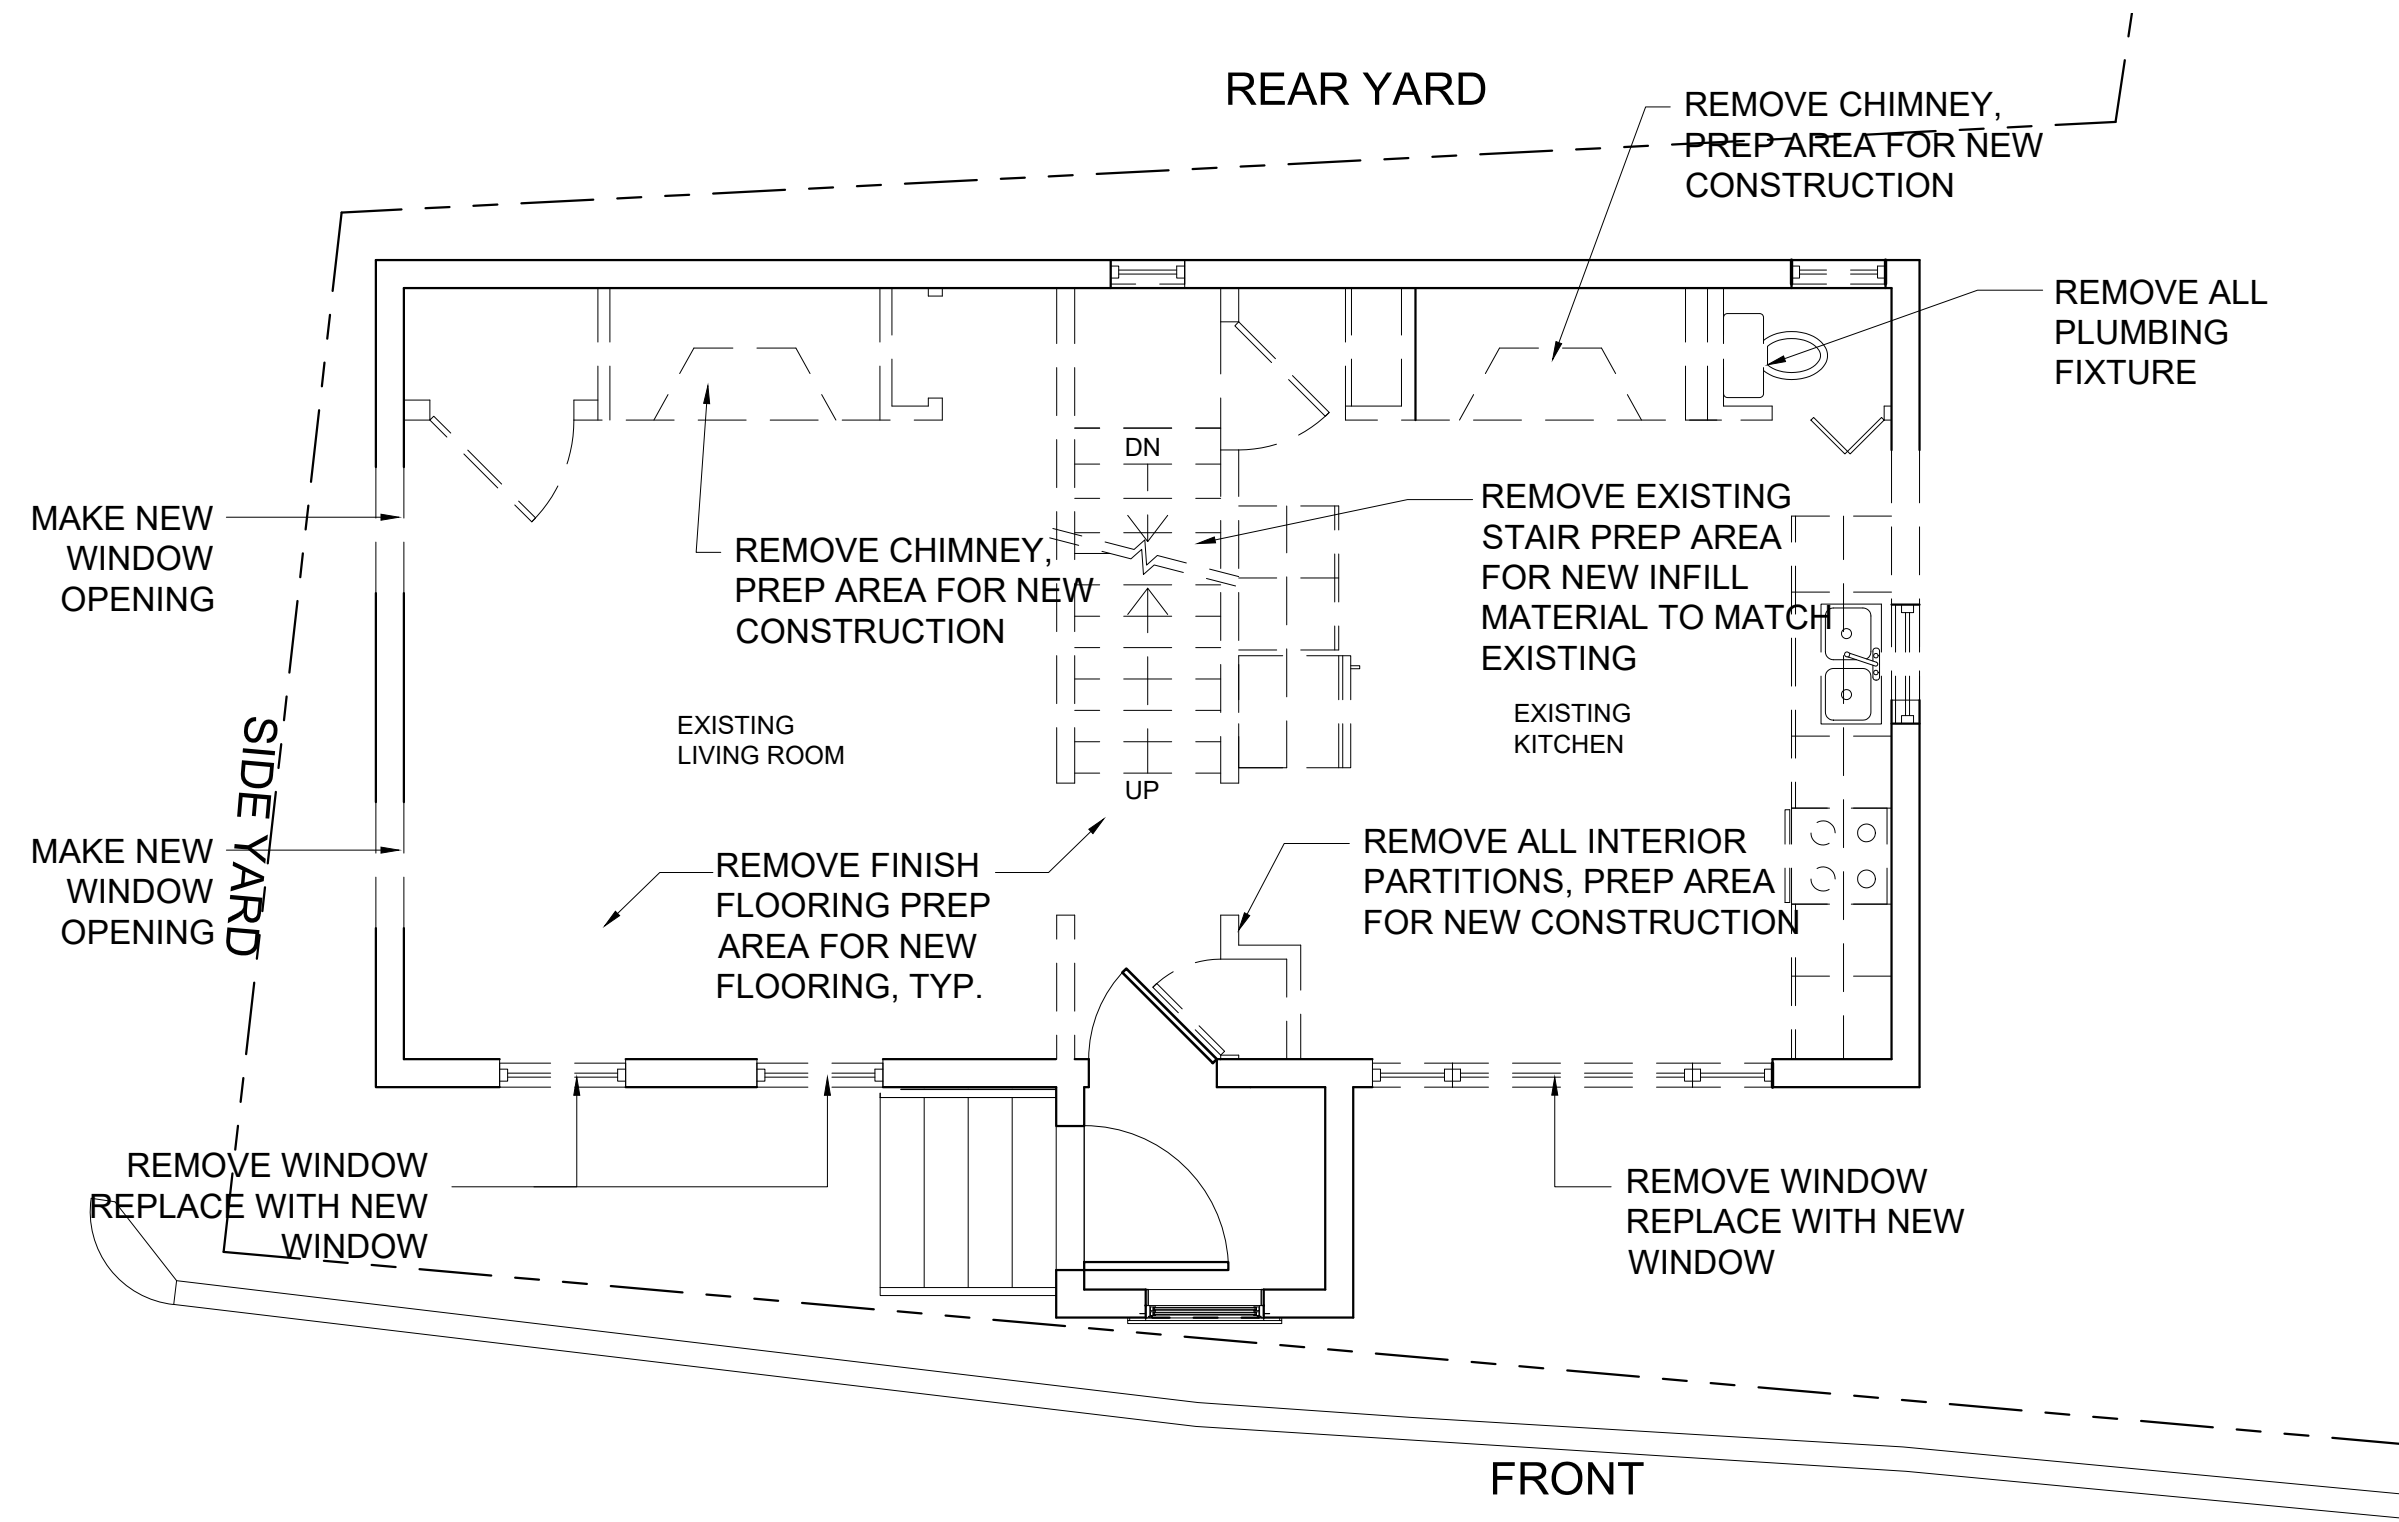


1 EXISTING FIRST FLOOR PLAN  
1/4" = 1'-0"

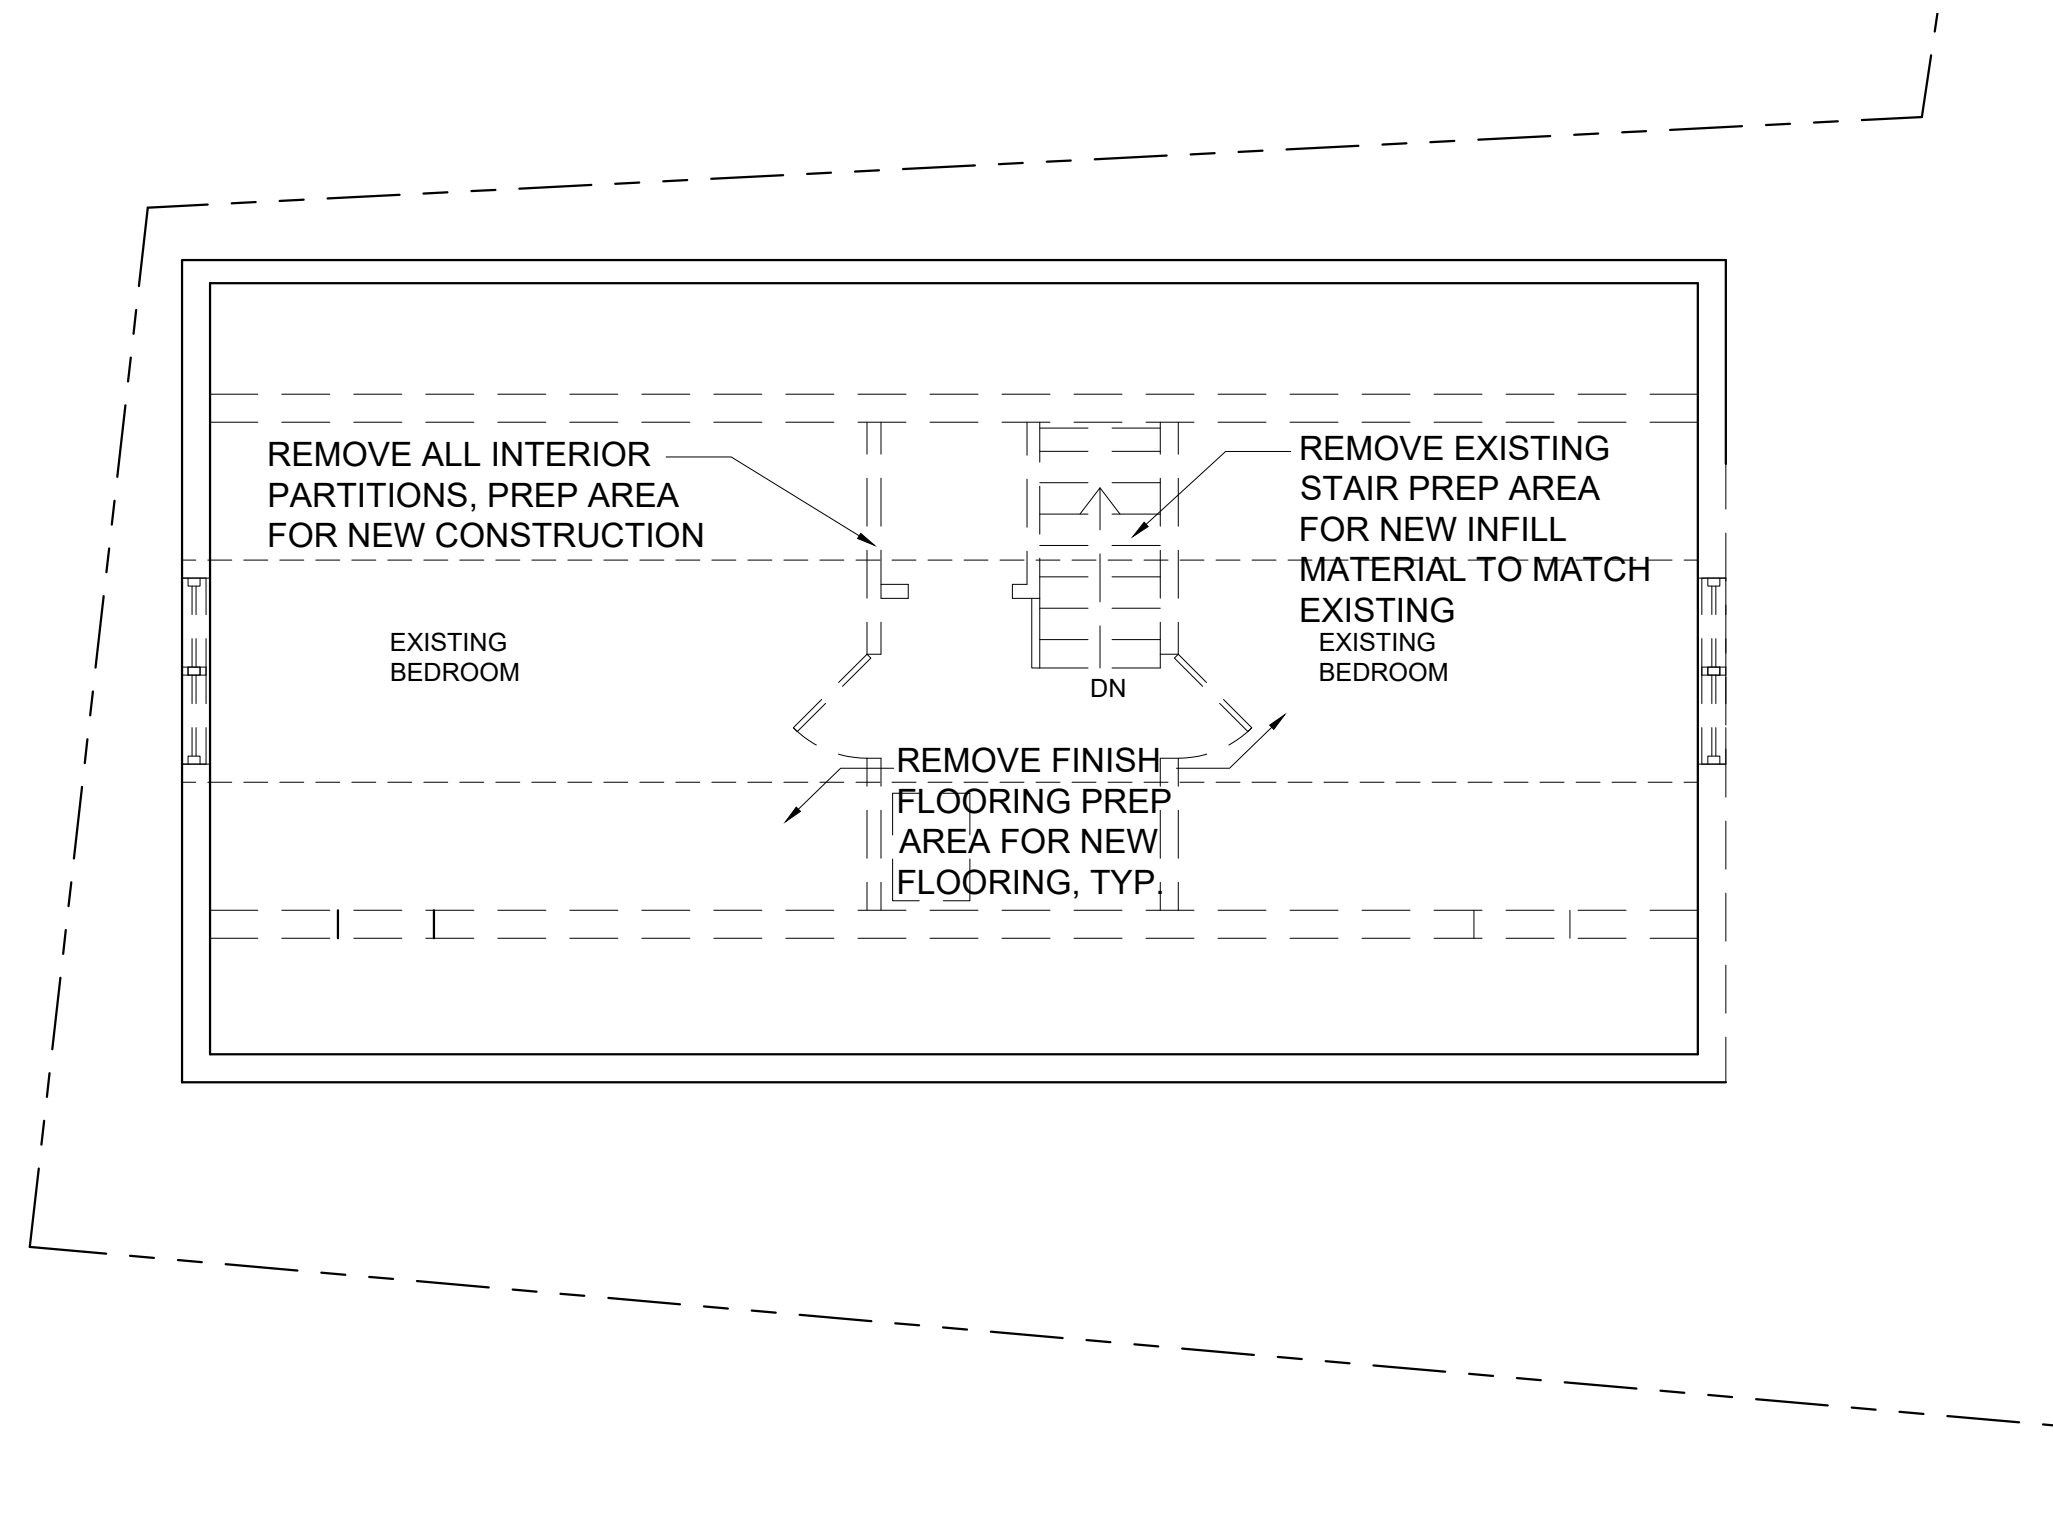

3 EXISTING THIRD FLOOR PLAN  
1/4" = 1'-0"

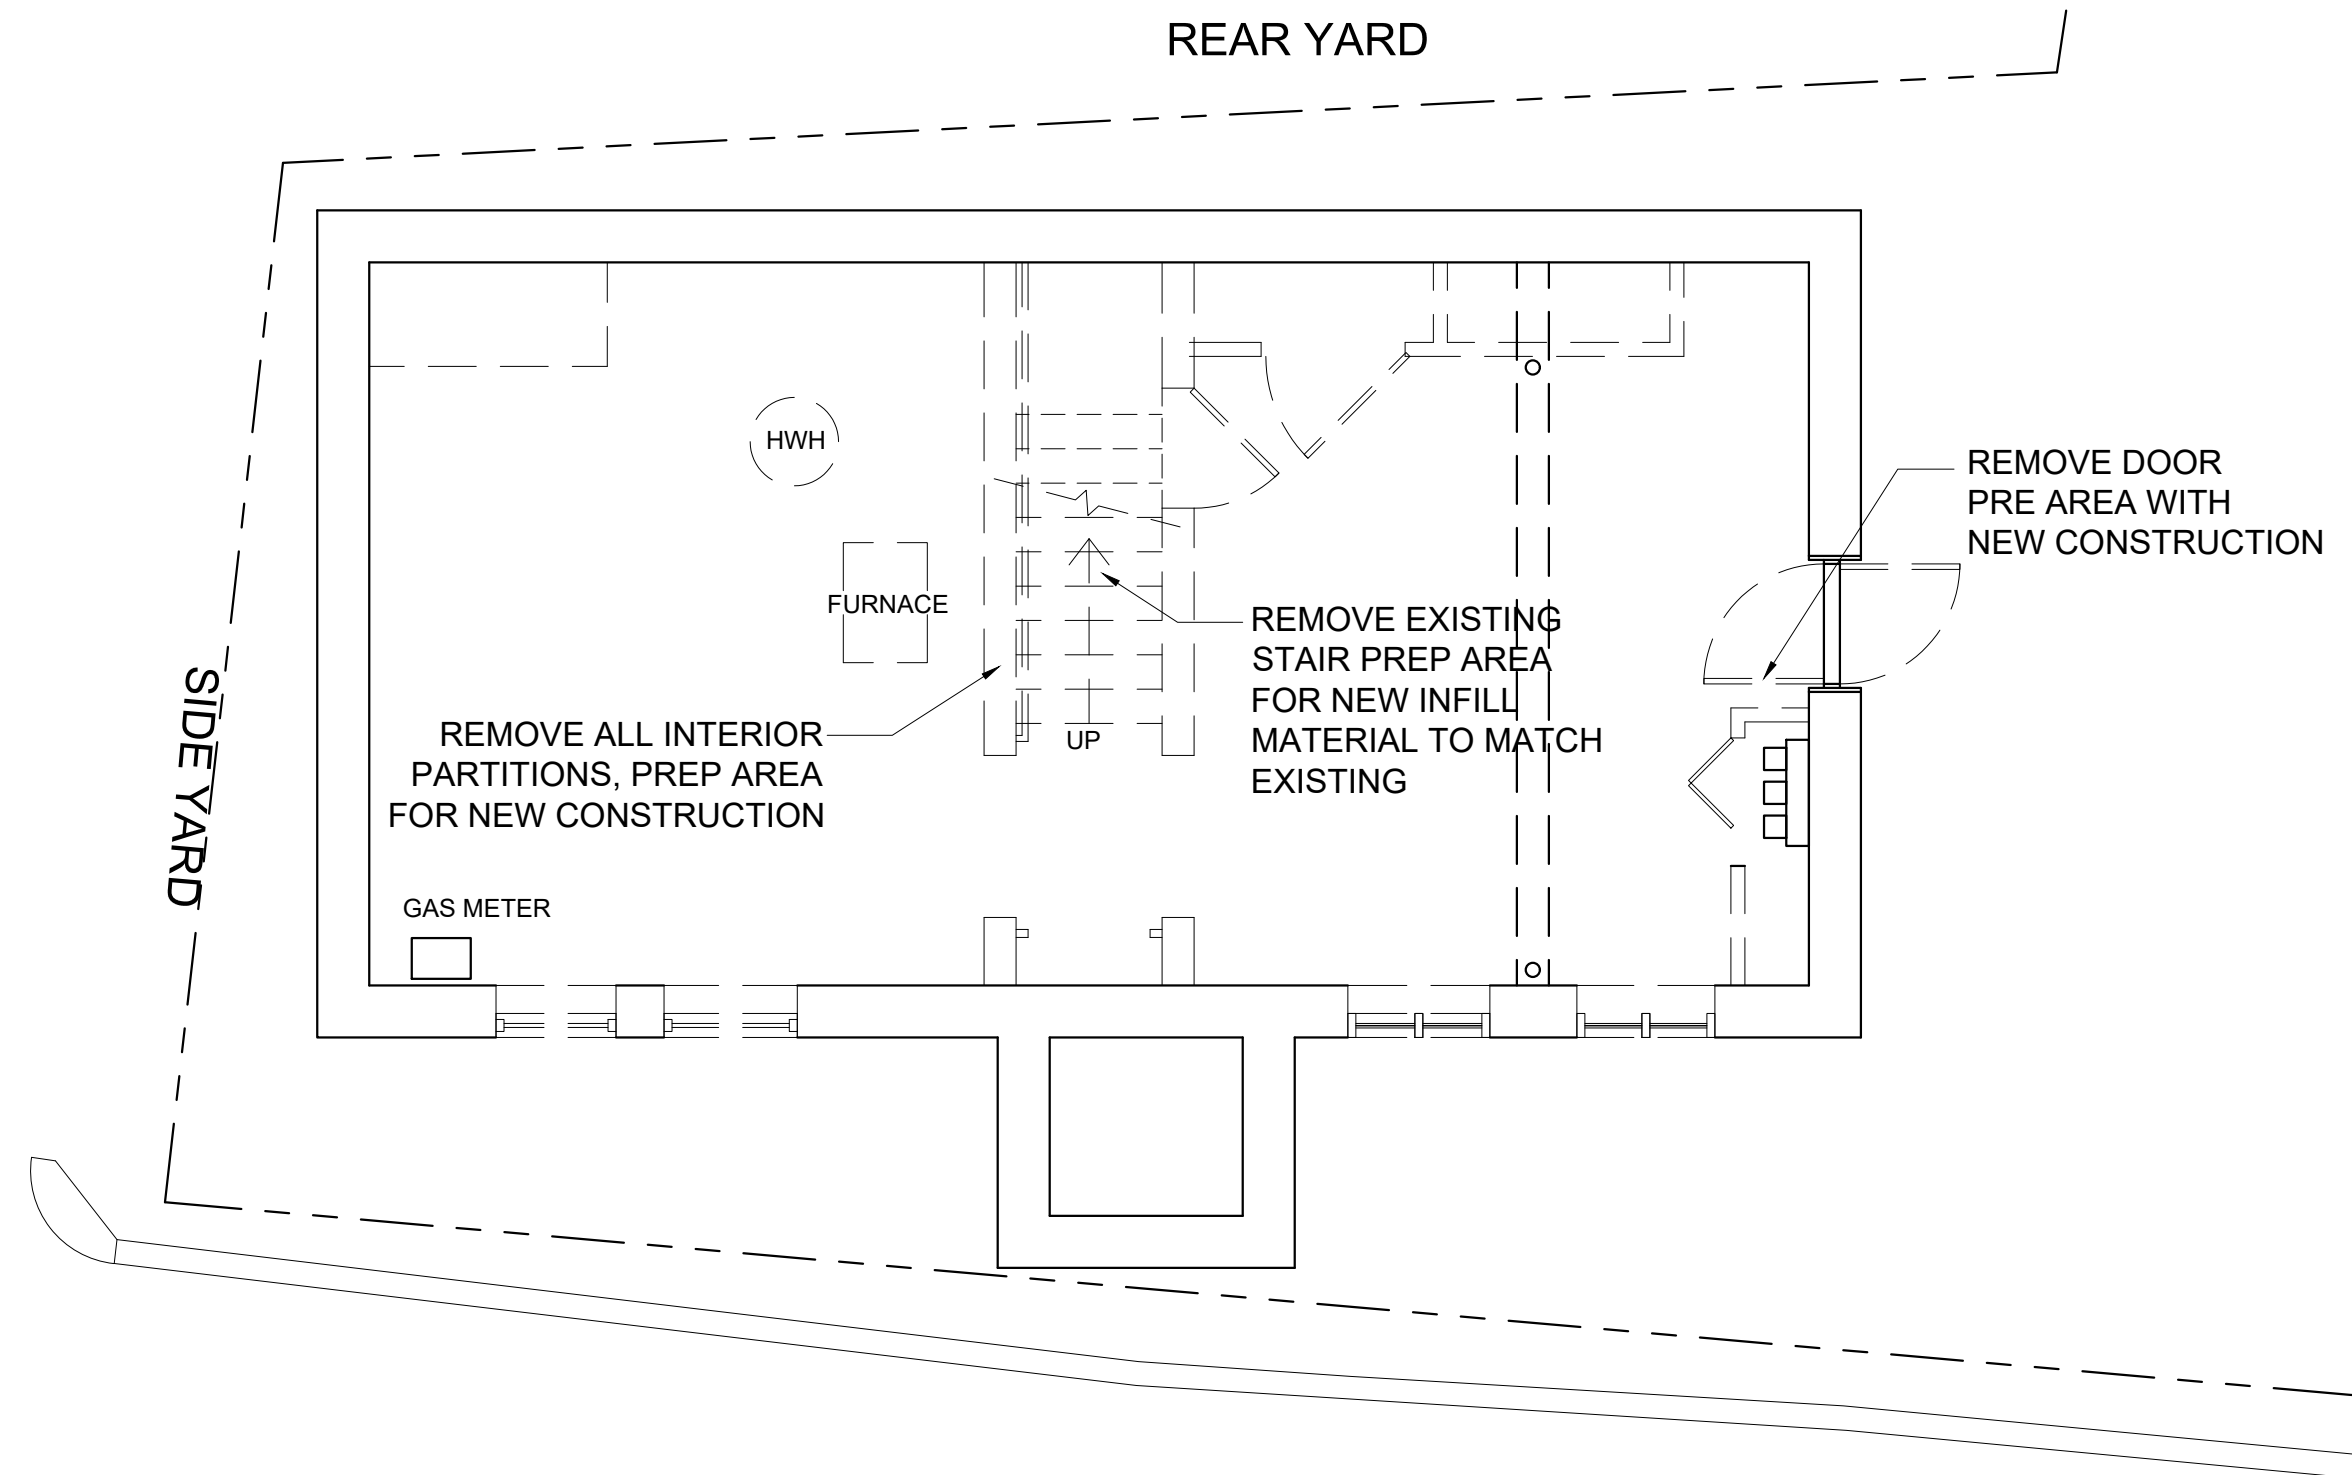

0 EXISTING BASEMENT FLOOR PLAN  
1/4" = 1'-0"

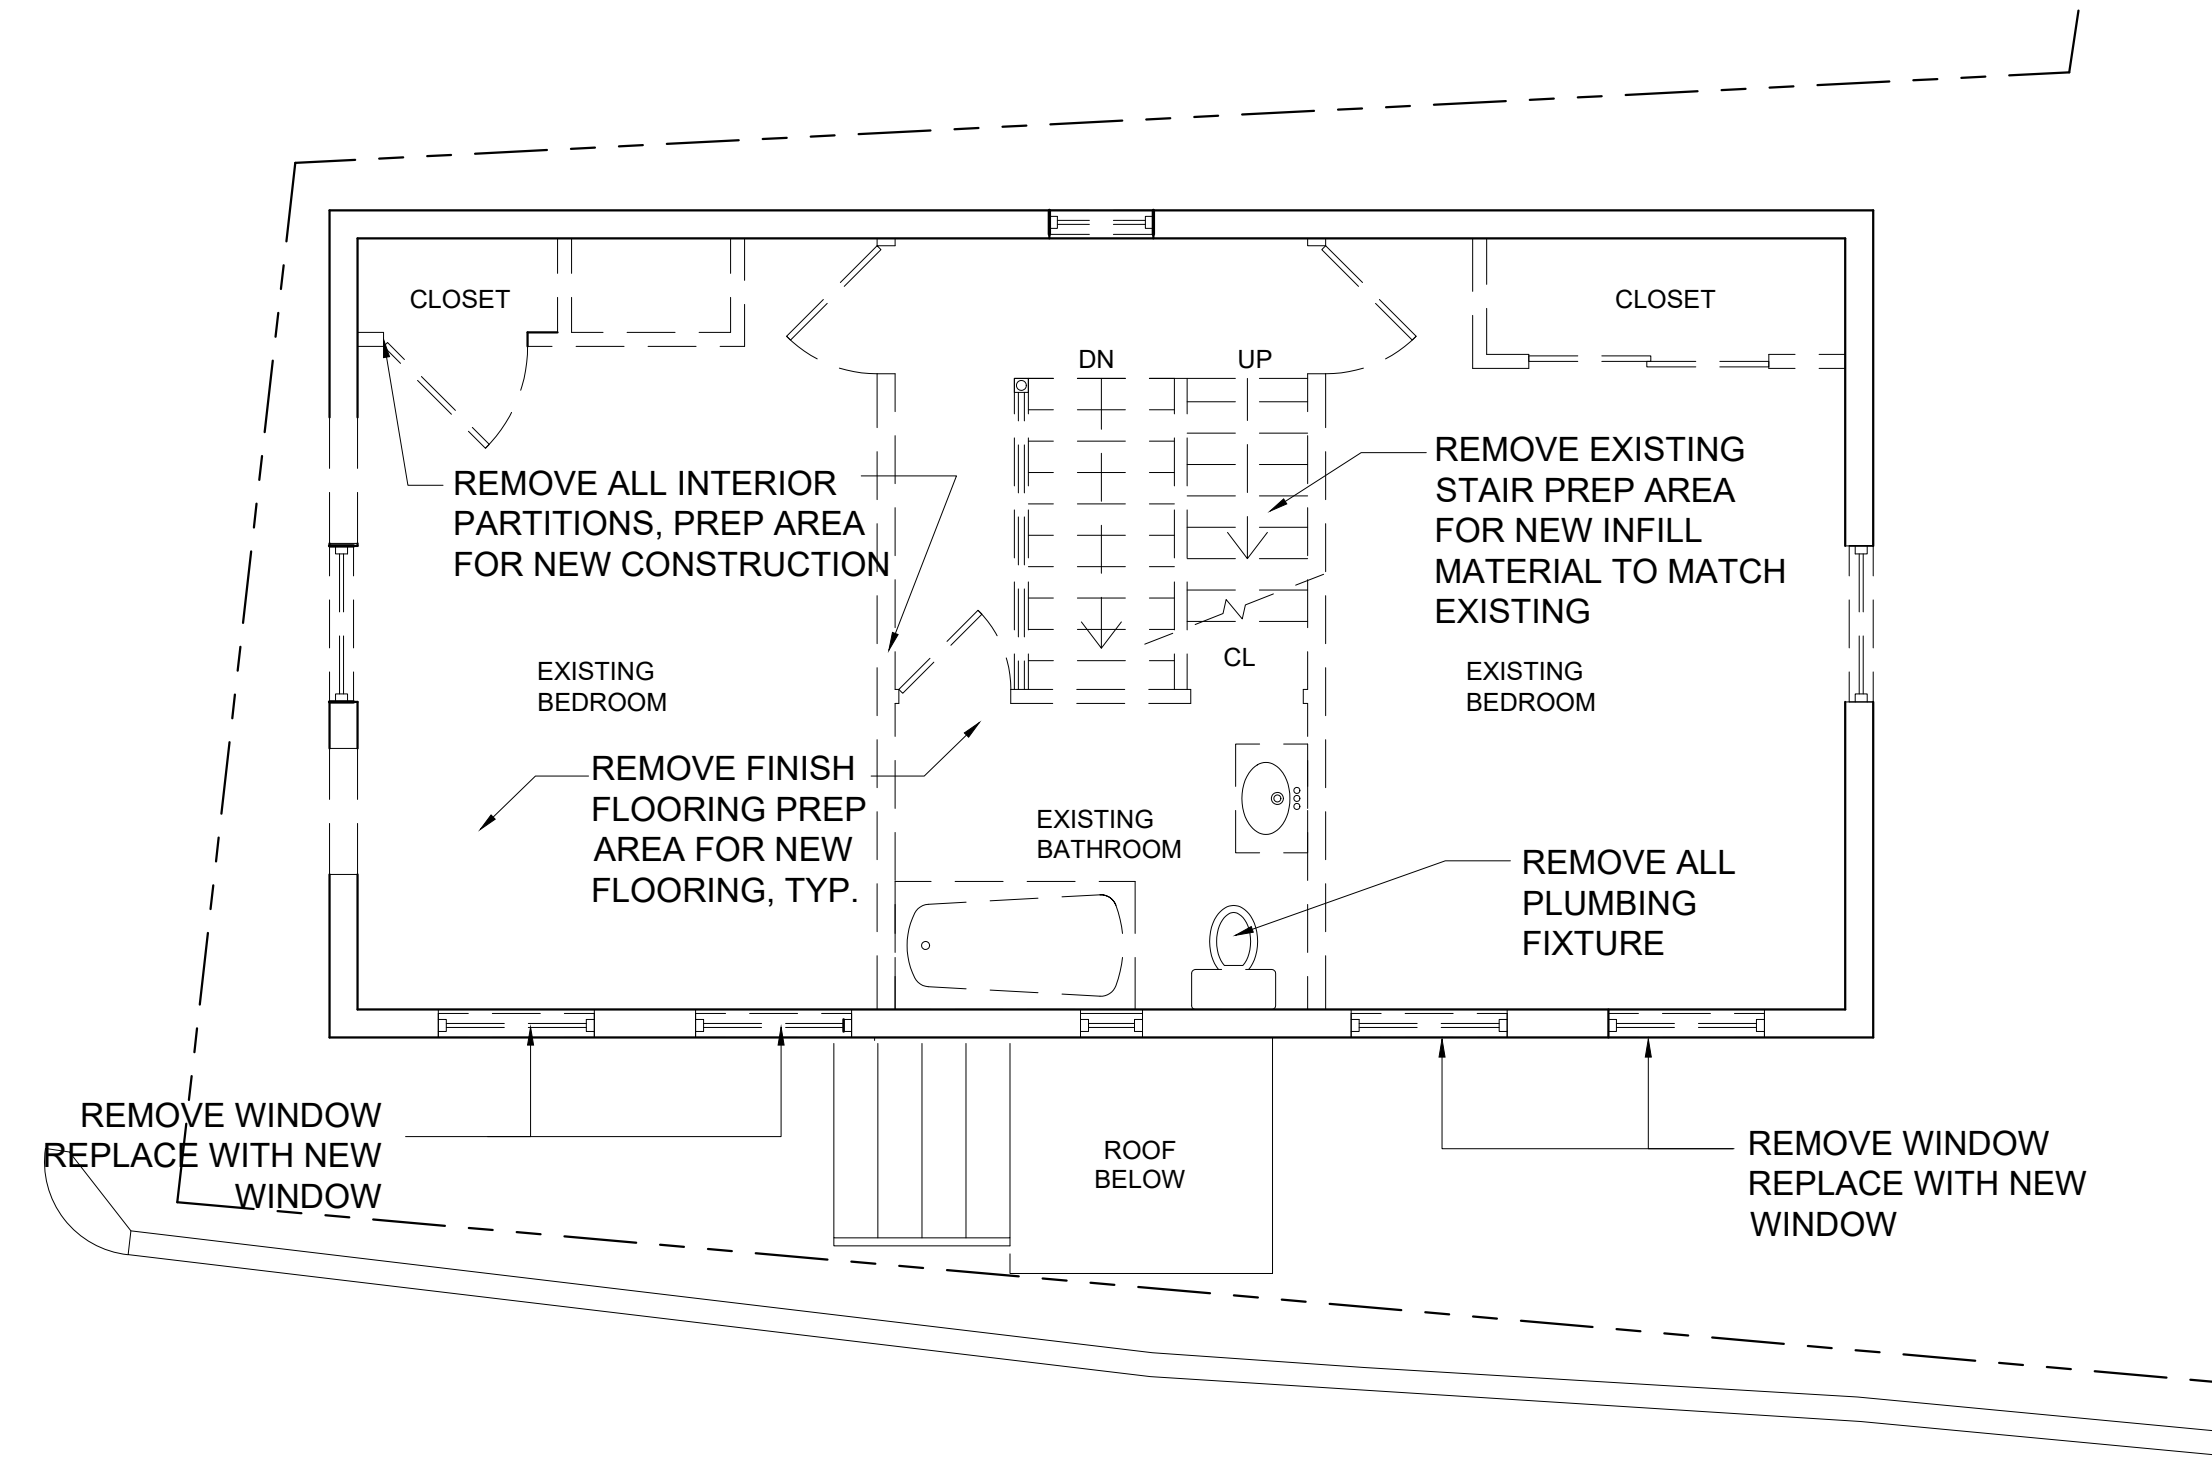

2 EXISTING SECOND FLOOR PLAN  
1/4" = 1'-0"

- DEMO NOTE:
1. PRIOR TO COMMENCEMENT OF WORK OR FABRICATION OF NEW COMPONENTS, CONTRACTORS SHALL INVESTIGATE AND VERIFY IN THE FIELD ALL CONDITIONS, DIMENSIONS AND ELEVATIONS OF THE EXISTING CONSTRUCTION
  2. REMOVAL OF ALL DEBRI FROM THE SITE SHALL BE DISPOSED OF LEGALLY AND IN ACCORDANCE WITH APPLICABLE CODES.
  3. BRACE AND MAINTAIN AS REQUIRED TO MAINTAIN AND PRESERVE EXISTING WALL INTEGRITY IN ITS ORIGINAL CONDITIONS DURING CONSTRUCTION
  4. PROPERLY BRACE ALL WALLS AS NECESSARY UNTIL ROOF FRAMING IS COMPLETE, AND NEW CONSTRUCTION DETAILS SUPPORT TOPS OF WALLS Laterally

Location

**PROPOSED RENOVATION & SEMI-ATTACHED ADDITION**  
**6-8 NEAREN ROW,**  
**CHARLESTOWN, MA 02129**

**Choo & Company, Inc.**

One Billings Road Quincy, MA 02171  
 617-786-7727 fax 617-786-7715

No.	Description	Date


Project No: 2023112  
 Scale: AS NOTED  
 Date: 09-06-2023  
 Drawn By: AMF

Drawing Name

**EXISTING/DEMO CONDITIONS FLOOR PLANS**


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**E-0.01**

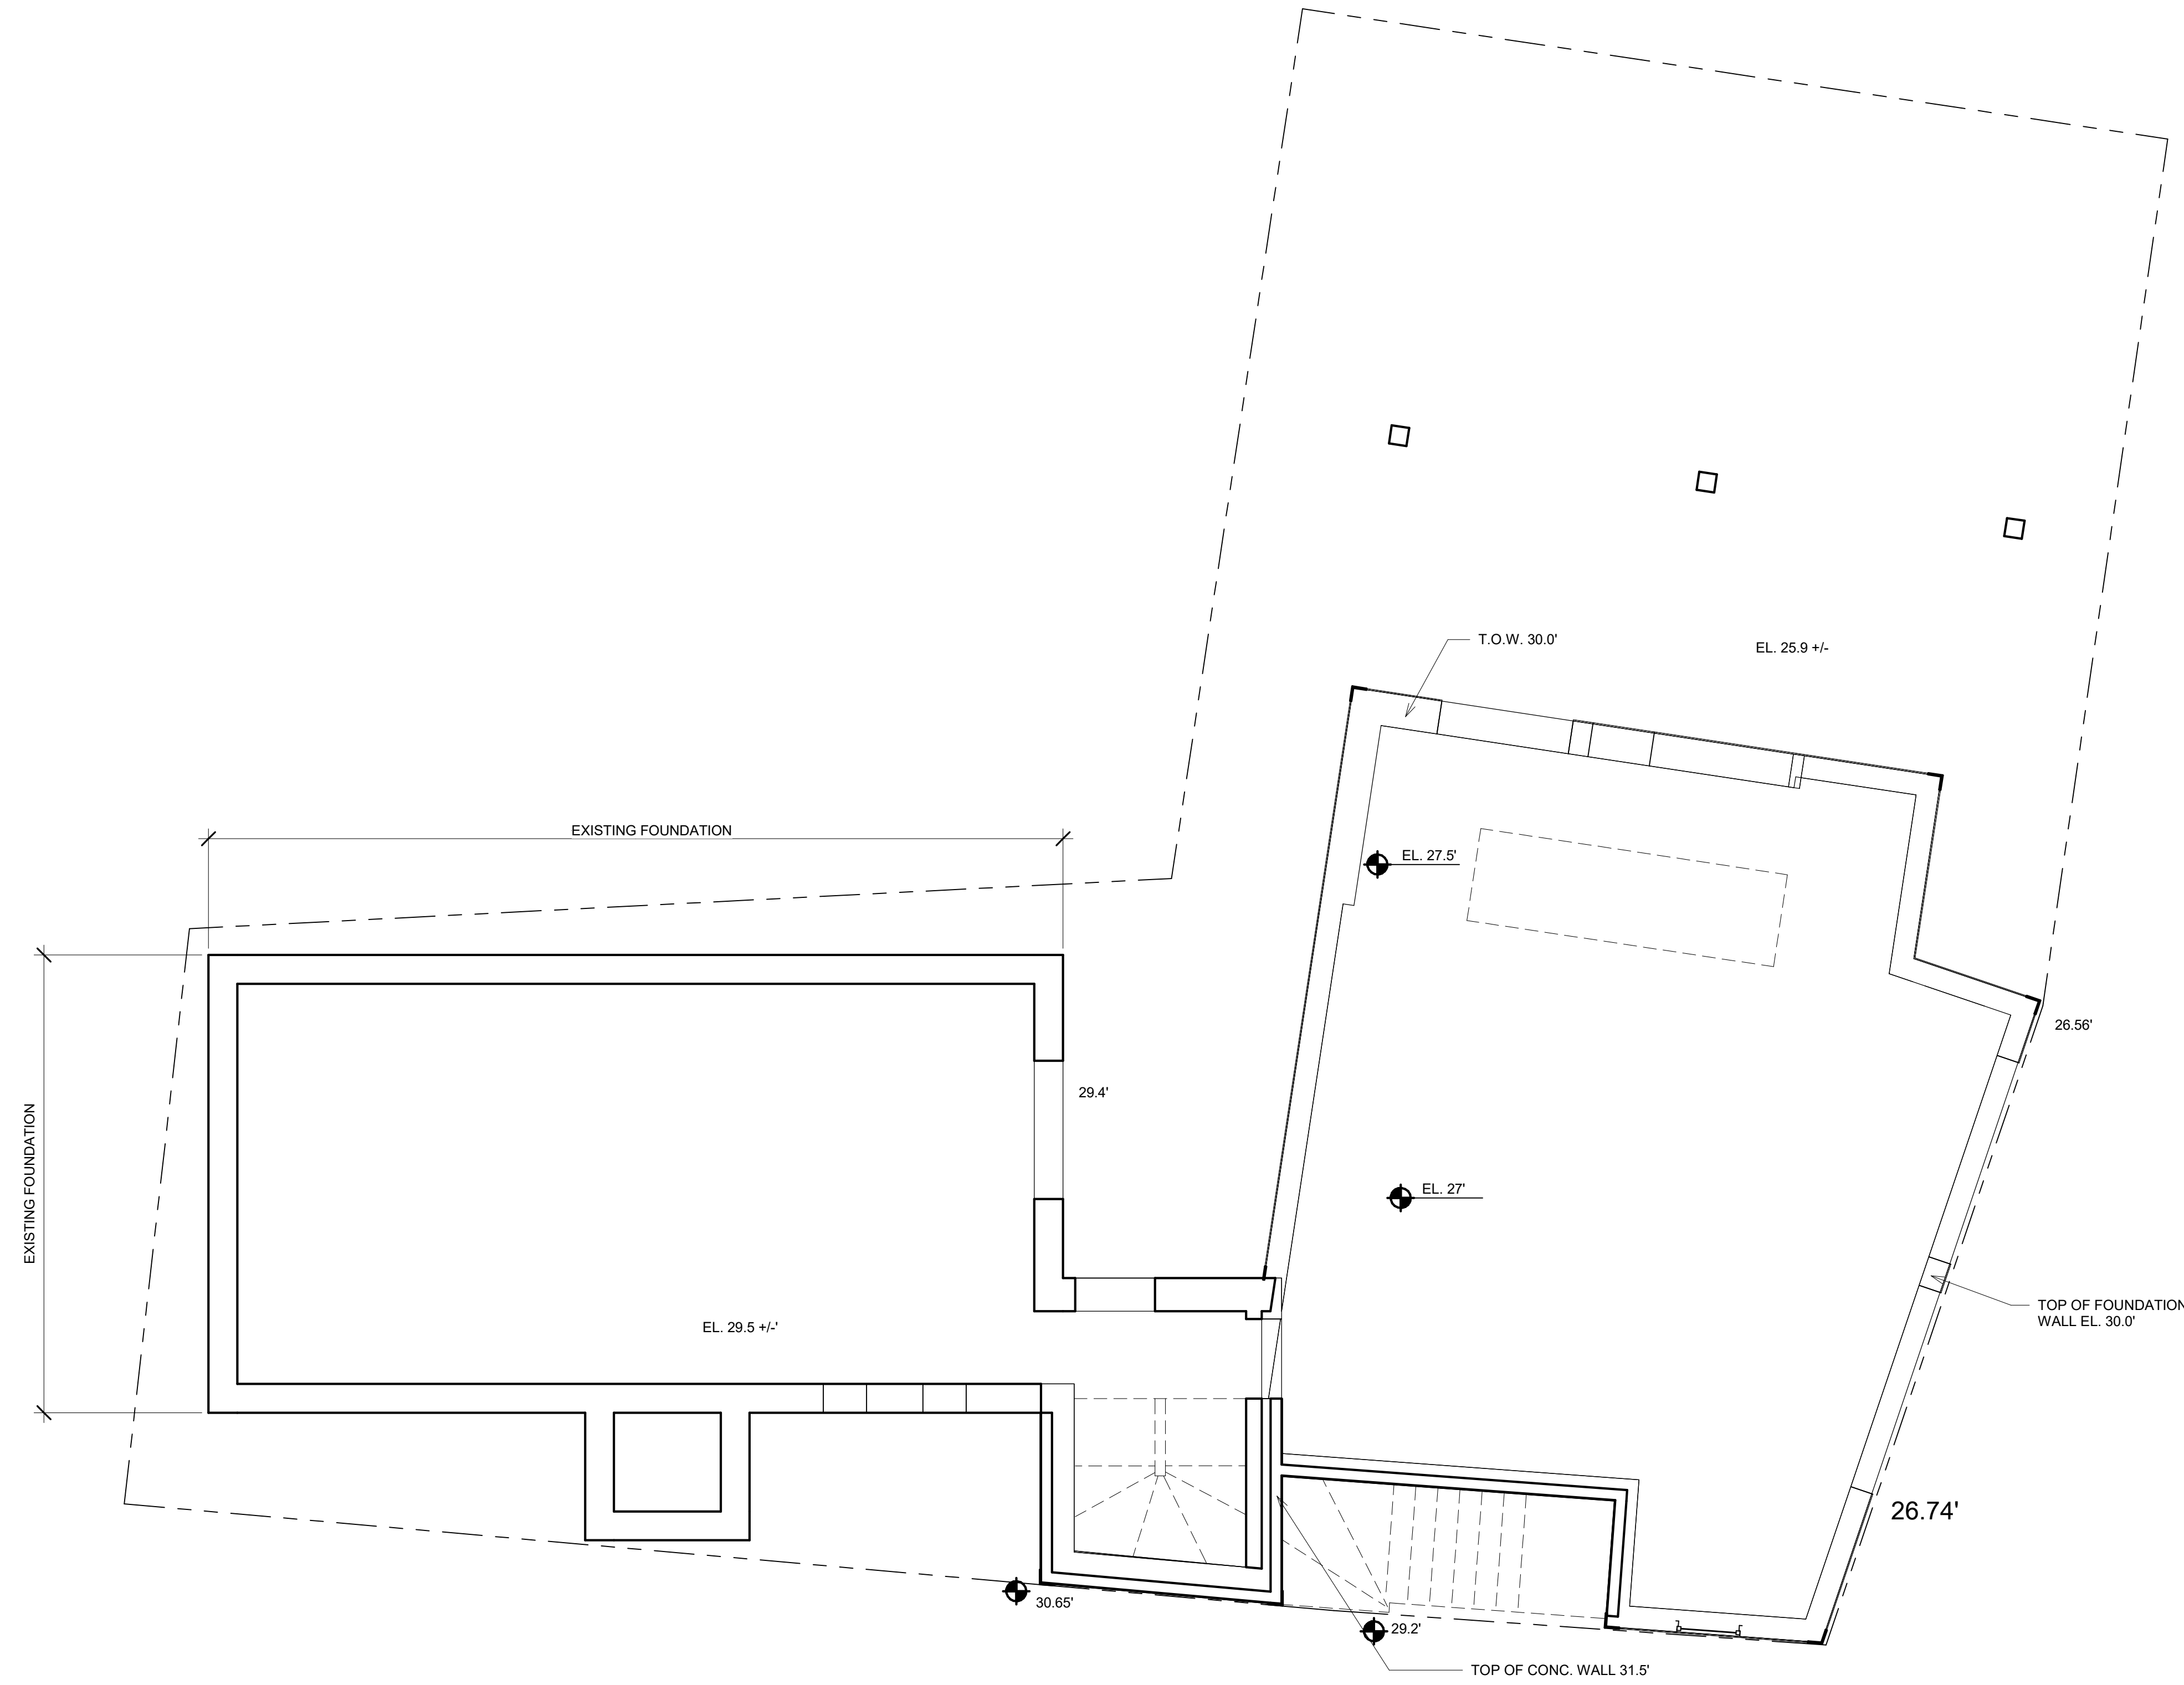

Location

**PROPOSED RENOVATION &  
SEMI-ATTACHED ADDITION  
6-8 NEAREN ROW,  
CHARLESTOWN, MA 02129**

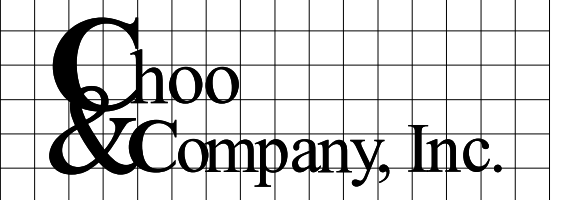

One Billings Road Quincy, MA 02171  
617-786-7727 fax 617-786-7715

No.	Description	Date

Project No: 2023112  
Scale: 1/4" = 1'-0"  
Date: 09-06-2023  
Drawn By: TN / DF

Drawing Name  
**PROPOSED  
FOUNDATION  
PLAN**

Sheet No.  
**A-1.00**










Location

**PROPOSED RENOVATION &  
SEMI-ATTACHED ADDITION  
6-8 NEAREN ROW,  
CHARLESTOWN, MA 02129**

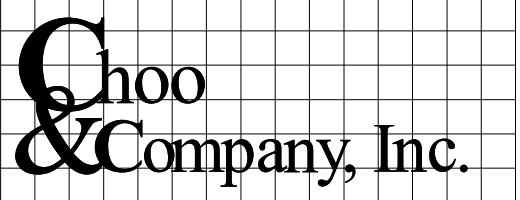


One Billings Road Quincy, MA 02171  
617-786-7727 fax 617-786-7715

No.	Description	Date
2	Revision 2	10-19-2023


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Scale: 1/4" = 1'-0"  
Date: 09-06-2023  
Drawn By: TN / DF

**PROPOSED  
THIRD FLOOR  
LEVEL**

Sheet No.  
**A-1.13**

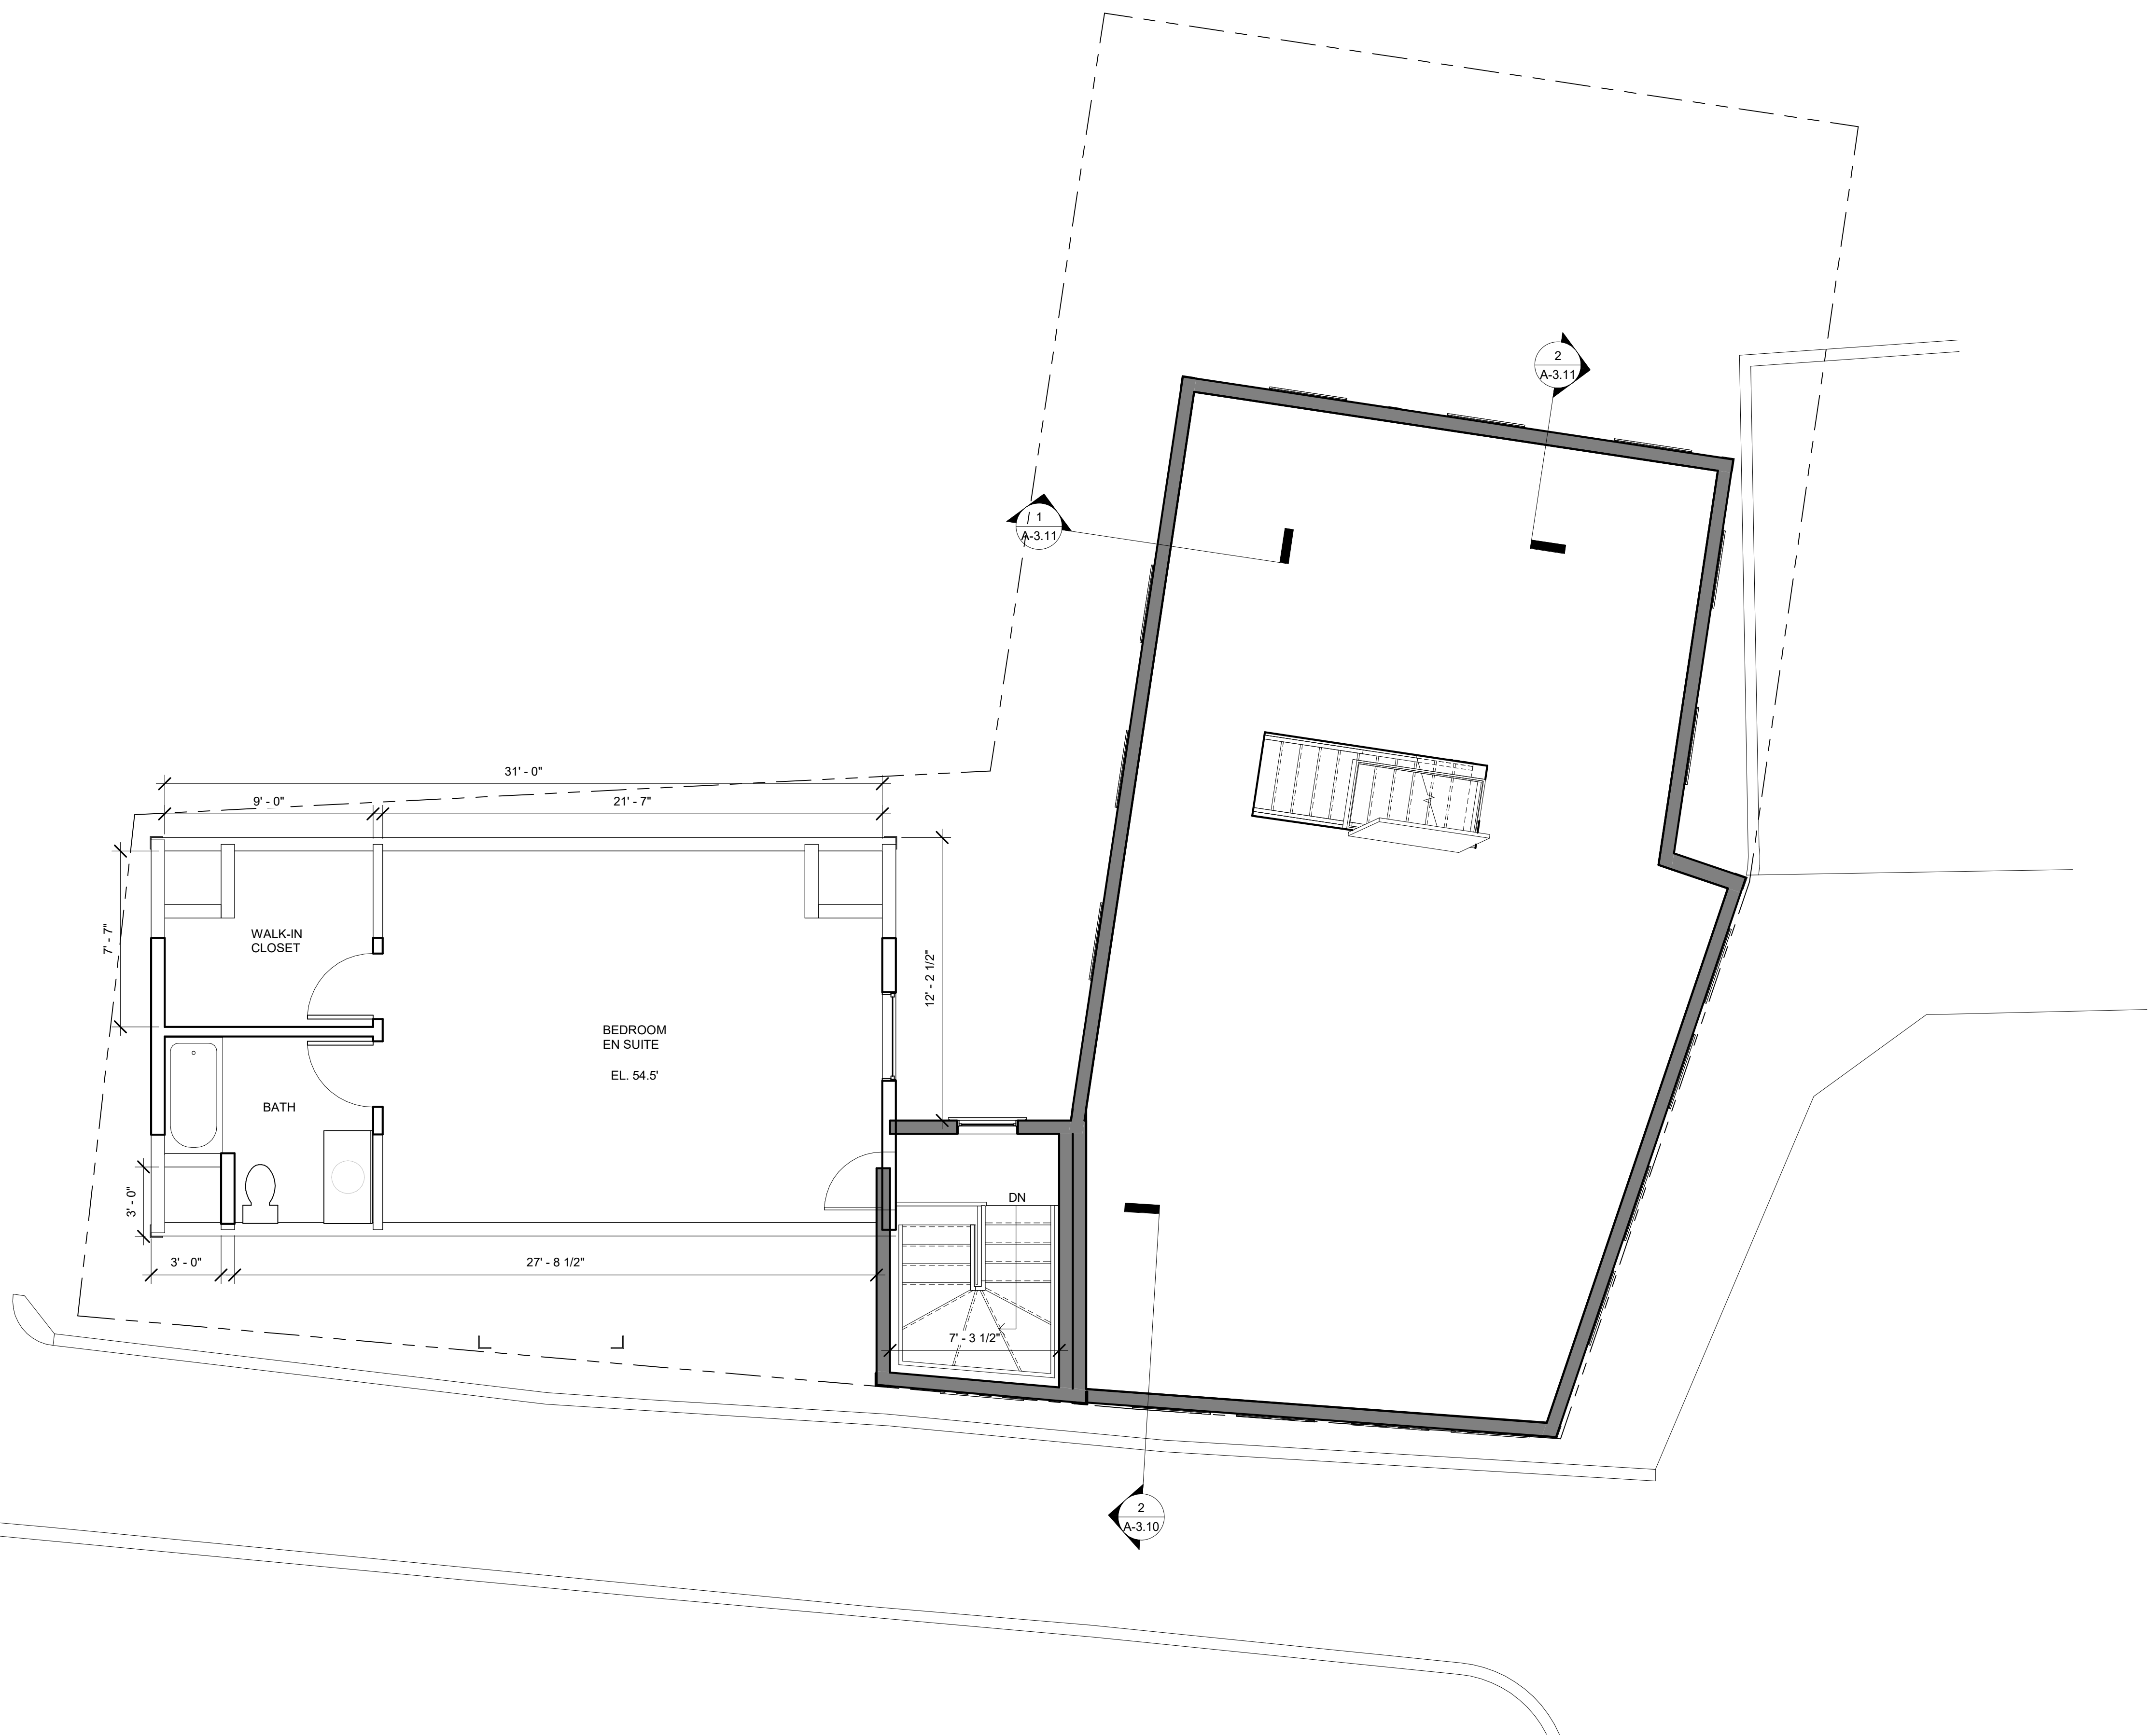




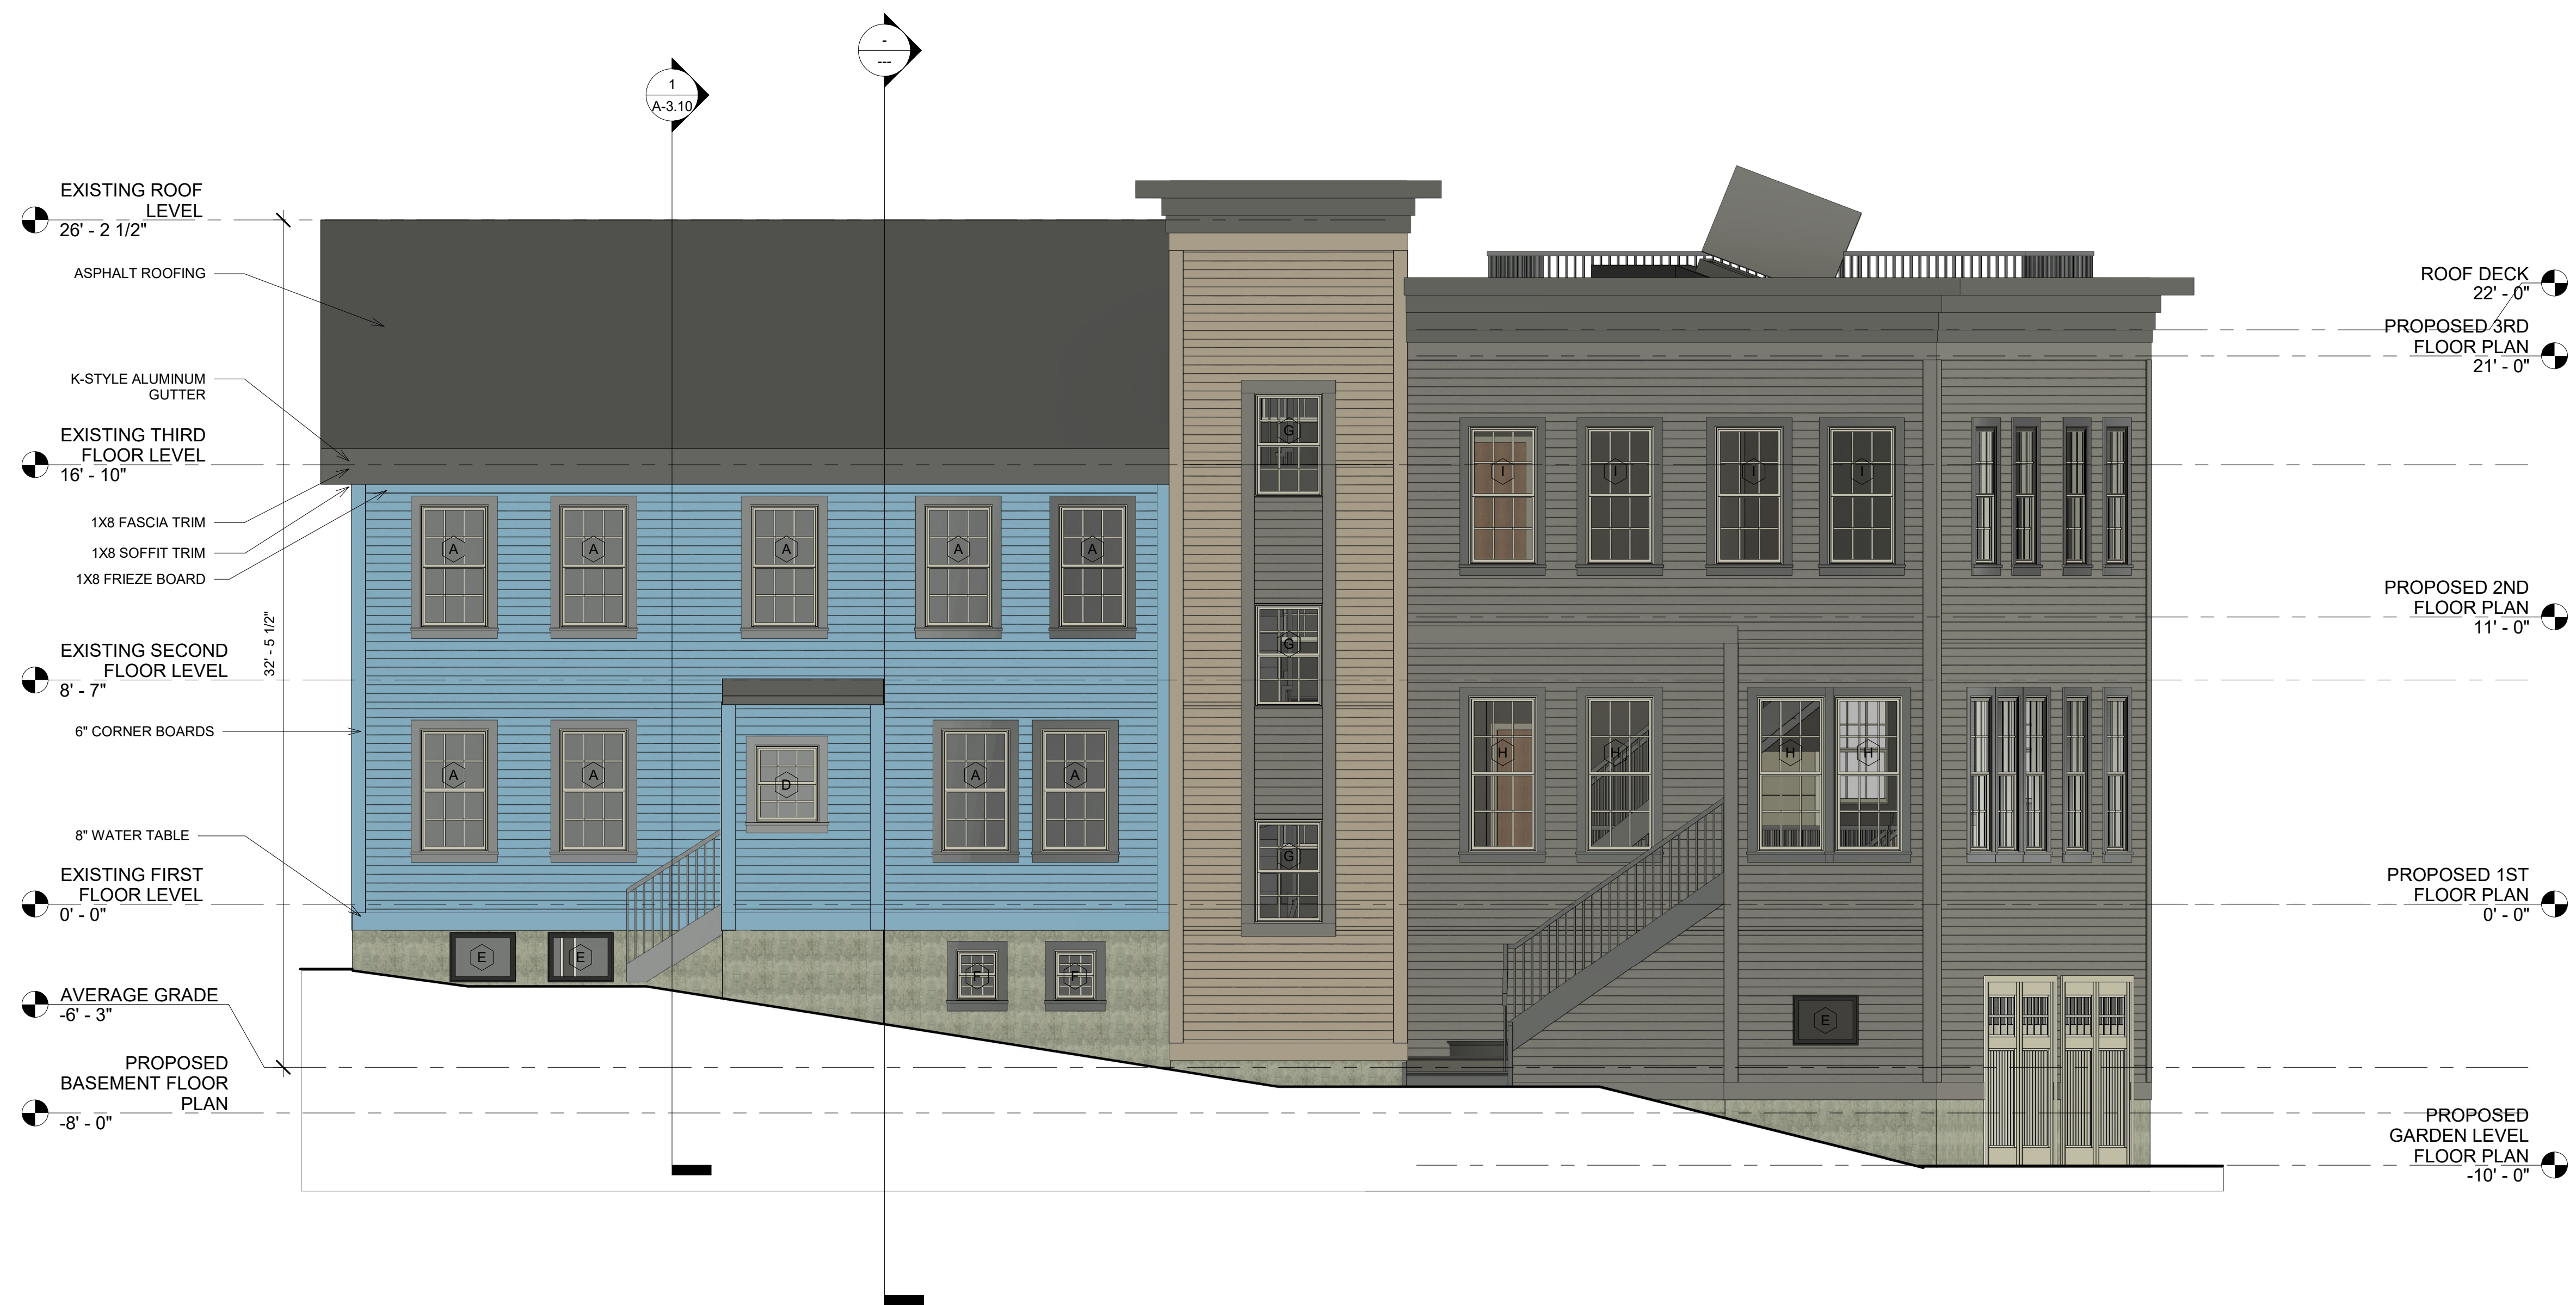

Location

**PROPOSED RENOVATION &  
SEMI-ATTACHED ADDITION  
6-8 NEAREN ROW,  
CHARLESTOWN, MA 02129**

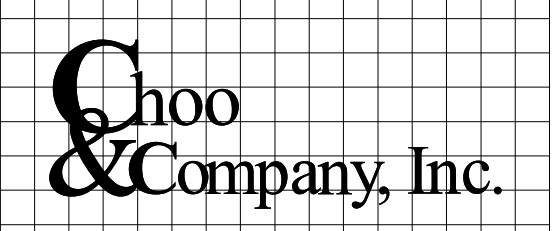

One Billings Road Quincy, MA 02171  
617-786-7727 fax 617-786-7715

No.	Description	Date
2	Revision 2	10-19-2023


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Scale: 1/4" = 1'-0"  
Date: 09-06-2023  
Drawn By: TN / DF

Drawing Name  
**PROPOSED  
ELEVATION**

Sheet No.  
**A-2.10**

Location

**PROPOSED RENOVATION &  
SEMI-ATTACHED ADDITION  
6-8 NEAREN ROW,  
CHARLESTOWN, MA 02129**

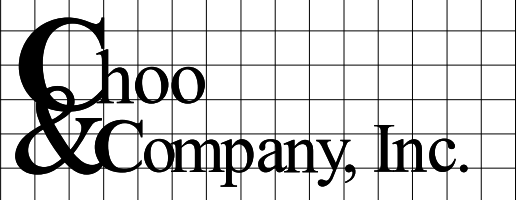

One Billings Road Quincy, MA 02171  
617-786-7727 fax 617-786-7715

No.	Description	Date

Project No: 2023112  
Scale: 1/4" = 1'-0"  
Date: 09-06-2023  
Drawn By: TN / DF


Drawing Name  
**PROPOSED  
ELEVATION**

Sheet No.  
**A-2.11**



Location

# PROPOSED RENOVATION & SEMI-ATTACHED ADDITION 6-8 NEAREN ROW, CHARLESTOWN, MA 02129

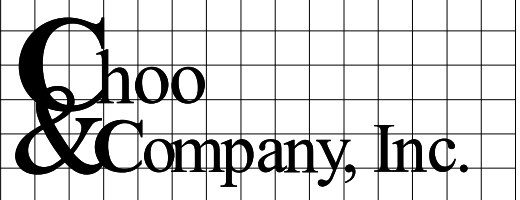

One Billings Road Quincy, MA 02171  
617-786-7727 fax 617-786-7715

No.	Description	Date
2	Revision 2	10-19-2023

Project No: 2023112  
 Scale: 1/4" = 1'-0"  
 Date: 09-06-2023  
 Drawn By: TN / DF

Drawing Name  
**PROPOSED ELEVATION**


Sheet No.  
**A-2.12**





Location

**PROPOSED RENOVATION &  
SEMI-ATTACHED ADDITION  
6-8 NEAREN ROW,  
CHARLESTOWN, MA 02129**

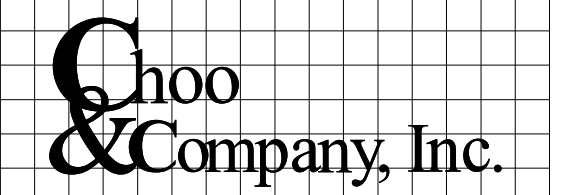


One Billings Road Quincy, MA 02171  
617-786-7727 fax 617-786-7715


No.	Description	Date
2	Revision 2	10-19-2023

Project No: 2023112  
Scale: 1/4" = 1'-0"  
Date: 09-06-2023  
Drawn By: TN / DF

**PROPOSED  
ELEVATIONS**

Sheet No.  
**A-2.13**

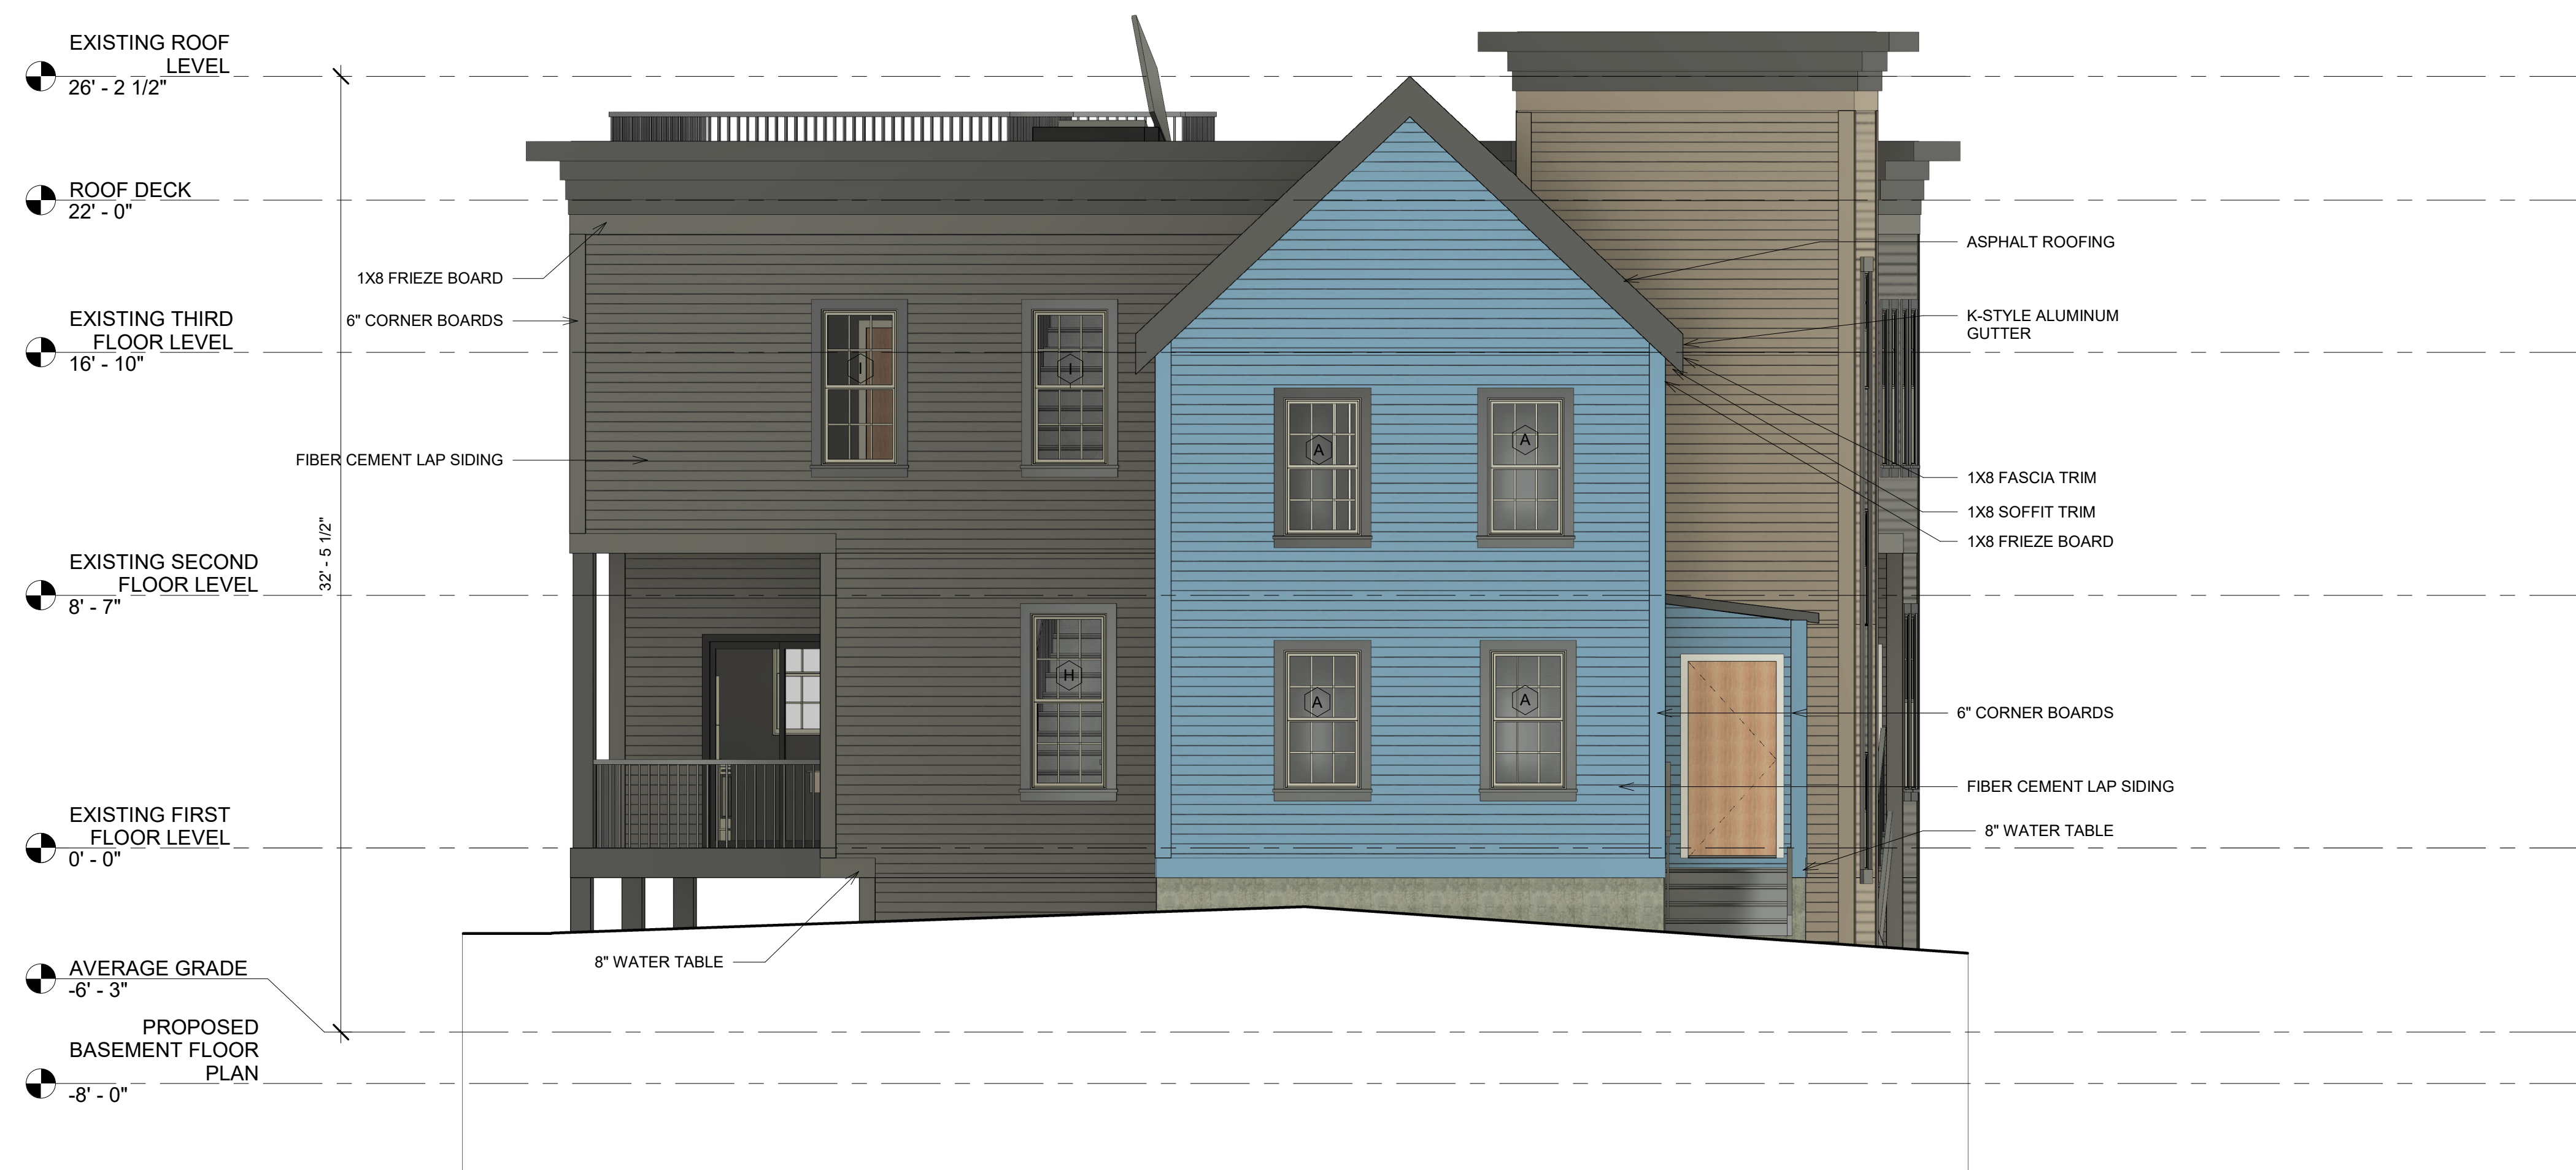

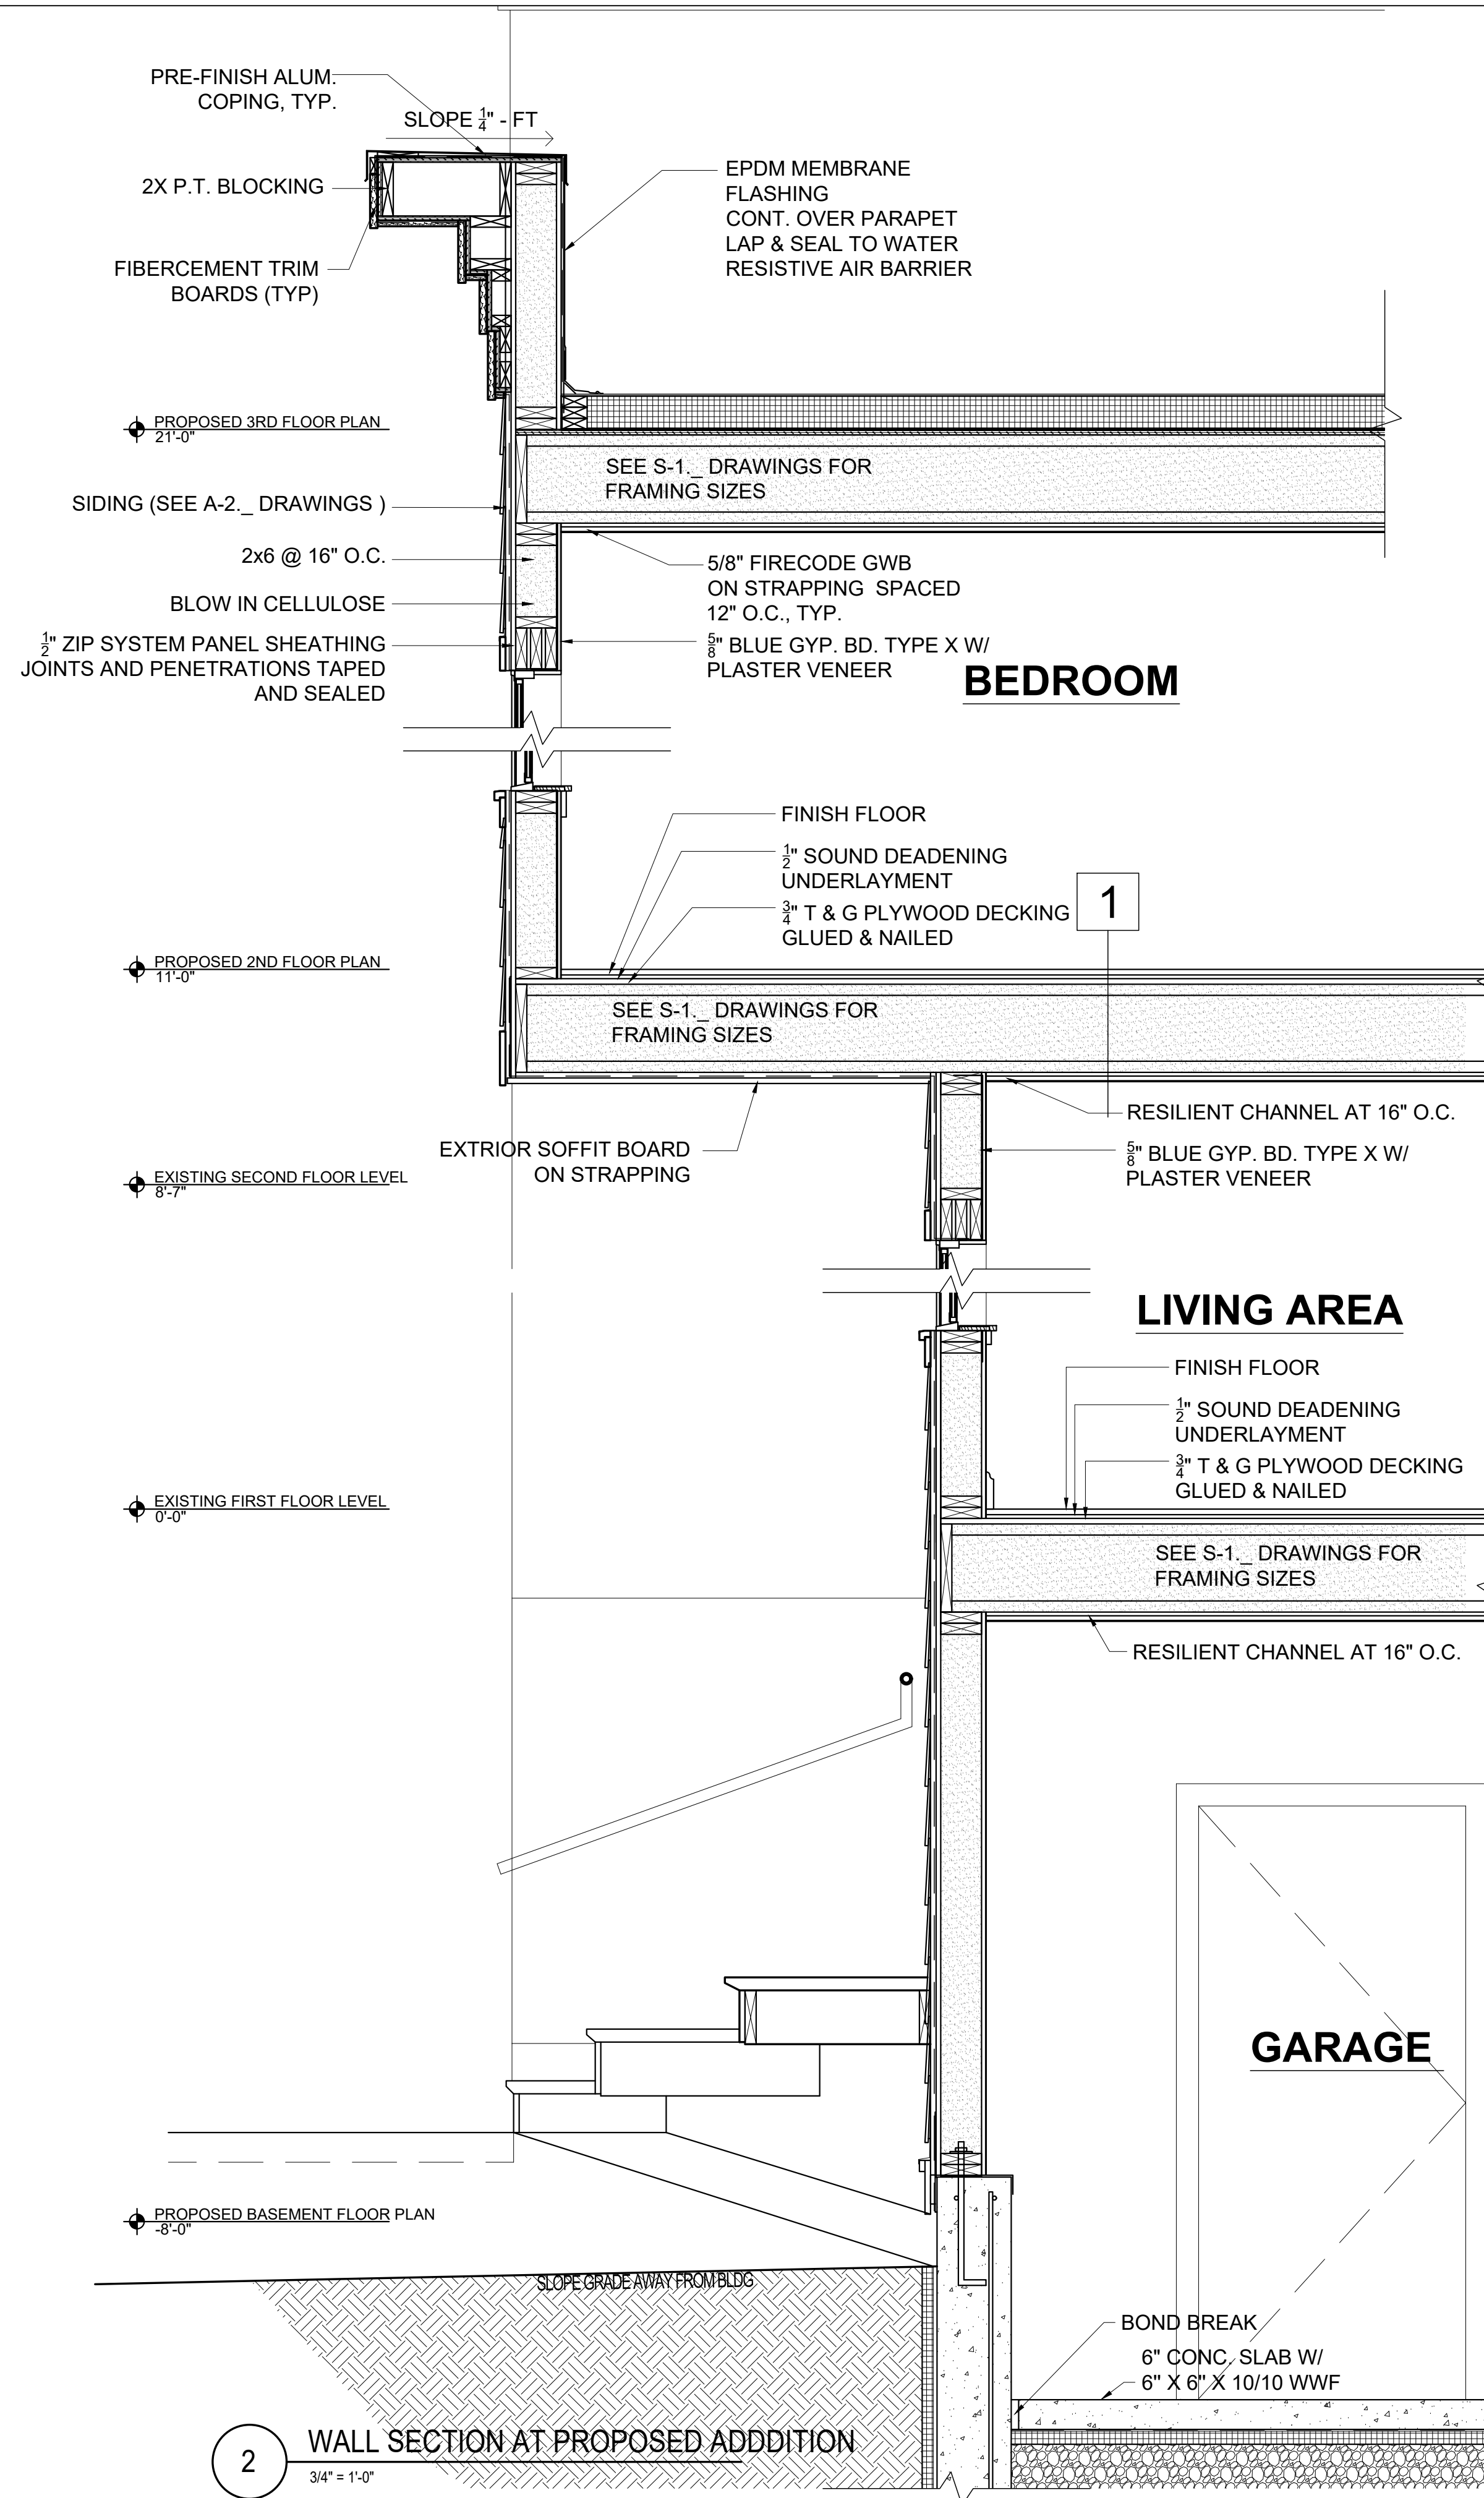

**2** WALL SECTION AT PROPOSED ADDITION  
3/4" = 1'-0"

Location

**PROPOSED RENOVATION & SEMI-ATTACHED ADDITION**  
6-8 NEAREN ROW,  
CHARLESTOWN, MA 02129

**Choo & Company, Inc.**  
One Billings Road Quincy, MA 02171  
617-786-7727 fax 617-786-7715

No.	Description	Date

Project No: 2023112  
Scale: AS NOTED  
Date: 09-06-2023  
Drawn By: AMF

Drawing Name  
**EXTERIOR WALL SECTION**

Sheet No.  
**A-3.10**














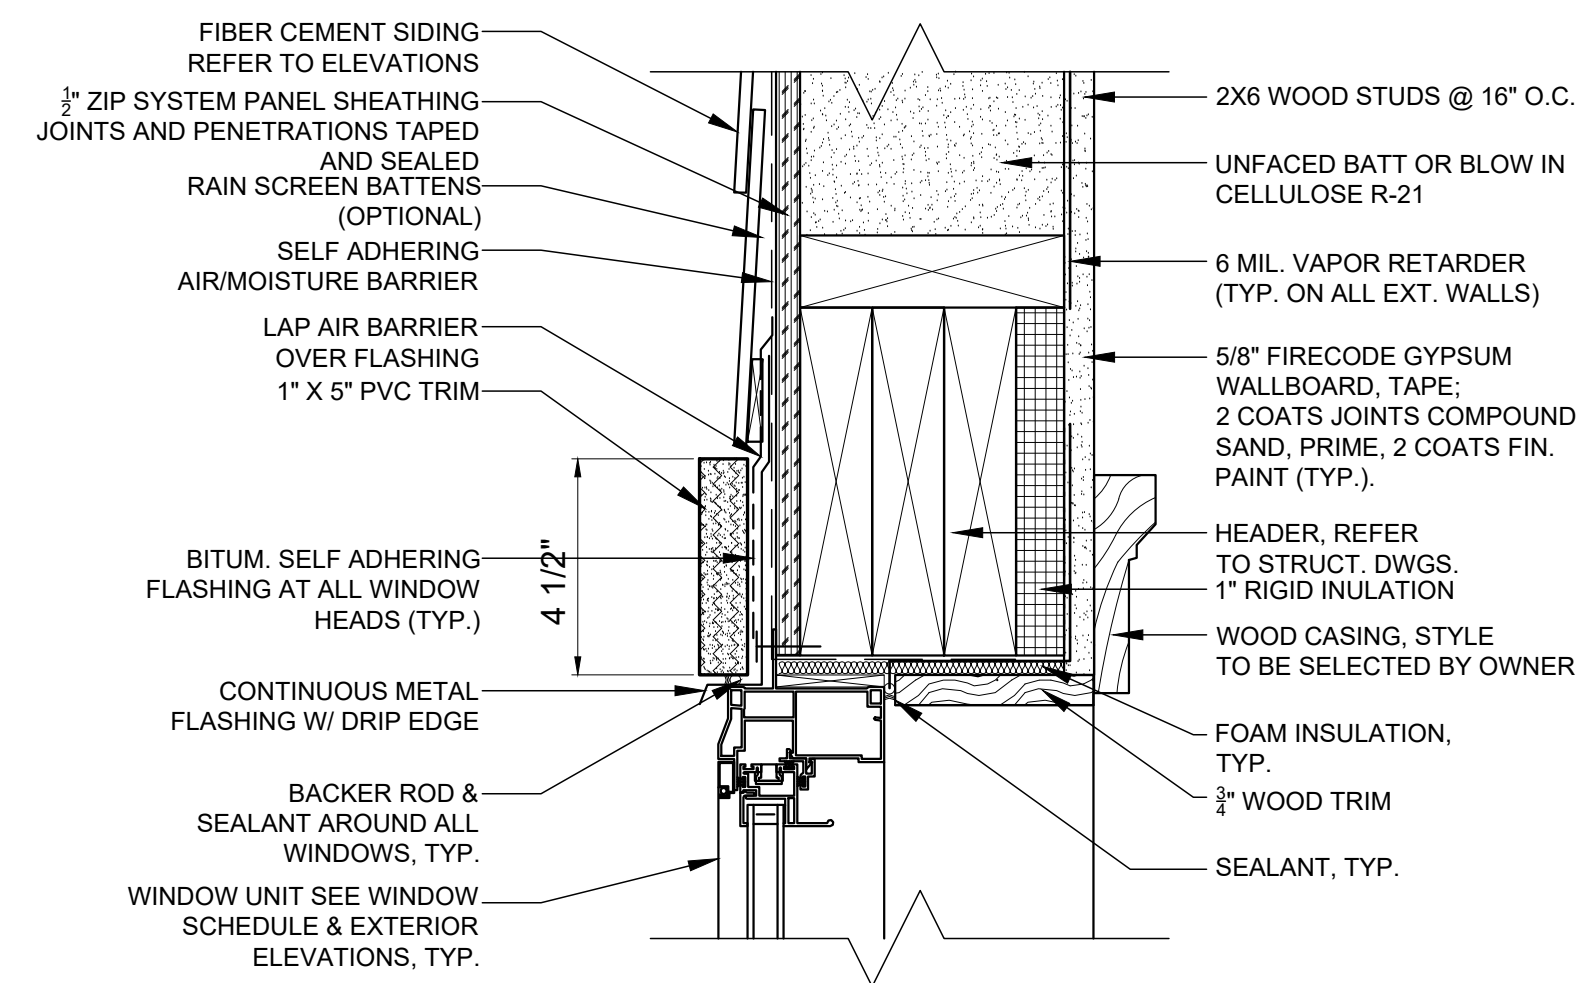

3 WINDOW HEAD DETAIL  
3" = 1'-0"

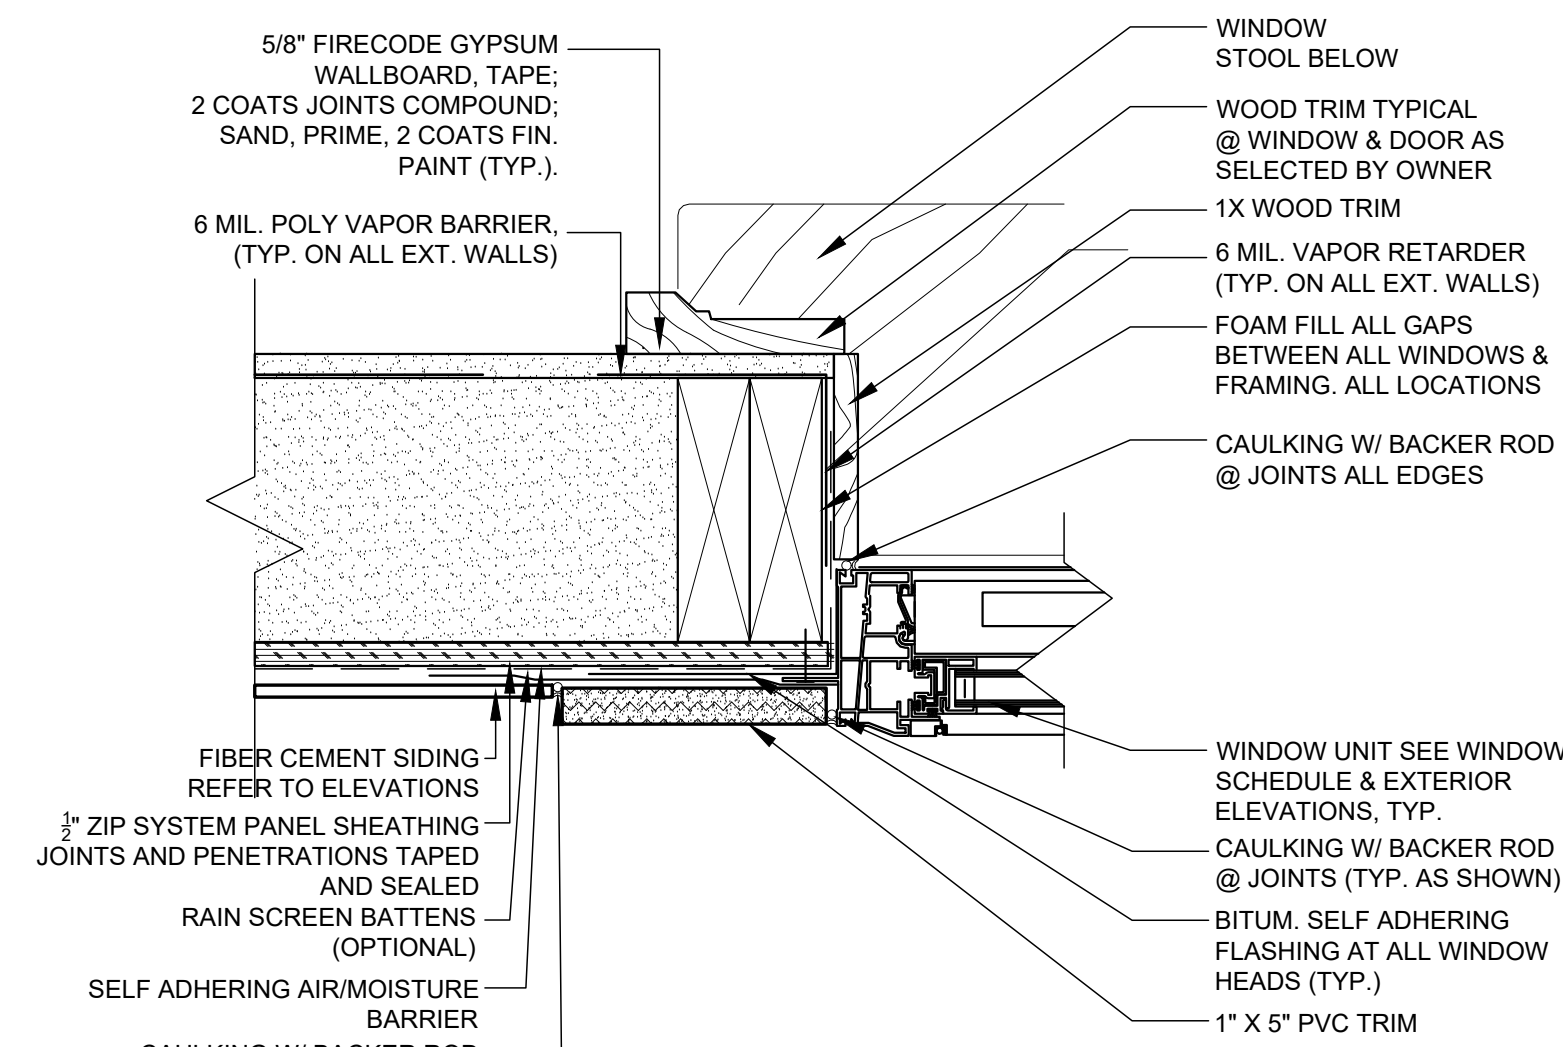

2 WINDOW JAMB DETAIL  
3" = 1'-0"

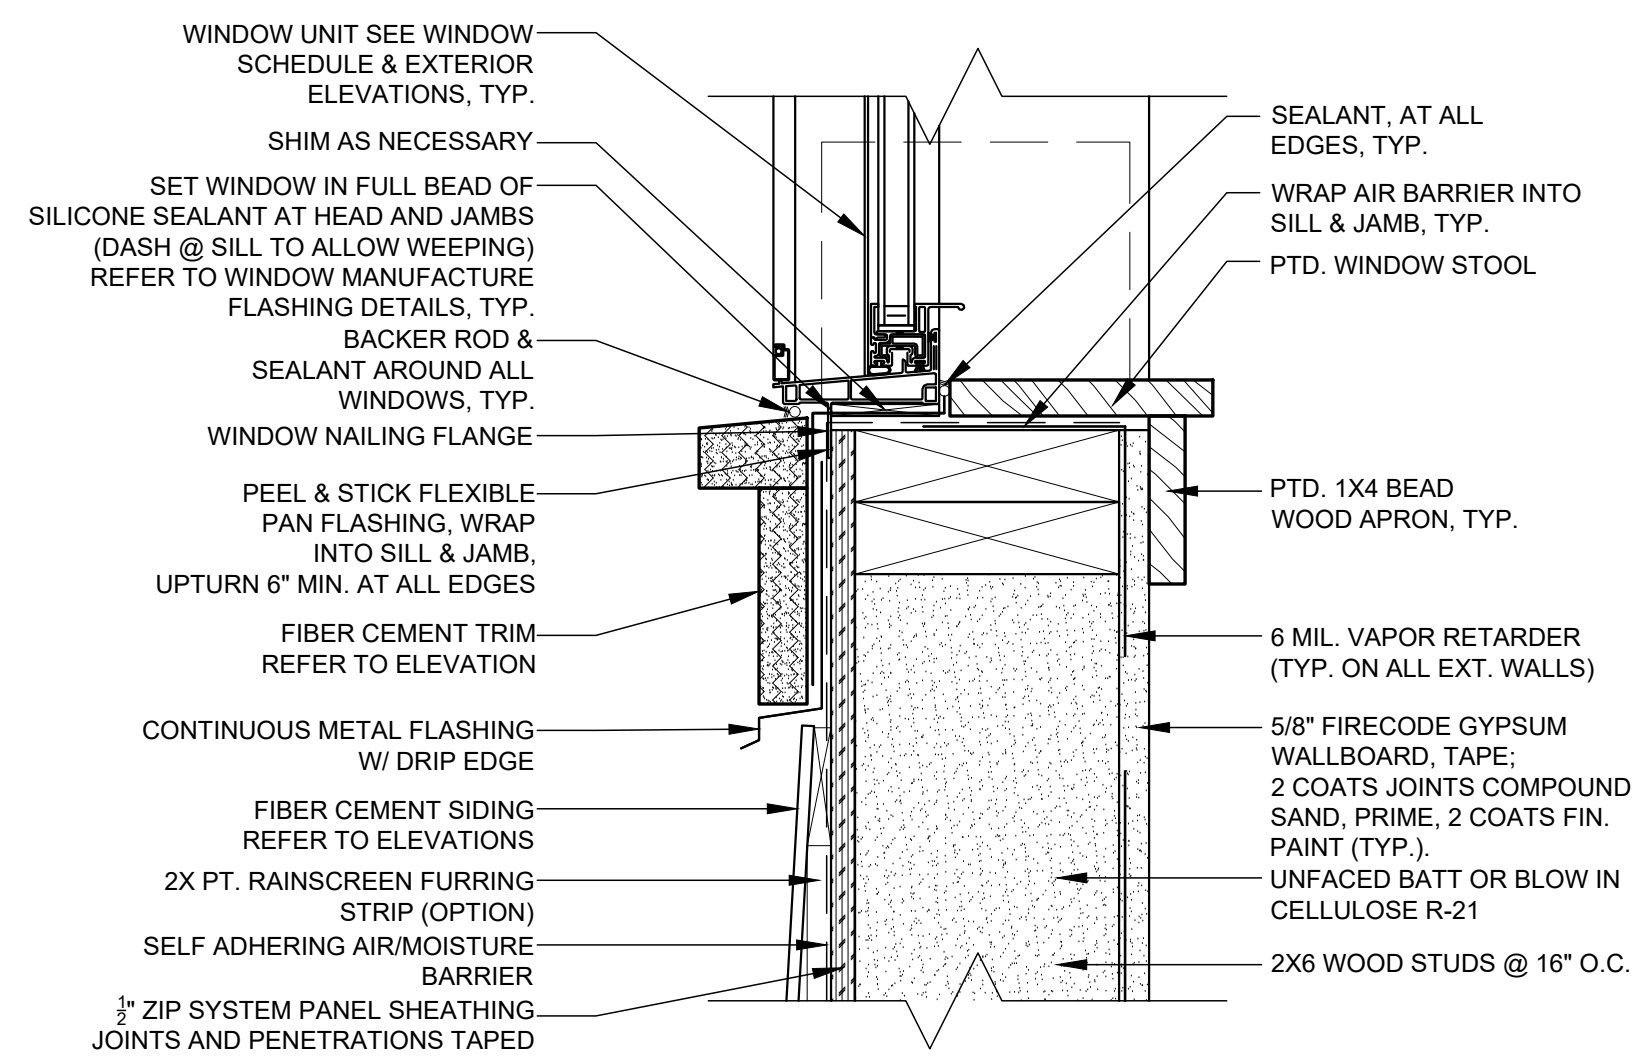


1 WINDOW SILL DETAIL  
3" = 1'-0"

WINDOW SCHEDULE

NOTE: G.C. IS RESPONSIBLE TO VERIFY ALL DIMENSIONS AND UNIT QUANTITIES PRIOR TO ORDERING

NO.	MANUFACTURER	MODEL	QUAN.	WINDOW DIM.	MATERIAL	REMARKS
A	ANDERSON 400 SERIES	WDH2646	16	RO 2'-8 1/8" x 4'-8 7/8"	WOOD / FIBERGLASS	DOUBLE-HUNG, PRIMED INTERIOR, SIMULATED DIVIDED LITES, 6 OVER 6 LITES
C	NOT USED					
D	ANDERSON 400 SERIES	WDH24210	1	RO 1'-6 1/8" x 3'-0 7/8"	WOOD / FIBERGLASS	DOUBLE-HUNG, PRIMED INTERIOR, SIMULATED DIVIDED LITES, 6 OVER 6 LITES
E	ANDERSON 400 SERIES	A281	3	RO 2'-8" x 2'-0 5/8"	WOOD / FIBERGLASS	AWNING, PRIMED INTERIOR,
F	ANDERSON 400 SERIES		2	RO 1'-10 1/8" x 2'-1 7/8"	WOOD / FIBERGLASS	DOUBLE-HUNG, PRIMED INTERIOR, SIMULATED DIVIDED LITES, 6 OVER 6 LITES
G	ANDERSON 400 SERIES	WDH26310	3	RO 2'-1 1/8" x 4'-0 7/8"	WOOD / FIBERGLASS	DOUBLE-HUNG, PRIMED INTERIOR, SIMULATED DIVIDED LITES, 6 OVER 6 LITES
H	ANDERSON 400 SERIES	WDH2610	11	RO 2'-8 1/8" x 6'-0 7/8"	WOOD / FIBERGLASS	DOUBLE-HUNG, PRIMED INTERIOR, SIMULATED DIVIDED LITES, 6 OVER 6 LITES
I	ANDERSON 400 SERIES	WDH2652	13	RO 2'-8 1/8" x 5'-4 7/8"	WOOD / FIBERGLASS	DOUBLE-HUNG, PRIMED INTERIOR, SIMULATED DIVIDED LITES, 6 OVER 6 LITES
I'	ANDERSON 400 SERIES	WDH2652	1	RO 2'-8 1/8" x 5'-4 7/8"	WOOD / FIBERGLASS	DOUBLE-HUNG, PRIMED INTERIOR, SIMULATED DIVIDED LITES, 6 OVER 6 LITES, TEMPERED GLASS
J	ANDERSON 400 SERIES	WDH26310	4	RO 2'-8 1/8" x 4'-0 7/8"	WOOD / FIBERGLASS	DOUBLE-HUNG, PRIMED INTERIOR, SIMULATED DIVIDED LITES, 6 OVER 6 LITES
K	ANDERSON 400 SERIES	A21	1	RO 2'-0 5/8" x 2'-0 1/8"	WOOD / FIBERGLASS	AWNING, PRIMED INTERIOR,
L	ANDERSON 400 SERIES	AW21	1	RO 2'-0 5/8" x 2'-4 7/8"	WOOD / FIBERGLASS	AWNING, PRIMED INTERIOR,
M	ANDERSON 400 SERIES	P4030	1	RO 4'-0 1/2" x 3'-0 1/2"	WOOD / FIBERGLASS	PICTURE, PRIMED INTERIOR
N	ANDERSON 400 SERIES	AX251	1	RO 2'-4 7/8" x 2'-8"	WOOD / FIBERGLASS	PICTURE, PRIMED INTERIOR
O	ANDERSON 400 SERIES	AW21	1	RO 2'-0 5/8" x 2'-4 7/8"	WOOD / FIBERGLASS	AWNING, PRIMED INTERIOR, TEMPERED GLASS
P	FIRELITE IGU		3	RO 2'-0 5/8" x 2'-4 7/8"	STEEL / CERAMIC	FIXED 1 HOUR RATED FIRE GLASS, 12 LITES

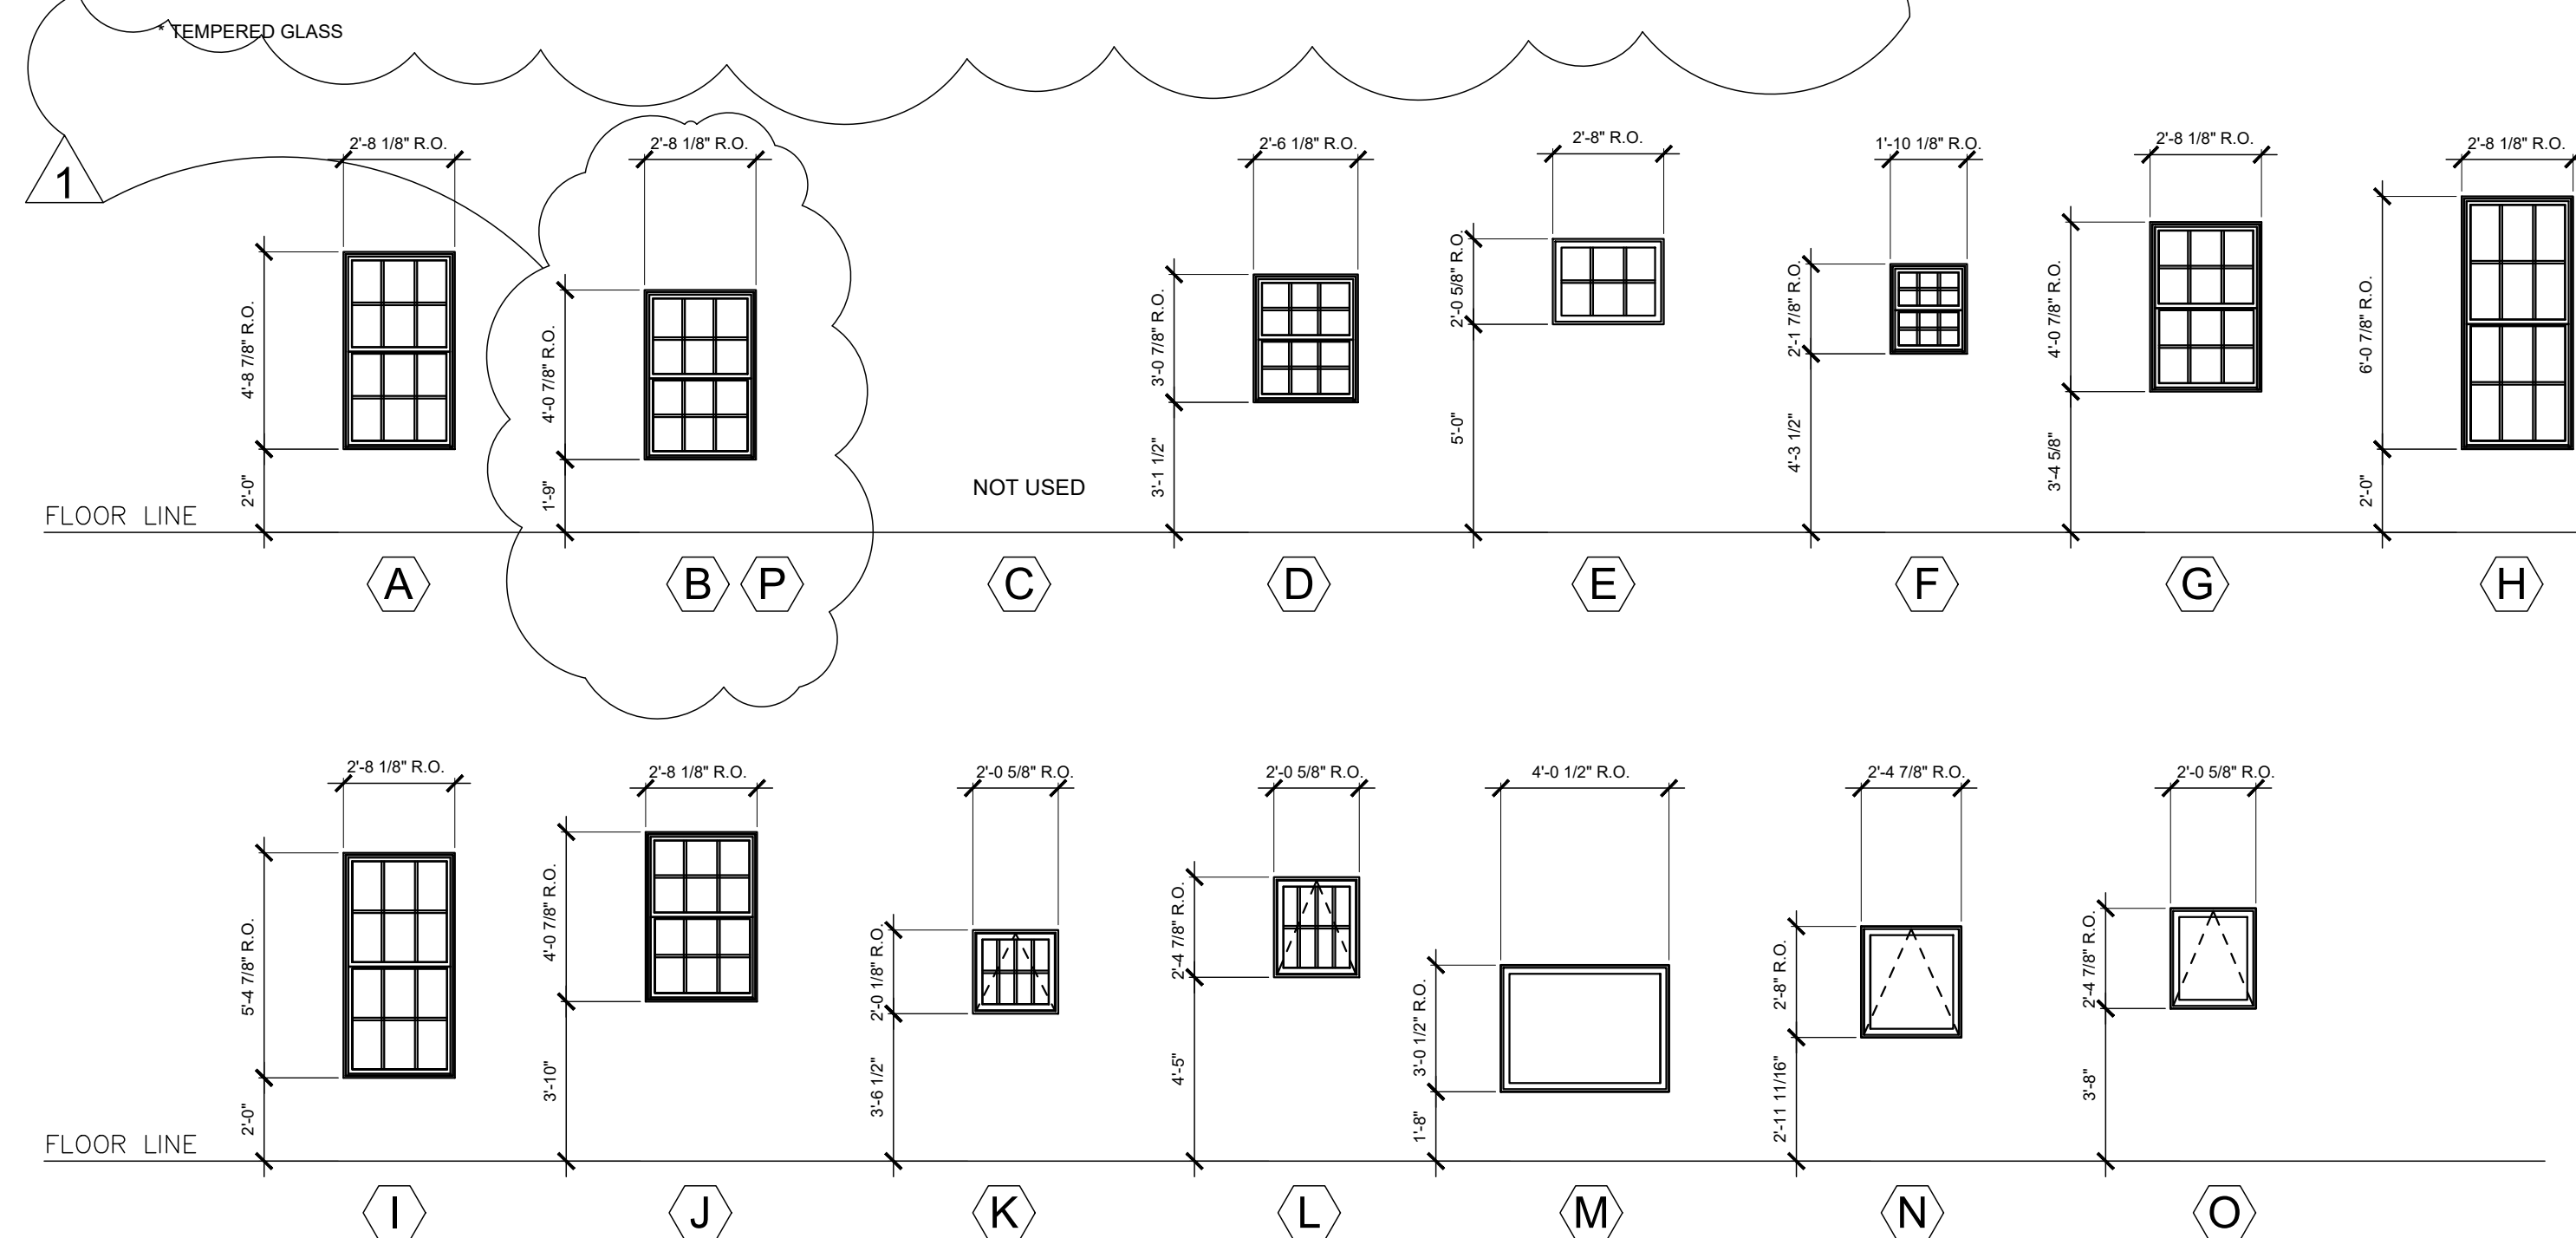

- WINDOW NOTES:
- G.C. IS RESPONSIBLE TO VERIFY ALL DIMENSIONS AND UNIT QUANTITIES PRIOR TO ORDERING
  - GLAZING TO BE LOW-E TYPE
  - ALL WINDOWS TO INCLUDE INSECT SCREENING PER MANUFACTURER
  - DIMENSIONS SHOWN ARE BASED ROUGH OPENINGS.
  - PROVIDE WINDOW OPENING CONTROL DEVICES THAT COMPLY WITH ASTM F2090 ON ALL OPERABLE WINDOW WITH SILLS LESS THEN 36" A.F.F.
  - INTERIOR AND EXTERIOR WINDOW COLOR AND HARDWARE FINISH TO BE SELECTED BY OWNER UNLESS OTHERWISE NOTED.

PROPOSED RENOVATION & SEMI-ATTACHED ADDITION  
6-8 NEAREN ROW,  
CHARLESTOWN, MA 02129

Choo & Company, Inc.  
One Billings Road Quincy, MA 02171  
617-786-7727 fax 617-786-7715

No.	Description	Date
1	ISD	10-06-2023

Project No: 2023112  
Scale: AS NOTED  
Date: 09-06-2023  
Drawn By: AMF

WINDOW SCHEDULE AND ELEVATIONS

Sheet No.  
A-6.01









**GENERAL NOTES:**

**CONTRACTOR RESPONSIBILITY-  
CONTRACTOR IS SOLELY RESPONSIBLE FOR:**

- VIEWING SITE AND INCLUDING ANY SPECIAL CONDITIONS NECESSARY TO PERFORM THE WORK AS DESCRIBED IN THE DRAWINGS.
- ESTABLISHING CONTROL OF THE SITE VIA SURVEY, AND LAYOUT.
- OBTAINING AND PAYING FOR ALL PERMITS.
- PAYING FOR ALL TEMPORARY UTILITIES AND FACILITIES.
- CHECKING AND CONFIRMING ALL DIMENSIONS, AND LAYOUTS.
- SCHEDULING AND SEQUENCING.
- CONSTRUCTION MEANS, METHODS AND TECHNIQUES
- MAINTAINING DRAWINGS AND PERMITS ON SITE.
- JOB SITE SAFETY
- COORDINATION BETWEEN TRADES, AND SUPPLIERS.
- PROVIDE SCHEDULE TO OWNER AND ARCHITECT.
- PROVIDE A SCHEDULE OF VALUES TO THE OWNER AND ARCHITECT.
- TEMPORARY HEAT, ICE AND SNOWPLOWING IS THE RESPONSIBILITY OF THE CONTRACTOR.
- SITE CLEANLINESS AND CONFORMANCE TO NFPA 241 REQUIREMENTS.
- REPAIRING ANY WORK DAMAGED BY HIS FORCES WHILE PERFORMING THIS CONTRACT.
- GIVING WARRANTY FOR HIS WORK FOR A PERIOD OF ONE YEAR FROM THE DATE OF FINAL COMPLETION.

**REVIEW OF WORK BY DESIGNERS-**

CONTRACTOR SHALL NOTIFY ARCHITECT BEFORE PROJECT STARTS.

CONTRACTOR SHALL NOTIFY ARCHITECT, ONE WEEK PRIOR TO:

- POURING CONCRETE
- INSULATING
- INSTALLING DRYWALL
- FINAL INSPECTION

**SHOP DRAWINGS-**

ALL SHOP DRAWINGS SHALL BE SUBMITTED 30 DAYS AFTER CONTRACT AWARD.

GENERAL CONTRACTOR SHALL APPROVE SHOP DRAWINGS, PRIOR TO SUBMITTING TO ARCHITECT OR ENGINEER.

NON SUBMISSION DOES NOT CONSTITUTE APPROVAL OF ANY WORK.

NO EXCEPTIONS TAKEN DOES NOT RELIEVE THE CONTRACTOR OF PERFORMING ANY OTHER WORK ON THE DRAWINGS.

CONTRACTOR SHALL EXPECT A MINIMUM OF 2 WEEKS FOR DESIGNERS' REVIEW TIME.

ANY VARIANCE FROM THE ORIGINAL DESIGN SHALL BE NOTED.

ANY SUBSTITUTION NOT INDICATED SHALL NOT CONSTITUTE APPROVAL OF A CHANGE.

SHOP DRAWINGS ARE NOT COORDINATION DRAWINGS.

DESIGNERS ARE NOT RESPONSIBLE FOR DIMENSIONS.

CONTRACTOR TO ENSURE MATERIALS AND ASSEMBLIES ARE COMPATIBLE AND ACCEPTABLE TO THE MANUFACTURER. ALL ASSEMBLY MATERIALS SHALL BE FROM A SINGLE SOURCE AS MUCH AS POSSIBLE.

**REQUEST FOR INFORMATION -**

ONLY RFI'S SENT THROUGH BY THE OWNER AND AWARDED CONTRACTOR WILL BE ANSWERED. SUBCONTRACTORS MUST SUBMIT RFI'S THROUGH THE GENERAL CONTRACTOR.

BIDDING PHASE - OWNER AND AWARDED CONTRACTOR ARE RESPONSIBLE FOR COMPILING AND AGGREGATING RFI'S AND SUBMITTING TO THE ARCHITECT OR DESIGNER AT ONE TIME ONLY. ARCHITECT OR DESIGNER HAS ONE WEEK TO RESPOND. QUESTIONS MUST BE COMPLETE , NOT PIECEMEAL AND SHOULD BE SUBMITTED BY CSI DIVISION.

**CHANGE ORDERS-**

CONTRACTOR SHALL VISIT THE SITE AND BE THOROUGHLY ACQUAINTED WITH THE PROJECT PRIOR TO SUBMITTING A PRICE. ADDITIONAL MONEY WILL NOT BE GRANTED FOR WORK NOT CLARIFIED PRIOR TO BIDDING.

DESIGNER SHALL BE NOTIFIED OF ANY CHANGE TO THE DRAWINGS, UNFORESEEN FIELD CONDITIONS OR DISCREPANCIES PRIOR TO PERFORMING WORK.

ANY PROPOSED CHANGES SHALL BE ACCOMPANIED WITH A WRITTEN DESCRIPTION OR A SKETCH FOR CLARIFICATION.

ALL CHANGE ORDERS SHALL BE APPROVED PRIOR TO PERFORMING WORK.

CHANGE ORDERS SHALL BE PRICED EITHER LUMP SUM OR UNIT PRICE OR TIME AND MATERIALS.

ANY SUBSTITUTION REQUEST SHALL BE MADE VIA CHANGE ORDER, AND NOT VIA SHOP DRAWINGS UNLESS AGREED TO.

ANY CHANGE SHALL STATE THE CREDIT OR COST ADD AND/OR ANY CHANGE TO THE SCHEDULE.

**REQUISITIONS-**

ANY REQUISITION REQUIRED TO BE SIGNED BY THE ARCHITECT SHALL BE SUBMITTED A MINIMUM OF ONE WEEK PRIOR TO BEING SUBMITTED TO THE BANK FOR REVIEW.

CONTRACTOR SHALL PROVIDE RECEIPTS AND INSURANCE CERTIFICATES FOR ANY MATERIALS FOR PAYMENT FOR ANY UNINSTALLED MATERIALS.

**FOUNDATION NOTES:**

- THE FOUNDATION HAS BEEN DESIGNED FOR 4000 PSF ALLOWABLE SOIL BEARING CAPACITY.
- ALL BACKFILL UNDER STRUCTURAL SLABS, MATS, AND FOOTINGS WILL BE ENGINEERED BACKFILL COMPACTED IN SPECIFIC LIFTS TO 95 PERCENT OF MAXIMUM DRY DENSITY, UNLESS OTHERWISE INDICATED OR SPECIFIED.
- ALL EMBANKMENTS AND BACKFILL COMPACTED IN SPECIFIED LIFTS TO 90 PERCENT OF MAXIMUM DRY DENSITY, UNLESS OTHERWISE INDICATED OR SPECIFIED.
- PROVIDE SHEETING, BRACING, AND UNDERPINNING AS REQUIRED TO PRESERVE ADJACENT STRUCTURES.
- FOUNDATIONS SHALL NOT BE POURED IN WATER OR ON FROZEN GROUND.
- VERIFY LOCATIONS AND REQUIREMENTS FOR INSERTS, SLEEVES, CONDUITS, EMBEDMENT AND PENETRATIONS WITH RESPECTIVE TRADES BEFORE PLACING CONCRETE.
- DOWELS FROM FOUNDATIONS INTO PIERS, COLUMNS, BUTTRESSES OR WALLS SHALL BE THE SAME SIZE AND NUMBER AS REINFORCEMENT IN PIERS, COLUMNS, BUTTRESSES OR WALLS ABOVE, EXCEPT AS OTHERWISE SHOWN.
- CONTRACTOR SHALL PROVIDE CONTINUOUS DRAINAGE BY MECHANICAL METHODS TO CONTROL SURFACE AND UNDERGROUND WATER, AS REQUIRED DURING CONSTRUCTION.
- CONTRACTOR SHALL ENSURE THAT GROUND WATER LEVELS UNDER ADJACENT STRUCTURES AND PROPERTIES ARE NOT ALTERED.
- ALL FOUNDATION UNITS (PIERS) SHALL BE CENTERED SUPPORT MEMBERS, UNLESS NOTED OTHERWISE ON PLANS.
- COORDINATE UNDER FLOOR AND PERIMETER DRAIN REQUIREMENTS WITH ARCHITECTURAL, CIVIL AND PLUMBING DRAWINGS AND THE REQUIREMENTS OF THE GEOTECHNICAL ENGINEER.
- ALL BEARING MATERIALS SHALL BE INSPECTED BY THE INDEPENDENT TESTING AGENCY PRIOR TO CONCRETE PLACEMENT. THE INDEPENDENT TESTING AGENCY SHALL DETERMINE THE SUITABILITY OF THE BEARING MATERIAL. FOOTING ELEVATIONS SHALL BE ADJUSTED AS REQUIRED.
- BOTTOM OF ALL EXTERIOR FOOTINGS SHALL BEAR A MINIMUM OF 4'-0" BELOW FINAL FINISHED GRADE FOR FROST PROTECTION.
- FOUNDATION WALLS THAT RETAIN EARTH SHALL BE BRACED AGAINST BACKFILLING PRESSURES UNTIL FLOOR & SLAB AT TOP AND BOTTOM ARE IN PLACE.
- WHERE FOUNDATION WALLS ARE TO HAVE EARTH PLACED ON EACH SIDE, PLACE FILL SIMULTANEOUSLY SO AS TO MAINTAIN A COMMON ELEVATION ON EACH SIDE OF THE WALL.
- ALL FOOTING EXCAVATIONS ARE TO BE FINISHED BY HAND.
- PROTECT IN-PLACE FOUNDATIONS, SLABS AND ADJACENT STRUCTURES, NEW CONSTRUCTION, STREET UTILITIES FROM FROST PENETRATION OR DAMAGE FROM CONSTRUCTION ACTIVITIES UNTIL THE PROJECT IS COMPLETED.
- SLAB ON GRADE SHALL BEAR DIRECTLY ON A MIN. 12" THICK LAYER OF COMPACTED STRUCTURAL FILL, OR MIN. 6" THICK LAYER OF CRUSHED STONE, PLACED ABOVE PROOFROLLED AND COMPACTED EXISTING FILL, OR ABOVE UNDISTURBED NATURAL TILL. SHOULD BEDROCK BE ENCOUNTERED AT OR WITHIN 12" OF BOTTOM OF SLAB, BEDROCK SHALL BE OVER EXCAVATED A MIN. OF 12" BELOW BOTTOM OF SLAB.
- WHERE BEDROCK IS ENCOUNTERED AT OR WITHIN 12" OF DESIGN FOOTING GRADE, IT SHOULD BE OVER EXCAVATED A MIN. OF 12" BELOW THE BOTTOM OF PROPOSED FOOTING. BEDROCK EXCAVATIONS SHOULD EXTEND A MIN. OF 12" BEYOND FOOTING EDGE. LOOSE ROCK PIECES SHOULD BE REMOVED WITHIN THE FOOTING BEARING ZONE, AND OPEN BEDROCK JOINTS SHOULD BE CHOKED WITH CRUSHED STONE OR FILLED WITH CONCRETE PRIOR TO PLACING THE SOIL CUSHION.

**CONCRETE NOTES:**

- ALL CONCRETE SHALL ATTAIN A MINIMUM COMPRESSIVE STRENGTH OF:
    - 3000 PSI** FOR BASEMENT SLABS, FOUNDATION WALL, EXTERIOR WALLS AND OTHER VERTICAL CONCRETE SURFACES EXPOSED TO THE WEATHER FOR DRIVEWAYS, CURBS, WALKS, PATIOS, PORCHES, CARPORT SLAB, COMPOSITE SLAB, STEPS AND OTHER FLATWORK EXPOSED TO WEATHER AND GARAGE FLOOR SLABS
    - 3500 PSI**
  - MAXIMUM SLUMP SHALL NOT EXCEED 4"; AND MAXIMUM; COARSE AGGREGATE SIZE SHALL NOT EXCEED 3/4" IN DIAMETER.
  - ALL CONCRETE SLABS ON GRADE SHALL BE POURED IN 900 SQUARE FOOT PANELS, MAXIMUM; OR, PROVIDE CONTROL JOINTS BY SAW CUTTING THE SLAB WHILE THE CONCRETE IS STILL GREEN.
- REINFORCING NOTES:**
- ALL REINFORCEMENT, EXCEPT FOR TIES AND STIRRUPS, SHALL CONFORM TO ASTM 615-60.
  - ALL REINFORCEMENT FOR TIES AND STIRRUPS SHALL CONFORM TO ASTM 615-40.
  - ALL WELDED WIRE FABRIC SHALL CONFORM TO ASTM A185-70 SPECIFICATIONS.
  - ALL REINFORCEMENT SHALL BE INSPECTED AND APPROVED BY THE ARCHITECT OR HIS ENGINEER PRIOR TO THE PLACEMENT OF ANY CONCRETE.
  - THE CONTRACTOR SHALL SUBMIT FOUR PRINTS OF SHOP DRAWINGS: SHOWING ALL REINFORCING DETAILS, CHAIR BARS, HIGH CHAIRS, SLAB BOLSTERS, ETC. TO THE ARCHITECT FOR HIS APPROVAL. THE CONTRACTOR SHALL RECEIVE WRITTEN APPROVED SHOP DRAWINGS FROM THE ARCHITECT OR HIS ENGINEER PRIOR TO THE FABRICATION OF REINFORCEMENT.
  - CLEARANCES OF MAIN REINFORCING FROM ADJACENT CONCRETE SURFACES SHALL BE AS FOLLOWS:
    - A. FOOTINGS 3 INCHES
    - B. SIDES OF FOUNDATIONS WALLS. EXPOSED FACES OF FOUNDATIONS. SIDES OF COLUMNS/PIERS, SLABS ON GRADE FROM TOP SURFACE 2 INCHES
    - C. INTERIOR FACES OF FOUNDATIONS. TOP REINFORCING IN SLABS EXPOSED TO THE WEATHER 1-1/2 INCHES
    - D. TOP STEEL OF INTERIOR SLABS 1 INCHES
  - MAXIMUM DEVIATION FROM THESE REQUIREMENTS SHALL BE 1/4" OF SECTIONS 10" OR LESS, 1/2" FOR SECTIONS GREATER THAN 10".

NOTE: THERE HAS BEEN NO SOIL TESTING PROVIDED TO THIS OFFICE FOR THIS PROJECT. THE DESIGNING ARCHITECT OR STRUCTURAL ENGINEER ACCEPTS NO RESPONSIBILITY FOR EXISTING SOIL CONDITIONS. ANY SOIL BEARING CAPACITY OF THIS FOUNDATION SYSTEM IS DESIGNED BASED ON A 2 TON MINIMUM SOIL BEARING CAPACITY. IT SHALL BE THE CONTRACTORS OR OWNERS' RESPONSIBILITY TO DETERMINE SUITABLE SOIL CONDITIONS AND VERIFY THE BEARING PRESSURE. IF A SUITABLE SOIL THAT CAN WITHSTAND A 2 TON BEARING CAPACITY IS NOT AVAILABLE, THIS OFFICE SHOULD BE CONTACTED BY THE CONTRACTOR OR OWNER FOR A FOUNDATION REDESIGN.

**WOOD NOTES:**

- ALL LUMBER SHALL HAVE A MOISTURE CONTENT OF NOT MORE THAN 19%.
- ALL FRAMING LUMBER SHALL BE #2 SPF, OR BETTER, HAVING A MINIMUM:
  - FB=875 PSI, FV=135 PSI, E=1,400,000 PSI.
- ALL L.V.L. LUMBER DENOTED ON PLANS SHALL HAVE A MINIMUM:
  - FB=2,650 PSI, FV=285 PSI, E=1,900,000 PSI - FOR STUDS COLUMNS
  - FB-3100 PSI, FV=285 PSI, E=2,000,000 PSI - FOR BEAMS
- ALL JOIST SPANS SHALL HAVE ONE ROW OF 1" X 3: CROSS BRIDGING AT MID SPAN AND NOT MORE THAN 8'-0" O.C.
- ALL STUD BEARING WALLS SHALL HAVE ONE ROW OF 2X HORIZONTAL BLOCKING AT 1/2 STUD HEIGHT, AND NOT MORE THAN 6'-0" O.C. MAXIMUM.
- PROVIDE AND INSTALL ALL NECESSARY TIMBER CONNECTORS WITH ADEQUATE STRENGTH.
- PROVIDE DOUBLE JOIST BELOW PARTITIONS PARALLEL TO JOIST FRAMING.
- PROVIDE SOLID BRIDGING BELOW PARTITIONS PERPENDICULAR TO JOIST FRAMING.
- PROVIDE SOLID BRIDGING BETWEEN JOIST FRAMING MEMBERS WHEN BEARING ON STUD PARTITIONS OR BEAMS.
- PROVIDE A CONTINUOUS BAND JOIST AT EXTERIOR STUD WALLS.
- PROVIDE DIAGONAL METAL STRAP BRACING AT ALL CORNERS AND WALL INTERSECTIONS, AT THE INSIDE FACE OF STUDS, FROM TOP PLATE TO FLOOR PLATE AT A 45 DEGREE ANGLE WITH A SIMPSON TYPE "RCWB" STRAP, OR EQUAL.
- ALL BUILT-UP BEAMS SHALL BE BOLTED WITH 1/2" Ø THRU BOLTS, MEETING A307 STANDARDS, OR, AS NOTED ON DRAWINGS.

**WOOD LINTEL SCHEDULE:**

Lintels over openings in bearing walls shall be as follows; or as noted on drawings.

Span of opening:	Size: 2x6 studs	Size: 2x4 studs
less than 4'-0"	3 - 2x8	2 - 2x8
up to 6'-0"	3 - 2x12	2 - 2x12
up to 8'-0"	3 - 13/4"x9 1/2" LVL	2 - 13/4"x9 1/2" LVL
up to 10'-0"	3 - 13/4"x11 7/8" LVL	2 - 13/4"x11 7/8" LVL

ALL POSTS FOR LINTEL TO BE (3)2X6 JACK STUD AND (3) 2X6 KING STUD

**STRUCTURAL STEEL NOTES:**

- ALL STRUCTURAL STEEL SHALL CONFORM TO ASTM A992 GRADE 50 SPECIFICATIONS, EXCEPT SQUARE STEEL TUBE COLUMNS.
- ALL SQUARE STEEL TUBE COLUMNS SHALL CONFORM TO ASTM A500, WITH A MINIMUM YIELD STRESS OF 46,000 PSI.
- ALL SHOP CONNECTIONS SHALL BE WELDED.
- FIELD CONNECTION SHALL BE MADE WITH HIGH STRENGTH FRICTION BOLTS MEETING A325-X SPECIFICATIONS.
- ALL BOLTS SHALL BE 3/4" IN DIAMETER, OR AS NOTED ON DRAWINGS. HOLES SHALL BE 1/16" LARGER.
- ALL STRUCTURAL STEEL SHALL RECEIVE ONE SHOP COAT OF RUST INHIBITIVE PAINT; SUCH AS TNEMEC-99, OR RUST INHIBITOR BY "MAINLINE". OR, PAINT, AS NOTED IN THE SPECIFICATIONS.
- AFTER STRUCTURAL STEEL ERECTION IS IN PLACE, ALL EXPOSED AREAS SHALL BE TOUCHED UP. SEE SPECIFICATIONS ON PAINTING FOR ADDITIONAL REQUIREMENTS.
- PROVIDE 3/4: GROUT, 3,000 PSI, AND 1/4" THICK LEVELING PLATES UNDER ALL COLUMN BASE PLATES, WITH FOUR (4) 3/4" DIAMETER x 16" LONG ANCHOR BOLTS; OR AS NOTED.
- PROVIDE A MINIMUM OF 8" BEARING ON EACH SIDE OF LINTELS AND HEADERS OVER DOORS, WINDOWS, LOUVERS, AND OPENINGS, ETC.
- THE CONTRACTOR SHALL SUBMIT A REPRODUCIBLE SEPIA AND FOUR PRINTS OF SHOP DRAWINGS; SHOWING ALL STRUCTURAL STEEL SIZES, CONNECTIONS AND DETAILS, TO THE ARCHITECT FOR HIS APPROVAL. FABRICATION OF STRUCTURAL STEEL MEMBERS SHALL NOT BEGIN WITHOUT PRIOR WRITTEN APPROVAL BY THE ARCHITECT OR HIS ENGINEER.
- ALL WORK SHALL BE PERFORMED IN CONFORMANCE WITH THE LATEST COMMONWEALTH OF MASSACHUSETTS BUILDING CODE AND THE STRUCTURAL STEEL INSTITUTE SPECIFICATIONS FOR BUILDINGS AND BRIDGES.


**CONTRACTOR NOTE:**  
PRIOR TO COMMENCEMENT OF WORK OR FABRICATION OF COMPONENTS, CONTRACTOR SHALL INVESTIGATE AND VERIFY IN THE FIELD ALL CONDITIONS, DIMENSIONS, AND ELEVATIONS OF THE EXISTING CONSTRUCTION. ALL DISCREPANCIES BETWEEN FIELD-VERIFIED CONDITIONS, DIMENSIONS AND ELEVATIONS AND THOSE INDICATED ON THE DRAWINGS SHALL BE IMMEDIATELY MADE KNOWN TO THE ARCHITECT IN WRITING. THE USE OF (V.I.F.) OR (+/-) OR OTHER SIMILAR NOTES AT CERTAIN LOCATIONS ON THE DRAWINGS DOES NOT RELIEVE THE CONTRACTOR OF RESPONSIBILITY FOR VERIFYING ALL CONDITIONS DESCRIBED ABOVE.

CONTRACTOR TO PROVIDE TEMPORARY SHORING, BRACING, AND SUPPORT AS REQUIRED DURING CONSTRUCTION. PROVIDE NEW JOIST HANGERS AND HURRICANE TIES BY SIMPSON STRONG-TIE AT LOCATIONS WHERE MEMBERS FRAME IN TO SIDE OF EXISTING MEMBERS OR NEW

PERMIT ONLY

Location

**PROPOSED RENOVATION &  
SEMI-ATTACHED ADDITION  
6-8 NEAREN ROW,  
CHARLESTOWN, MA, 02129**

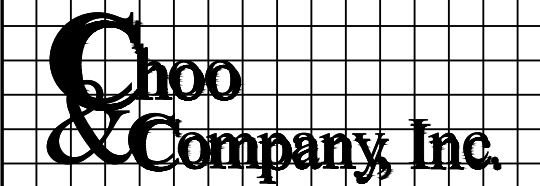

One Billings Road Quincy, MA 02171  
617-786-7727 fax 617-786-7715

No.	Revision Date


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Date: 9-6-2023  
Drawn By: AC

Drawing Name  
**GENERAL NOTES**

Sheet No.  
**S-0**






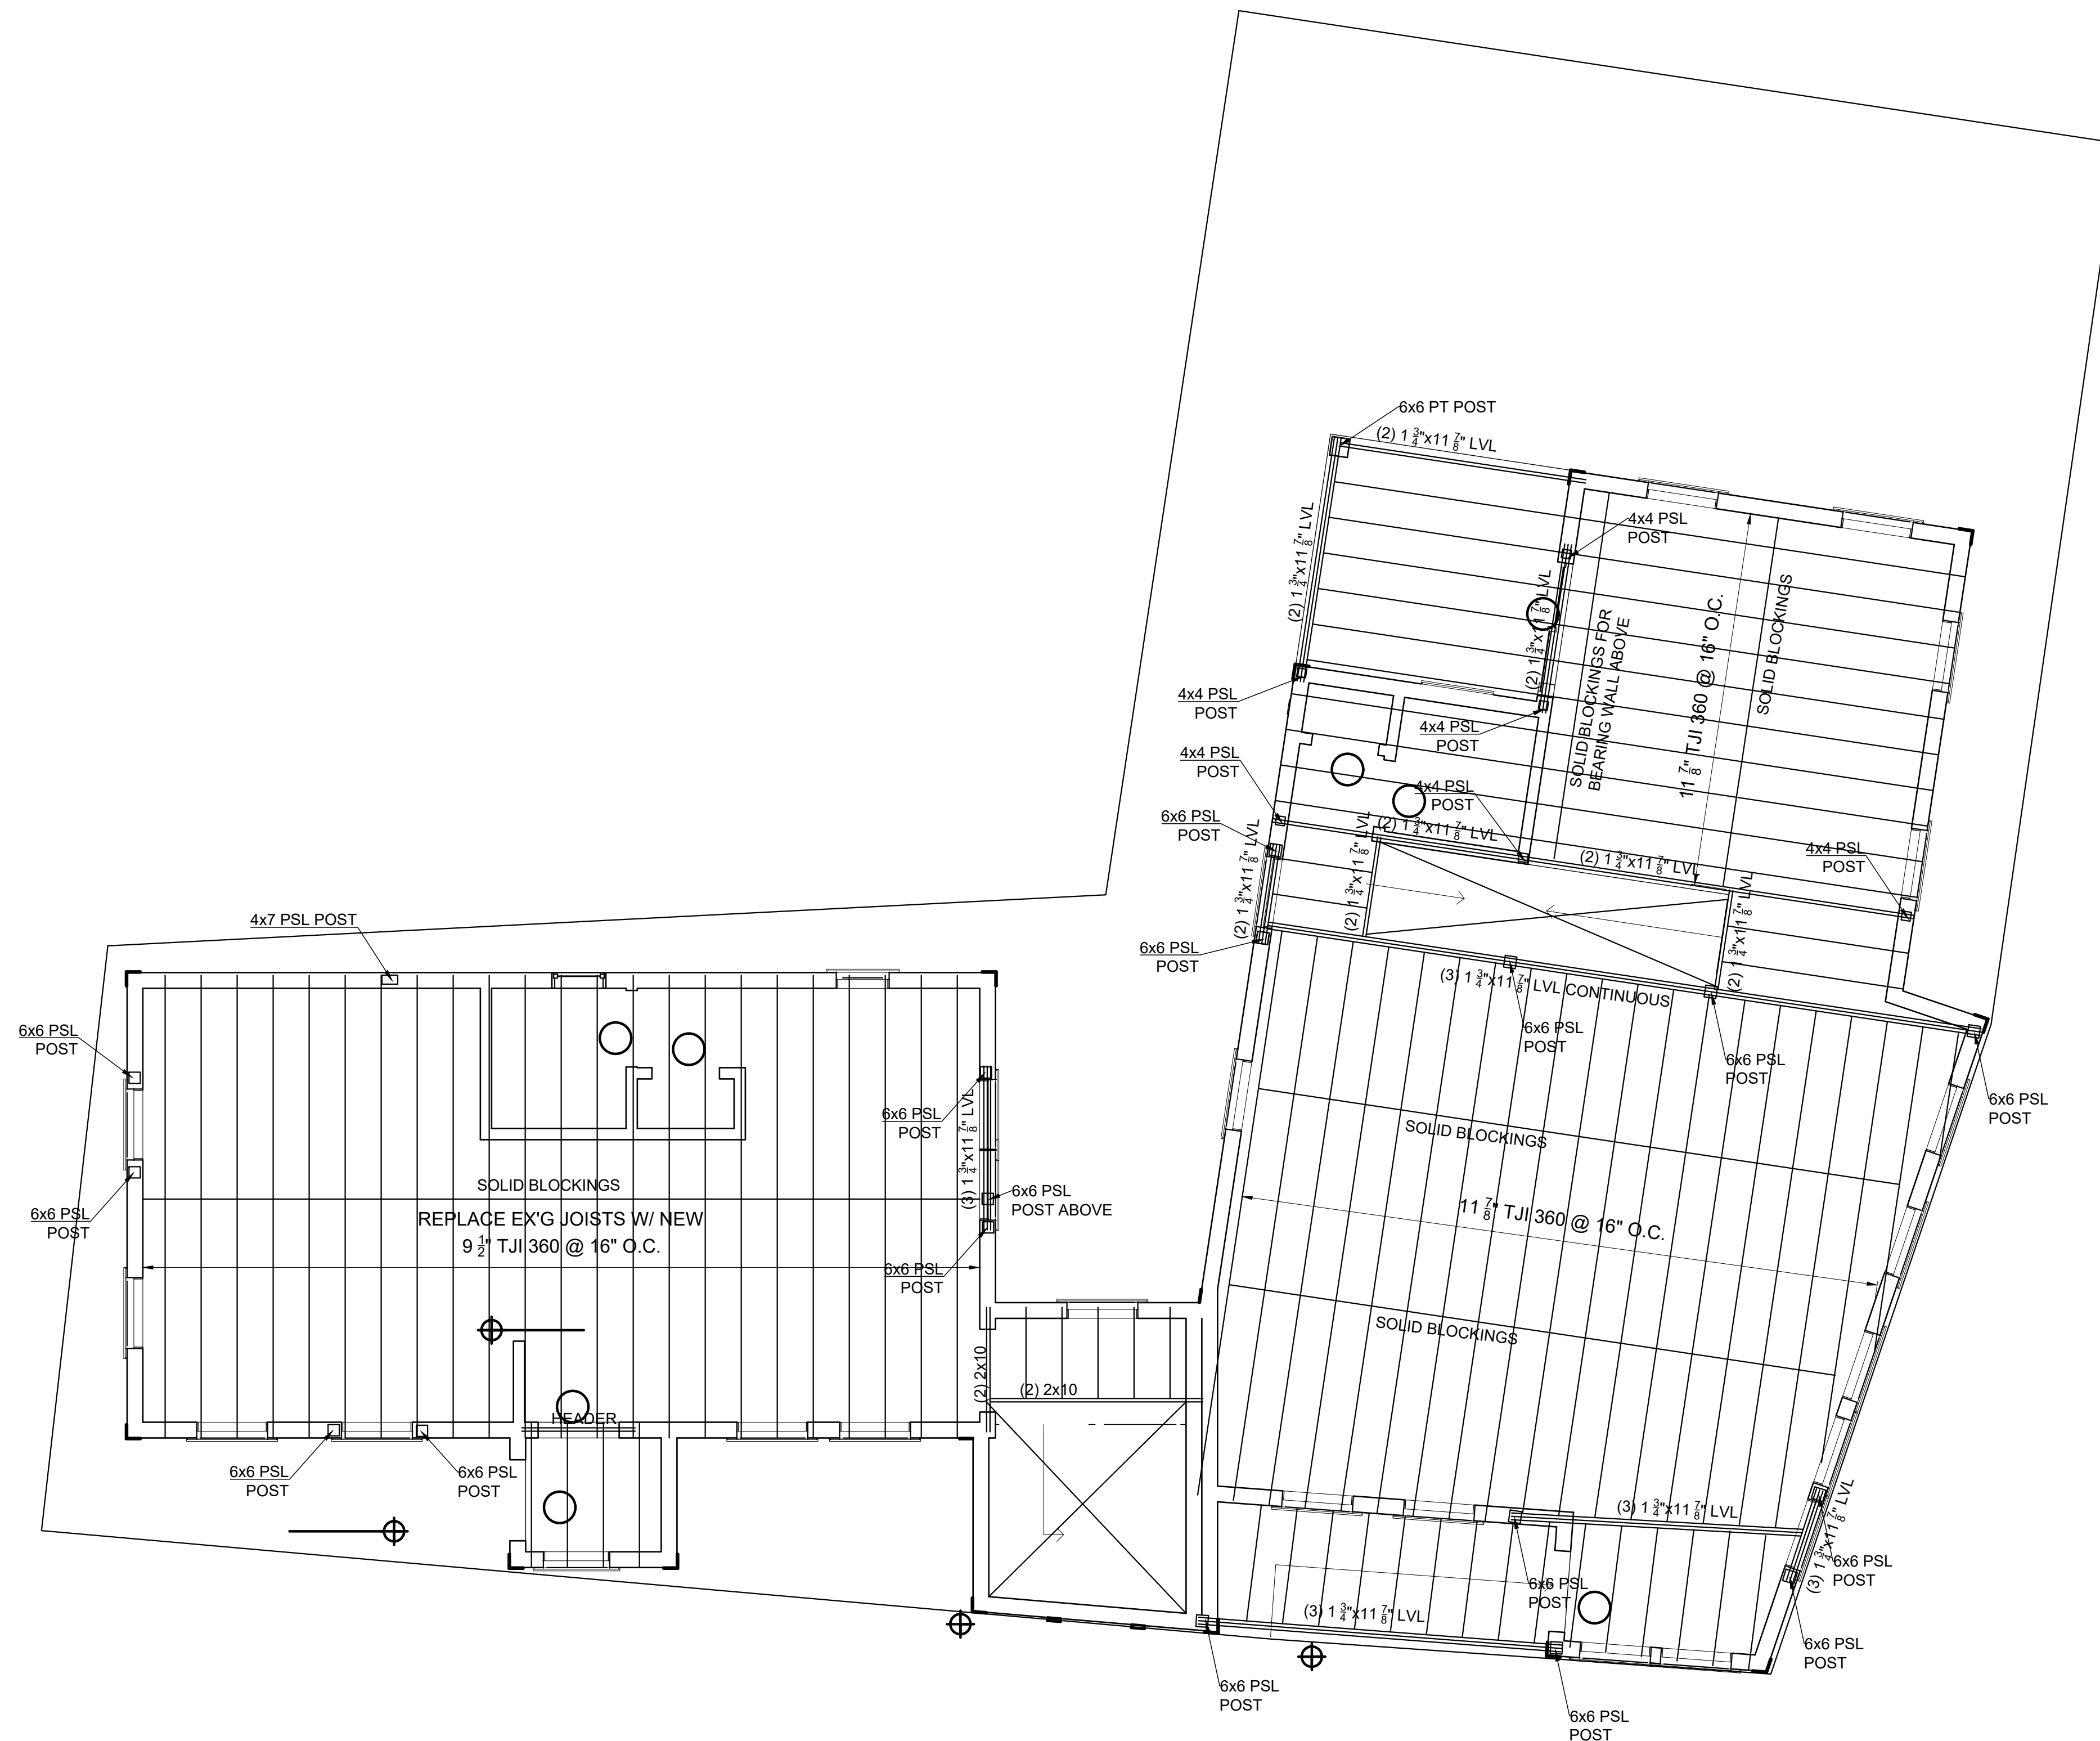

1 2ND FLOOR FRAMING PLAN  
1/4" = 1'-0"

Location

**PROPOSED RENOVATION &  
SEMI-ATTACHED ADDITION**  
6-8 NEAREN ROW,  
CHARLESTOWN, MA, 02129

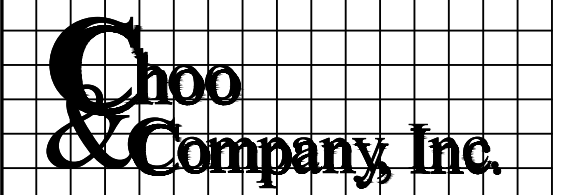

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No.	Revision Date

Project No: 2023112  
Scale: AS NOTED  
Date: 9-6-2023  
Drawn By: AC

Drawing Name  
**FRAMING  
PLAN**

Sheet No.  
**S-1.3**


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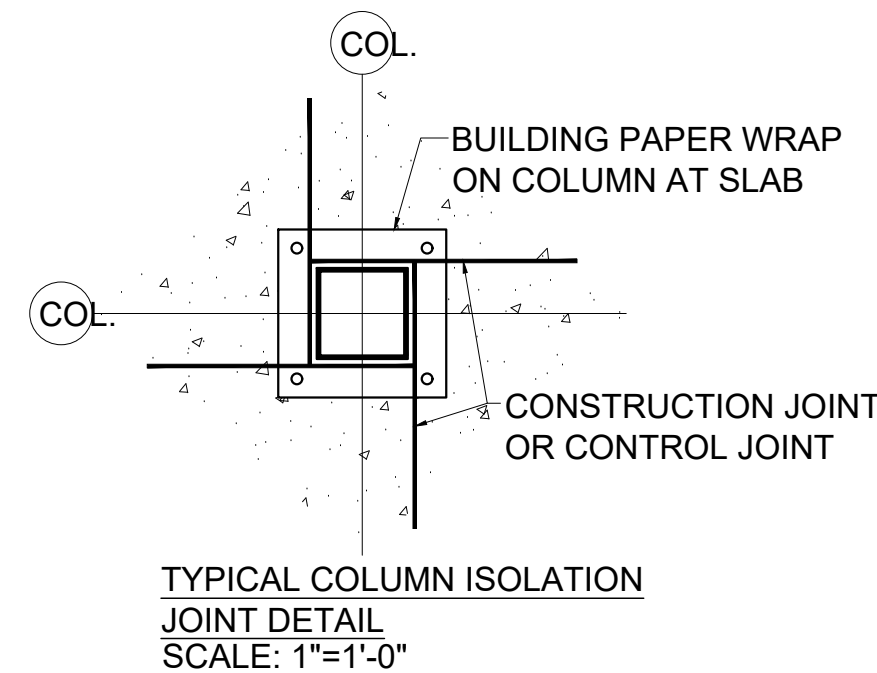
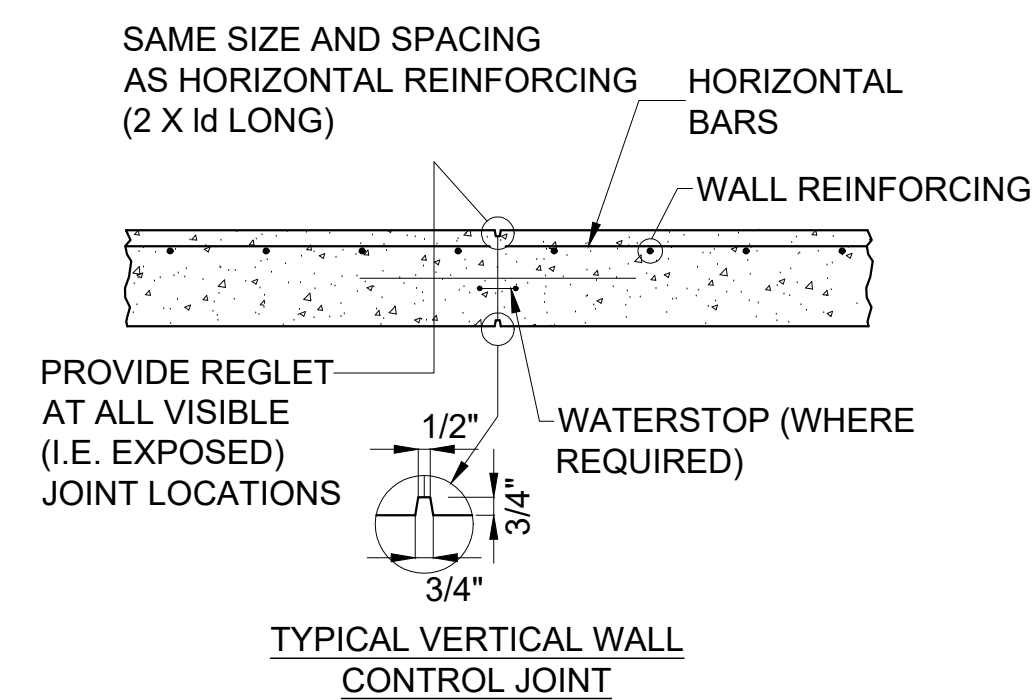










TYPICAL PLAN OF HORIZONTAL WALL REINFORCING

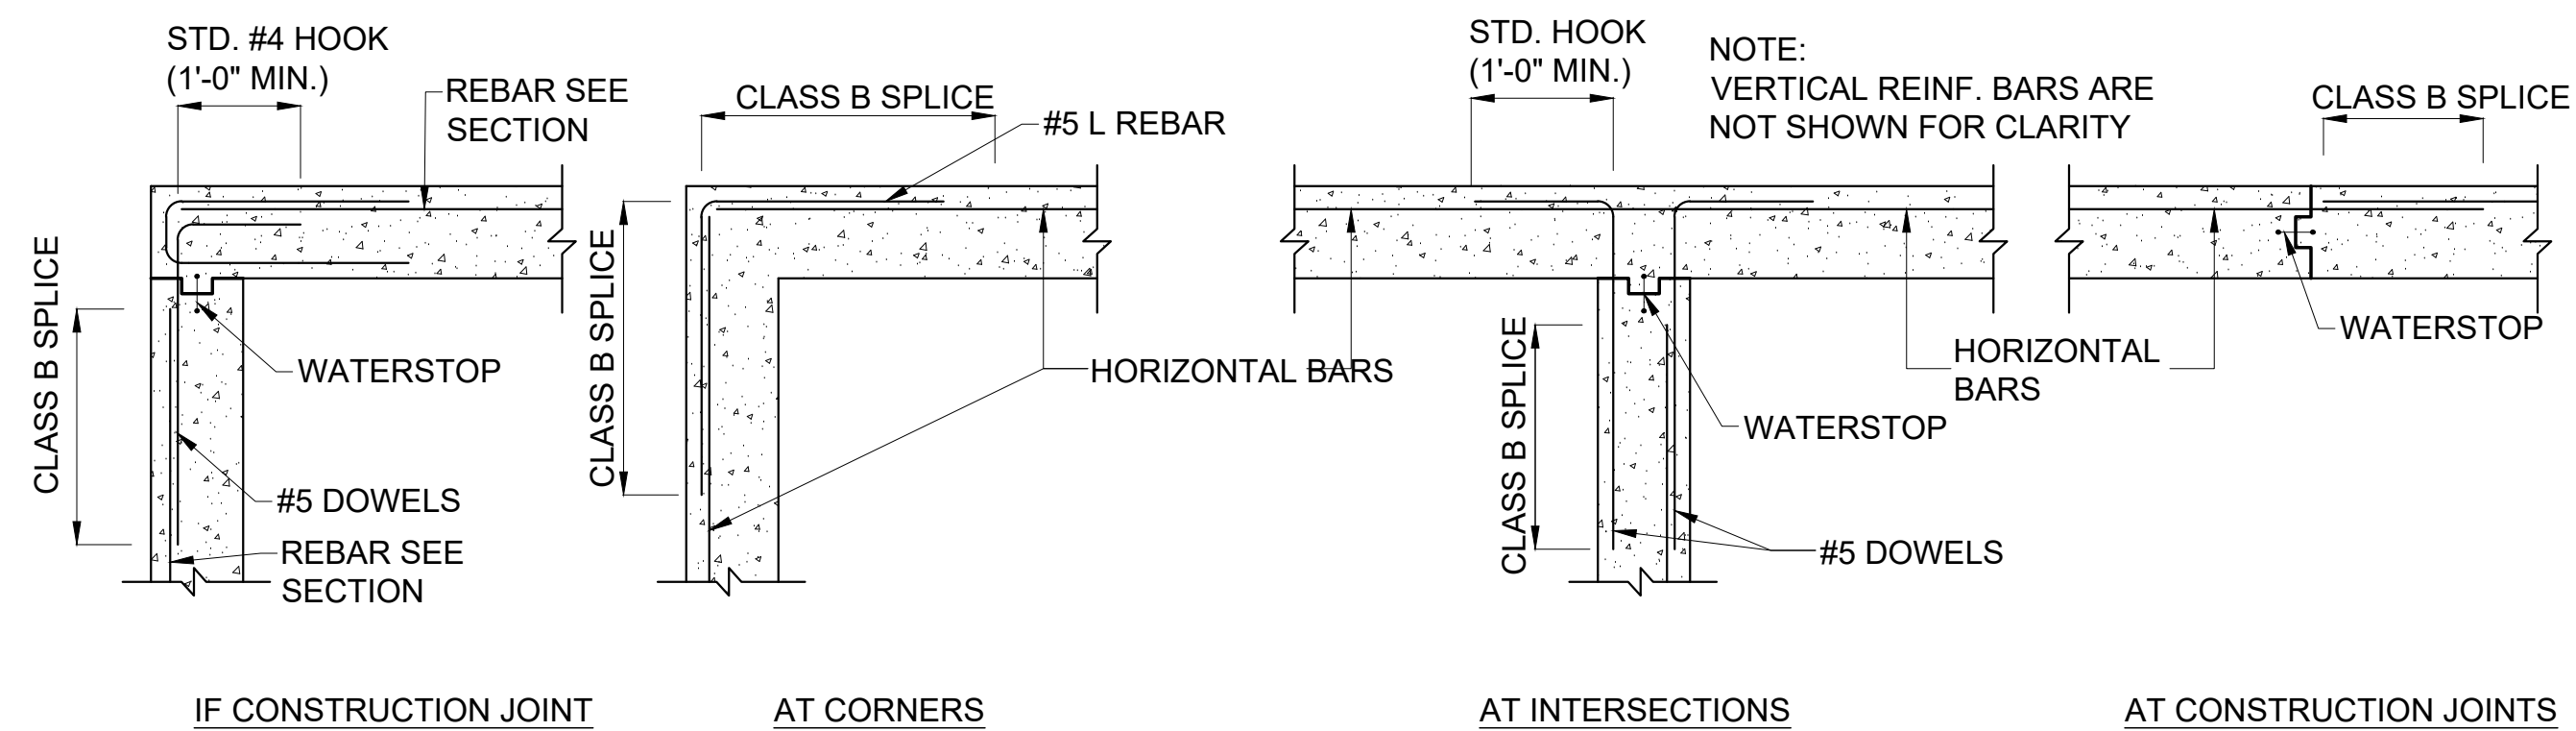

1 FOOTING DETAILS  
 1/2" = 1'-0"

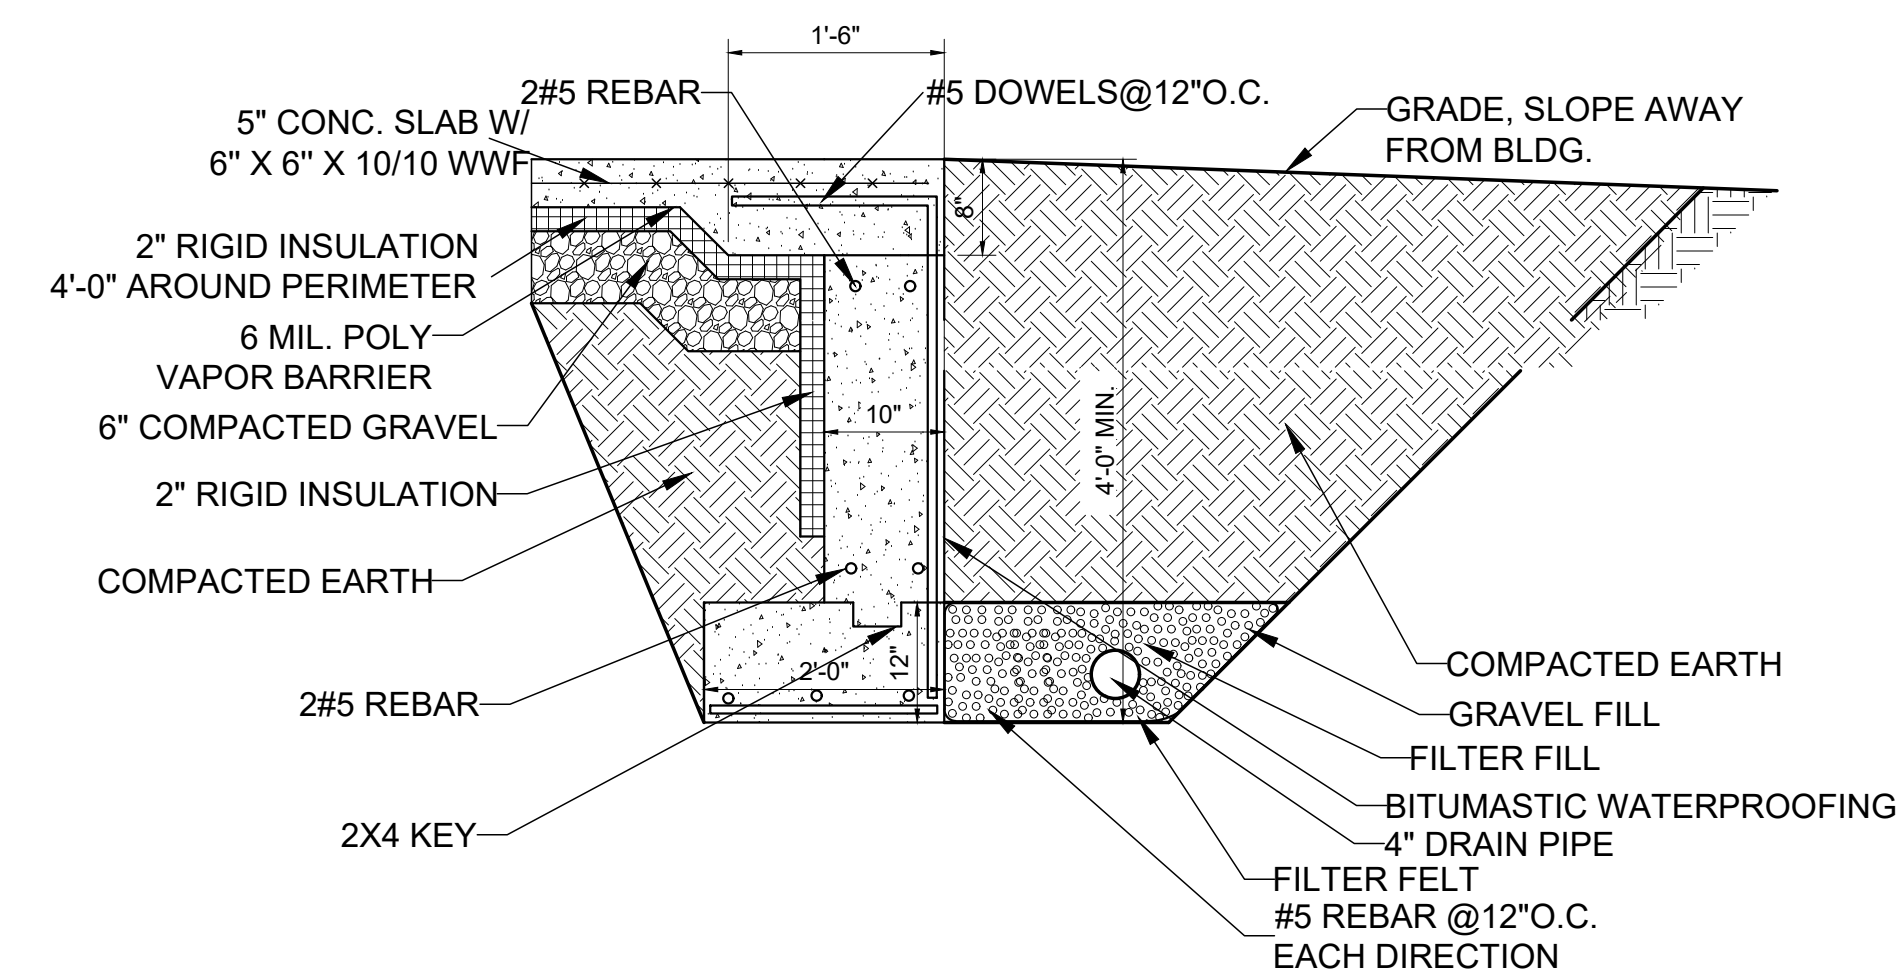

2 GARAGE ENTRANCE SECTION  
 1/2" = 1'-0"

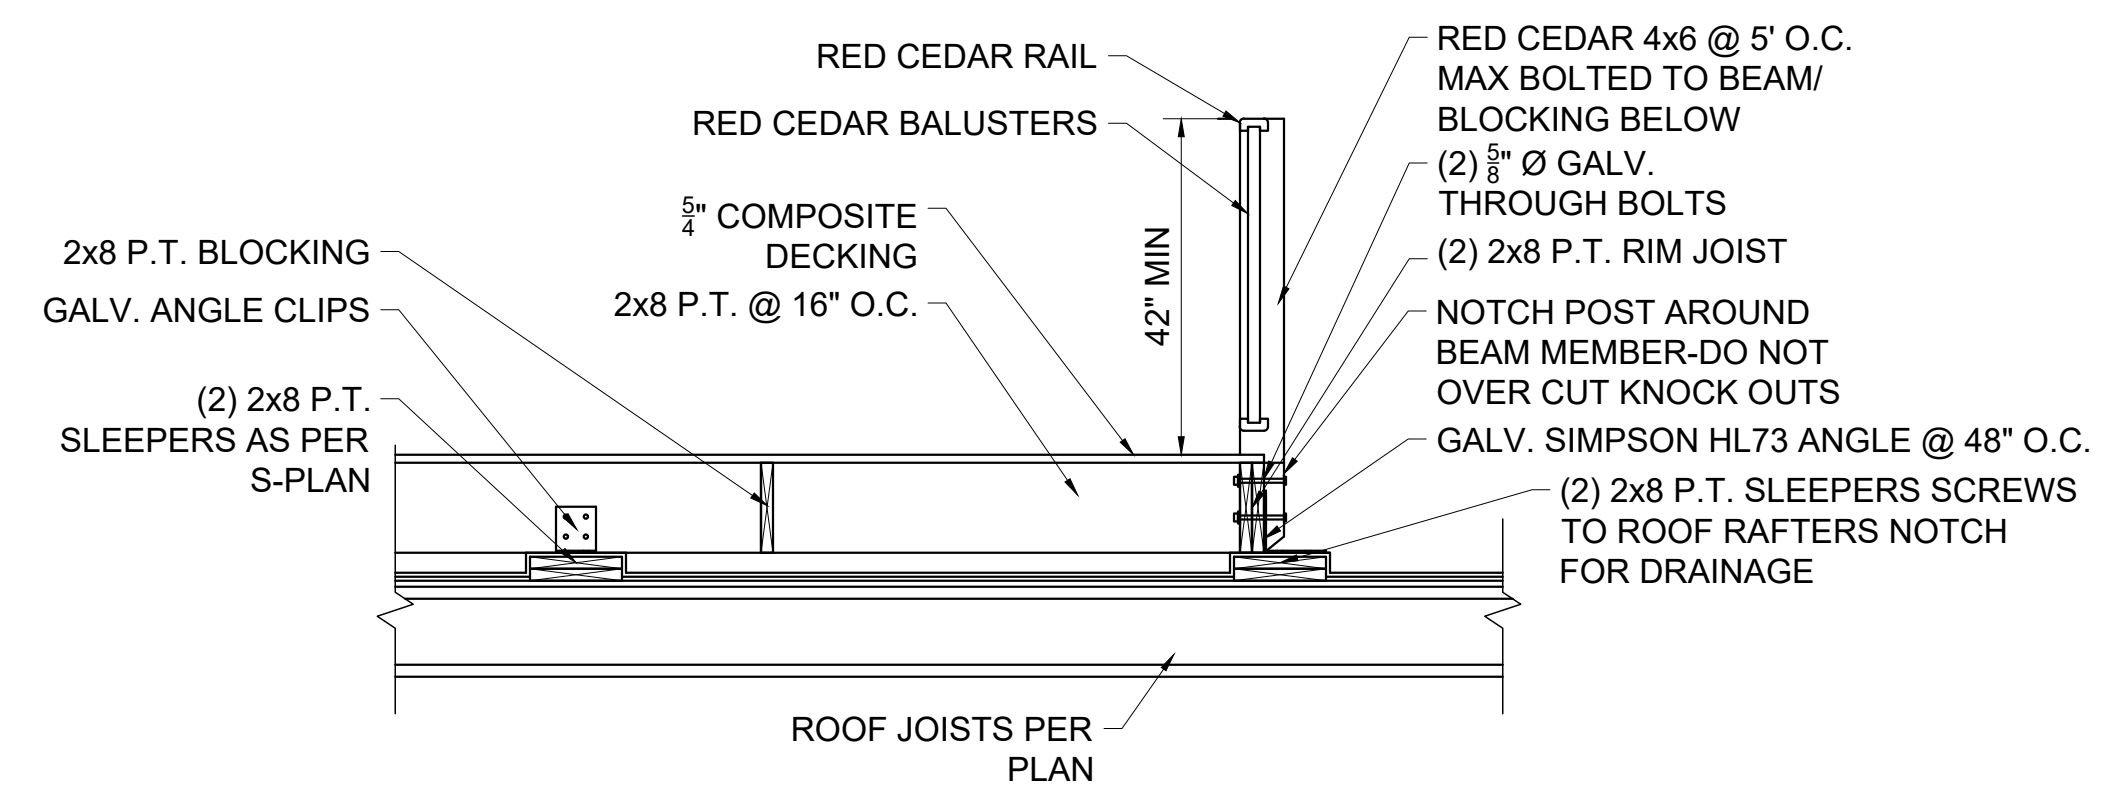

3 ROOF DECK SECTION  
 1/2" = 1'-0"

Location

**PROPOSED RENOVATION & SEMI-ATTACHED ADDITION**  
**6-8 NEAREN ROW,**  
**CHARLESTOWN, MA, 02129**

**Choo & Company, Inc.**

One Billings Road Quincy, MA 02171  
 617-786-7727 fax 617-786-7715

No.	Revision Date

Project No: 2023112  
 Scale: AS NOTED  
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Drawing Name

**FRAMING DETAILS**

Sheet No.

**S-2.1**

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