OUTLINE SPECIFICATIONS

GENERAL CONDITIONS A SUMMARY OF WORK

WORK SHALL CONSIST OF ADDITIONS AND ALTERATIONS TO 189 GRAMPIAN WAY LOT 2B, BOSTON, MASS AS DEFINED, HEREIN, KNOW AS THE CONTRACT DOCUMENTS.

B. SUMMARY OF CONSTRUCTION PROCEDURE: 1. THE OWNER IS RESPONSIBLE FOR THE PREPARATION OF THE BUILDING AND SITE, AND FOR THE SELECTION AND FURNISHING OF CERTAIN MATERIALS AS NOTED IS THESE SPECIFICATIONS.

. THE CONTRACTOR SHALL BE RESPONSIBLE FOR THE WORK INDICATED ON THESE CONSTRUCTION 3. THE CONTRACTOR SHALL USE PARTICULAR CARE AND CAUTION IN EXCAVATION AND IN USAGE OF THE

CODES AND REGULATIONS

WORK AND MATERIALS SHALL CONFORM TO THE LATEST EDITIONS OF THE FOLLOWING CODES AND STANDARDS, AND ANY AND ALL REQUIREMENTS OF THE AUTHORITIES HAVING JURISDICTION: LATEST ADDITION OF THE COMMONWEALTH OF MASSACHUSETTS BUILDING CODE FOR ONE AND TWO FAMILY DWELLINGS; INTERNATIONAL RESIDENTIAL BUILDING CODE; INTERNATIONAL ELECTRIC CODE', NATIONAL FIRE PROTECTION ASSOCIATION; BUILDING OFFICIALS AND CODE ADMINISTRATORS.

MASSACHUSETTS 'STRETCH' ENERGY CODE: THE BUILDING OWNER\BUILDER SHALL HAVE AN INDEPENDENT CERTIFIED BUILDING ENERGY PROFESSIONAL PROVIDE A HERS (HOME ENERGY RATING SYSTEM) RATING. A HERS RATING SHALL BE SUBMITTED TO THE CODE OFFICIAL IN DRAFT FORM AT PLAN REVIEW STAGE, AND A FINAL FORM AT BUILDING COMPLETION.

 CONTRACTOR SHALL COMMENCE DEMOLITION AS SHOWN ON THE LOCUS PLANS. OWNER SHALL INFORM THE CONTRACTOR OF ANY MATERIALS TO BE SALVAGED.

1. ANCHOR BOLTS, NUTS, AND WASHERS SHALL CONFORM TO ASTM A-307, Q-563 AND F-436, AS APPICABLE. ALL METAL ITEMS TO BE USED IN FRAMING SUCH AS JOISTS HANGERS, POST ANCHORS AND BRACKETS SHALL BE HOT-DIPPED GALVANIZED IN ACCORDANCE WITH ASTM A-153. 2. SILL PLATE ANCHOR BOLTS SHALL BE SPACED 6'-0" O.C. MAX., AND 2'-0" MAX FROM CORNERS. 3. STRUCTURAL STEEL SHALL CONFORM TO ASTM A-36.

1. RAFTERS, JOISTS AND STUDS SHALL BE NO. 2 HEM-FIR OR SPRUCE-PINE-FIR, M/E+ 1600 MINIMUM FOR REPETITIVE MEMBERS. REFER TO STRUCTURAL ENGINEER FRAMING PLANS FOR SIZES. 2. ENGINEERED FLOOR JOISTS SHALL BE AJ25 JOISTS, FROM ALL JOISTS OR, TJI230 FROM I-LEVEL, OR APPROVED EQUAL, REFER TO FRAMING PLANS FOR SIZES.

3. SUBFLOOR SHALL BE 3/4" T & G PLYWOOD. INSTALL PANELS USING SCREW/ RING SHANK NAIL AND GLUE METHOD. AS PER APA STANDARDS. 4. LUMBER SHALL BE SOUND, SEASONED, AND KILN DRIED TO A MOISTURE CONTENT NOT TO EXCEED 19% 5. LUMBER IN CONTACT WITH CONCRETE AND MASONRY AND IN EXTERIOR APPLICATIONS SHALL BE CCA 0.40 PCF PRESSURE TREATED.

6. PROVIDE SILL SEALER AT SILL PLATE AND FOUNDATION AS MANUFACTURED BY CERTAINTEED OR EQUAL

1. CONCRETE WORK SHALL CONFORM TO THE LATEST EDITION OF THE STANDARDS, INCLUDING BUT NOT LIMITED TO

2. CONCRETE SHALL ATTAIN 3,000 PSI MINIMUM COMPRESSION STRENGTH AT 28 DAYS.

3. CONCRETE SHALL BE PLACED WITHOUT HORIZONTAL AND VERTICAL CONSTRUCTION JOINTS, EXCEPT WHERE

4. REINFORCING STEEL SHALL CONFIRM TO ASTM-615, GRADE 60 DEFORMED BARS.

1. FOUNDATION AND EXCAVATION SHALL BE CARRIED DOWN TO UNDISTURBED NATURAL GRAVEL OR COMPACTED GRAVELFILL OR 2 TSF BEARING CAPACITY MATERIALS. NO FOOTING SHALL BE PLACED IN WATER OR ON FROZEN GROUND.

3. IN GENERAL, EXTERIOR BUILDING WALL FOOTINGS SHALL BE CARRIED DOWN A MINIMUM OF 4'-0" BELOW GRADE. 4. ALL FOOTING EXCAVATIONS SHALL BE FINISHED BY HAND.

5. PROVIDE DAMPROOFING ON EXTERIOR OF FOUNDATION WALL BELOW GRADE. 6. PROVIDE CONTINUOUS 4" PERFORATED FOOTING DRAIN TILE AT PERIMETER OF FOUNDATION WITH 12" OF

CRUSHED GRAVEL TO NEW DRYWELL. DRYWELL LOCATION IS TO BE DETERMINED IN FIELD. 7. PROVIDE 4 MIL VAPOR BARRIER UNDER BASEMENT CONCRETE SLAB.

1. EXTERIOR SIDING SHALL BE PREMIUM GRADE RED CEDAR CLAPBOARD SIDING WITH 6" EXPOSURE, OR TO MATCH EXISTING SIDING. CORNER BOARD SHALL BE 5/4" X 6" AZEK TRIM BOARDS. 2. EXTERIOR SHEATHING SHALL BE APA EXP-1, ½" CDX 16/0 PLYWOOD. INSTALL SHEATHING WITH FACE GRAIN PERPENDICULAR TO STUDS.

3. AIR INFILTRATION BARRIER SHALL BE TYVEK MANUFACTURED BY DUPONT, OR APPROVED EQUAL. 4. EXTERIOR WALL CONSTRUCTION SHALL BE STUD GRADE 2x6 WOOD STUDS SPACED 16" ON CENTER. 5. VAPOR BARRIER SHALL BE A CONTINUOUS 6 MIL. POLYETHYLENE SHEET ON INTERIOR SIDE OF STUDS. 6. WINDOW HEAD AND TRIM FLASHING SHALL BE 20 GAGE ALUMINUM Z STRIPS. 7. EXTERIOR TRIM SHALL MATCH EXISITNG HOUSE, OR SHALL BE 1x, 5/4x AND AZM-217 BAND MOLDED TRIM AS BY AZEK.

B. SEALANT/ CAULKING AT WINDOWS AND DOORS SHALL BE TREMCO POLYSULFIDE OR BUTYL RUBBER,

TYPICAL ROOF STRUCTURE

1. ROOFING SHINGLES SHALL BE ASPHALT/ FIBERGLAS SHINGLES, 50 YEAR AS MANUFACTURED BY OWENS/ CORNING. ROOFING SHINGLES SHALL MATCH EXISTING HOUSE. 2. UNDERLAYMENT SHALL BE 15 LB. ASPHALT FELT, ASTM D-226.

3. PROVIDE W.R. GRACE "ICE AND WEATHER SHIELD" WATERPROOFING MEMBRANE AT LEAST 36" OVER HEATED SPACE AT EAVES. ROOFS WITH PITCHES LOWER THAN 3 ON 12 SHALL BE COMPLETELY COVERED WITH WATERPROOFING MEMBRANE. 4. ROOF SHEATHING SHALL BE 5/8" APA RATED PLYWOOD, EXPOSURE 1.

5. RAFTERS SHALL BE NO.2 DOUGLAS FIR-LARCH OR SPRÜCE-PINE-FIR, M/E= 1600 MINIMUM FOR REPETITIVE MEMBERS. REFER TO STRUCTURAL ENGINEER FRAMING PLANS FOR SIZES 6. EAVE DRIP EDGE AND RAKE EDGE SHALL BE 16 GAGE ALUMINUM. PROVIDE 10 FOOT MINIMUM

7. FLASHING SHALL BE 20 GAGE ALUMINUM. 8. EAVE SOFFIT VENTS, WHERE REQUIRED, SHALL BE S-400 CONTINUOUS PERFORATED VENTS AS MANUFACTURED BY COR-A-VENT.

NSTALL SPRAY-ON FOAM INSULATION AT ALL APPLICATIONS: -PROVIDE CLOSED CELL SPRAY-ON FOAM INSULATION AT EXTERIOR WALL OF ADDITION. R: 36. -PROVIDE OPEN CELL SPRAY-ON FOAM INSULATION AT BASEMENT CEILING. R: 30 MIN. -PROVIDE CLOSED CELL SPRAY-ON FOAM INSULATION TO RAFTERS. R: 44. APPLY CLOSED CELL FOAM DIRECTLY TO UNDERSIDE OF ROOF SHEATHING. PROVIDE APPROVED FIRE RETARDANT INTUMESCENT COATING OR PAINT TO EXPOSED SIDE OF CLOSED CELL FOAM

1. ALL INTERIOR AND EXTERIOR PAINTING AND STAINING SHALL BE BENJAMIN MOORE. 2. STAINED SURFACES SHALL RECEIVE ONE SATIN FINISH COAT OF POLYURETHANE. 3. ALL COLORS SHALL BE SELECTED BY OWNER/ ARCHITECT.

1. EXTERIOR ENTRY DOORS SHALL BE BY SIMPSON. SEE SCHEDULE FOR TYPE. 2. INTERIOR 4 PANEL COLONIAL STYLE DOORS SHALL BE BY JELD-WEN OR APPROVED EQUAL. SEE SCHEDULE FOR STYLE AND SIZES. 3. PROVIDE ALL HINGES BUTTS, KNOBS AND OTHER HARDWARE NECESSARY FOR INSTALLATION OF

4. OWNER SHALL PROVIDE LOCKSETS FOR INTERIOR DOORS. CONTRACTOR SHALL PROVIDE LOCKSETS FOR EXTERIOR DOORS.

1. WINDOWS SHALL BE ANDERSEN 200 SERIES VINYL CLAD WOOD WINDOWS, WITH LOW E II GLAZING.
2. SEE WINDOW SCHEDULE FOR SIZES AND SPECIFICATIONS.

ELECTRICAL

1. ALL ROUGH ELECTRICAL WORK SHALL BE CARRIED OUT BY LICENSED ELECTRICIANS AND WITHIN THE LAWS OF THE MASS. BUILDING AND ELECTRIC CODES. 2. ELECTRICIAN SHALL VERIFY THAT THERE IS 200 AMP SERVICE IN BASEMENT.

3. DURING ROUGH-IN PHASE THE OWNER SHALL REVIEW ALL SWITCH, LIGHTING AND OUTLET LOCATIONS WITH ELECTRICIAN PRIOR TO INSTALLATION. 4. ALL OUTLETS, SWITCHES AND PLATES TO BE LUTRON DIVA SERIES, COLOR WHITE. DIMMERS TO BE

MAESTRO, SUPPLIED BY ELECTRICIAN. PROVIDE CABLE TV CONNECTIONS. 5. FINISH LIGHTING FIXTURES SHALL BE FURNISHED BY OWNER, INSTALLED BY ELECTRICIAN. 6. RECESSED LIGHTING SHALL BE PROVIDED AND INSTALLED BY G.C. 7. PROVIDE HARD WIRED SMOKE DETECTORS AND CO2 DETECTORS AS REQUIRED BY MASS. STATE

8. OWNER SHALL BE RESPONSIBLE FOR ALARM SYSTEM. 9. OWNER SHALL BE RESPONSIBLE FOR AUDIO/VIDEO SYSTEMS.

10. LIGHTING PROVIDED BY ELECTRICIAN SHALL INCLUDE: -LOW VOLTAGE UNDER COUNTER LIGHITNG IN KITCHEN - 4" HALO LED RECESSED LIGHTS IN INTERIOR

-8 RECESSED EXTERIOR LIGHTS AT PORCHES AND GARAGE SOFFIT PROVIDE DIMMERS FOR ALL LOCATIONS.

1. PROVIDE NEW FORCED AIR HEATING AND COOLING HEATING SYSTEMS. CONTRACTOR SHALL DESIGN & SIZE SYSTEM TO MEET ACCEPTABLE HEATING REQUIREMENTS SET FORTH BY TEH MASSACHUSETTS STATE BUILDING CODE. 2. PROVIDE 1 SEPARATE SYSTEMS FOR IN-LAW APARTMENT

3.CONTRACTOR SHALL REMOVE EXISTING BOILER. AND PROVIDE HIGH EFFECIENCY BOILER FOR HOT WATER AND TO RUN TO AIRHANDLER FOR HEAT.

4. ALL ROUGH PLUMBING SHALL BE CARRIED OUT BY LICENCED PLUMBERS AND WITHIN THE LAWS OF THE MASS. BUILDING AND PLUMBING CODES.

5. PROVIDE INSULATED DUCTWORK WITH BOLTED CONNECTIONS.

6. PLUMBING FIXTURES FOR BATH SHALL BE FURNISHED BY OWNER, INSTALLED BY CONTRACTOR.

1. GYPSUM WALL BOARD SHALL CONFORM TO ASTM C-36, BY U.S. GYPSUM CO., OR NATIONAL GYPSUM CO.. 2. INTERIOR WALL BOARD FINISH SHALL BE 1/2" GYPSUM BLUEBOARD WITH SKIM COAT PLASTER

3. WHERE FIRE RATING IS REQUIRED, GYPSUM WALL BOARD SHALL BE 5/8" THICK FIRECODE X. 4. PROVIDE ALL STANDARD ACCESSORIES TO FINISH WORK. 5. WALL AND FLOOR BOARD IN BATHROOM AT ALL TILE APPLICATIONS, INCLUDING SHOWER CEILINGS, SHALL BE DUROCK 1/2" CEMENT BOARD.

BATH VANITY and WETBAR CABINETRY

1. VANITY FOR BATH AND CABINETRY FOR WETBAR SHALL BE PROVIDED BY OWNER, INSTALLED BE CONTRACTOR. OWNER SHALL FURNISH ALL HARDWARE, SINKS, FAUCETS AND COUNTERTOPS. 2. COUNTERTOPS SHALL BE FURNISHED AND INSTALLED BY OWNER.

SHOWER DOOR SYSTEM

1. SHOWER DOORS AND PARTITIONS SHALL BE AS PER MISTER SHOWER DOOR, OASIS SHOWER DOORS, OR EQUAL, SHOWER GLASS SHALL BE PROVIDED AND INSTALLED BY G.C. 2. BATH SHOWER PARTITION SHALL BE BUTT GLAZE TYPE WITH CRYSTAL CLEAN GLASS.

STONE TILE 1. STONE TILE SHALL BE FURNISHED BY OWNER, INSTALLED BY GENERAL CONTRACTOR.

SCOPE OF WORK SHALL INCLUDE: -MASTER BATH ROOM FLOORS, SHOWER WALLS

2. TILE TO BE INSTALLED IN ACCORDANCE WITH STANDARDS SET BY THE TILE COUNCIL OF AMERICA, INC., USING CEMENTIOUS MORTAR BED FOR SETTING TILES. 3. PROVIDE ALL GROUT AND ACCESSORIES TO COMPLETE THE WORK. GROUT COLOR TO BE SELECTED AND APPROVED BY OWNER/ ARCHITECT.

CERAMIC TILE

1. CERAMIC TILE FOR ALL BACKSPLASHS AND ALL BATHROOMS SHALL BE FURNISHED BY OWNER, INSTALLED BY GENERAL CONTRACTOR.

2. TILE TO BE INSTALLED IN ACCORDANCE WITH STANDARDS SET BY THE TILE COUNCIL OF AMERICA, INC., USING CEMENTIOUS MORTAR BED FOR SETTING TILES. 3. PROVIDE ALL GROUT AND ACCESSORIES TO COMPLETE THE WORK. GROUT COLOR TO BE SELECTED AND APPROVED BY OWNER/ ARCHITECT.

DEMOLITION NOTES

2 REMOVE AND STORE INTERIOR DOOR, TO BE

4. REMOVE PORCH STAIRS AS SHOWN

5. REMOVE UTILITIES AND MECHANICAL SYSTEMS

6. REMOVE MAIN STAIRCASE AND STORE, PARTS TO

7. REMOVE INTERIOR PARTITIONS AS INDICATED. SEE PROPOSED FLOOR PLANS FOR NEW WALLS.

8. REMOVE EXTERIOR WALL AND WINDOWS FOR NEW

10. REMOVE BRICK CHIMNEY FROM ROOF ITS

11. REMOVE CONSERVATORY IN ITS ENTIRETY

NEW PLUMBING

14. REMOVE BRICK CHIMNEY FROM ROOF TO SECOND

DEMOLITION SCOPE SHALL INCLUDE:

1.REMOVE ALL EXISTING WINDOWS AND DOORS AS INDICATED ON DEMOLITION PLANS.

3. REMOVE STAIRCASE IN ITS ENTIRETY


9. REMOVE FLOOR FRAMING IN SHADED AREA.


12. REMOVE EXTERIOR WALL FOR NEW OPENING

13.REMOVE CONCRETE FLOOR AS REQUIRED FOR

15. REMOVE WALL AS REQUIRED FOR NEW OPENING


FLOOR LINE

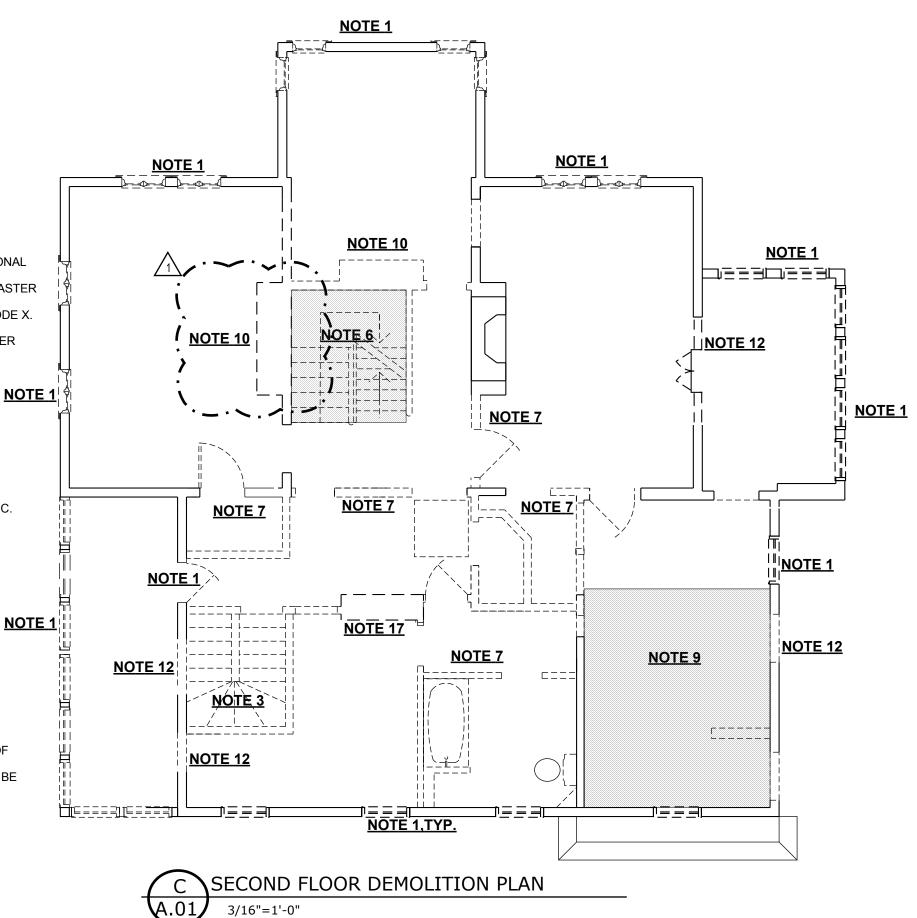

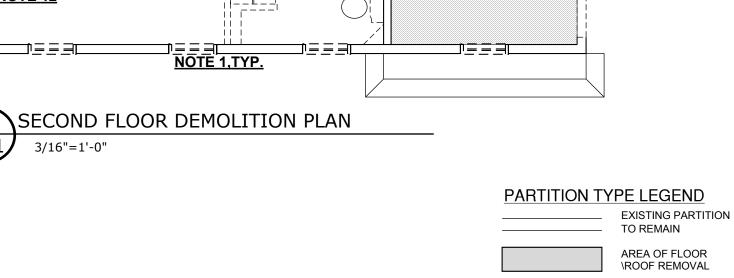

_ _ _ _ -

— — — - BE REMOVED

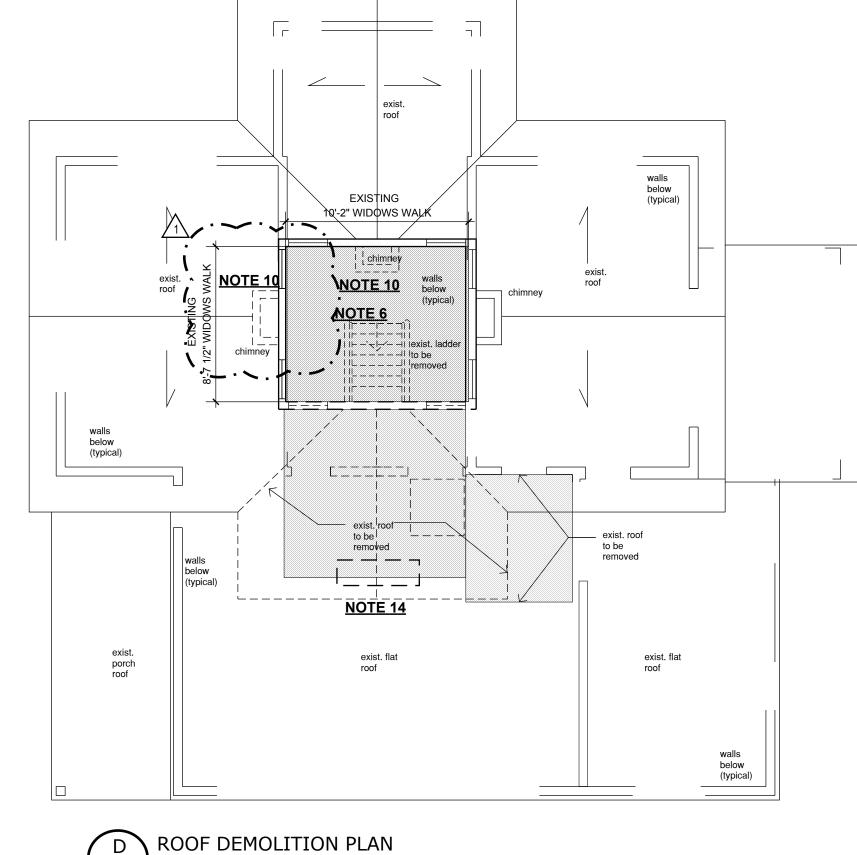

3/16"=1'-0"

NOTE 11

NOTE 10

NOTE 6

NOTE 2

TYP.

FIRST FLOOR DEMOLITION PLAN

3/16"=1'-0"

NOTE 9

NOTE 7

NOTE 7

NOTE 2



当NOTE 1

NOTE 1

NOTE 7

NOTE 1

NOTE 1

NOTE 8


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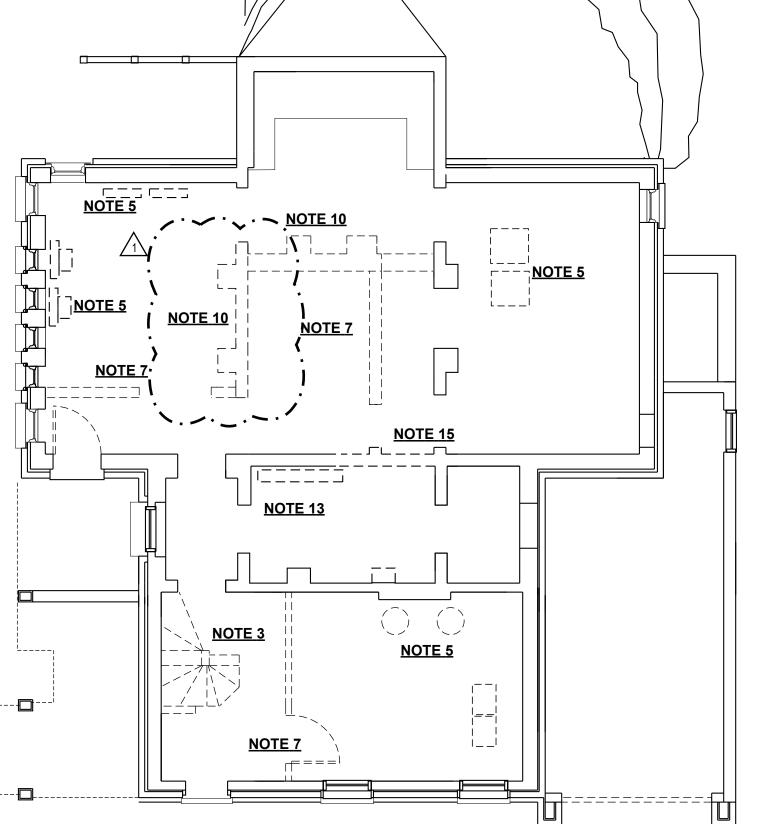
rampian

PROJECT 2019.16










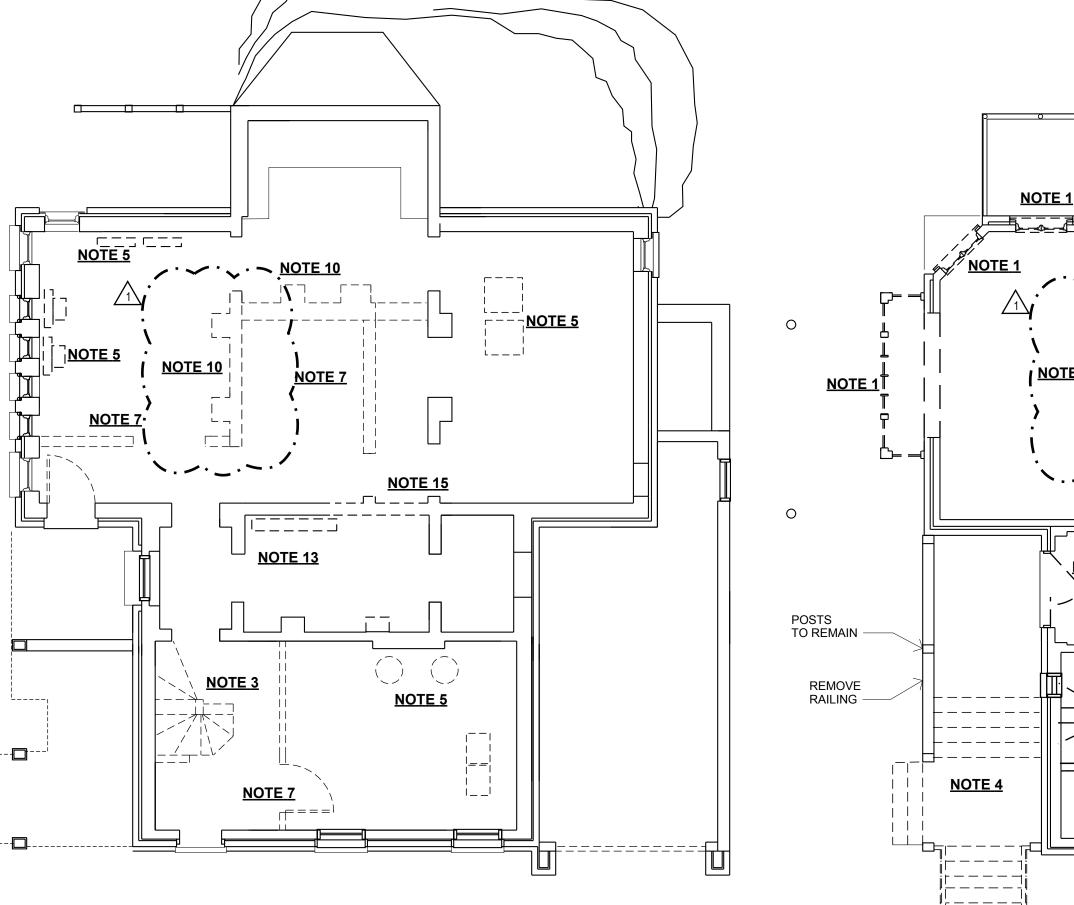


BASEMENT DEMOLITION PLAN

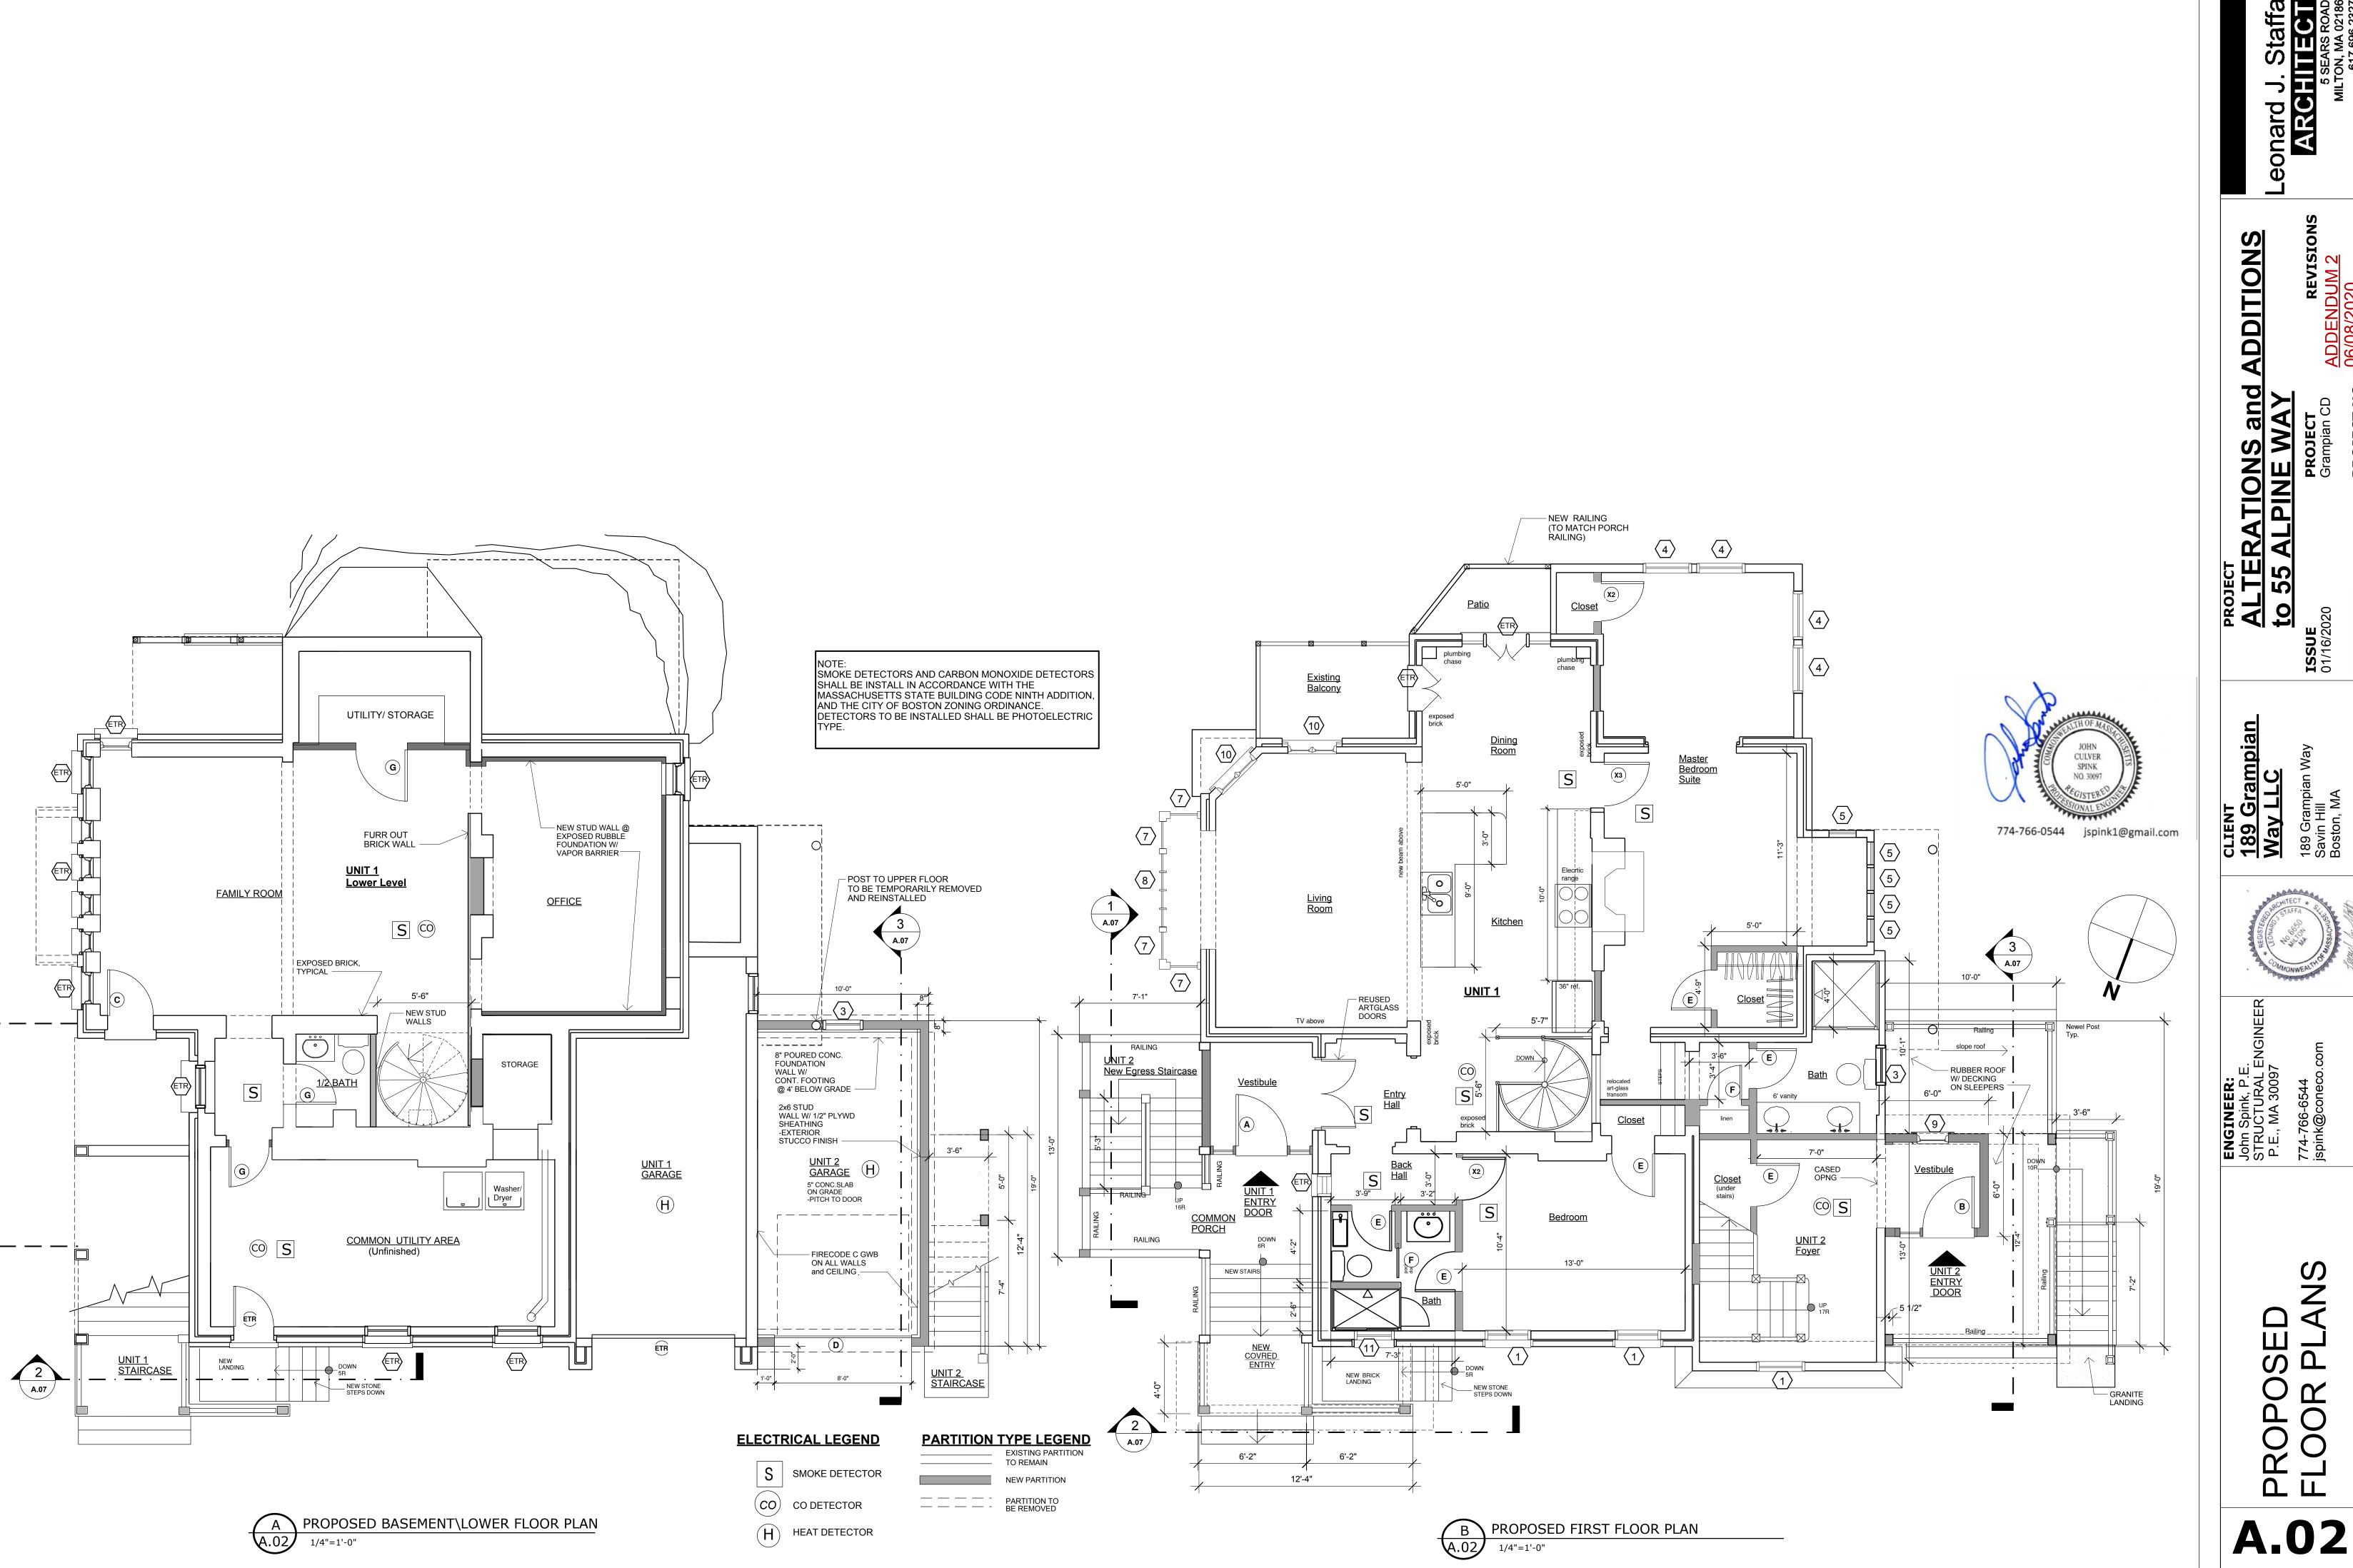

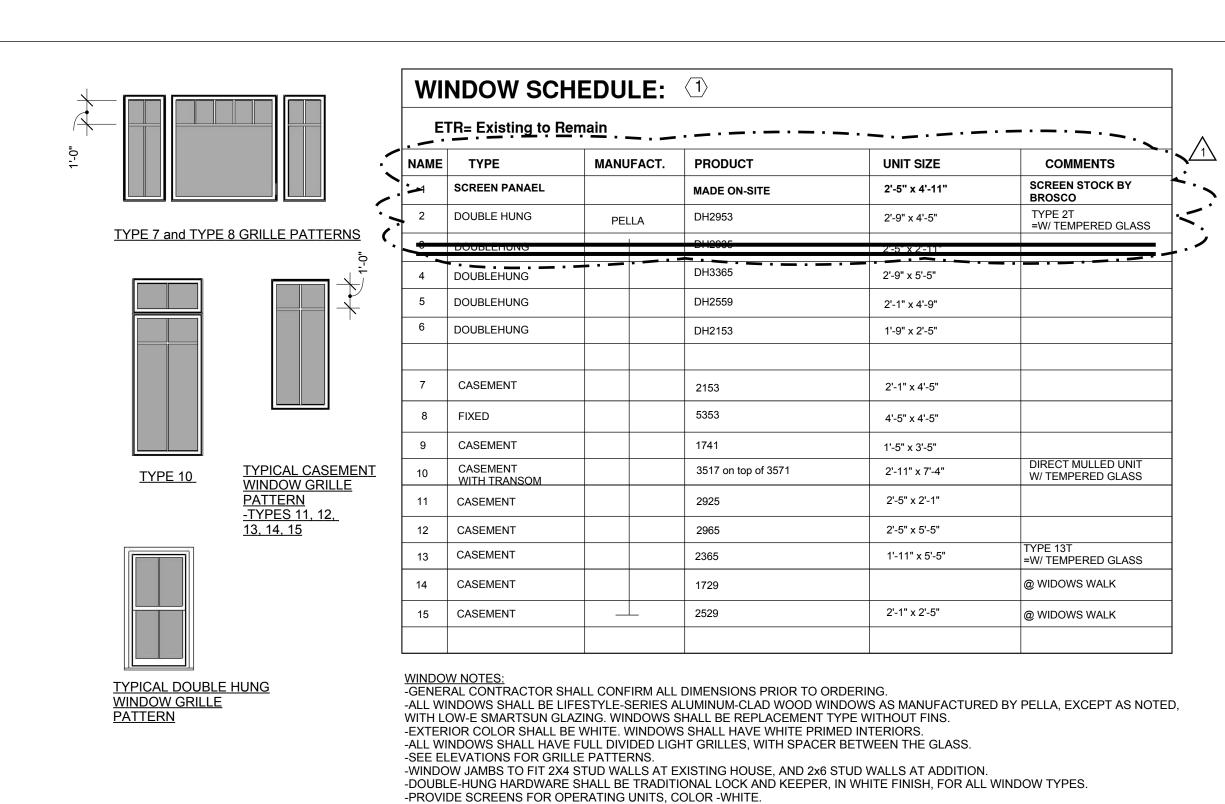

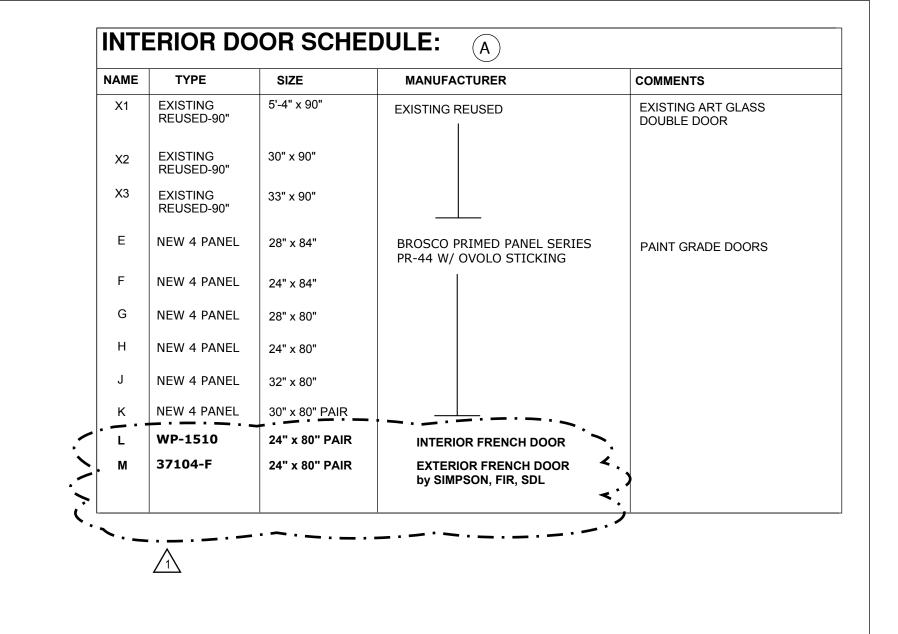

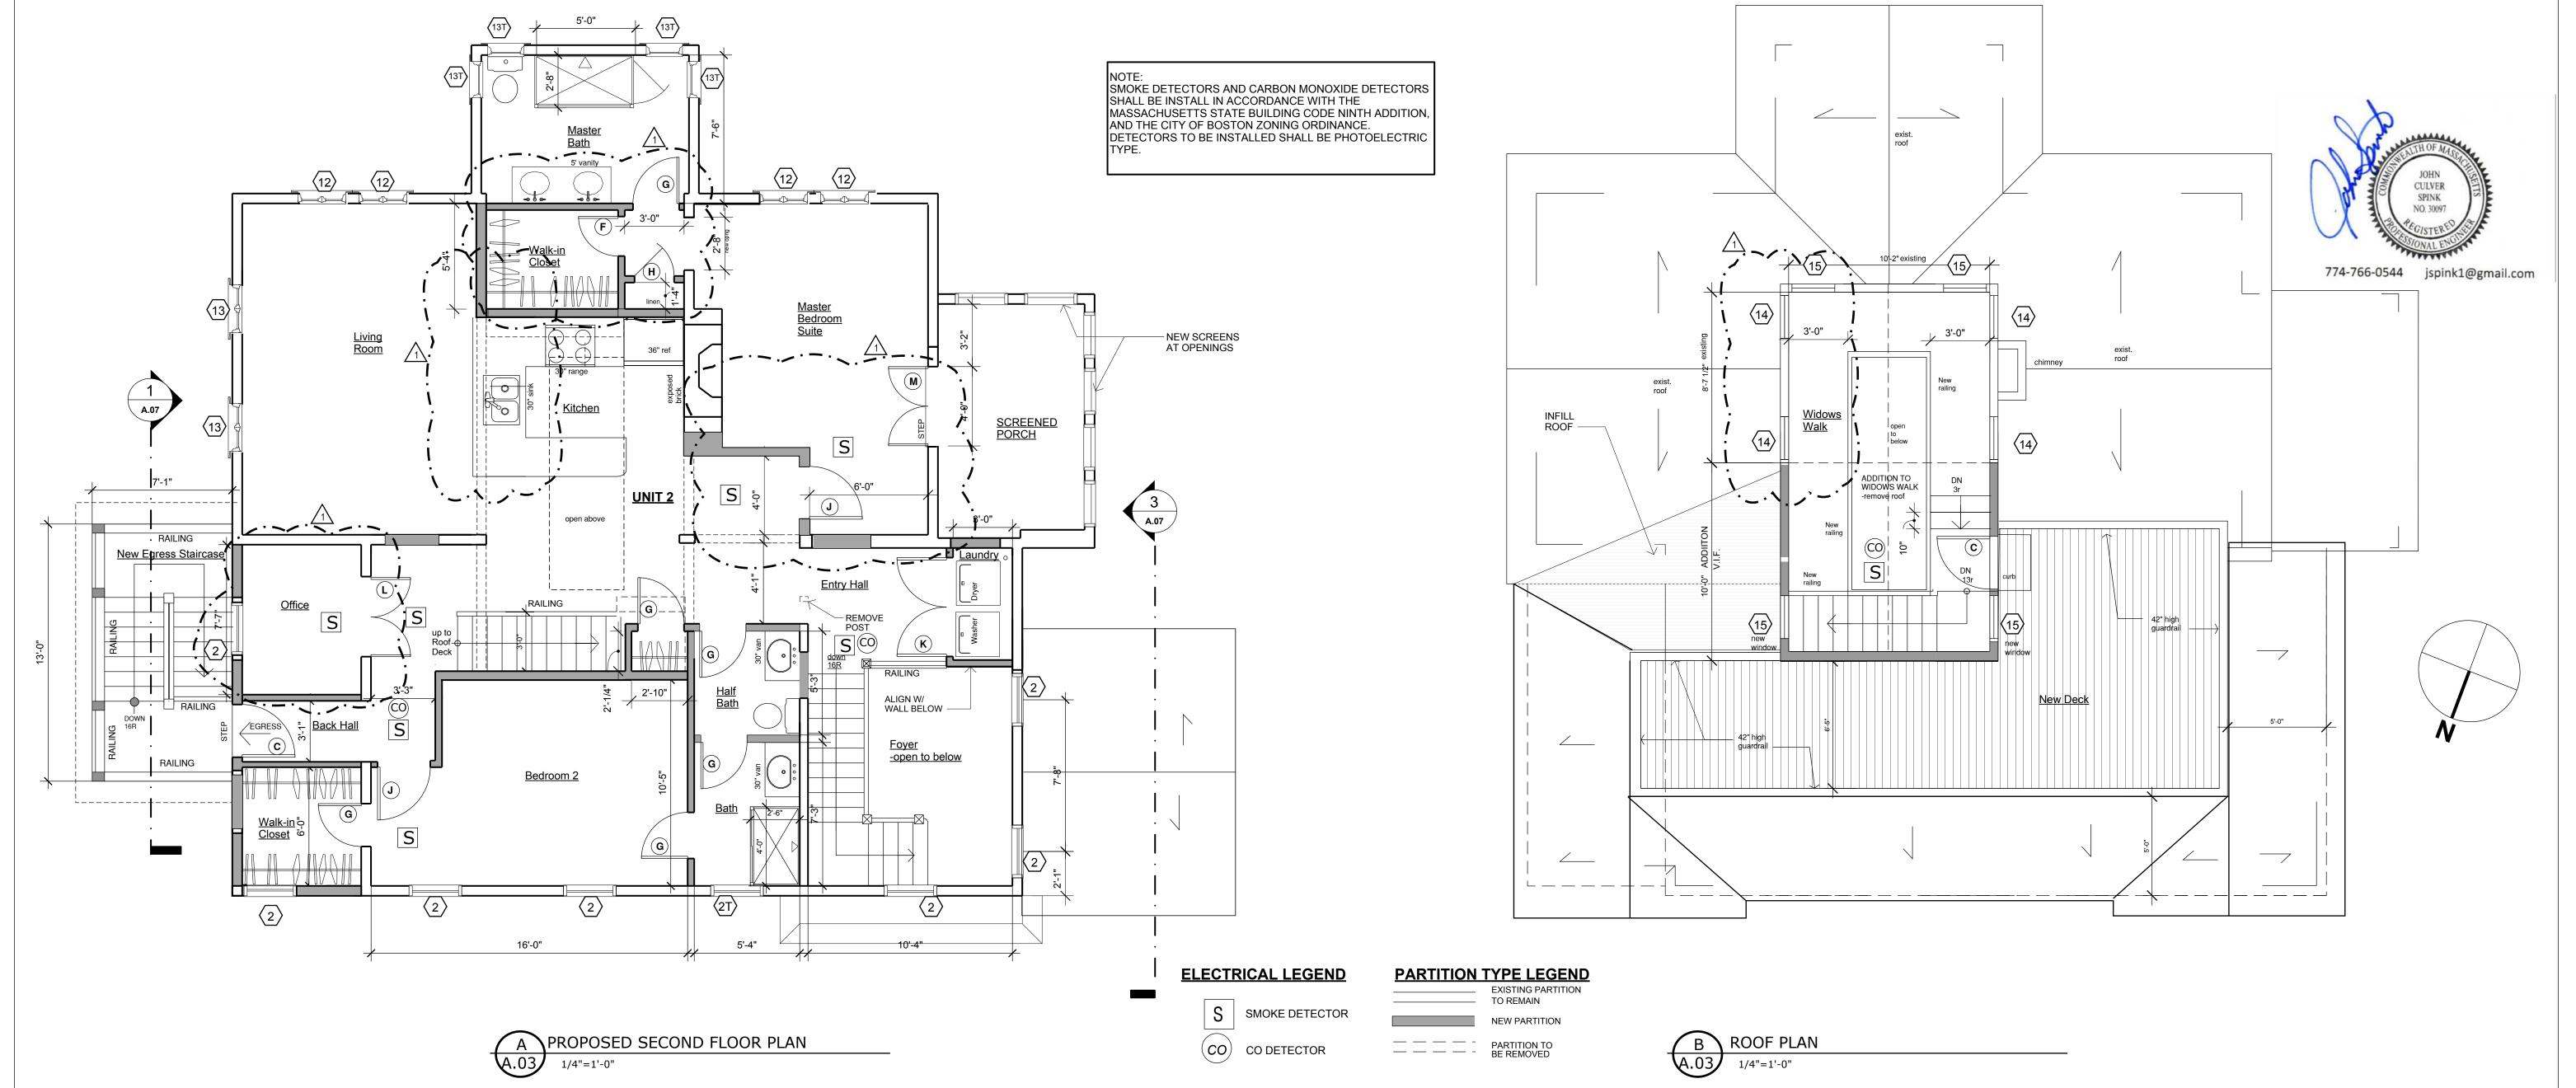


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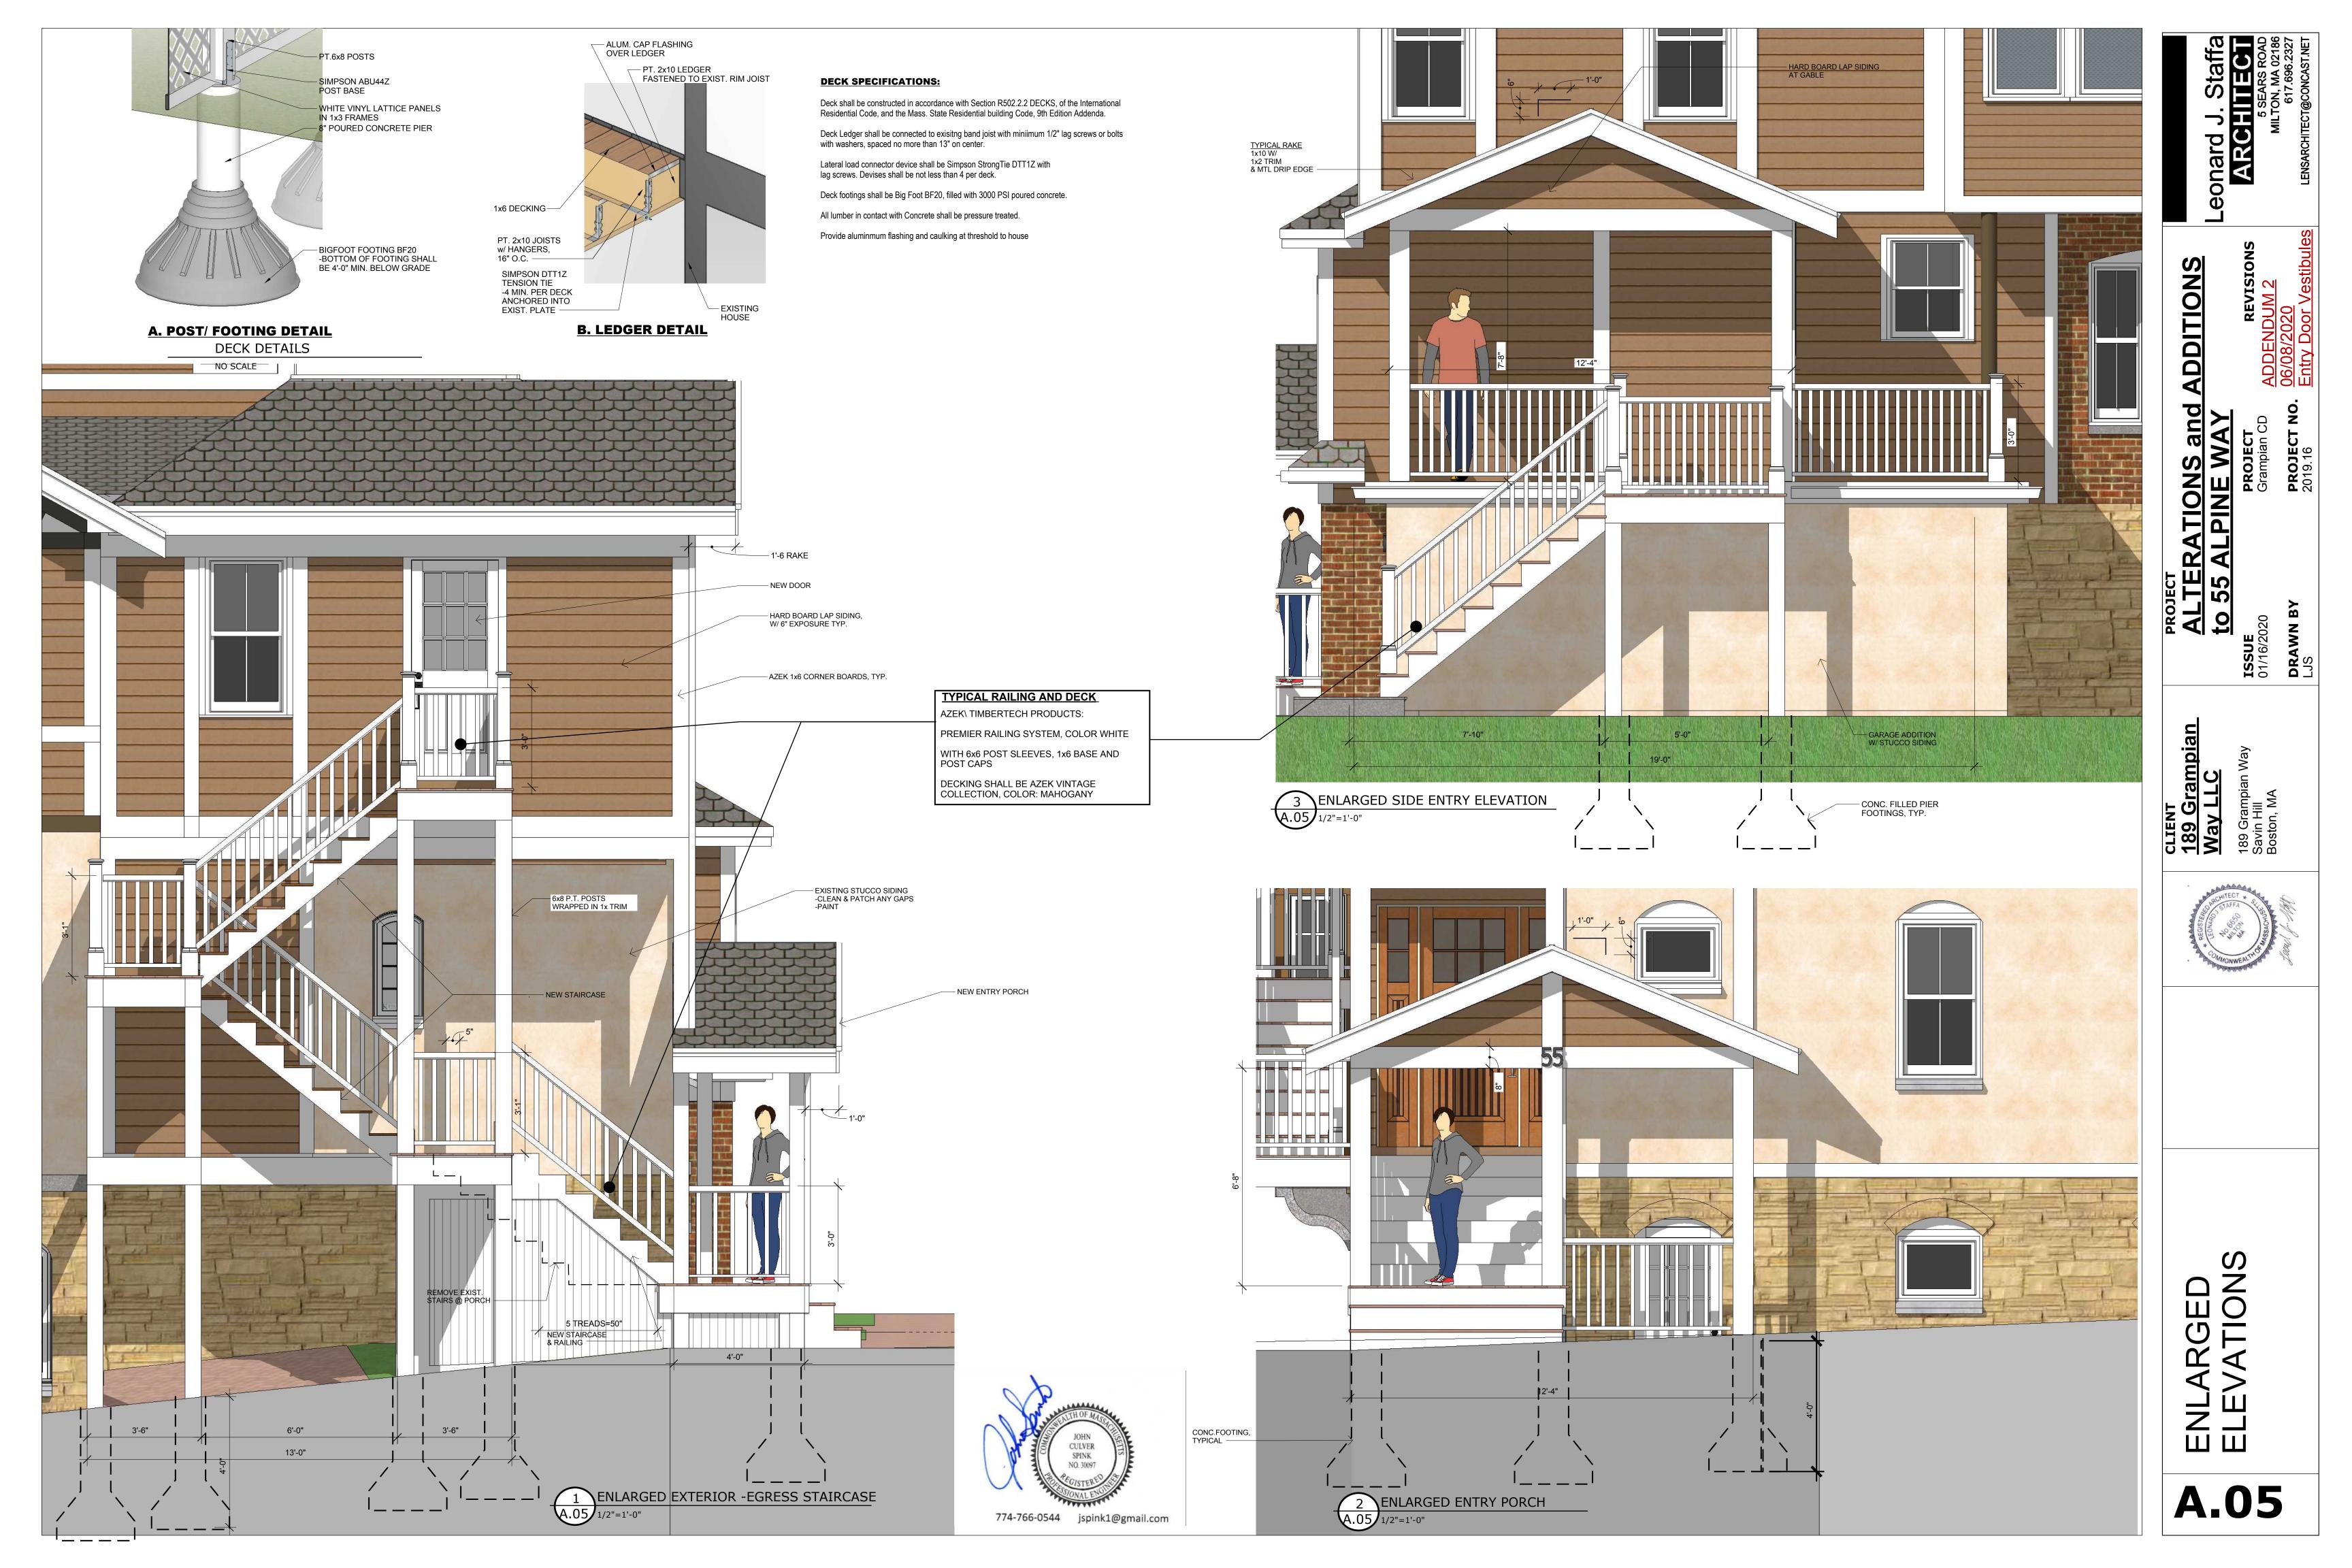
Grampian / LLC


CLIEN 189 (Way 189 Gre Savin H Boston,

ENGINEER:John Spink, P.E.
STRUCTURAL ENGIR
P.E., MA 30097

A.03




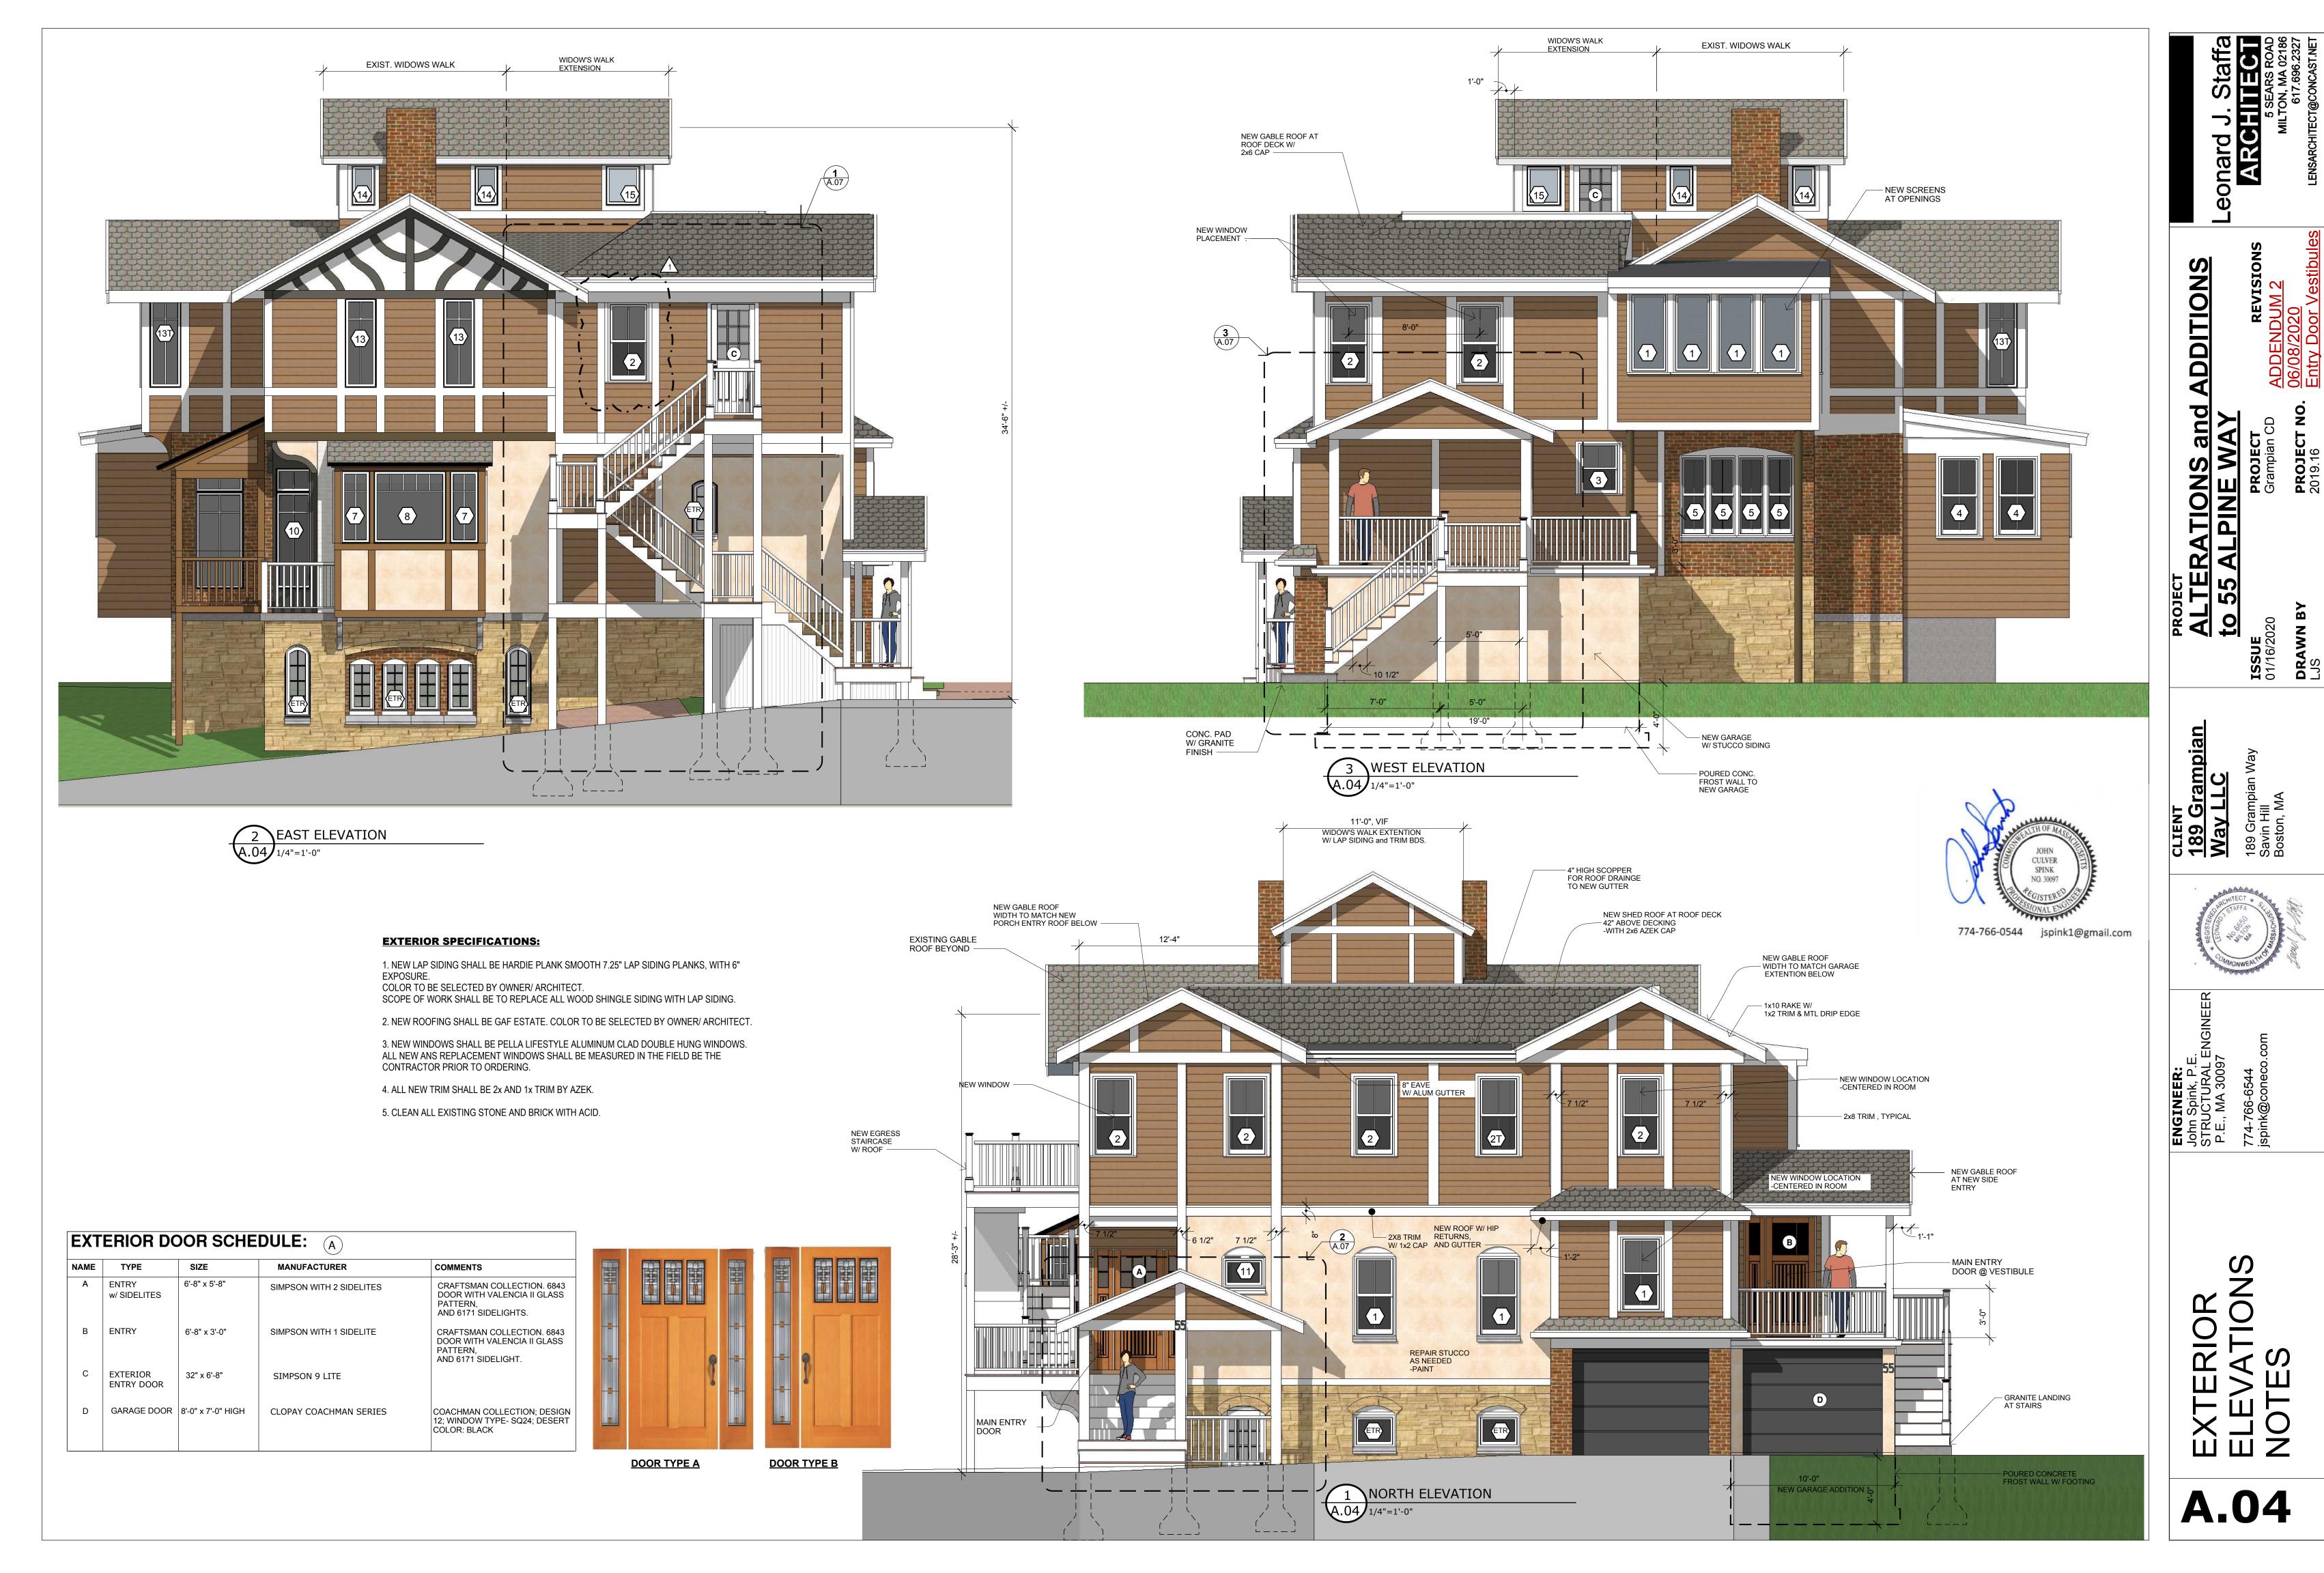

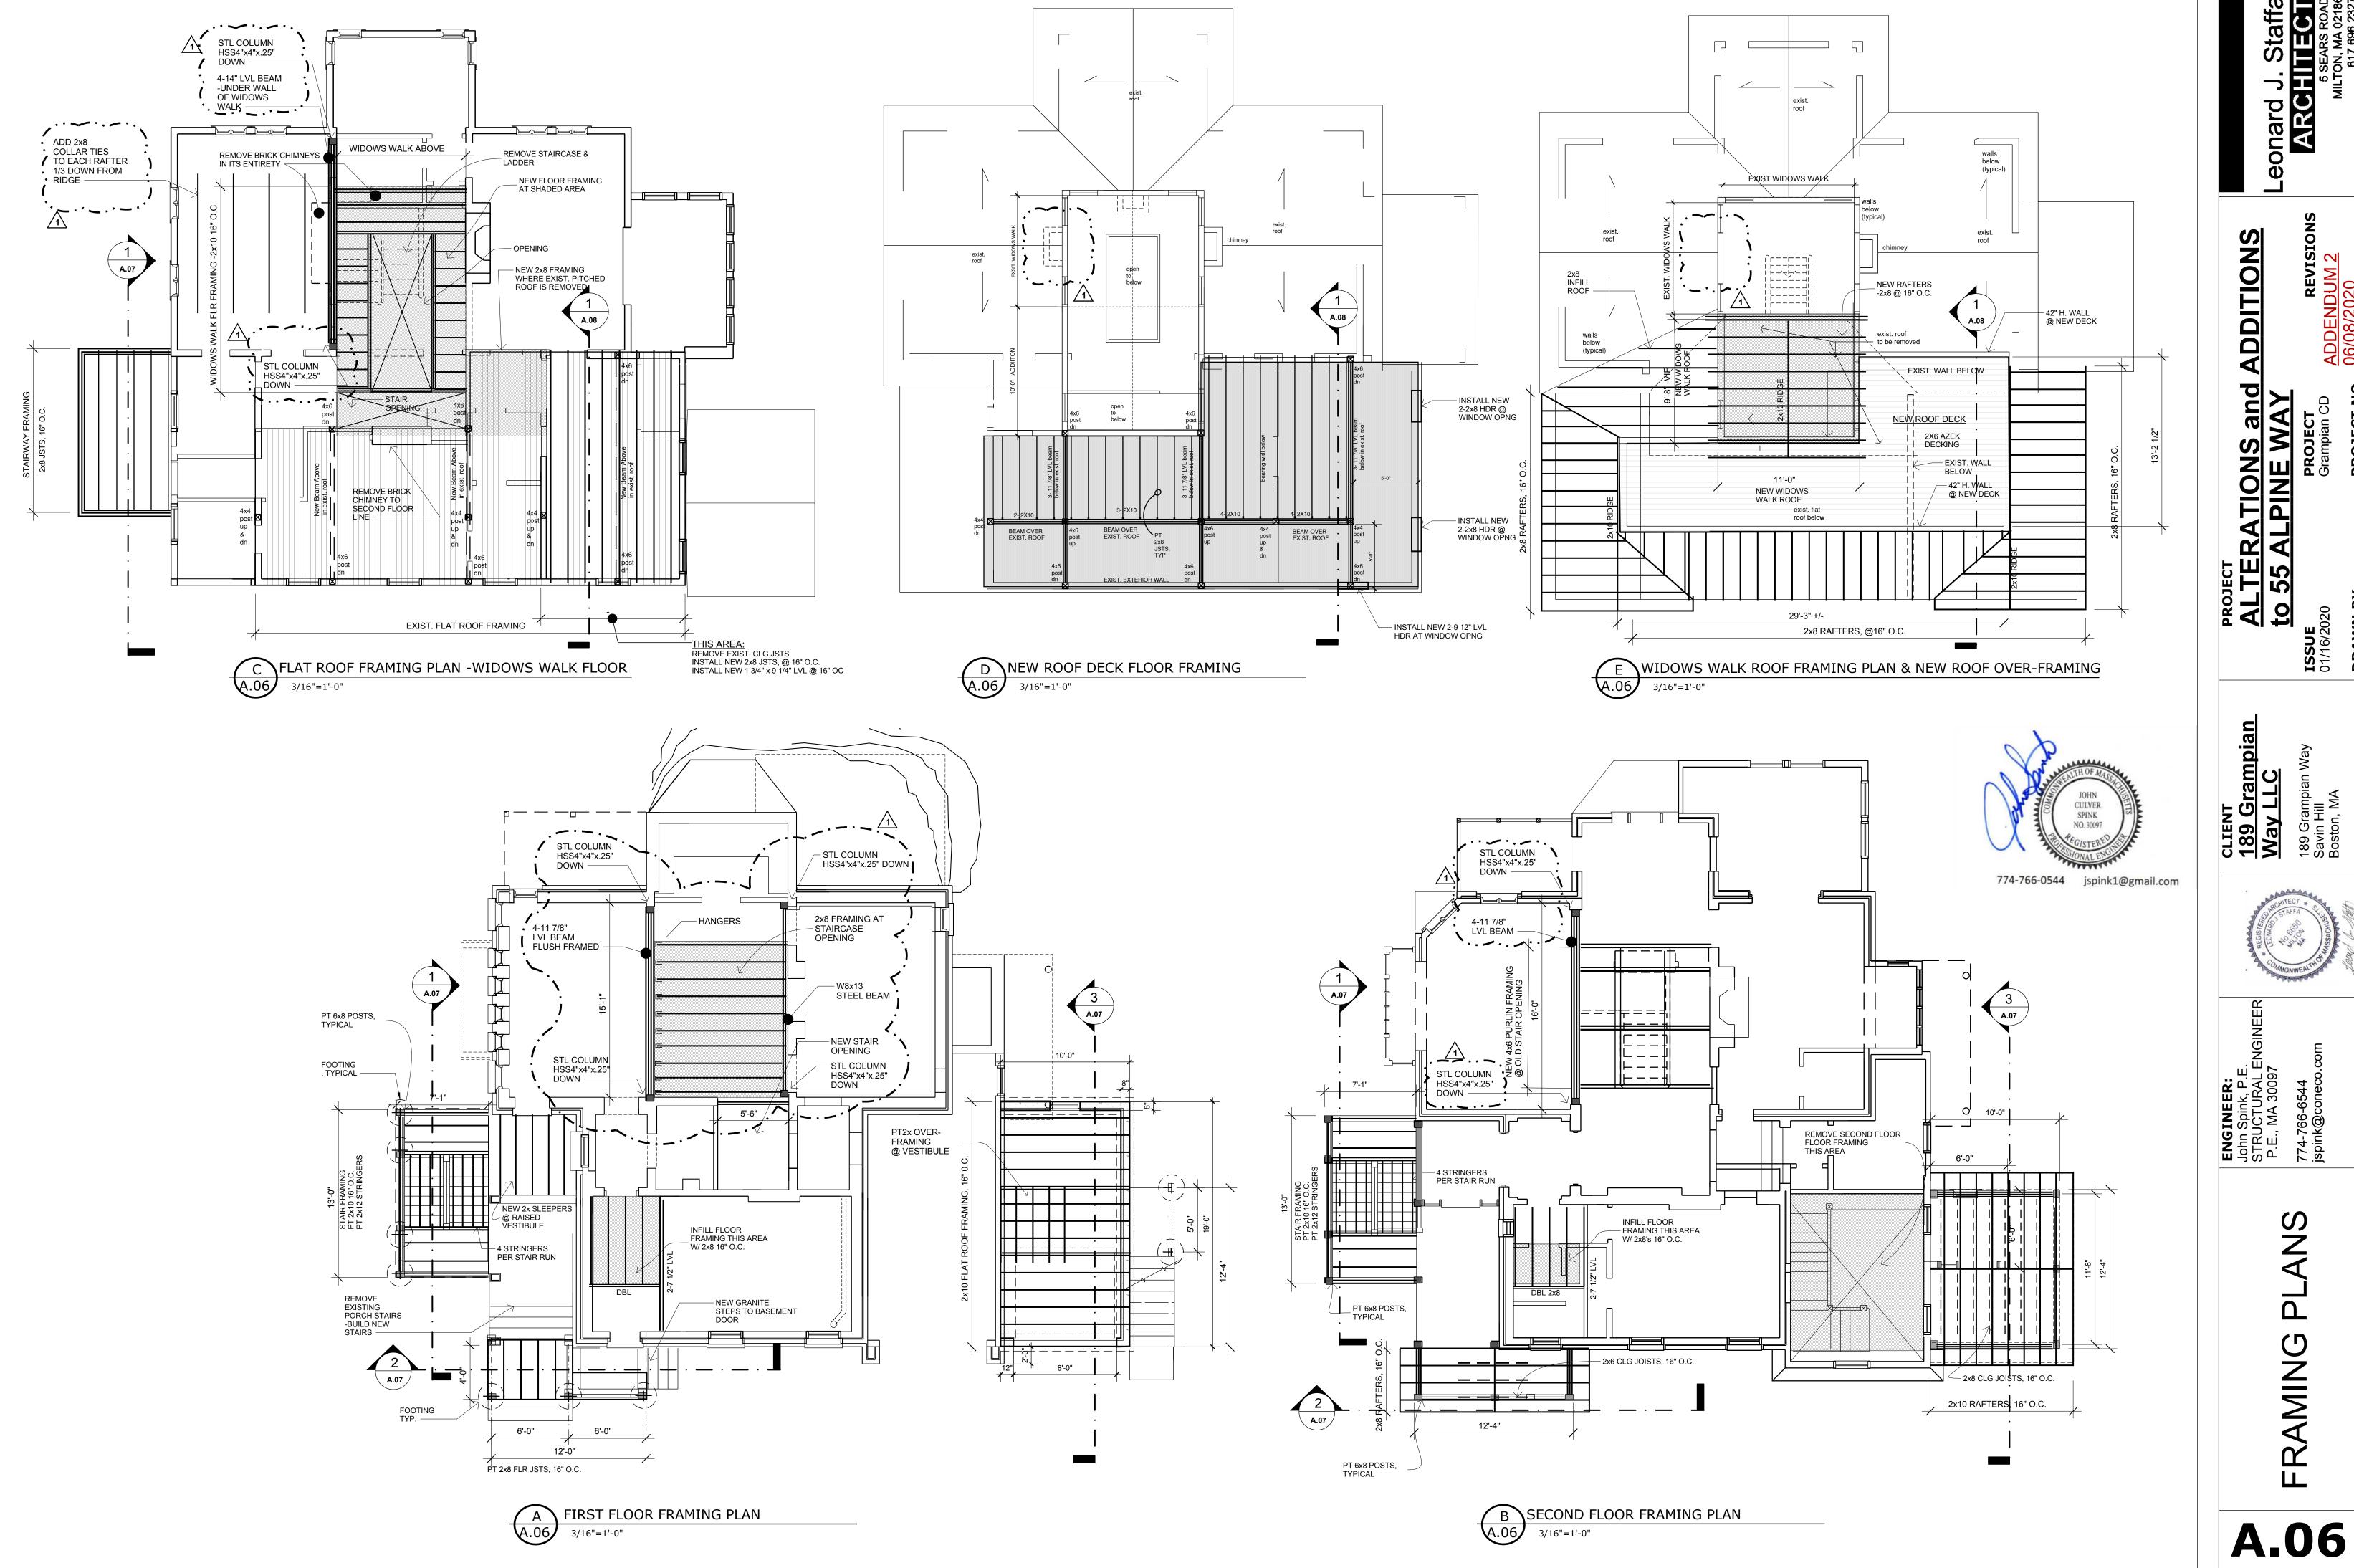


Leonard J. Staffa ARCHITECT

PROJECT NO. 2019.16

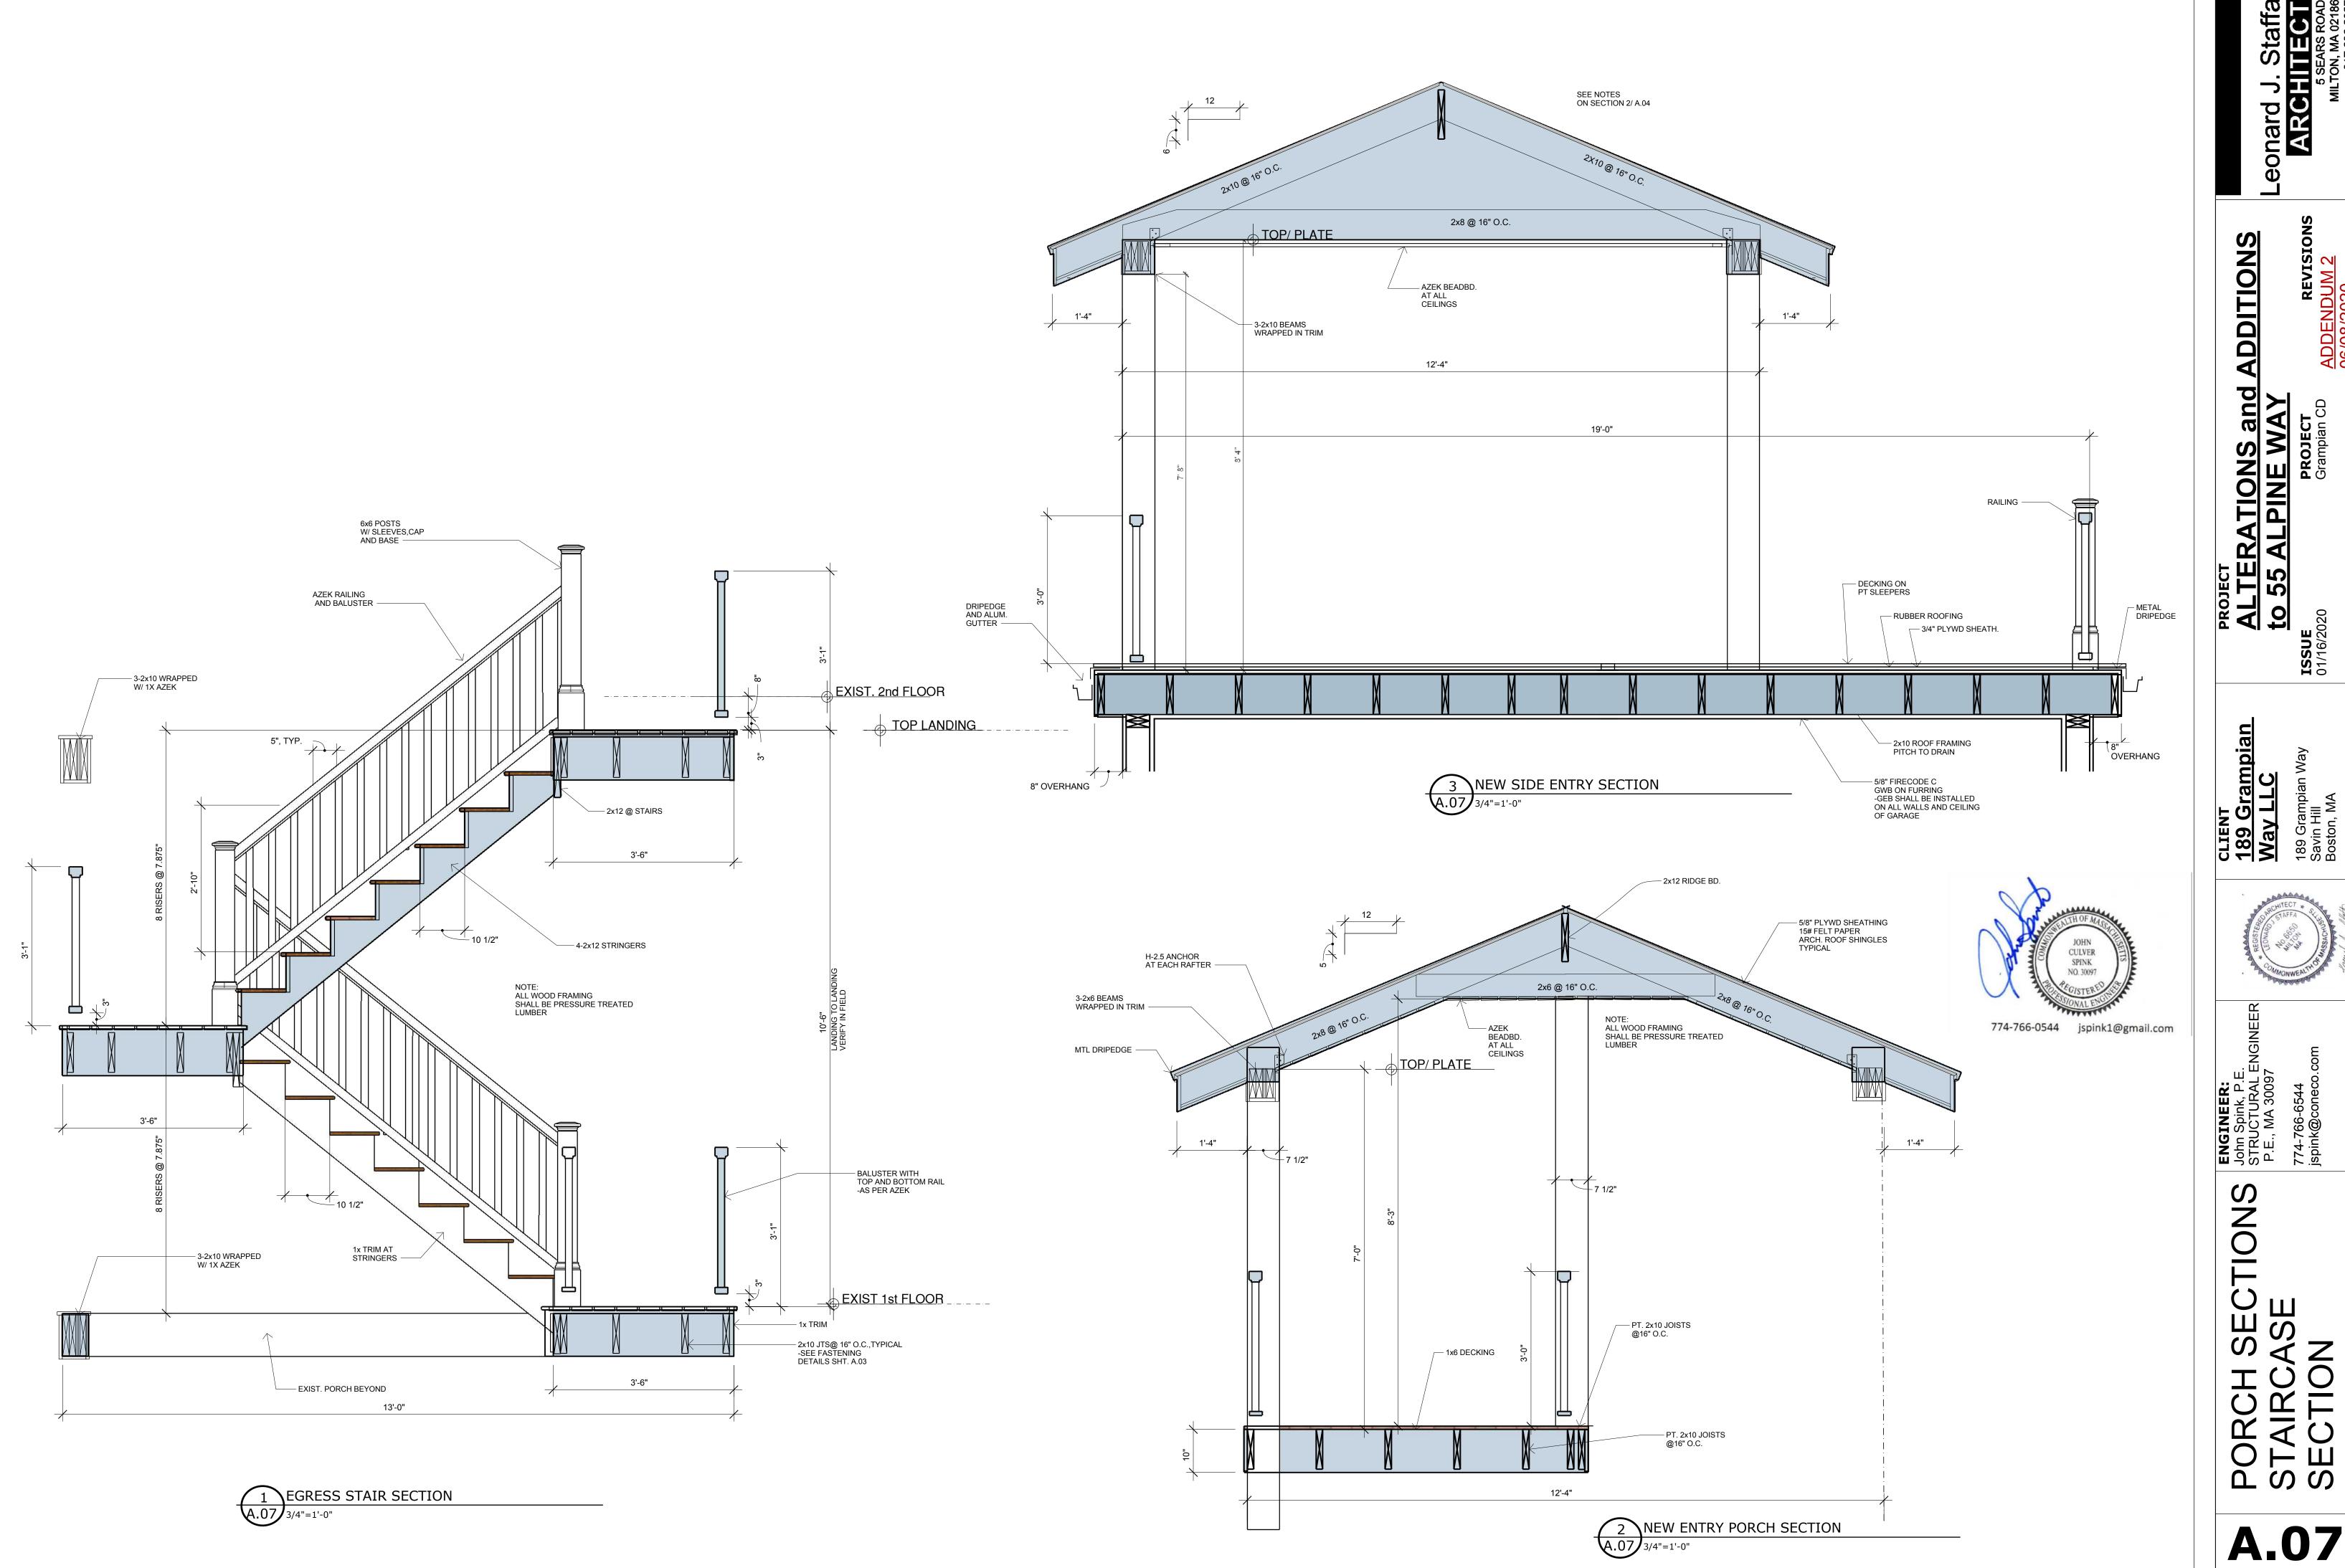

PROJECT NO. 2019.16

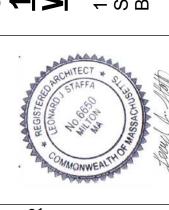

A.07

SCHEMATIC SECTION at ROOF DECK
3/4"=1'-0"

Leonard J. Staffa
ARCHITECT


ADDITIONS


PROJECT NO. 2019.16 ALTERATIONS and to 55 ALPINE WAY


189 Grampian
Way LLC
189 Grampian Way
Savin Hill
Boston, MA



A.08

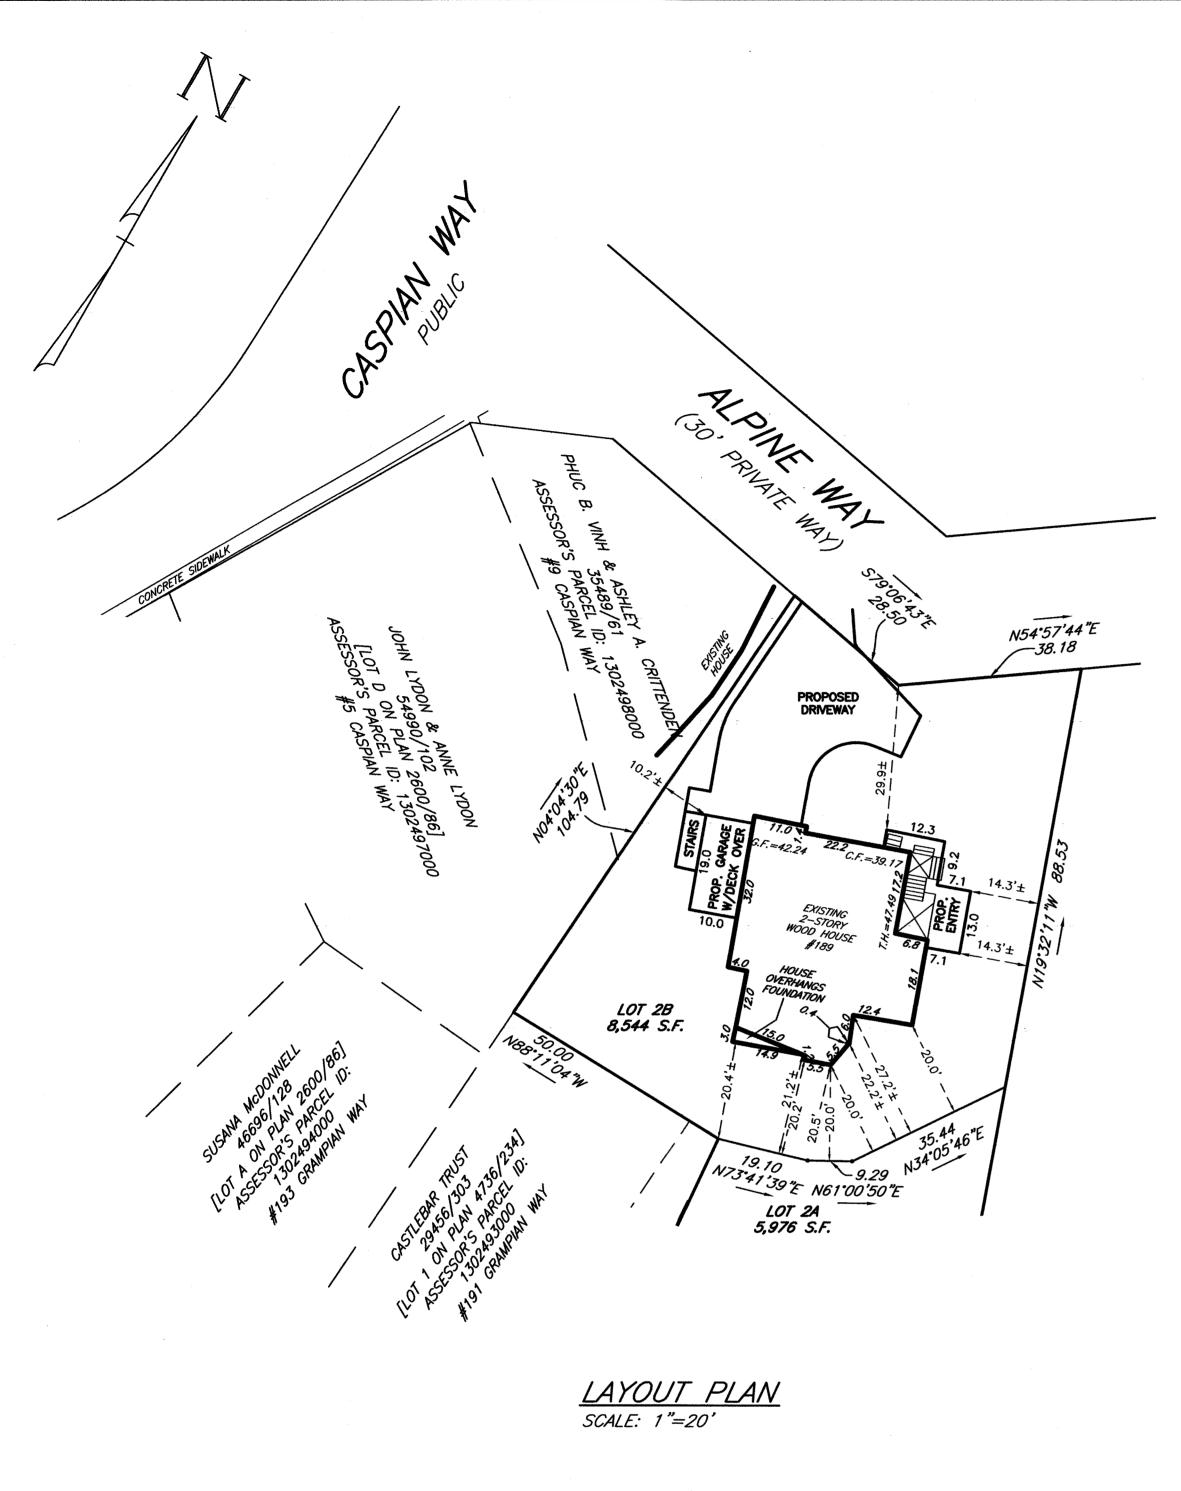

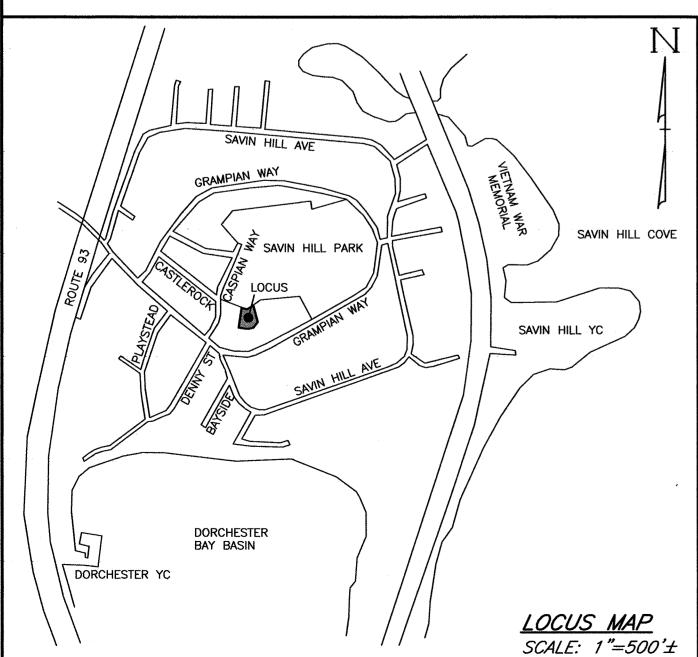

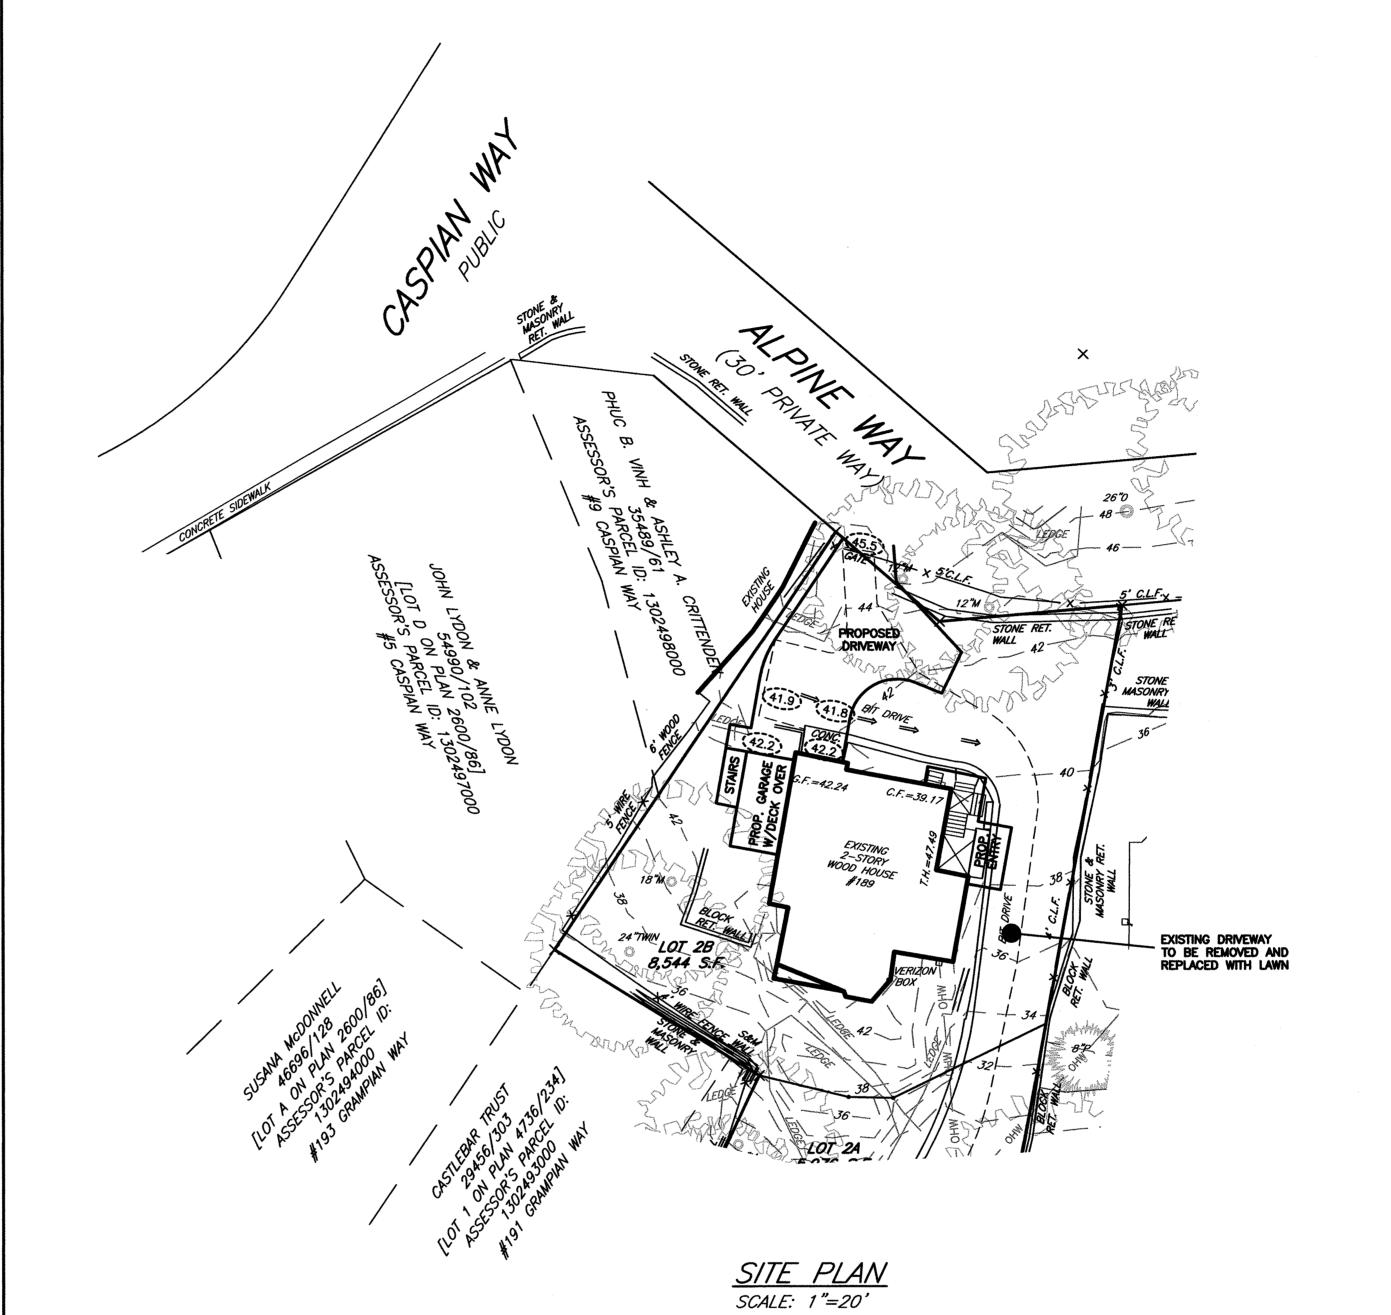

ZONING TABLE			
ZONE	2F-5000		
DIMENSIONAL CONTROLS	REQUIRED/ALLOWED	EXISTING	PROPOSED
MIN. LOT AREA	5,000 S.F.	8,544 S.F.	8,544 S.F.
LOT FRONTAGE	40 ft.	66.68 ft.	66.68 ft.
FRONT SETBACK	15 ft.	32.48 ft.	29.9 ft.
SIDE SETBACK	10 ft.	21.27 ft. EAST 18.78 ft, WEST	14.3 ft. EAST 10.2 ft. WEST
REAR SETBACK	20 ft.	21.30 ft. *	21.30 ft *
BUILDING HEIGHT	35 ft.	mean hgt to exist. gable 28'-3"± mean hgt to exist. Widow's Walk 34'-6"±	mean hgt to exist. gable 28'—3"± mean hgt to Widow's Walk Addition 34'—6"±
F.A.R.	(8,544 S.F.)×(50%)=4,272 S.F.	Basement: 196 S.F. 1st Flr: 1,621 S.F. 2nd Flr: 1,529 S.F. Roof/Widow's Walk: 104 S.F. Total = 3,450 S.F.	Basement: 792 S.F. 1st Flr: 1,584 S.F. 2nd Flr: 1,529 S.F. Roof/Widow's Walk: 209 S.F. Total = 4,114 S.F.
MIN. RATIO OF USEABLE OPEN SPACE	750 S.F. PER UNIT=1,500 S.F.	8,544 S.F1,678 S.F. = 6,866 S.F. OPEN SPACE	8,544 S.F2,923 S.F. = 5,621 S.F. OPEN SPACE

INFORMATION IN THE ZONING TABLE PROVIDED BY OTHERS.

* - SEE NOTE #5

<u>LEGEND</u>

VERTICAL GRANITE CURB	VGC
EDGE PAVEMENT	<i>EP</i>
OVERHEAD WIRES	——— OHW ———
CHAIN LINK FENCE	X
EXISTING CONTOUR	
1' SQUARE GRANITE POST	□ GP
UTILITY POLE	Q
LIGHT POLE	❖
GAS GATE	ర
WATER SHUTOFF	₩
WATER GATE	**
FIRE HYDRANT	Ħ
ELECTRIC HANDHOLE	EHH ©
DRAIN MANHOLE	0
CATCH BASIN	#
SEWER MANHOLE	S
EXISTING SPOT GRADE	× 23.18

TREE TYPES

S - SPRUCE

M - MAPLE P - PINE

T - UNKNOWN

B - BIRCH

O - OAK

NOTES:

1) ACCORDING TO A PLAN ENTITLED "PLAN OF LAND IN BOSTON, MA" DATED MARCH 22, 1988

OF DEEDS ALPINE WAY IS A 30 FOOT WIDE PRIVATE UNDEVELOPED RIGHT OF WAY. 2) THE CITY OF BOSTON PARK DEPARTMENT RECORD PLAN 3003M FOR SAVIN HILL PARK

4) LOT LINES SHOWN ARE COMPILED FROM VARIOUS PLANS, DEEDS, AND OCCUPATION AND

5) THE AVERAGE REAR LOT LINE DISTANCE FOR LOT 2B IS GREATER THAN 20 FEET. THE

DATED AUGUST 1909 INDICATES ALPINE WAY IS A 30 FOOT WIDE RIGHT OF WAY. 3) A SITE INSPECTION BY HAYES ENGINEERING, INC. PERSONNEL ON MARCH 6, 2017

BY CASPIAN ENGINEERING CO. RECORDED AS PLAN 15178/214 IN THE SUFFOLK REGISTRY

CONFIRMED THAT THERE WERE NO GATES OR OBSTRUCTIONS ON ALPINE WAY PREVENTING

ACCESS BETWEEN GRAMPIAN WAY AND CASPIAN WAY. IT WAS ALSO NOTED THAT MOTORIZED

BASED UPON AN ON GROUND SURVEY BY HAYES ENGINEERING, INC. PERFORMED BETWEEN

AVERAGE VALUE OF THE REAR SETBACK DIMENSIONS DEPICTED ON THE PROPOSED PLAN IS 21.30'

Checked By: WRB
Project File: BOS-0140 Comp. No: BOS70 ☐ Issued For Permit ☐ Issued For Review

Design By: WRB
Drawn By: EBL

Prepared For:

Prepared By:

☐ Issued For Bid ☐ Issued For Construction

☐ Not For Construction

Drawing Title:


SITE PLAN 5 ALPINE W F PARCEL ID BOSTON,

DATUM IS NAVD88.

VEHICLES HAVE USED THE WAY.

EXISTING IMPERVIOUS AREA = 3,312 S.F. PROPOSED IMPERVIOUS AREA = 3,113 S.F. TOTAL REDUCTION IN IMPERVIOUS AREA = 199 S.F.

SEPTEMBER 1, 2016 AND AUGUST 27, 2019.

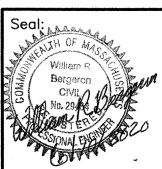

Drawing No.:









CLIENT
189 Grampian
Way LLC
189 Grampian Way
Savin Hill
Boston, MA

ADDITIONS

PROJECT NO. 2019.16

EXISTING ELEVATIONS

EC.1