**ABBREVIATIONS** 

APPROXIMATE

BLOCKING BOTTOM OF

CEILING HEIGHT

CENTERLINE

DIAMETER

existing

ELEVATION

ELECTRICAL

FLOOR DRAIN

FACE OF FINISH

GALVANIZED SHEET METAL

GYPSUM WALL BOARD

MASONRY OPENING

MECHANICAL

MISCELLANEOUS

NOT IN CONTRACT

OUTSIDE DIAMETER

NOT TO SCALE

ON CENTER

PAINT GRADE

ROOF DRAIN REQUIRED ROUGH OPENING

SCHEDULE STAIN GRADE

SPECIFICATION

STAINLESS STEEL

STORAGE

TEMPERED

TOP OF SLAB TUBULAR STEEL

VERIFY IN FIELD

WITHOUT

STRUCTURAL

SYMMETRICAL

SEE LANDSCAPE DRAWINGS

SEE STRUCTURAL DRAWINGS

TONGUE AND GROOVE

UNLESS OTHERWISE NOTED

WATERPROOFING MEMBRANE

PLYWOOD PAINTED

**OPENING OPPOSITE** 

MINIMUM

METAL

GROUND FAULT INTERCEPTOR CIRCUIT

MECHANICAL, ELECTRICAL, PLUMBING

HEATING, VENTILATING, AND AIR CONDITIONING

FACE OF STUD

HOSE BIB HOLLOW METAL

CONTINUOUS

CONTROL JOINT

CONCRETE MASONRY UNIT

APPROX

F.O.F.

F.O.S.

GWB

N.T.S.

SCHED.

STOR.

STRUCT.

U.O.N.

V.I.F.

H OR HVAC

BOSTON, MA 02136

# MARCH 25, 2024 ISSUED FOR CONSTRUCTION

SYMBOLS

ABOVE FINISHED FLOOR ACOUSTIC CEILING TILE AMERICANS WITH DISABILITIES ACT ARCHITECTURAL AUDIO VISUAL

REFERENCE NUMBER DRAWING DRAWING SHEET

DRAWING SHEET


REFERENCE NUMBER

**BUILDING SECTION** 

REFERENCE NUMBER WALL SECTION

REFERENCE NUMBER

DRAWING SHEET

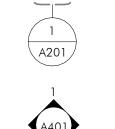

REFERENCE NUMBER INTERIOR ELEVATION DRAWING SHEET REFERENCE NUMBER EXTERIOR ELEVATION

DRAWING SHEET NORTH ARROW WINDOW TAG DOOR TAG INTERIOR WALL TYPE TAG APPLIANCE TAG **REVISION TAG** 

**ROOM TAG** FINISH ROOM TAG

EXTERIOR WALL TYPE TAG

CENTER LINE



### **VICINITY MAP**



#### PROJECT DATA

DEMOLITION OF EXISTING FUNERAL HOME; ERECTION OF A NEW CONSTRUCTION 14- UNIT RESIDENTIAL BUILDING CONSISTING OF 3 STORIES OF RESIDENTIAL OVER PARKING AT GROUND LEVEL.

THE PROPOSED STRUCTURE IS 4 STORIES ABOVE GRADE AND FULLY SPRINKLERED

USE GROUP: RESIDENTIAL/R2 CONSTRUCTION CLASSIFICATION: TYPE 5-B CONSTRUCTION

PROJECT ADDRESS: 34 OAK STREET, BOSTON 02163 PARCEL ID: 1809033000

ZONING SUBDISTRICT: NEIGHBORHOOD SHOPPING (NS-2)

ZONING DISTRICT: HYDE PARK NEIGHBORHOOD

LEVEL	GROSS SQUARE FOOTAGE	
irst (parking)	402	
ECOND	5,632	
HIRD	5,664	
OURTH	5,498	
OTAL	17,196	

### SHEET INDEX

SHEET INDEX					
Discipline	NUMBER	NAME			
	·				
	A000	COVER			
CIVIL		00.12.1			
CIVIL	C-1	LAYOUT AND MATERIALS PLAN			
CIVIL	C-2	GRADING AND UTILITY PLAN			
CIVIL	C-3	PLANTING PLAN			
ARCHITECTURE					
ARCHITECTURE	A001	CODE REVIEW			
ARCHITECTURE	A002	WOOD FRAMED PARTITION TYPES			
ARCHITECTURE	A003	METAL FRAMED PARTITION TYPES			
ARCHITECTURE	A004	EXTERIOR WALL TYPES			
ARCHITECTURE	A010	AXONS			
ARCHITECTURE	A101	PROPOSED PLANS - BASEMENT LEVEL			
ARCHITECTURE	A101.B	FOUNDATION PLAN			
ARCHITECTURE	A102	PROPOSED PLANS - FIRST LEVEL			
ARCHITECTURE	A103	PROPOSED PLANS - SECOND LEVEL			
ARCHITECTURE	A104	PROPOSED PLANS - THIRD LEVEL			
ARCHITECTURE	A105	PROPOSED ROOF PLAN			
ARCHITECTURE	A121	BUILDING REFLECTED CEILING PLANS			
ARCHITECTURE	A201	BUILDING ELEVATIONS			
ARCHITECTURE	A202	BUILDING ELEVATIONS			
ARCHITECTURE	A203	BUILDING ELEVATIONS			
ARCHITECTURE	A204	BUILDING ELEVATIONS			
ARCHITECTURE	A301	BUILDING SECTIONS			
ARCHITECTURE	A310	WALL SECTIONS			
ARCHITECTURE	A311	WALL SECTIONS			
ARCHITECTURE	A320	STAIRS PLANS AND SECTIONS			
ARCHITECTURE	A321	STAIR DETAILS			
ARCHITECTURE	A340	ELEVATOR PLANS AND SECTIONS			
ARCHITECTURE	A400	SECTION DETAILS			
ARCHITECTURE	A401	SECTION DETAILS			
ARCHITECTURE	A402	SECTION DETAILS			
ARCHITECTURE	A405	ROOF DETAILS			
ARCHITECTURE	A420	PLAN DETAILS			
ARCHITECTURE	A501	ENLARGED UNIT PLANS AND RCPS			
ARCHITECTURE	A502	ENLARGED UNIT PLANS AND RCPS			
ARCHITECTURE	A503	ENLARGED UNIT PLANS AND RCPS			
ARCHITECTURE	A504	ENLARGED UNIT PLANS AND RCPS			
ARCHITECTURE	A530	AMENITIES PLANS & ELEVATIONS			
ARCHITECTURE	A600	DOOR SCHEDULE AND DOOR DETAILS			
ARCHITECTURE	A610	WINDOW SCHEDULE AND DETAILS			
ARCHITECTURE	A700	ENLARGED KITCHEN PLANS AND ELEVATIONS			
ARCHITECTURE	A701	ENLARGED KITCHEN PLANS AND ELEVATIONS			
ARCHITECTURE	A702	KITCHEN ISLAND DETAILS			
ARCHITECTURE	A710	ENLARGED BATH PLANS AND ELEVATIONS			
ARCHITECTURE	A711	ENLARGED BATH PLANS AND ELEVATIONS			
ARCHITECTURE	A720	FINISHES AND MATERIALS			
ARCHITECTURE	A800	MILLWORK DETAILS			
STRUCTURAL	L				
STRUCTURAL	\$101	STRUCTURAL NOTES			
STRUCTURAL	\$102	STIA REQUIREMENTS			
STRUCTURAL	S201	TYPICAL DETAILS			
CTRUCTURAL	5207	TYDICAL DETAILS			

TYPICAL DETAILS
TYPICAL DETAILS

TYPICAL DETAILS

S203


S204

STRUCTURAL

<u> </u>		
STRUCTURAL	\$205	TYPICAL DETAILS
STRUCTURAL	S206	TYPICAL DETAILS
STRUCTURAL	S207	TYPICAL DETAILS
STRUCTURAL	\$301	FOUNDATION AND BASEMENT LEVEL PLAN
STRUCTURAL	\$401	FIRST LEVEL FRAMING PLAN
STRUCTURAL	\$402	SECOND LEVEL FRAMING PLAN
STRUCTURAL	\$403	THIRD LEVEL FRAMING PLAN
STRUCTURAL	\$501	ROOF FRAMING PLAN
STRUCTURAL	\$601	FOUNDATION SECTION AND DETAILS
STRUCTURAL	\$602	COMPOSITE SLAB SECTIONS AND DETAILS
STRUCTURAL	S701	FLOOR FRAMING SECTIONS AND DETAILS
STRUCTURAL	\$801	ROOF FRAMING SECTIONS AND DETAILS
STRUCTURAL	S901	STAIR FRAMING SECTIONS AND DETAILS
MECHANICAL MECHANICAL	3701	STAIR TRAVIING SECTIONS AND DETAILS
MECHANICAL	H101	HVAC LEVEL 1 PLANS
MECHANICAL	H102	HVAC LEVEL 1 PLANS
MECHANICAL	H103	HVAC LEVEL 3 PLANS
MECHANICAL	H104	HVAC TYPICAL FLOOR PLAN
MECHANICAL	H105	HVAC ROOF PLANS
MECHANICAL	H200	HVAC NOTES
MECHANICAL	H201	HVAC SCHEDULES
MECHANICAL	H202	HVAC DETAILS
MECHANICAL	H203	HVAC DETAILS
ELECTRICAL	11203	TIVAC DETAILS
ELECTRICAL	E 101	POWER LEVEL 1 PLANS
ELECTRICAL	E 102	POWER LEVEL 2 PLANS
ELECTRICAL	E 103	POWER LEVEL 3 PLANS
ELECTRICAL	E 104	POWER LEVEL 4 PLANS
ELECTRICAL	E 105	POWER ROOF PLANS
ELECTRICAL	E 201	LIGHTING LEVEL 1 PLANS
ELECTRICAL	E 202	LIGHTING LEVEL 2 PLANS
ELECTRICAL	E 203	LIGHTING LEVEL 2 PLANS
ELECTRICAL	E 204	LIGHTING LEVEL 4 PLANS
ELECTRICAL	E 205	LIGHTING ROOF PLANS
ELECTRICAL	E 300	ELECTRICAL NOTES
ELECTRICAL	E 301	ELECTRICAL RISER
ELECTRICAL	EU100	ELECTRICAL UNIT PLANS
ELECTRICAL	EU101	ELECTRICAL UNIT PLANS
ELECTRICAL	EU102	ELECTRICAL UNIT PLANS
ELECTRICAL	EU103	ELECTRICAL UNIT PLANS
PLUMBING	10103	ELECTRICAL OTHER LANS
PLUMBING	P101	PLUMBING LEVEL 1 PLANS
PLUMBING	P102	PLUMBING LEVEL 1 PLANS
PLUMBING	P102	PLUMBING LEVEL 3 PLANS
	P104	PLUMBING LEVEL 4 PLANS
PLUMBING	P104	
PLUMBING		PLUMBING ROOF PLANS
PLUMBING	P200	PLUMBING NOTES
PLUMBING	P201	PLUMBING SCHEDULES
PLUMBING	P202	PLUMBING DETAILS
PLUMBING	P203	PLUMBING DETAILS
PLUMBING	P204	PLUMBING DETAILS
FIRE PROTECTION	EA101	FIDE ALADAA LEVEL 1 DIANIS
FIRE PROTECTION	FA101	FIRE ALARM LEVEL 1 PLANS
FIRE PROTECTION	FA102	FIRE ALARM LEVEL 2 PLANS
FIRE PROTECTION	FA103	FIRE ALARM LEVEL 3 PLANS

NUMBER

Discipline	NUMBER	NAME	NAME	
		T		
FIRE PROTECTION	FA104	FIRE ALARM LEVEL 4 PLANS		
FIRE PROTECTION	FA200	FIRE ALARM NOTES		
FIRE PROTECTION	FAU100	FIRE ALARM UNIT PLANS		
FIRE PROTECTION	FAU101	FIRE ALARM UNIT PLANS		
FIRE PROTECTION	FP101	FIRE PROTECTION LEVEL 1		
FIRE PROTECTION	FP102	FIRE PROTECTION LEVEL 2		
FIRE PROTECTION	FP103	FIRE PROTECTION LEVEL 3		
FIRE PROTECTION	FP104	FIRE PROTECTION LEVEL 4		
FIRE PROTECTION	FP105	FIRE PROTECTION ROOF		
FIRE PROTECTION	FP200	FIRE PROTECTION NOTES		
FIRE PROTECTION	FP201	FIRE PROTECTION DETAILS		
FIRE PROTECTION	FP202	FIRE PROTECTION DETAILS		

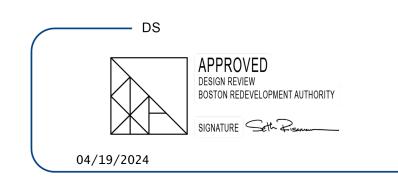

All changes to the exterior and/or site plan shall be submitted to the Boston Planning and Development Agency ("BPDA") for review and approval.

### **ZONING REVIEW**

HYDE PARK ZONING DISTRICT/ NS-2 SUB-DISTRICT

	ALLOWABLE	EXISTING	PROPOSED
LOT SIZE	NONE	9,747 S.F.	NO CHANGE
LOT WIDTH	NONE		NO CHANGE
F.A.R.	19,494 S.F. (2.0)		17,196 S.F. (1.76)
BUILDING HEIGHT	40'-0"		39'-11"
OPEN SPACE	N/A		
FRONT YARD	0'-0"*		- OAK ST: AVG = 22'-6"; CLOSEST POINT = 21'-7" - MAPLE ST: 2'-8"
SIDE YARD	0'-0"**		10'-3"
REAR YARD	10'-0"		10'-1"'
PARKING	1/UNIT (14)		14 SPACES

\*69-30. 1 Conformity with Existing Building Alignment. If at any time in the same Block as a Lot required by this Article to have a minumum Front Yard there exist two or more Buildings fronting on the same side of the same Street as such Lot, instead of the minimum Front Yard deptht specified in this Article, the minimum Front Yard depth shall be in conformity with the Existing Building Alignment of the Block.

\*69-30. 3 Front Wall of Building Not Parallel to Front Lot Line. If the front wall of a Building is not parallel to the Front Lot Line, but the average distance between such wall and such Lot Line is no less than the minimum Front Yard depth otherwise required by this Article, and the distance between such wall and such Lot line is at no point less than three fourths (3/4) of the minimum Front Yard depth so otherwise required, the Front Yard requirements of this Article shall be deemed to be met.

Oak Street Modal Alignment Calc (See Sheet titled Modeal Plan): 22.5' **3/4 Front Setback:** .75\*22.5'= **16.9**'

\*\*TABLE E - Footnote 4.In a Neighborhood Business Subdistrict, no side yard is required except in the case of a lot with a side lot line abutting a Residential Subdistrict, which shall have side yards as if it were in such abutting district. Every side yard so required that does not abut a street line shall, along every lot line on which such yard abuts, be at a level no higher than that of the lowest window sill of the lowest room designed for human occupancy or so occupied, and relying upon natural light or natural ventilation from windows opening on such yard.

BOSTON, MA 02118 O: 617.765.8000

REVISIONS

DRAWING INFORMATION

DATE: MARCH 25, 2024

PROJECT #: 21004

DRAWING TITLE

DRAWING NUMBER

SCALE: As indicated

ISSUE: ISSUED FOR CONSTRUCTION

## PROPOSED HOUSING DEVELOPMENT

### 34 OAK STREET HYDE PARK, MA

LEGEND

LA

-----

\_\_\_\_

PROPERTY LINE

CEMENT CONCRETE PAVEMENT

VERTICAL GRANITE CURB

TRANSITION CURB

LANDSCAPE AREA

SAW CUT LINE

STEEL BOLLARD


PARKING COUNT

FENCE


FLUSH CURB

### LAYOUT AND MATERIALS NOTES

- EXISTING CONDITIONS INFORMATION IS REPRODUCED FROM THE SURVEY PREPARED BY FRAMINGHAM SURVEY CONSULTANTS INC OF FRAMINGHAM, MA AND IS DATED FEBRUARY 14, 2024.
- THE LOCATIONS OF UNDERGROUND UTILITIES SHOWN ARE BASED ON THE SURVEY REFERENCED ABOVE. THE CONTRACTOR SHALL NOTIFY DIGSAFE AND THE PROPER LOCAL AUTHORITIES OR RESPECTIVE UTILITY COMPANIES TO CONFIRM THE LOCATION OF ALL EXISTING UTILITIES BEFORE COMMENCING WORK. ANY DAMAGE DUE TO FAILURE OF THE CONTRACTOR TO CONTACT THE PROPER AUTHORITIES SHALL BE BORNE BY THE CONTRACTOR.
- CONTRACTOR(s) SHALL THOROUGHLY FAMILIARIZE THEMSELVES WITH ALL CONSTRUCTION DOCUMENTS, SPECIFICATIONS, AND SITE CONDITIONS PRIOR TO BIDDING AND PRIOR TO CONSTRUCTION.
- ANY DISCREPANCIES BETWEEN DRAWINGS, SPECIFICATIONS, AND SITE CONDITIONS SHALL BE REPORTED IMMEDIATELY TO THE OWNER'S REPRESENTATIVE FOR CLARIFICATION AND RESOLUTION PRIOR TO BIDDING OR CONSTRUCTION.
- ALL WORK CONDUCTED WITHIN PUBLIC RIGHT-OF-WAYS SHALL CONFORM TO THE REQUIREMENTS AND SPECIFICATIONS OF THE CITY OF BOSTON.
- SEE ARCHITECTURAL DRAWINGS FOR EXACT BUILDING DIMENSIONS AND ALL DETAILS CONTIGUOUS TO THE BUILDING, INCLUDING SIDEWALKS, RAMPS, UTILITY ENTRANCE LOCATIONS, WALL PACKS, CONCRETE DOOR PADS, ROOF DRAINS, ETC.
- ACCESSIBLE CURB RAMPS SHALL BE PER THE MASSACHUSETTS ARCHITECTURAL ACCESS BOARD (AAB) AND THE AMERICANS WITH DISABILITIES ACT (ADA) ACCESSIBILITY GUIDELINES, WHICHEVER IS MORE STRINGENT.
- THE FOLLOWING LAYOUT CRITERIA SHALL CONTROL UNLESS OTHERWISE NOTED ON THE PLAN: ALL DIMENSIONS ARE TO OUTSIDE FACE OF BUILDING. ALL DIMENSIONS ARE TO FACE OF CURB AT GUTTER LINE. ALL DIMENSIONS ARE TO CENTER OF PAVEMENT MARKINGS. ALL TIES TO PROPERTY LINES ARE PERPENDICULAR TO THE PROPERTY LINE UNLESS OTHERWISE NOTED.
- 9. FOR LAYOUT AND DIMENSIONING OF BUILDINGS, SEE ARCHITECTURAL DRAWINGS.
- 10. SCREENED IMAGES SHOW EXISTING CONDITIONS. WHERE EXISTING CONDITIONS LIE UNDER OR ARE IMPINGED UPON BY PROPOSED BUILDINGS AND/OR SITE ELEMENTS, THE EXISTING CONDITION WILL BE REMOVED, ABANDONED AND/OR CAPPED OR DEMOLISHED AS REQUIRED.

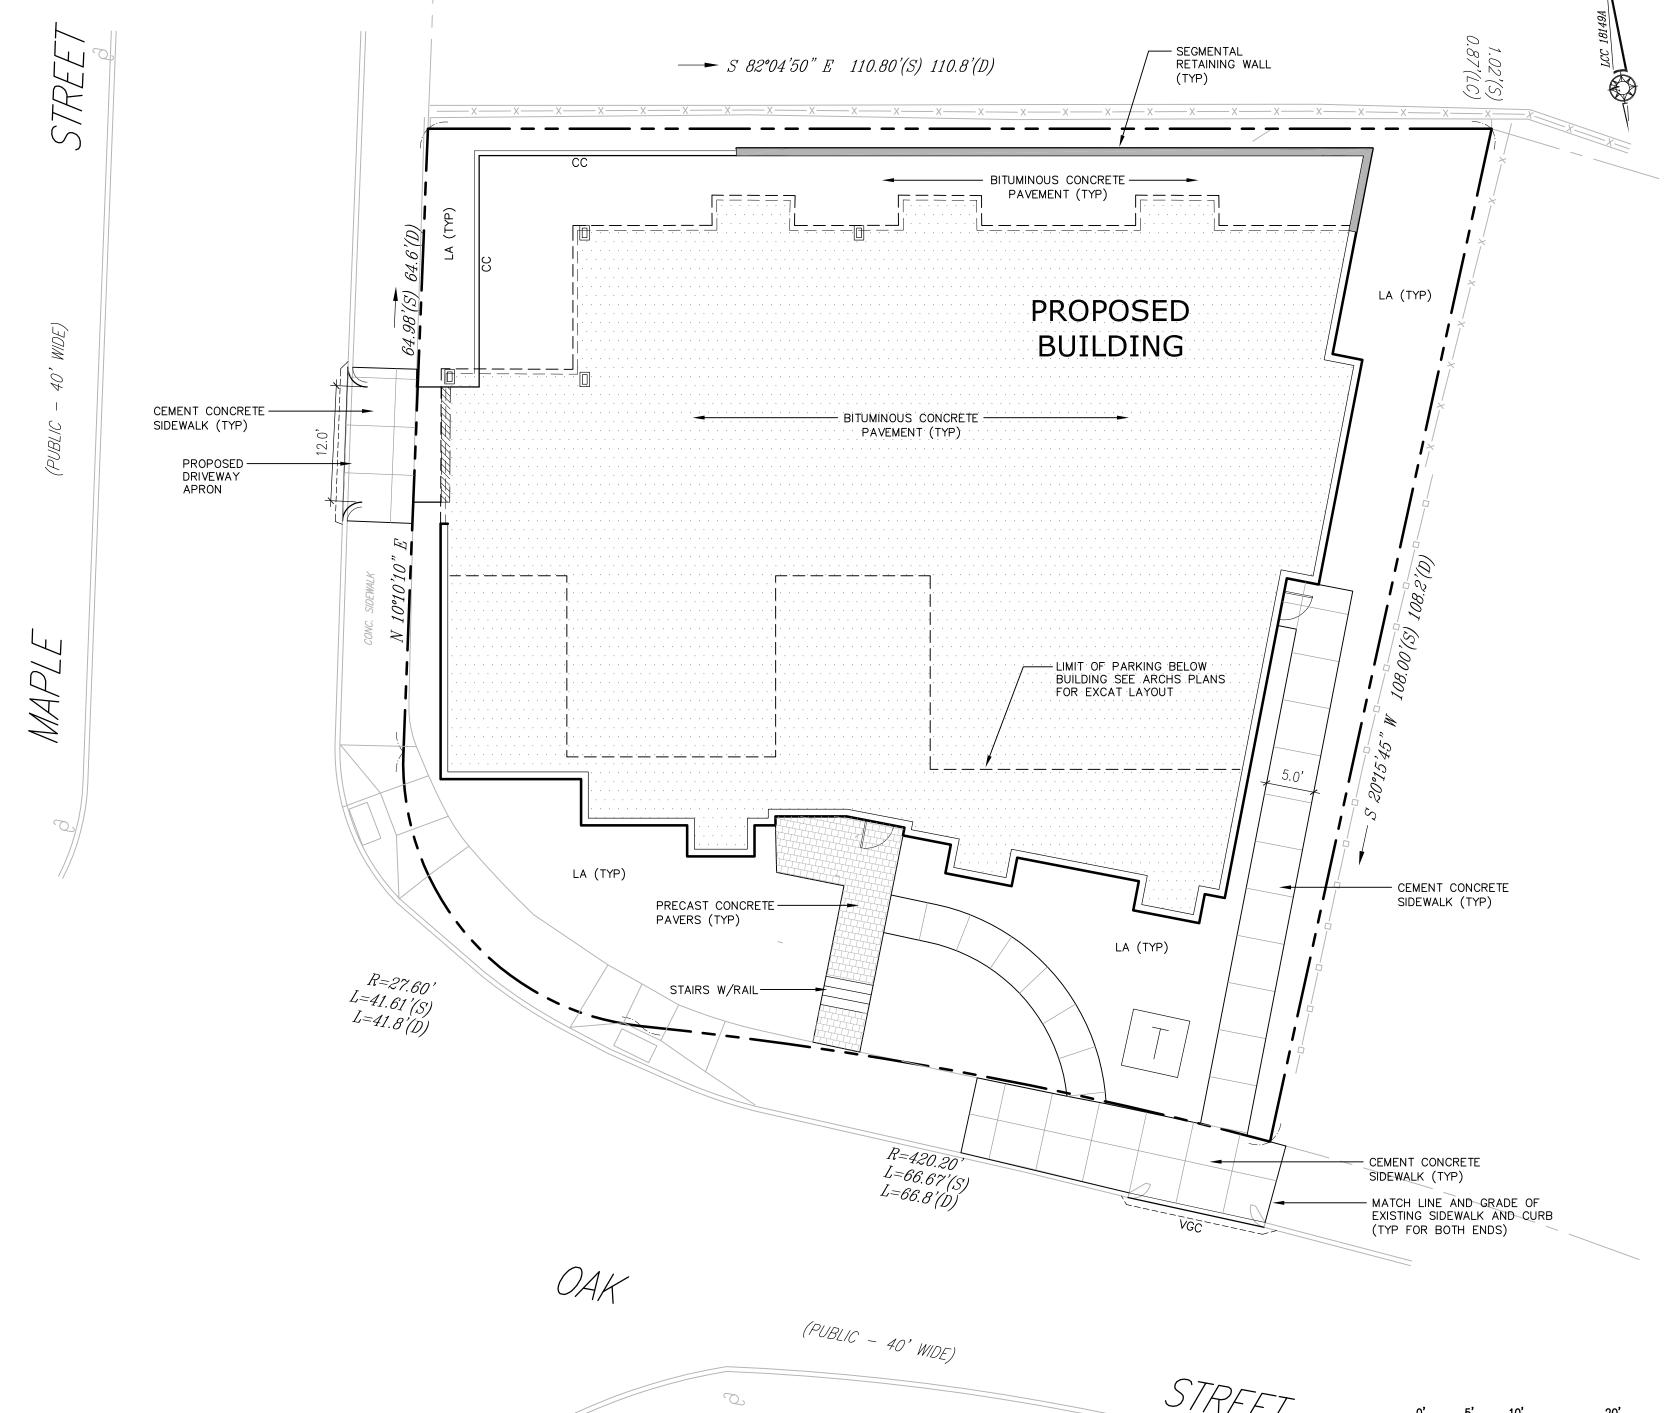




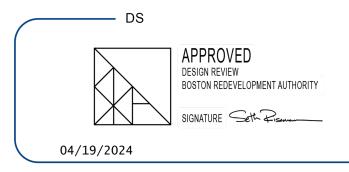


All changes to the exterior and/or site plan shall be submitted to the Boston Planning and Development Agency ("BPDA") for review and approval.



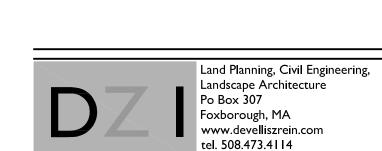

# DeVellis Zrein Inc.

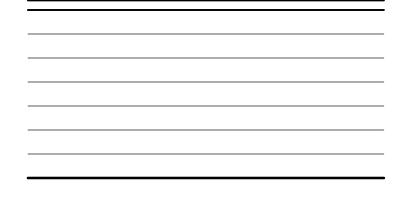

# LAYOUT AND MATERIALS PLAN

SCALE:	1" = 10'
JOB:	2G1S-553
FILE:	
DRAWN:	IAZ
CHECKED:	
DATE:	02.02.24

### PROPOSED HOUSING **DEVELOPMENT**

34 OAK STREET

HYDE PARK, MA

PROPERTY LINE

SEWER LINE

DRAIN LINE

WATER LINE

SPOTGRADE

CATCHBASIN

WATER GATE

ROOF DRAIN

DRAIN MANHOLE

TAPPING SLEEVE & GATE


CB ⊞

WG⊚

PROPOSED CONTOUR

### GRADING AND UTILITY NOTES

- EXISTING CONDITIONS INFORMATION IS REPRODUCED FROM THE SURVEY PREPARED BY FRAMINGHAM SURVEY CONSULTANTS INC OF FRAMINGHAM, MA AND IS DATED FEBRUARY 14, 2024.
- PRIOR TO THE START OF ANY EXCAVATION FOR THE PROJECT, BOTH ON AND OFF THE SITE, THE CONTRACTOR SHALL NOTIFY DIGSAFE AND BE PROVIDED WITH A DIGSAFE NUMBER INDICATING THAT ALL EXISTING UTILITIES HAVE BEEN LOCATED AND MARKED.
- CONTRACTOR TO ADJUST UTILITY ELEMENT MEANT TO BE FLUSH WITH GRADE (CLEAN-OUTS, UTILITY MANHOLES, CATCH BASINS, INLETS, ETC.) THAT IS AFFECTED BY SITE WORK OR GRADE CHANGES, WHETHER SPECIFICALLY NOTED ON PLANS OR NOT.
- ALL CONSTRUCTION TO BE DONE IN ACCORDANCE WITH CITY OF BOSTON DEPARTMENT OF PUBLIC WORKS STANDARDS.
- ALL WORK TO BE DONE WITHIN PUBLIC RIGHT-OF-WAYS SHALL CONFORM TO THE REQUIREMENTS AND SPECIFICATIONS OF THE CITY OF BOSTON.
- THE LOCATIONS OF EXISTING UNDERGROUND UTILITIES ARE SHOWN IN AN APPROXIMATE WAY ONLY AND HAVE NOT BEEN INDEPENDENTLY VERIFIED BY THE OWNER OR ITS REPRESENTATIVE. THE CONTRACTOR SHALL DETERMINE THE EXACT LOCATION OF ALL EXISTING UTILITIES BEFORE COMMENCING WORK, AND AGREES TO BE FULLY RESPONSIBLE FOR ANY AND ALL DAMAGES WHICH MAY BE OCCASIONED BY THE CONTRACTOR'S FAILURE TO EXACTLY LOCATE AND PRESERVE ALL UNDERGROUND UTILITIES.
- WHERE AN EXISTING UTILITY IS FOUND TO CONFLICT WITH THE PROPOSED WORK, THE LOCATION, ELEVATION, AND SIZE OF THE UTILITY SHALL BE ACCURATELY DETERMINED WITHOUT DELAY BY THE CONTRACTOR, AND THE INFORMATION FURNISHED TO THE ENGINEER FOR RESOLUTION OF THE CONFLICT.
- THE CONTRACTOR SHALL ALTER THE MASONRY OF THE TOP SECTION OF ALL EXISTING DRAINAGE STRUCTURES AS NECESSARY FOR CHANGES IN GRADE, AND RESET ALL WATER AND DRAINAGE FRAMES, GRATES, AND BOXES TO THE PROPOSED FINISH SURFACE GRADE.
- THE CONTRACTOR SHALL MAKE ALL ARRANGEMENTS FOR THE ALTERATION AND ADJUSTMENT OF ALL GAS, ELECTRIC, TELEPHONE, AND ANY OTHER PRIVATE UTILITIES BY THE UTILITY COMPANIES.
- CONTRACTOR SHALL MAINTAIN, OR ADJUST TO NEW FINISH GRADE, AS NECESSARY ALL UTILITY AND SITE STRUCTURES SUCH AS: LIGHT POLES, SIGN POLES, MANHOLES, CATCH BASINS, HAND HOLES, WATER AND GAS GATES, HYDRANTS, ETC., FROM MAINTAINED UTILITY AND SITE SYSTEMS, UNLESS OTHERWISE NOTED OR DIRECTED BY OWNER'S REPRESENTATIVE.
- ALL CEMENT LINED DUCTILE IRON JOINTS AT FITTINGS (CLASS 56,) VALVES, AND HYDRANT LATERALS SHALL BE MECHANICAL JOINT WITH NEOPRENE GASKETS. JOINTS AT OTHER LOCATIONS SHALL BE PUSH-ON TYPE WITH NEOPRENE OR SYNTHETIC RUBBER GASKETS. ALL WATER GATES SHALL OPEN AS PER CITY REQUIREMENTS. ALL WATER LINES SHALL HAVE A MINIMUM OF 5.5 FEET OF GROUND COVER AND A MINIMUM OF 10 FOOT SEPARATION FROM THE SEWER SYSTEM. AT WATER AND SEWER CROSSINGS, THE WATER LINE SHALL BE ENCASED IN SIX INCHES OF CONCRETE FOR A DISTANCE OF 10 FEET ON EITHER SIDE OF THE CROSSING.
- ALL SEWER PIPES SHALL BE PVC PER ASTM D3034, SDR-35 AND ASTM D1784 WITH RUBBER GASKET JOINTS.
- SITE LIGHTING IS SHOWN ON THIS PLAN FOR COORDINATION PURPOSES ONLY. REFER TO ELECTRICAL PLANS FOR EXACT TYPE AND LOCATION.
- REFER TO ELECTRICAL PLANS FOR SECTIONS AND DETAILS OF THE UTILITY DUCT BANK.
- AREAS OUTSIDE THE LIMITS OF PROPOSED WORK DISTURBED BY THE CONTRACTOR'S OPERATIONS SHALL BE RESTORED BY THE CONTRACTOR TO THEIR ORIGINAL CONDITION, AT THE CONTRACTOR'S EXPENSE.
- REFER TO ARCHITECTURAL PLANS FOR PROPOSED LOCATION OF UTILITY SERVICE STUBS AT BUILDING.
- THE LOCATION, SIZE, DEPTH, AND SPECIFICATIONS FOR CONSTRUCTION OF PRIVATE UTILITY SERVICES SHALL BE INSTALLED ACCORDING TO THE REQUIREMENTS PROVIDED BY, AND APPROVED BY, THE RESPECTIVE UTILITY COMPANY (GAS, TELEPHONE, ELECTRICAL.) FINAL DESIGN AND LOCATIONS AT THE BUILDING WILL BE PROVIDED BY THE ARCHITECT. THE CONTRACTOR SHALL COORDINATE THE INSTALLATION OF THE UTILITY CONNECTIONS WITH THE RESPECTIVE COMPANIES PRIOR TO ANY UTILITY CONSTRUCTION.
- PROTECT AND MAINTAIN EXISTING ON-SITE DRAINAGE STRUCTURES AND PIPES UNLESS OTHERWISE NOTED.
- WHERE PROPOSED GRADES MEET EXISTING GRADES, CONTRACTOR SHALL BLEND GRADES TO PROVIDE A SMOOTH TRANSITION BETWEEN EXISTING AND NEW WORK. PONDING AT TRANSITION AREAS WILL NOT BE ALLOWED.
- CONTRACTOR SHALL MAINTAIN POSITIVE DRAINAGE AWAY FROM ALL BUILDING FOUNDATIONS, STRUCTURES AND PLANTING BEDS.
- MAXIMUM SLOPE IN DISTURBED AREAS SHALL NOT EXCEED 3:1, UNLESS OTHERWISE
- ENSURE ALL EXISTING (TO REMAIN), AND PROPOSED MANHOLE COVERS PROPERLY IDENTIFY UTILITY SERVICED.
- CONTRACTOR SHALL VERIFY EXISTING GRADES AND NOTIFY OWNER'S REPRESENTATIVE OF ANY DISCREPANCIES.
- BITUMINOUS CONCRETE ELEVATIONS AT CATCH BASINS TO BE 1/4 INCH ABOVE RIM ELEVATION SHOWN FOR CATCH.
- SCREENED IMAGES SHOW EXISTING CONDITIONS. WHERE EXISTING CONDITIONS LIE UNDER OR ARE IMPINGED UPON BY PROPOSED BUILDINGS AND/OR SITE ELEMENTS, THE EXISTING CONDITION WILL BE REMOVED, ABANDONED AND/OR CAPPED OR DEMOLISHED AS REQUIRED.

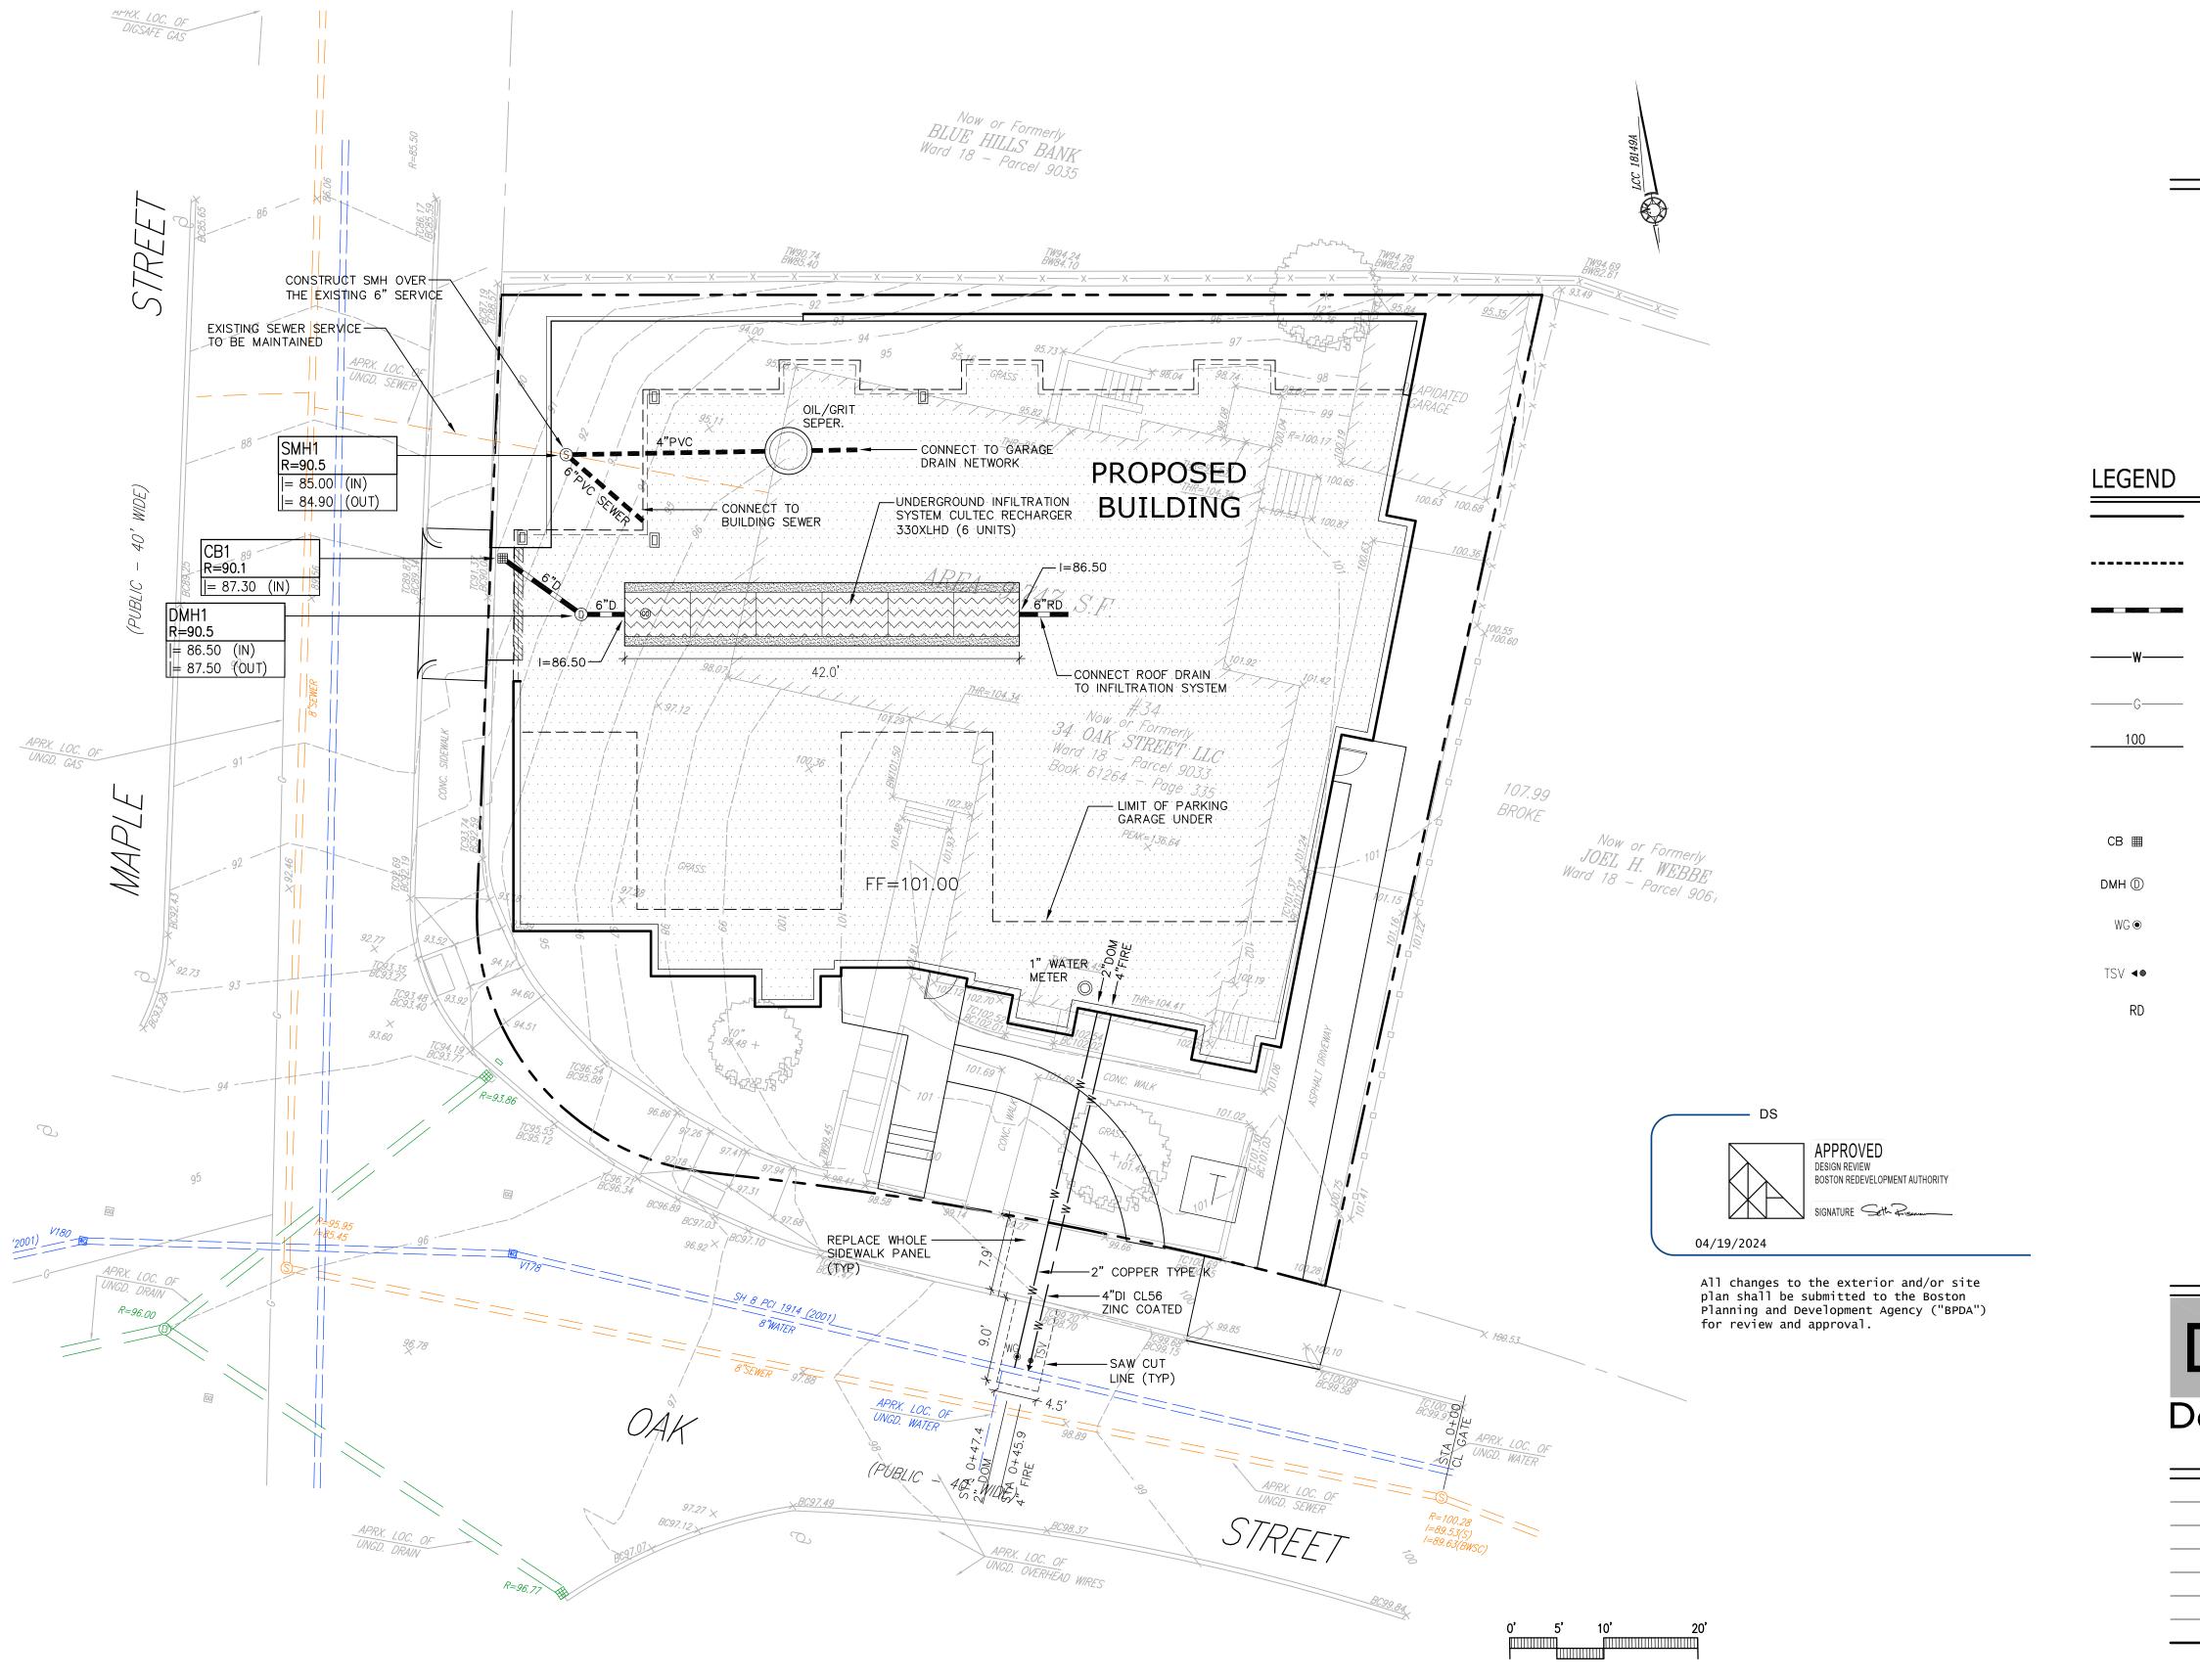



Land Planning, Civil Engineering, Landscape Architecture Po Box 307 Foxborough, MA www.develliszrein.com tel. 508.473.4114


DeVellis Zrein Inc.



SCALE:	1" = 10'	
JOB:	2G1S <b>-</b> 553	
FILE:		
DRAWN:	IAZ	
CHECKED:		
DATE:	02.02.24	

### PLANTING NOTES

- EXISTING CONDITIONS INFORMATION IS REPRODUCED FROM THE SURVEY PREPARED BY FRAMINGHAM SURVEY CONSULTANTS INC OF FRAMINGHAM, MA AND IS DATED FEBRUARY 14, 2024.
- 2. THE LOCATIONS OF UNDERGROUND UTILITIES SHOWN ARE BASED ON THE SURVEY REFERENCED ABOVE. THE CONTRACTOR SHALL CONTACT DIGSAFE AND THE PROPER LOCAL AUTHORITIES OR RESPECTIVE UTILITY COMPANIES TO CONFIRM THE LOCATION OF ALL EXISTING UTILITIES BEFORE COMMENCING WORK. ANY DAMAGE DUE TO FAILURE OF THE CONTRACTOR TO CONTACT THE PROPER AUTHORITIES SHALL BE BORNE BY THE CONTRACTOR.
- 3. CONTRACTOR SHALL BEGIN MAINTENANCE IMMEDIATELY AFTER PLANTING AND WILL CONTINUE UNTIL FINAL WRITTEN ACCEPTANCE OF PLANT MATERIAL.
- 4. LANDSCAPE ARCHITECT TO FLAG ALL TREES TO BE TRANSPLANTED PRIOR TO CONSTRUCTION START.
- 5. CONTRACTOR SHALL VERIFY ALL TREE REMOVALS AND/OR TRANSPLANTS WITH OWNER'S REPRESENTATIVE PRIOR TO CONSTRUCTION START.
- 6. CONTRACTOR SHALL MAINTAIN POSITIVE DRAINAGE AWAY FROM ALL BUILDING FOUNDATIONS, STRUCTURES, AND PLANTING BEDS.
- 7. MAXIMUM SLOPE WITHIN DISTURBED AREAS SHALL NOT EXCEED 3:1, UNLESS OTHERWISE NOTED.
- 8. THE LANDSCAPE CONTRACTOR SHALL SUPPLY ALL PLANT MATERIALS IN QUANTITIES SUFFICIENT TO COMPLETE ALL PLANTINGS SHOWN ON THIS DRAWING.
- 9. ALL MATERIALS SHALL CONFORM TO THE GUIDELINES ESTABLISHED BY THE AMERICAN NURSERY AND LANDSCAPE ASSOCIATION.
- 10. ALL PLANTS SHALL BEAR THE SAME RELATIONSHIP TO FINISH GRADE AS TO ORIGINAL GRADES BEFORE DIGGING.
- 11. ALL PLANTS TO BE BALLED IN BURLAP OR CONTAINERIZED.
- 12. MULCH FOR PLANTED AREAS TO BE AGED PINE BARK:
  PARTIALLY DECOMPOSED, DARK BROWN IN COLOR AND FREE OF
  WOOD CHIPS THICKER THAN 1/4 INCH.
- 13. PLANTING SOIL MIX: LOAM THOROUGHLY INCORPORATED WITH ROTTED MANURE PROPORTIONED 5 C.Y. TO 1 C.Y. OR EQUIVALENT. FERTILIZER ADDED PER RECOMMENDED RATES OF SOILS ANALYSIS.
- 14. THE LANDSCAPE CONTRACTOR SHALL GUARANTEE ALL PLANT MATERIALS FOR ONE (1) FULL YEAR FROM DATE OF ACCEPTANCE.
- 15. ALL PLANT MATERIALS ARE SUBJECT TO THE APPROVAL OF THE LANDSCAPE ARCHITECT, AT THE NURSERY, AND AT THE
- 16. ALL AREAS OF THE SITE WHICH HAVE BEEN DISTURBED AND NOT OTHERWISE DEVELOPED SHALL BE LOAMED AND SEEDED WITH A MINIMUM DEPTH OF 6" DEPTH TOPSOIL.
- 17. PLANT SPECIES AS INDICATED IN THE PLANT LIST ARE SUGGESTIONS ONLY. FINAL SELECTION OF SPECIES SHALL OCCUR AT THE TIME OF PLANT PURCHASE, DEPENDING ON AVAILABILITY. PLANT SIZE AND QUANTITY SHALL NOT CHANGE WITHOUT APPROVAL OF OWNER'S REPRESENTATIVE.

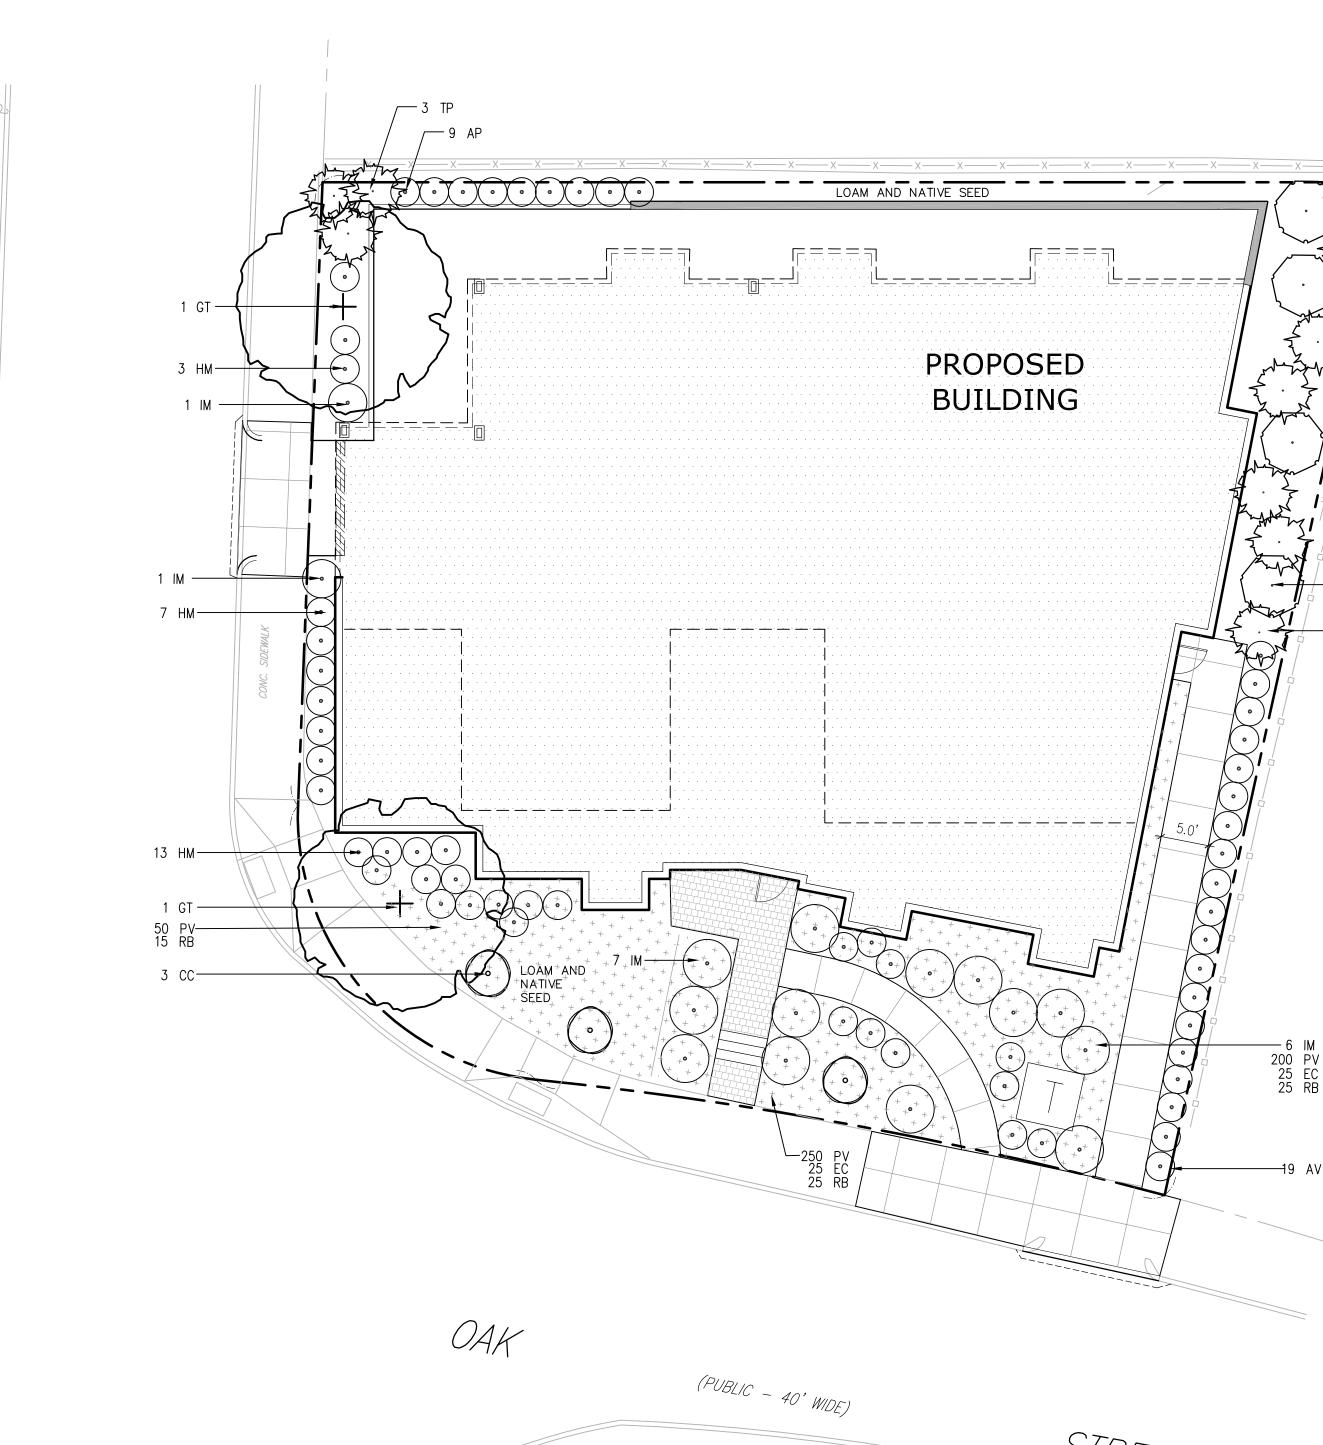

## PLANT SCHEDULE

SYMBOL	BOTANICAL NAME	COMMON NAME	QTY	SIZE	COMMENT
DECIDUOUS	TREES				
GT	GLEDITSIA TRIACANTHOS 'INERMIS'	THORNLESS HONEYLOCUST	2	2 -2 1/2" CAL.	
EVERGREEN	TREES	<u>'</u>			
TP	THUJA occidentalis	EASTERN WHITE CEDAR	10	5-6' HT.	
ORNAMENTA	L TREES	•			
AC	AMELANCHIER CANADENSIS	SHADBLOW	5	6-7' HT.	
CC	CERCIS CANADENSIS	EASTERN RED BUD	2	6-7' HT.	
SHRUBS			<u>.</u>	•	
НМ	HYDRANGEA MACR. MINI PENNY	MINI PENNY HYDRANGEA	23	24-36" HT.	
IM	ILEX MESERVAE 'BLUE PRINCESS'	BLUE PRINCESS HOLLY	15	24-36" HT.	
A۷	AZALEA VISCOSUM	WHITE NATIVE AZALEA	24	24-36" HT.	
AP	THUJA OCCIDENTALIS	EMERALD GREEN ARBORVITAE	9	24-36" HT.	
PERENNIALS	S, GROUNDCOVER AND ORNAMENTAL GRASSSES		50	1 GAL.	
EC	ECHINACEA PURPUREA	PINK CONE FLOWER	300	4" POTS	
PV	PANICUM VIRGATUM	SWITCH GRASS	65	1 GAL.	
RB	RUDBECKIA 'GOLDSTRUM'	BLACK EYED SUSAN			

NATIVE SEED BLEND 30% HARD FESCUE 25% PER. RYE 25% LITTLE BLUESTEM 20% SWITCHGRASS


# PROPOSED HOUSING DEVELOPMENT

34 OAK STREET HYDE PARK, MA


### PLANTING LEGEND

PROPERTY LINE


GROUNDCOVER / PERENNIAL PLANTING

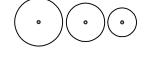


SHRUB PLANTING

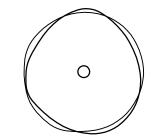

ORNAMENTAL TREE

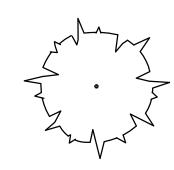

EVERGREEN TREE

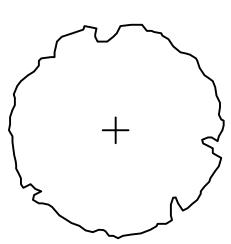

DECIDUOUS TREE



DeVellis Zrein Inc.



APPROVED DESIGN REVIEW

All changes to the exterior and/or site plan shall be submitted to the Boston Planning and Development Agency ("BPDA")

for review and approval.

04/19/2024

BOSTON REDEVELOPMENT AUTHORITY

SIGNATURE Seth Fisenen

# PLANTING PLAN


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JOB:	2G1S-553	
FILE:		
DRAWN:	IAZ	
CHECKED:		
DATE:	02.02.24	

C-3

FLOOR PLAN LEGEND 580 HARRISON AVE, SUITE 2W BOSTON, MA 02118 O: 617.765.8000 www.embarcdesign.com

LVT - LAMINATE

WD - WOOD

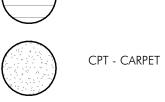



Diarmaid McGregor CONSULTANTS

OWNER


34 OAK STREET BOSTON, MA 02136 REVISIONS



DRAWING INFORMATION ISSUE: <u>ISSUED FOR CONSTRUCTION</u> DATE: MARCH 25, 2024 PROJECT #: 21004

SCALE: 1/4" = 1'-0" DRAWING TITLE PROPOSED PLANS - BASEMENT LEVEL

DRAWING NUMBER copyright: EMBARC INC.

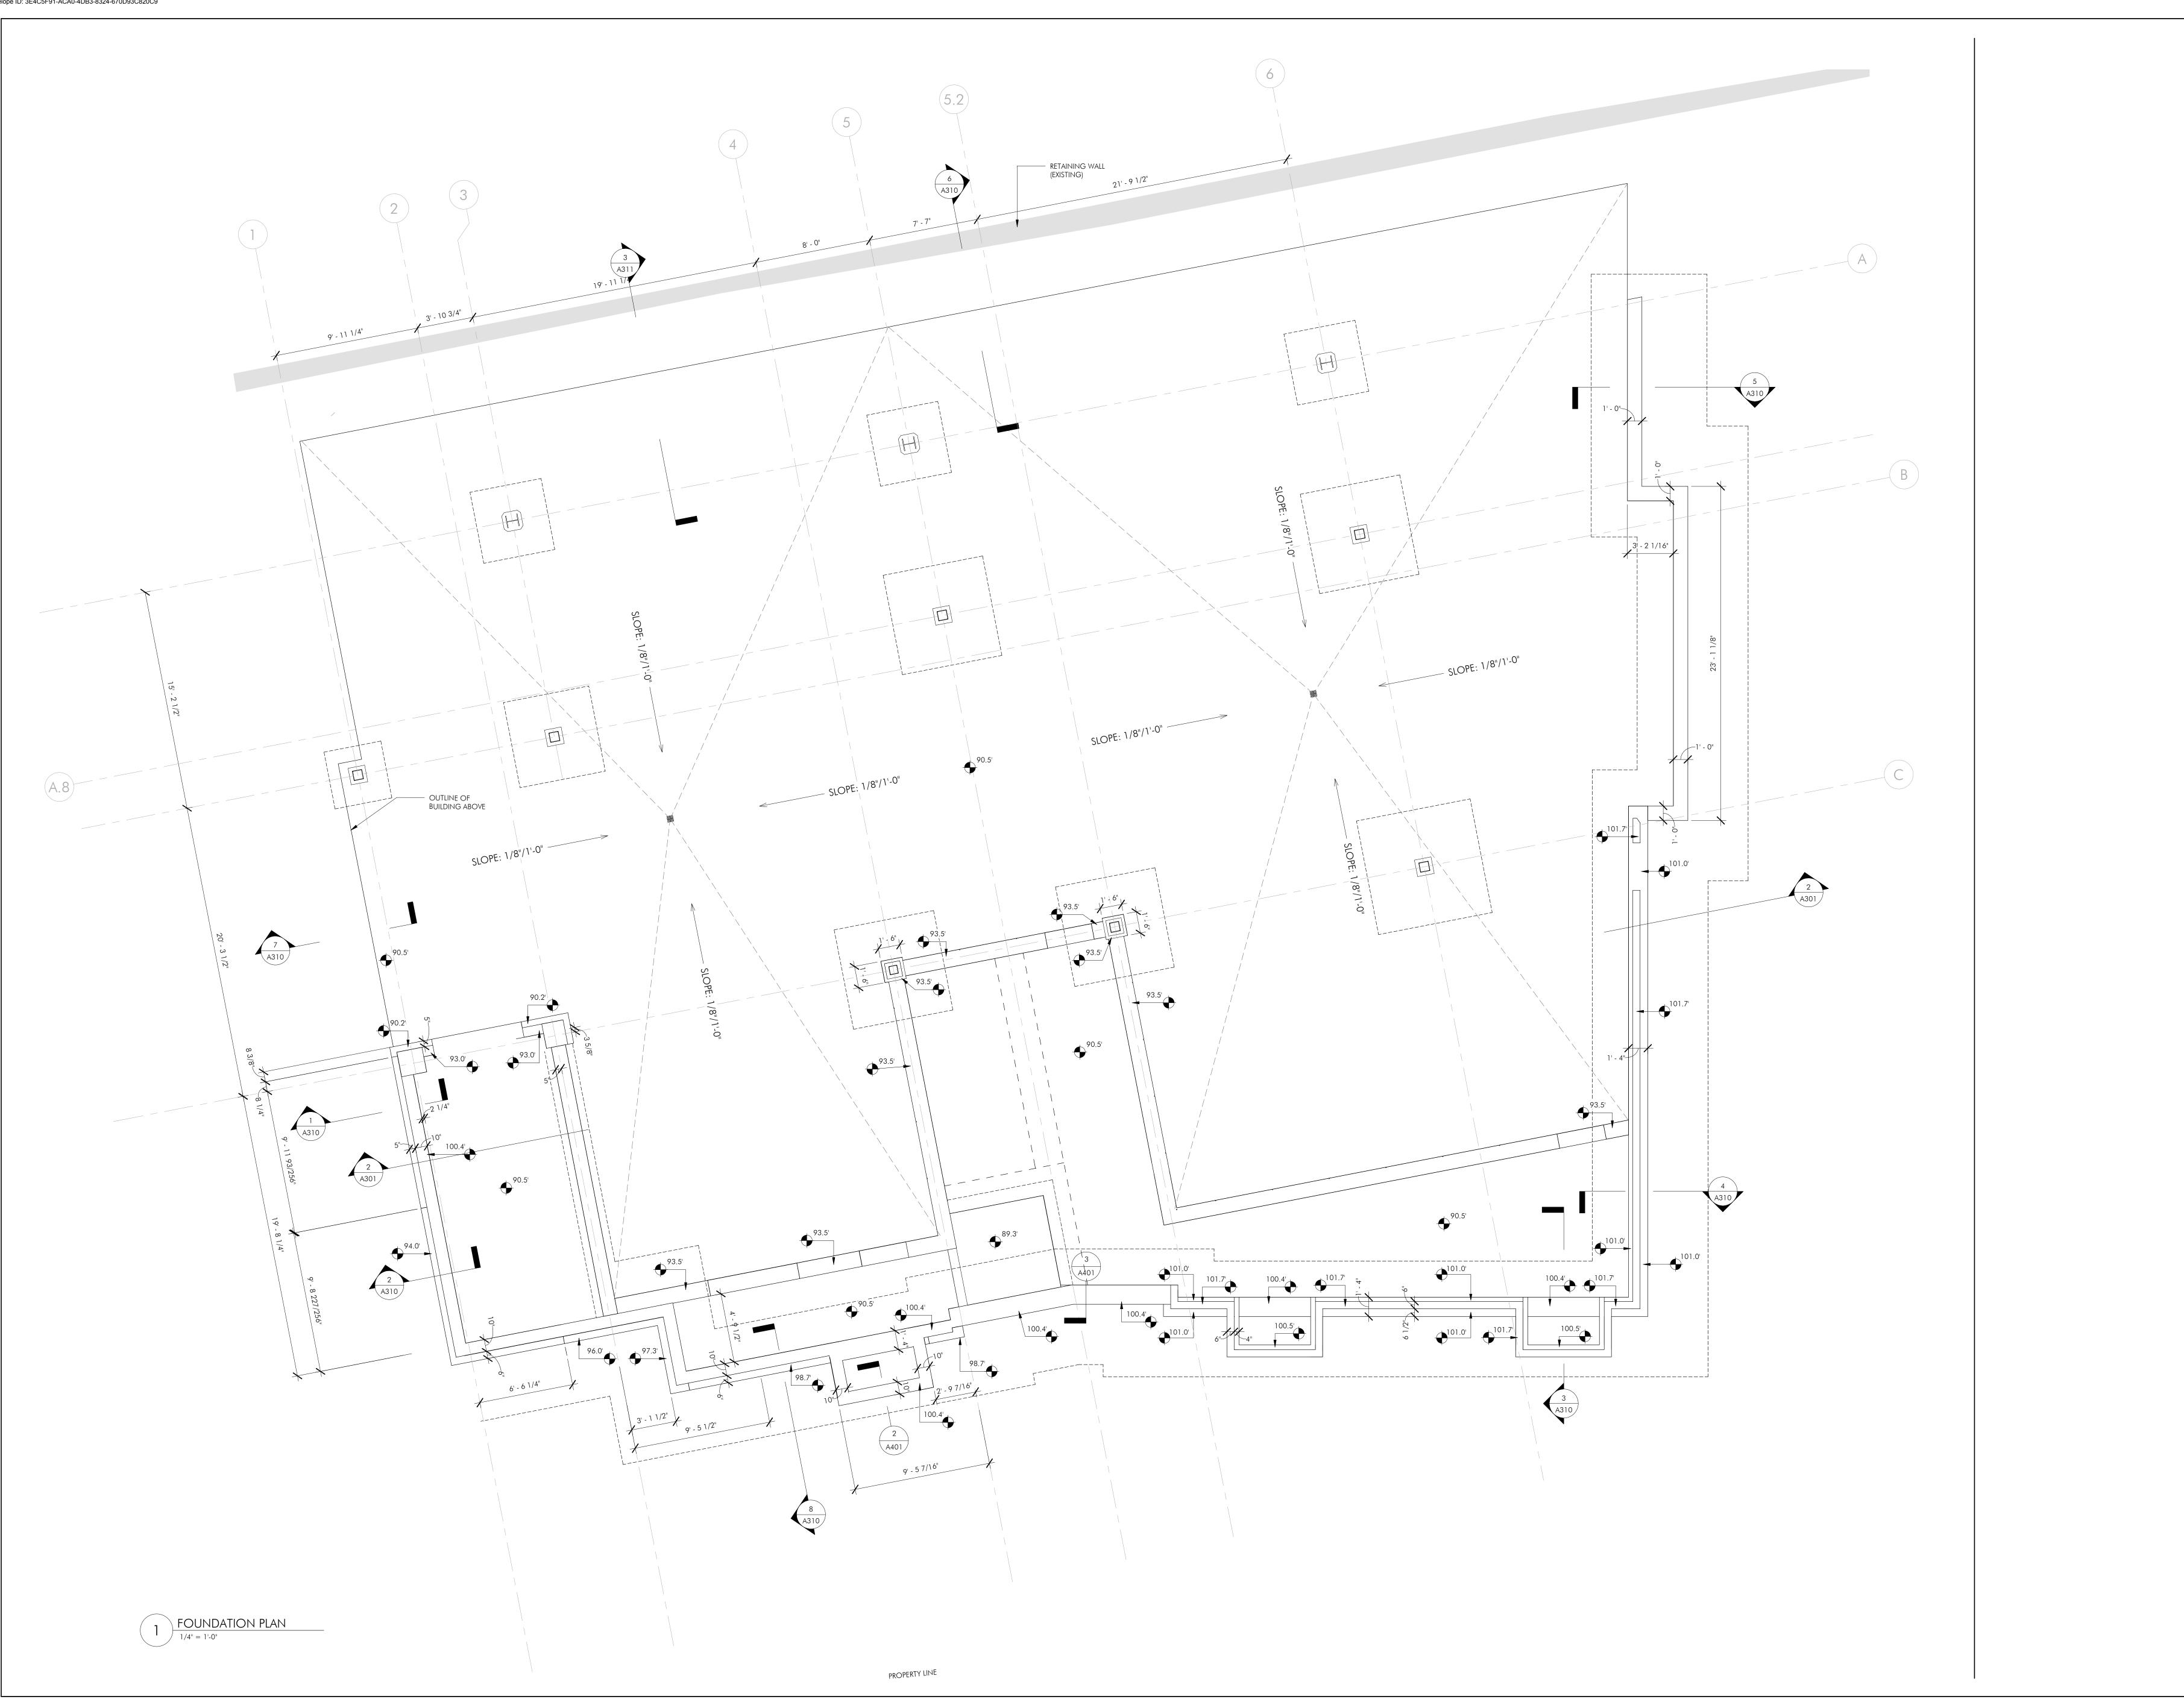

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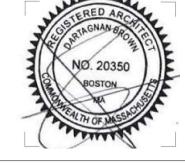
OWNER

Diarmaid McGregor

CONSULTANTS

34 OAK STREET BOSTON, MA 02136

REVISIONS




DRAWING INFORMATION DATE: MARCH 25, 2024

PROJECT #: 21004 SCALE: 1/4" = 1'-0"

PLAN

DRAWING NUMBER A101.B

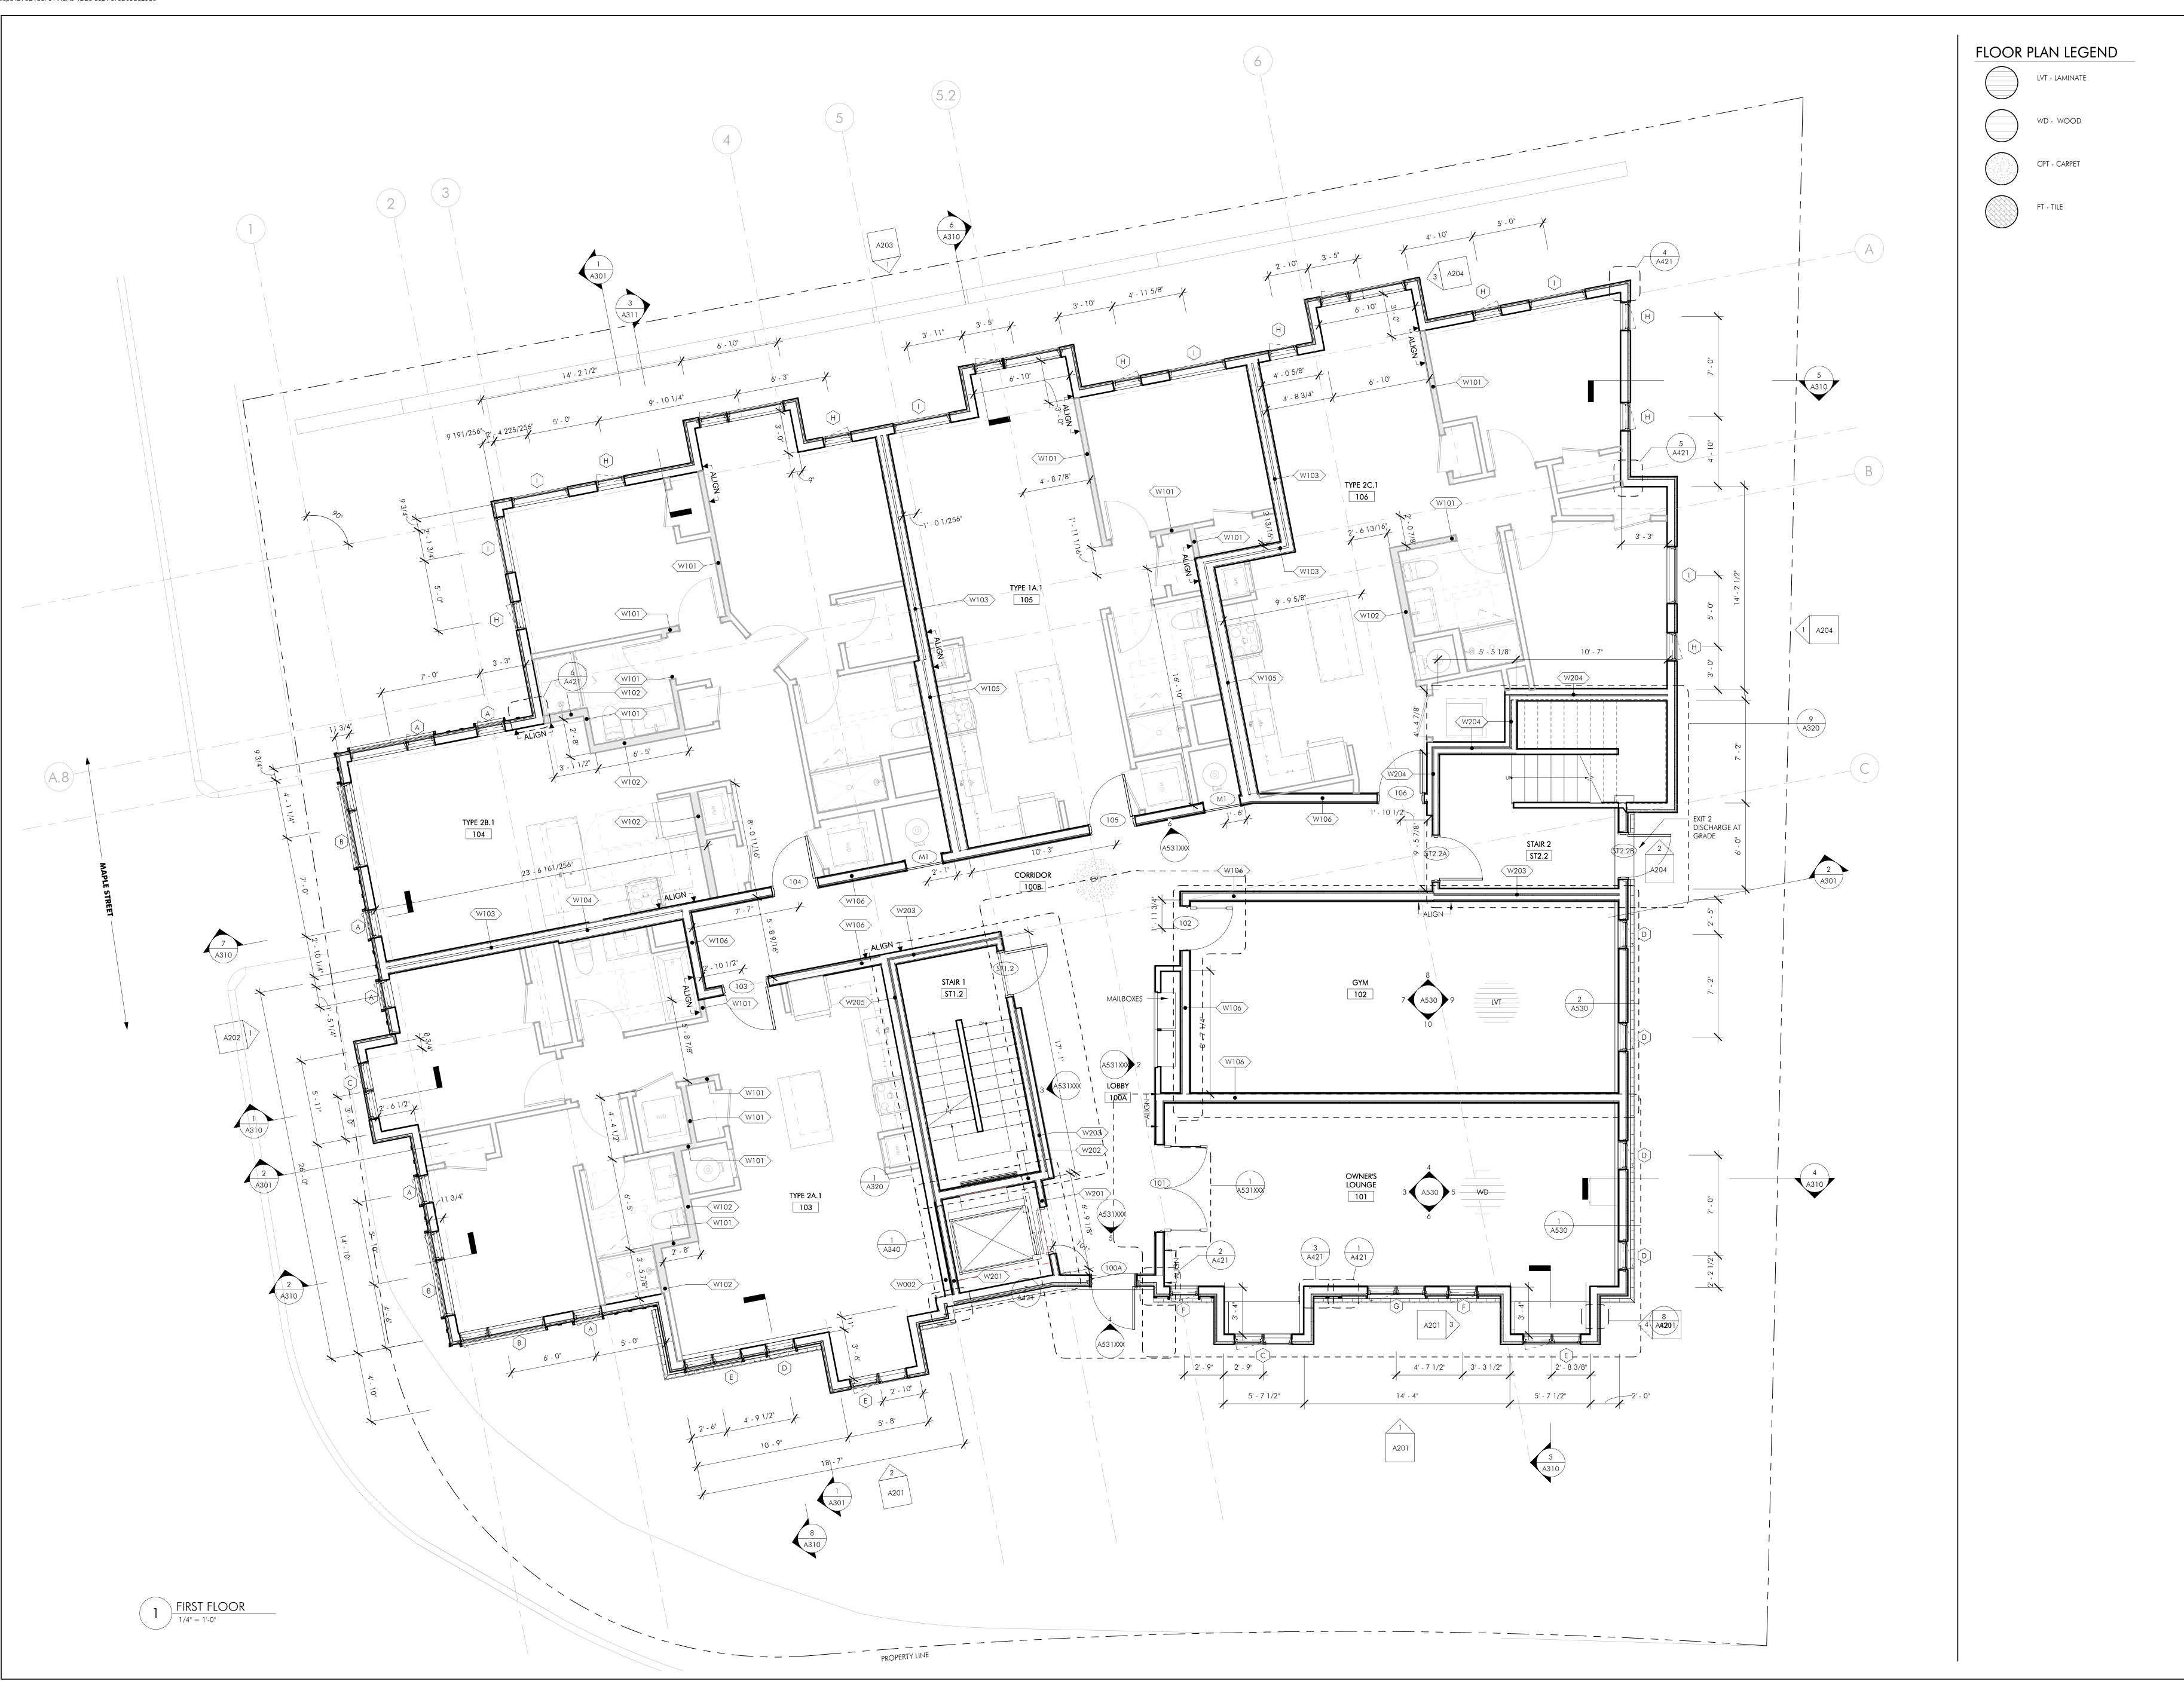

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CONSULTANTS


REVISIONS



DRAWING INFORMATION ISSUE: <u>ISSUED FOR CONSTRUCTION</u> DATE: <u>MARCH 25, 2024</u>


PROJECT #: 21004 SCALE: 1/4" = 1'-0"

DRAWING TITLE PROPOSED PLANS - FIRST LEVEL

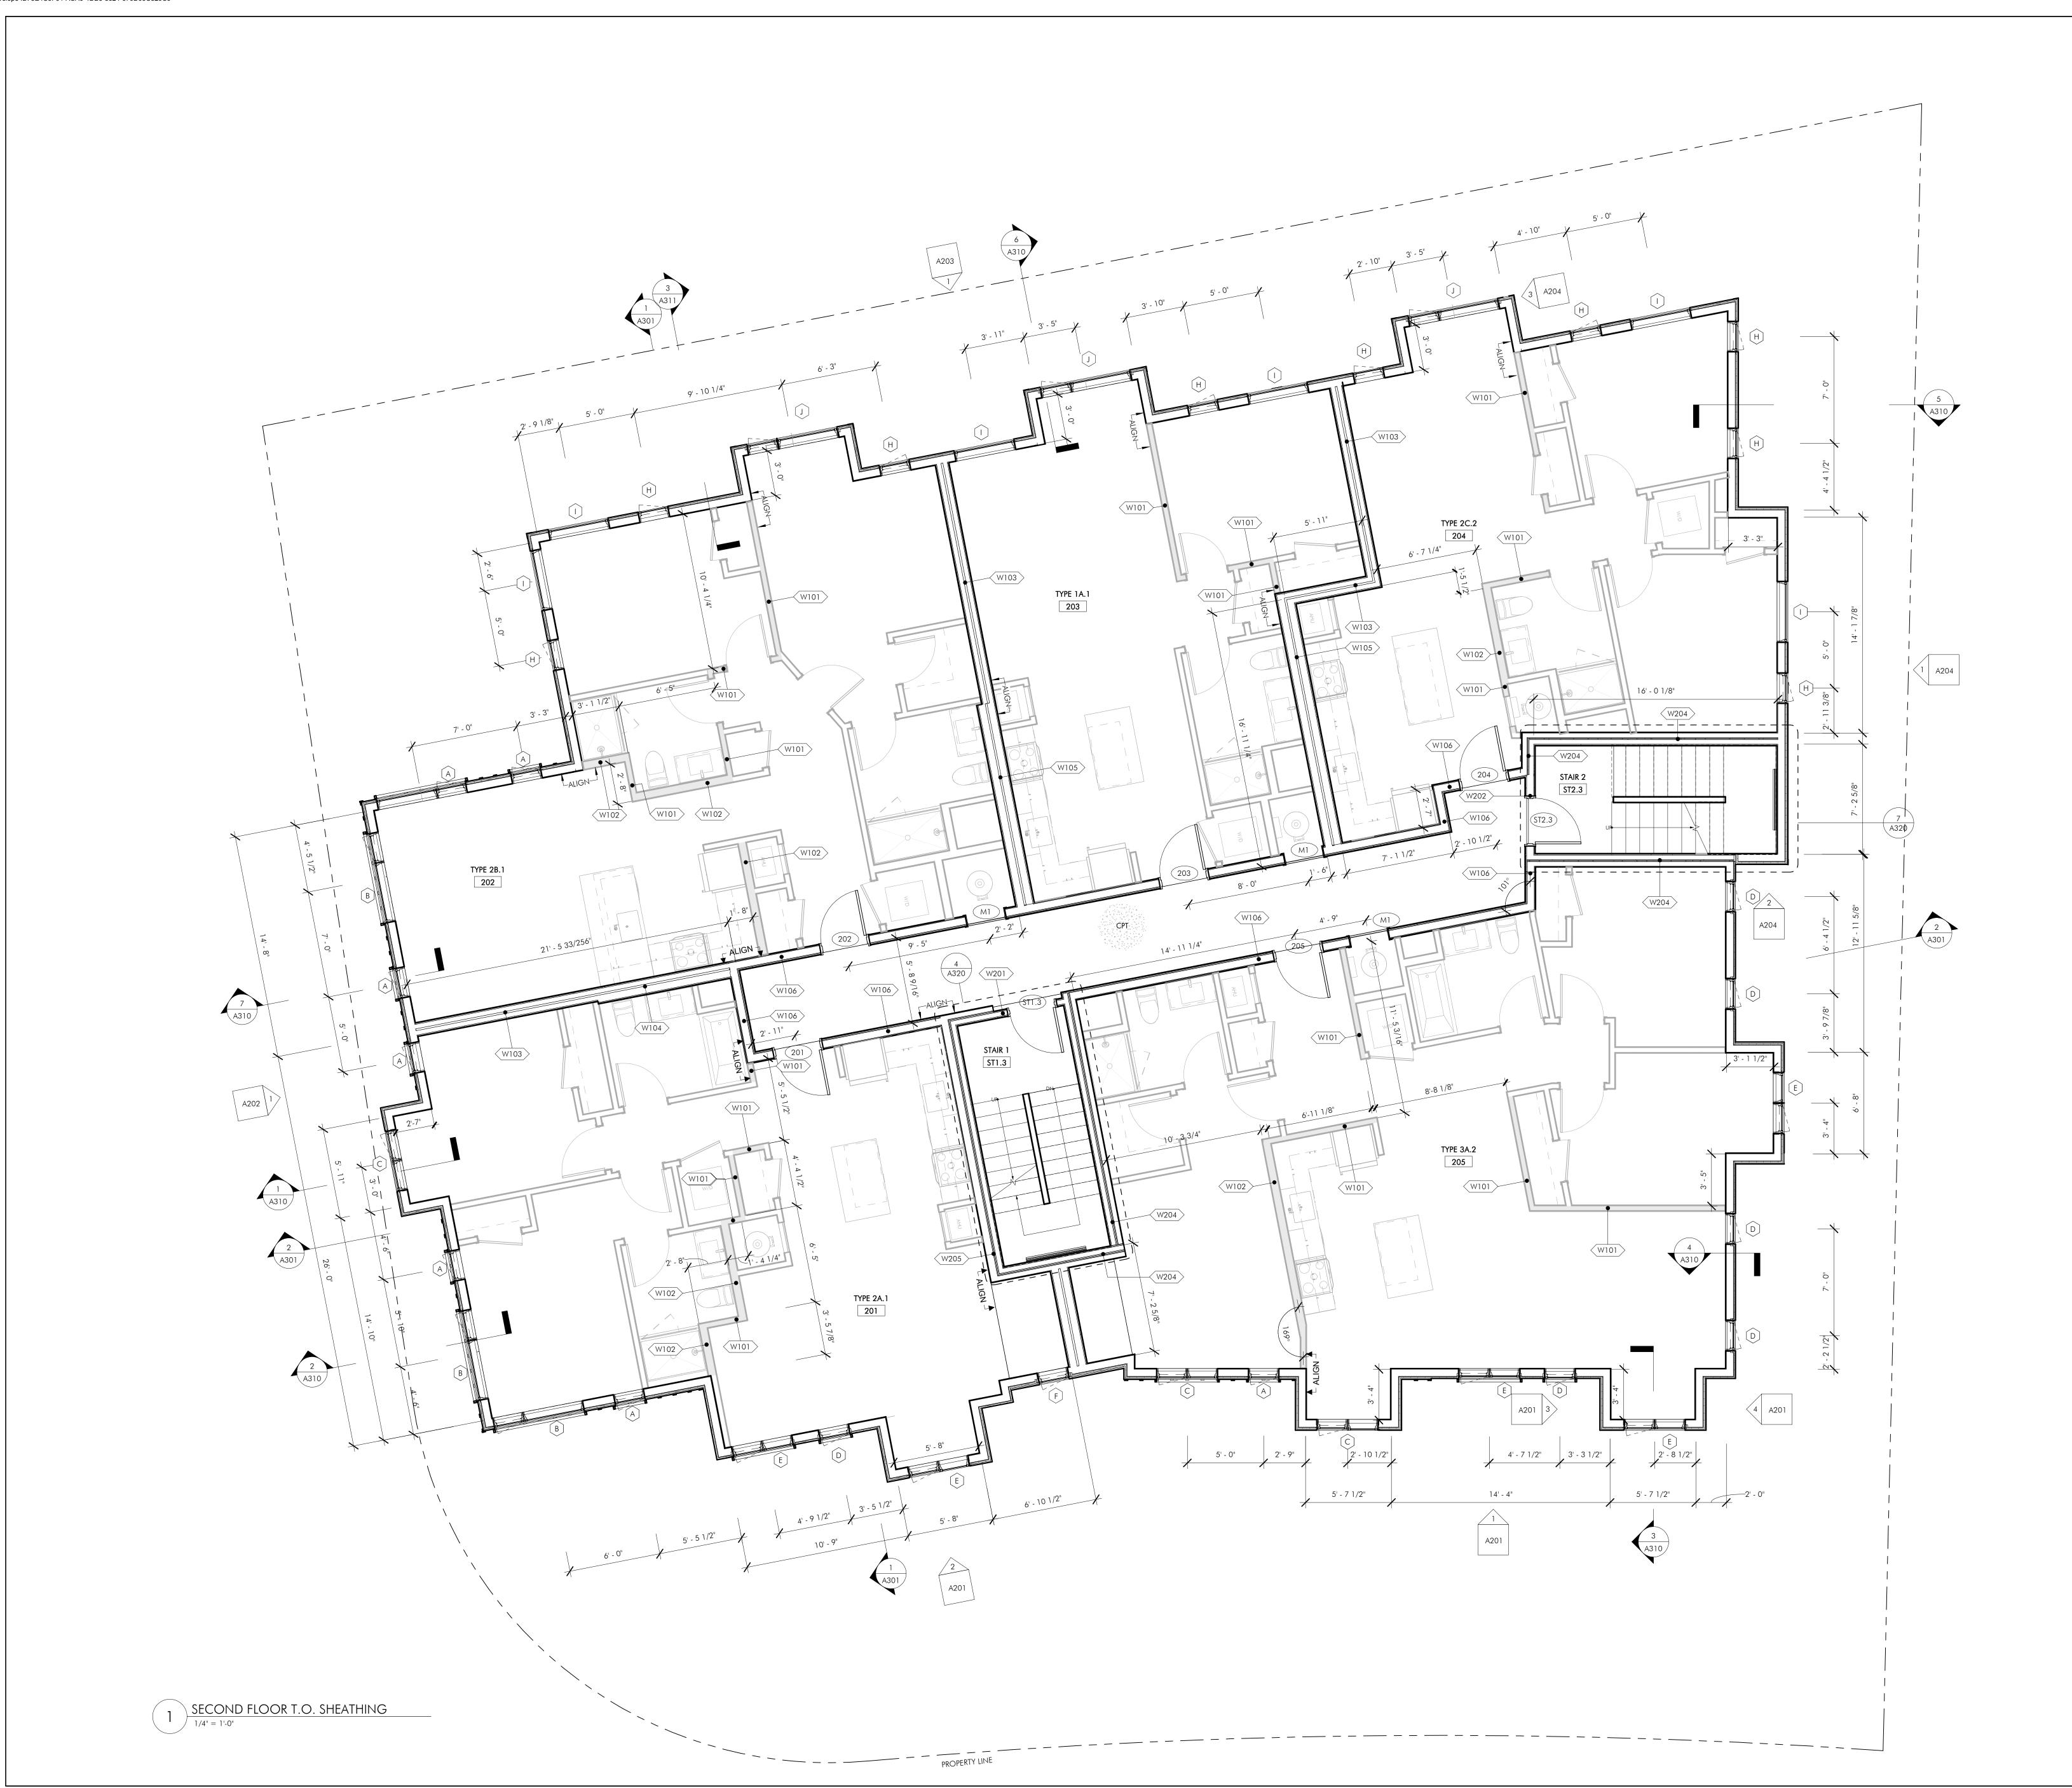

FLOOR PLAN LEGEND

LVT - LAMINATE

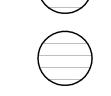



CONSULTANTS

Diarmaid McGregor


580 HARRISON AVE, SUITE 2W BOSTON, MA 02118 O: 617.765.8000 www.embarcdesign.com



DRAWING INFORMATION ISSUE: ISSUED FOR CONSTRUCTION DATE: MARCH 25, 2024

PROJECT #: 21004 SCALE: 1/4" = 1'-0"

DRAWING TITLE PROPOSED PLANS - SECOND LEVEL

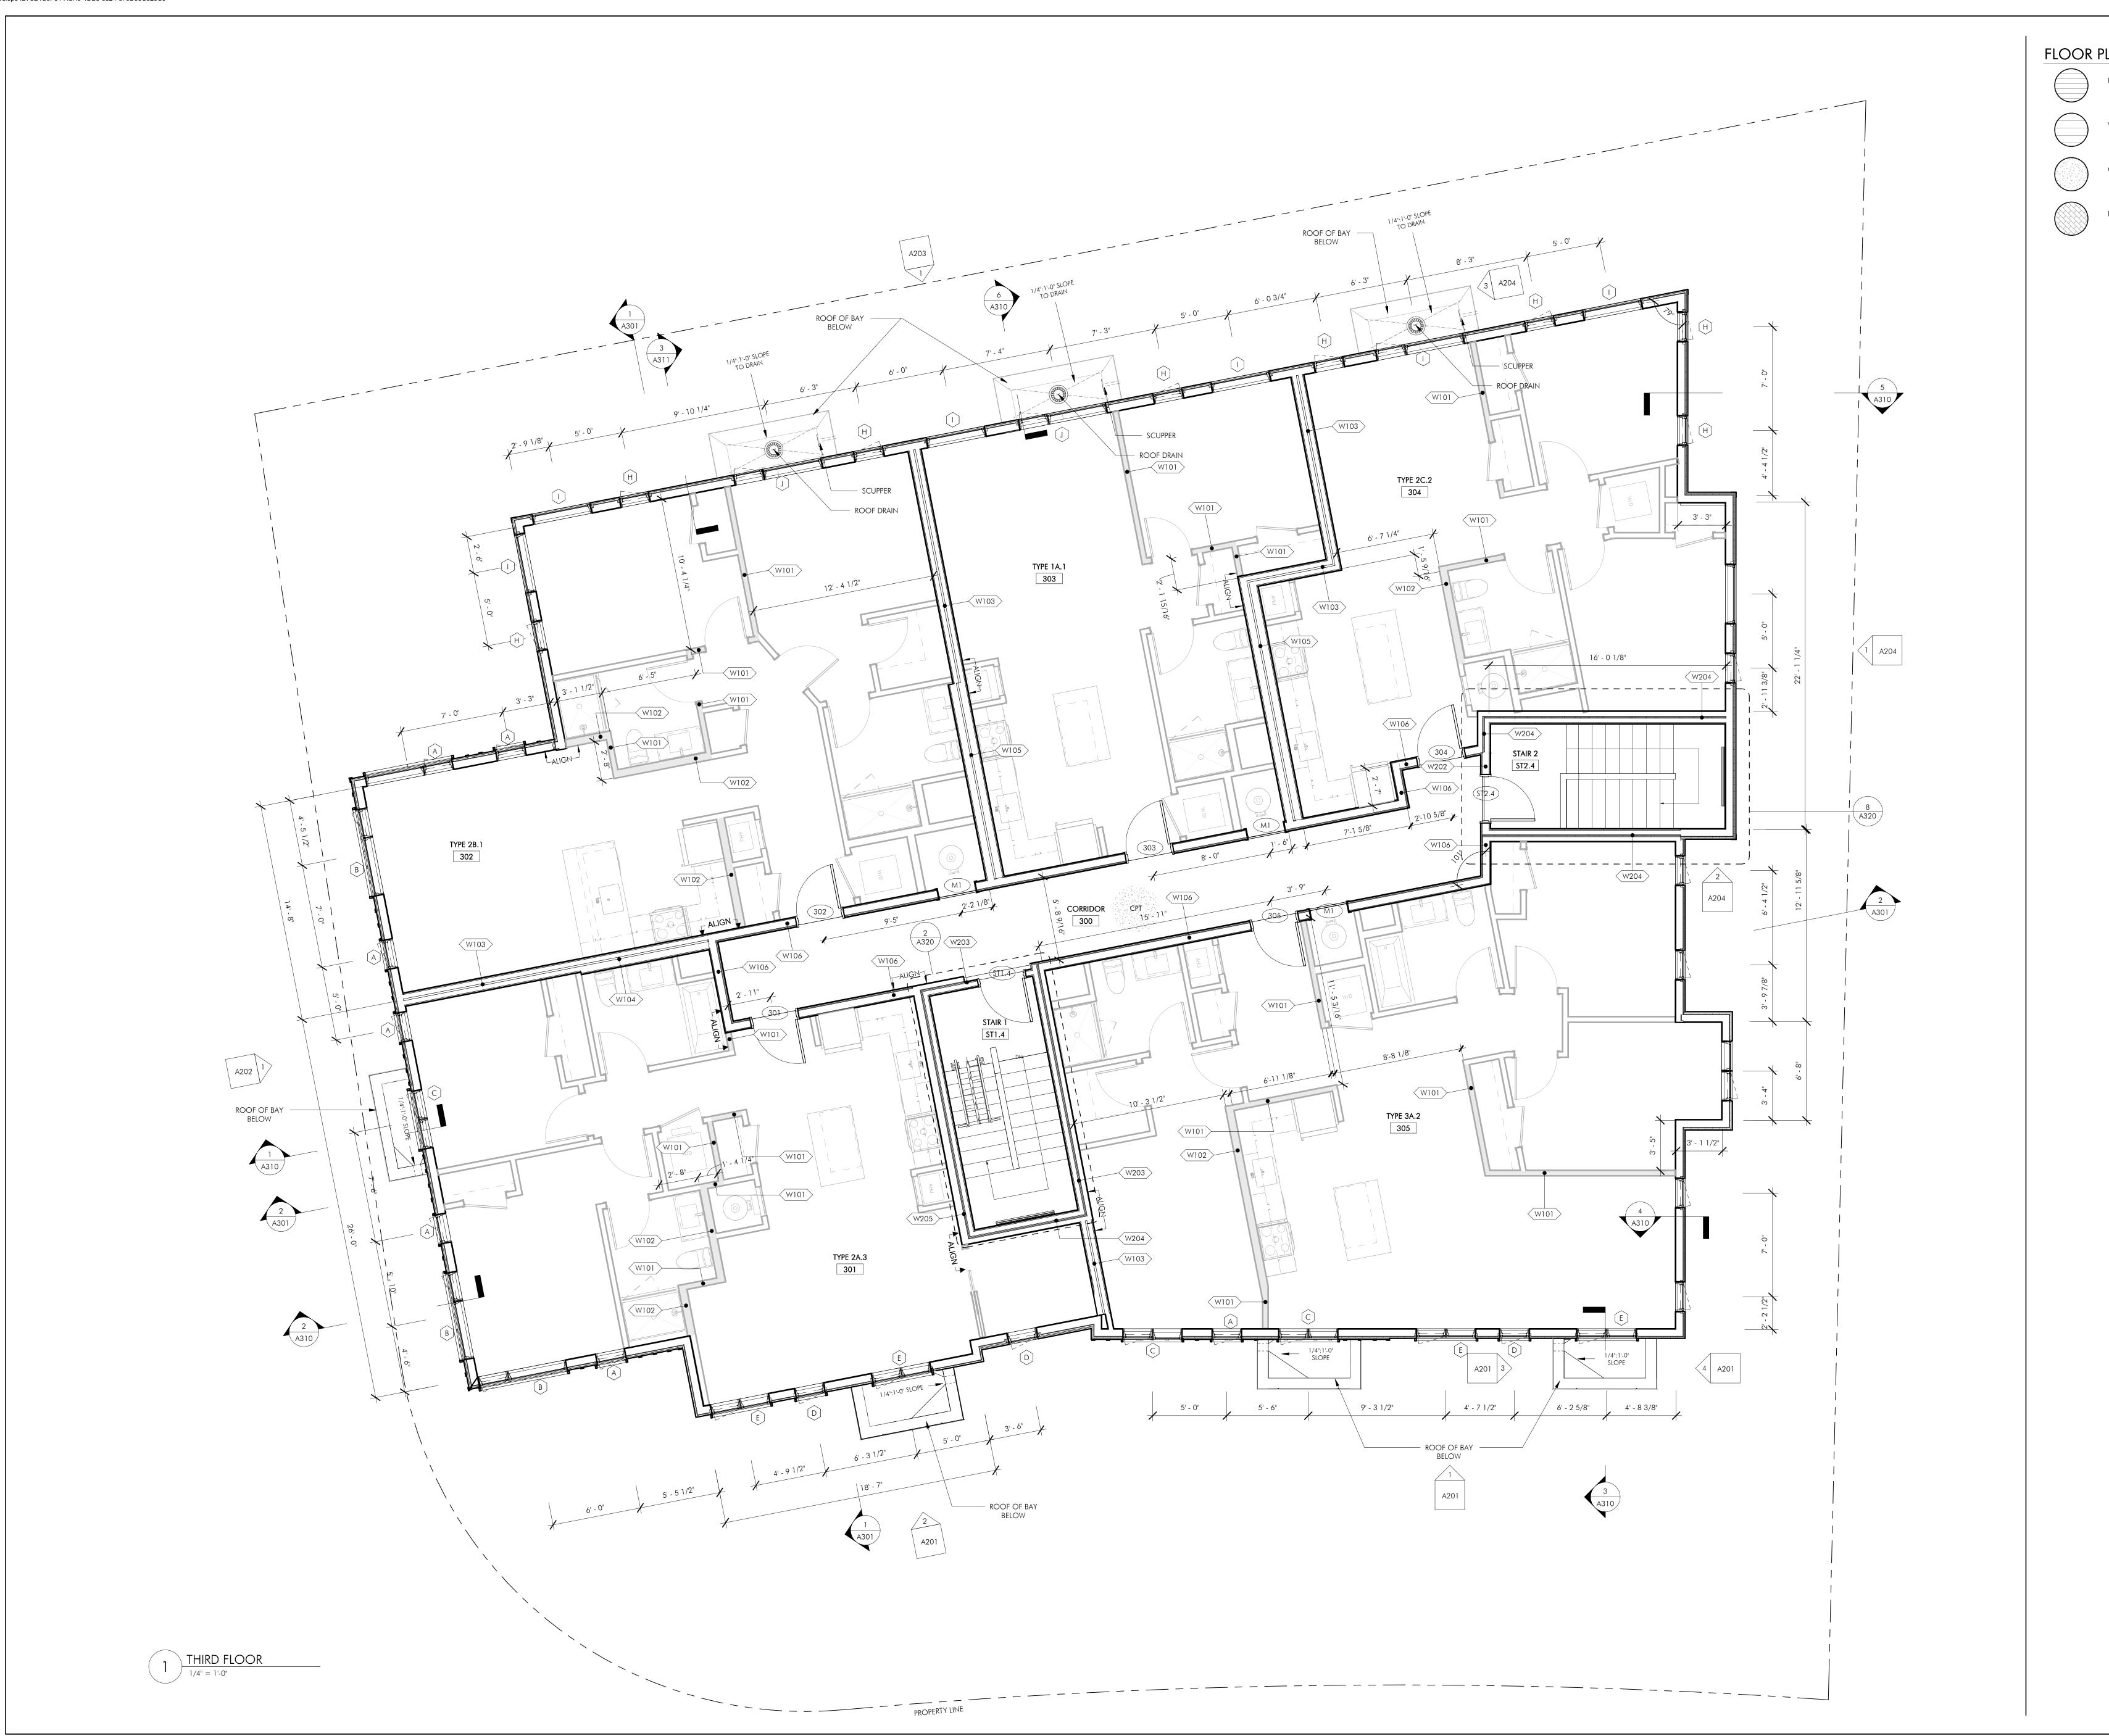

FLOOR PLAN LEGEND

LVT - LAMINATE

CONSULTANTS

Diarmaid McGregor


580 HARRISON AVE, SUITE 2W BOSTON, MA 02118 O: 617.765.8000 www.embarcdesign.com

DRAWING INFORMATION

ISSUE: ISSUED FOR CONSTRUCTION DATE: MARCH 25, 2024 PROJECT #: 21004 SCALE: 1/4" = 1'-0"

REVISIONS

DRAWING TITLE PROPOSED PLANS - THIRD LEVEL

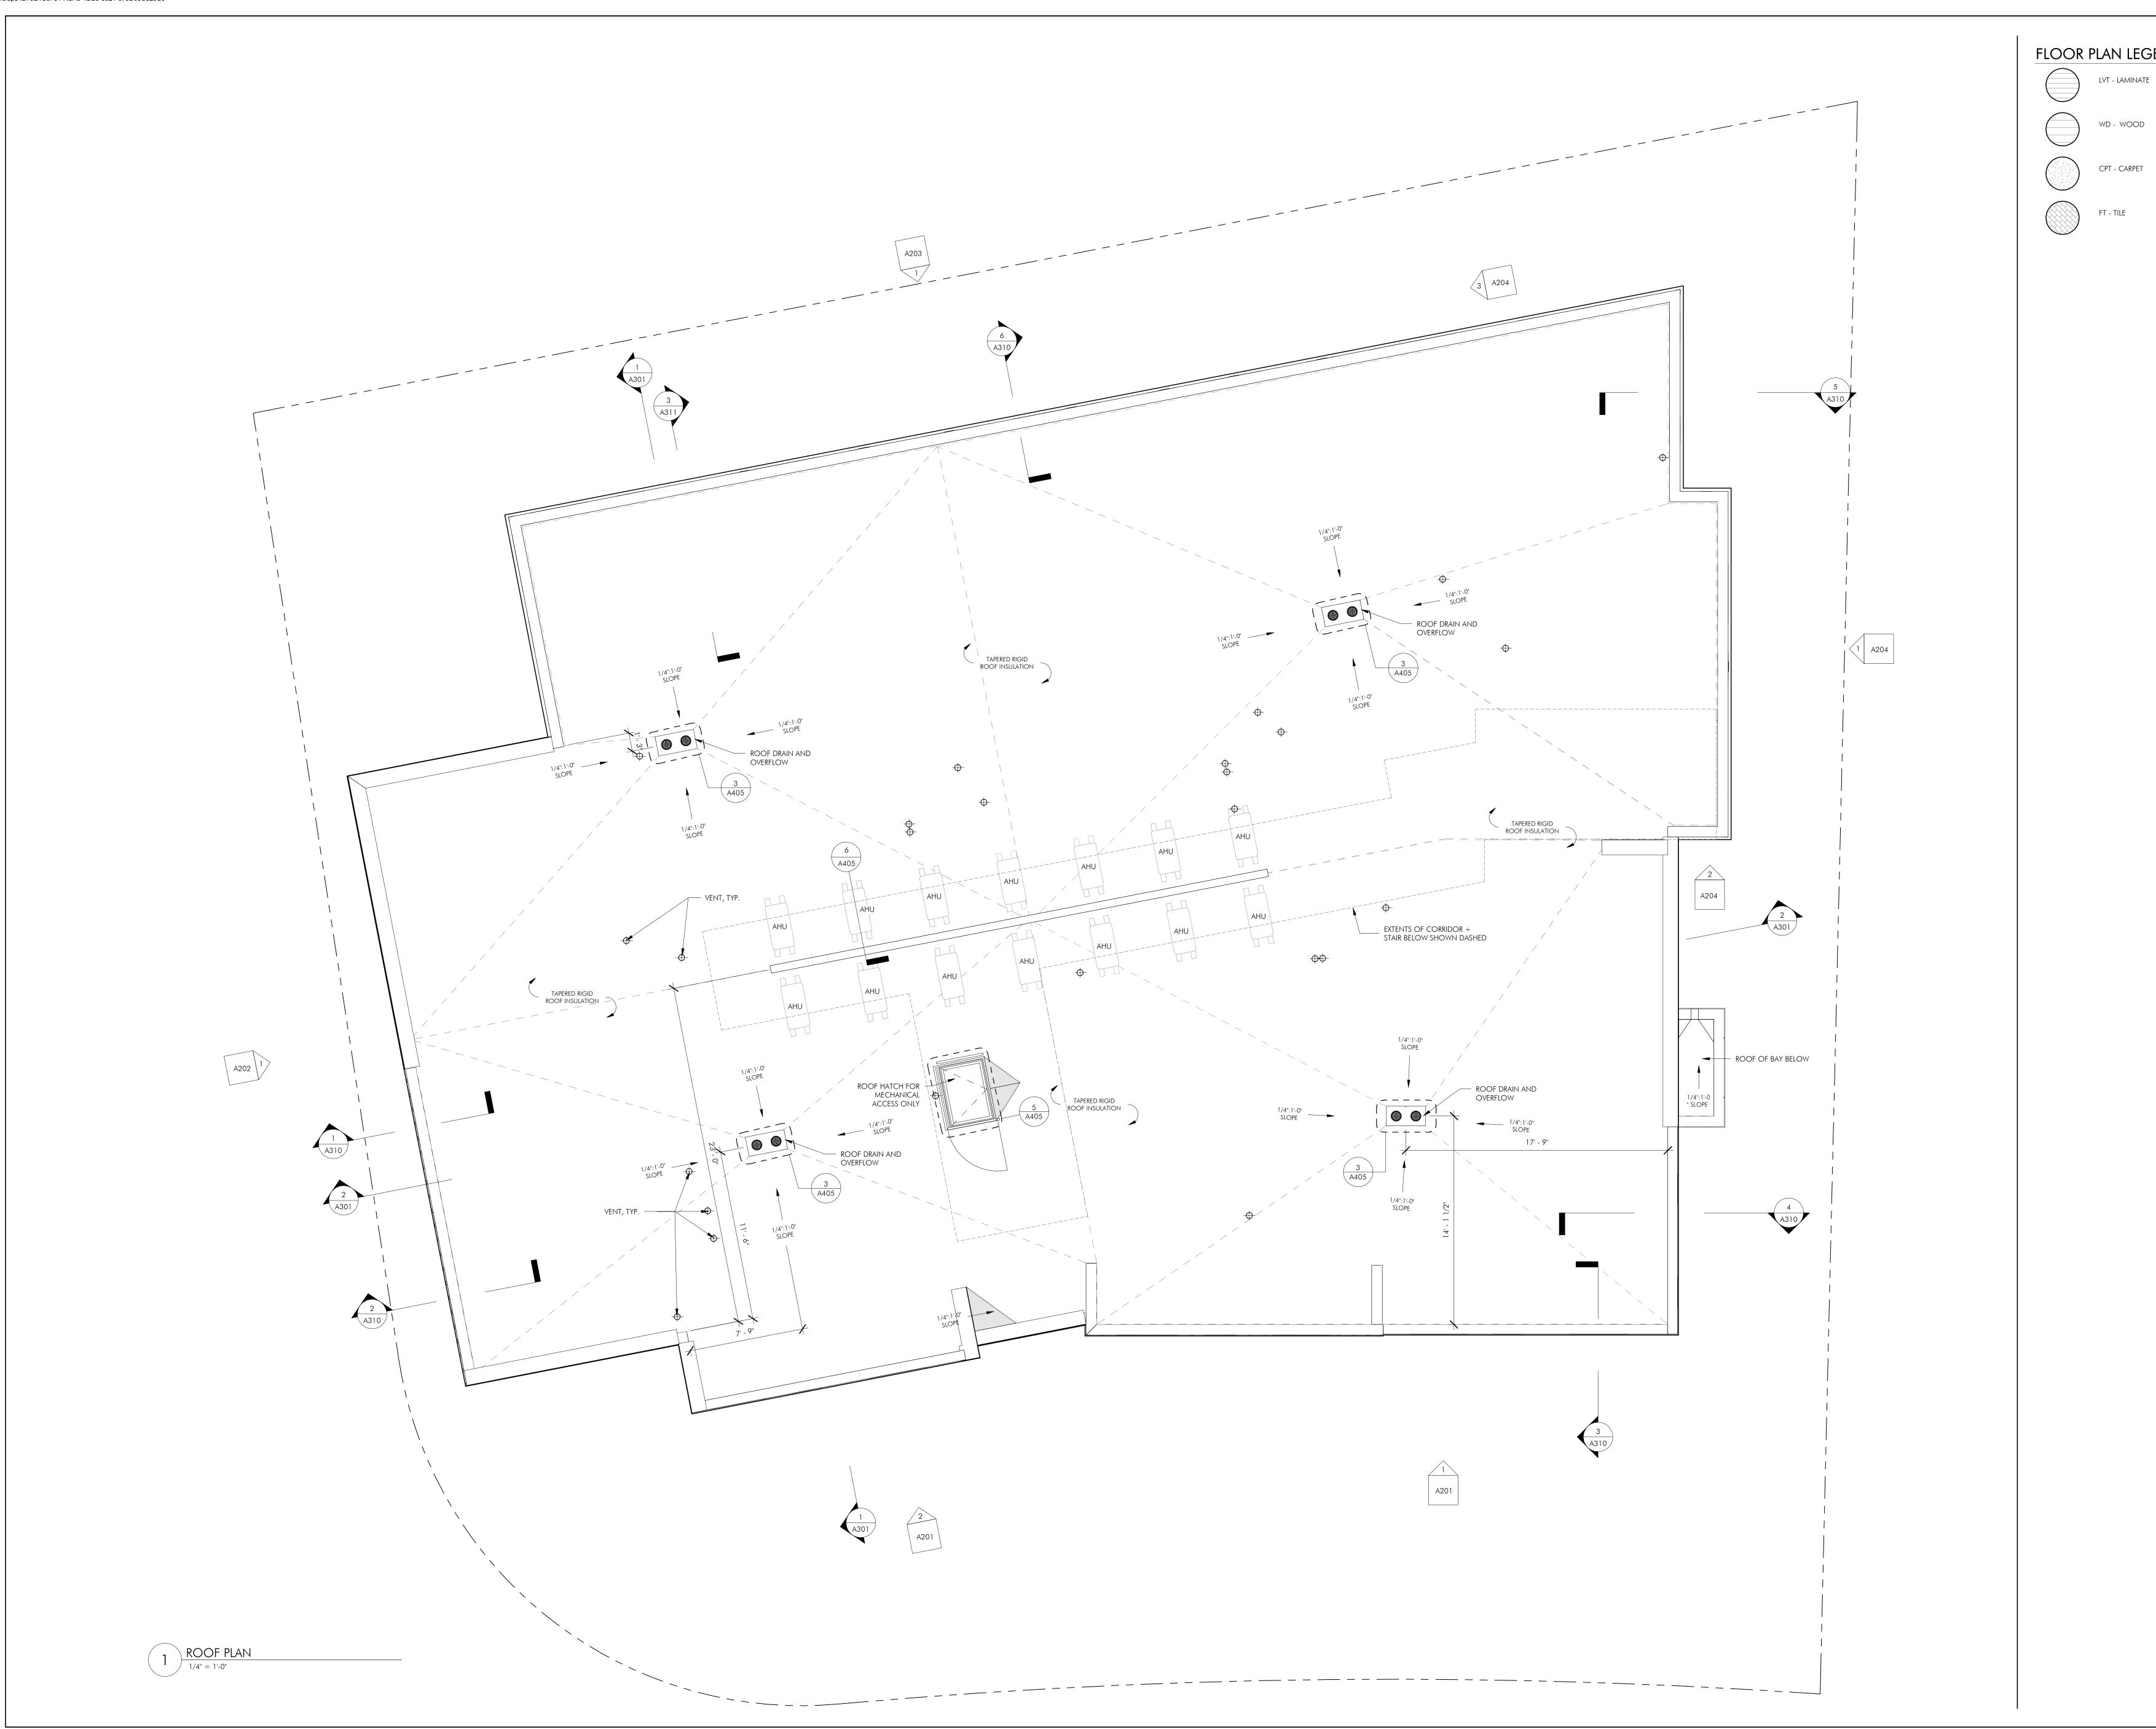

FLOOR PLAN LEGEND







CONSULTANTS

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REVISIONS



DRAWING INFORMATION ISSUE: <u>ISSUED FOR CONSTRUCTION</u> DATE: MARCH 25, 2024

PROJECT #: <u>21004</u> SCALE: 1/4" = 1'-0"

DRAWING TITLE PROPOSED ROOF PLAN

| ARCHITECT **EXTERIOR MATERIALS LEGEND:** 580 HARRISON AVE, SUITE 2W FCP-1: FIBER CEMENT PANEL BOSTON, MA 02118 - MANUFACTURER: TBD O: 617.765.8000 - COLOR: TBD www.embarcdesign.com OWNER Diarmaid McGregor FCP-2: FIBER CEMENT PANEL - JAMES HARDIE - COLOR: ARTIC WHITE CONSULTANTS BB-1: FIBER CEMENT BOARD & BATTEN - JAMES HARDIE - COLOR: ARTIC WHITE FCL - FIBER CEMENT LAP SIDING - JAMES HARDIE - COLOR: OLIVE BRK-1: BRICK VENEER - ENDICOTT - COLOR: EXECUTIVE IRONSPOT VELOUR CDP: CEDAR PLANK - TONGUE & GROOVE - VERTICAL ORIENTATION CMS-1: CORRUGATED METAL SIDING - MORIN; MX-1 - COLOR: DOVE GROVE CMS-2: CORRUGATED METAL SIDING - MORIN; MX-1 -COLOR: ZINC GROVE

> CMU-1: CMU VENEER - JANDRIS AND SONS

- COLOR: 9215 - FINISH: SPLIT FACE

BOSTON, MA 02136
SSUED FOR CONSTRUCTION

NO. 20350

REVISIONS

DRAWING INFORMATION

ISSUE: ISSUED FOR CONSTRU

ISSUE: ISSUED FOR CONSTRUCTION

DATE: MARCH 25, 2024

PROJECT #: 21004

SCALE: As indicated

DRAWING TITLE
BUILDING
ELEVATIONS



**EXTERIOR MATERIALS LEGEND:** 

FCP-1: FIBER CEMENT PANEL - MANUFACTURER: TBD - COLOR: TBD

- COLOR: ARTIC WHITE



FCP-2: FIBER CEMENT PANEL




BB-1: FIBER CEMENT BOARD & BATTEN - COLOR: ARTIC WHITE










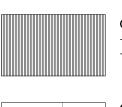

CMS-2: CORRUGATED METAL SIDING - MORIN; MX-1 -COLOR: ZINC GROVE

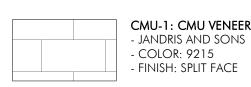

CMU-1: CMU VENEER
- JANDRIS AND SONS - COLOR: 9215


| ARCHITECT 580 HARRISON AVE, SUITE 2W BOSTON, MA 02118 O: 617.765.8000 www.embarcdesign.com

OWNER

Diarmaid McGregor

CONSULTANTS

REVISIONS

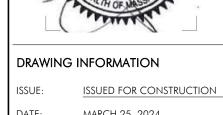

DATE: MARCH 25, 2024 PROJECT #: 21004

> DRAWING TITLE ELEVATIONS

**EXTERIOR MATERIALS LEGEND:** 




FCP-1: FIBER CEMENT PANEL - MANUFACTURER: TBD - COLOR: TBD



FCP-2: FIBER CEMENT PANEL

- JAMES HARDIE

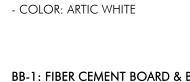













CMS-2: CORRUGATED METAL SIDING - MORIN; MX-1 -COLOR: ZINC GROVE

CMU-1: CMU VENEER - JANDRIS AND SONS - COLOR: 9215

CONSULTANTS

| ARCHITECT


OWNER

580 HARRISON AVE, SUITE 2W

BOSTON, MA 02118 O: 617.765.8000

www.embarcdesign.com

Diarmaid McGregor

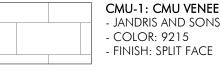

ONSTRUC 34 OAK STREET BOSTON, MA 02136

REVISIONS



DRAWING INFORMATION

PROJECT #: 21004

DRAWING TITLE BUILDING ELEVATIONS

FCP-1: FIBER CEMENT PANEL - MANUFACTURER: TBD - COLOR: TBD

FCP-2: FIBER CEMENT PANEL











CMS-2: CORRUGATED METAL SIDING - MORIN; MX-1 -COLOR: ZINC GROVE

| ARCHITECT BOSTON, MA 02118 O: 617.765.8000

www.embarcdesign.com OWNER

Diarmaid McGregor

CONSULTANTS

CMU-1: CMU VENEER - JANDRIS AND SONS - COLOR: 9215 - FINISH: SPLIT FACE

REVISIONS



DRAWING INFORMATION

PROJECT #: <u>21004</u>

DRAWING TITLE