



BAIRD RESIDENCE

16 WOODLAND ROAD
JAMAICA PLAIN, BOSTON, MA 02130

PERMIT REVISION

DATE ISSUED: AUGUST 18TH, 2023

DRAWING LIST SURVEY		DRAWING LIST - ARCHITECTURAL PERMIT SET		DRAWING LIST - ARCHITECTURAL PERMIT SET	
SHEET NO.	SHEET NAME	SHEET NO.	SHEET NAME	SHEET NO.	SHEET NAME
SURVEY		ARCHITECTURAL		ARCHITECTURAL	
-	SURVEY	A0.00	COVER	A4.00	EXTERIOR ELEVATIONS
DRAWING LIST CIVIL		A0.02	RESIDENTIAL CODE NOTES	A4.01	EXTERIOR ELEVATIONS
DRAWING LIST CIVIL		A0.10	GENERAL NOTES	A4.10	ENLARGED ELEVATIONS
SHEET NO.	SHEET NAME	A0.20	LOWER LEVEL & FIRST FLOOR DEMO PLAN	A4.11	ENLARGED ELEVATIONS
CIVIL		A1.00	SITE PLAN	A4.20	EXTERIOR WINDOW & DOOR SCHEDULE
2.11	SITE IMPROVEMENT PLAN	A2.00	LOWER LEVEL & FIRST FLOOR DEMO PLAN	A5.00	BUILDING SECTIONS
2.31	SOIL EROSION & SEDIMENT CONTROL PLAN	A2.01	SECOND & THIRD FLOOR DEMO PLAN	A5.01	BUILDING SECTIONS
3.01	CONSTRUCTION DETAILS	A2.10	LOWER LEVEL FLOOR PLAN	A6.00	INTERIOR ELEVATIONS
3.02	CONSTRUCTION DETAILS	A2.11	FIRST FLOOR PLAN	A6.01	INTERIOR ELEVATIONS
DRAWING LIST STRUCTURAL		A2.12	SECOND FLOOR PLAN	A6.02	INTERIOR ELEVATIONS
DRAWING LIST STRUCTURAL		A2.13	THIRD FLOOR PLAN	A6.03	INTERIOR ELEVATIONS
SHEET NO.	SHEET NAME	A2.14	ROOF PLAN	A6.05	INTERIOR ELEVATIONS
S0.00	GENERAL NOTES	A2.20	LOWER LEVEL FLOOR FINISH PLAN	A6.06	INTERIOR ELEVATIONS
S0.01	TYPICAL DETAILS	A2.21	FIRST FLOOR FINISH PLAN	A6.10	ENLARGED INTERIOR PLANS & ELEVATIONS
S0.02	TYPICAL DETAILS	A2.22	SECOND FLOOR FINISH PLAN	A6.11	ENLARGED INTERIOR PLANS & ELEVATIONS
S0.03	TYPICAL DETAILS	A2.23	THIRD FLOOR FINISH PLAN	A6.12	ENLARGED INTERIOR PLANS & ELEVATIONS
S1.10	FOUNDATION PLAN	A3.10	LOWER LEVEL REFLECTED CEILING PLAN	A6.13	ENLARGED INTERIOR PLANS & ELEVATIONS
S1.11	FIRST FLOOR FRAMING PLAN	A3.11	FIRST FLOOR REFLECTED CEILING PLAN	A6.14	ENLARGED INTERIOR PLANS & ELEVATIONS
S1.12	SECOND FLOOR FRAMING PLAN	A3.12	SECOND FLOOR REFLECTED CEILING PLAN	A6.15	ENLARGED INTERIOR PLANS & ELEVATIONS
S1.13	THIRD FLOOR FRAMING PLAN	A3.13	THIRD FLOOR REFLECTED CEILING PLAN	A6.16	ENLARGED INTERIOR PLANS & ELEVATIONS
S1.14	ROOF FRAMING PLAN	A3.15	SITE LIGHTING PLAN	A6.17	ENLARGED INTERIOR PLANS & ELEVATIONS
S2.00	SECTIONS	A3.20	LOWER LEVEL SWITCHING PLAN	A6.30	INTERIOR STAIR DETAILS
		A3.21	FIRST FLOOR SWITCHING PLAN	A6.31	INTERIOR STAIR DETAILS
		A3.22	SECOND FLOOR SWITCHING PLAN	A6.32	INTERIOR STAIR DETAILS
		A3.23	THIRD FLOOR SWITCHING PLAN	A6.33	ENTRY STAIR DETAILS
		A3.25	SITE SWITCHING PLAN	A7.00	INTERIOR PARTITION TYPES
				A7.01	INTERIOR FLOOR DETAILS

CLIENT

LISSA BAIRD
16 WOODLAND ROAD
JAMAICA PLAIN, MA 02130
917-617-0498

ARCHITECT

CHARLES ROSE ARCHITECTS, INC.
115 WILLOW AVENUE
SOMERVILLE, MA 02144
TEL: 617-428-5033
© CHARLES ROSE ARCHITECTS, INC.

CONTRACTOR

EMANUEL COELHO
699 BROADWAY
SOMERVILLE, MA 02144
TEL: 617-893-1717

SURVEYOR

KEN ANDERSON
400 HIGH STREET
HANSON, MA
P.O. BOX 149 HANSON, MA 02341
TEL: 781-293-3349

CIVIL ENGINEER

SOLLI ENGINEERING
11 WANDERBILT AVENUE
NORWOOD, MA 02062
TEL: 781-352-8491

STRUCTURAL ENGINEER

RSE ASSOCIATES
63 PLEASANT STREET
WATERTOWN, MA 02472
TEL: 617-928-9300



PLAN NOTES:


- ELEVATIONS AND BEARINGS ARE BASED UPON AN OPUS CONVERSIONS OF STATIC GPS OBSERVATIONS TAKEN ON FEBRUARY 11, 2022. REF FRAME: NAD_83(2011)(EPOCH:2010.0000).
- COORDINATES AND BEARING SHOWN ARE MASSACHUSETTS STATE PLANE (MAINLAND) AND ARE SHOWN FOR SURVEY REPRODUCTION PURPOSES ONLY.
- ABUTTERS ARE SHOWN PER ASSESSOR'S RECORDS.
- UNDERGROUND UTILITY LOCATIONS SHOWN ARE BASED UPON MARKINGS SET BY OTHERS. (DIG SAFE)
- TREE DIAMETERS ARE BASED UPON TRUNK DIAMETERS THREE FEET ABOVE GROUND LEVEL AND ARE PLOTTED TO SCALE.
- BY HORIZONTAL SCALING ONLY LOCUS LIES WITHIN FLOOD ZONE X, AREA OF MINIMAL FLOOD HAZARD, AS SHOWN ON FEMA FIRM 25025C0067G, EFFECTIVE DATE: 9/25/2009.

N/F LINDA F. TURNBILL
BK.49212, PG.281
PARCEL ID 19202385005

N/F HUB DEVELOPMENT LLC
BK.57363, PG.121
PARCEL ID 19202385006

N/F MATTHEW R. SLY
ANNA GUSKIN
BK.45020, PG.191
PARCEL ID 1902386000


N/F KAMRON N. KHAN
REHAN KHAN
BK.66141, PG.222
PARCEL ID 19202389000

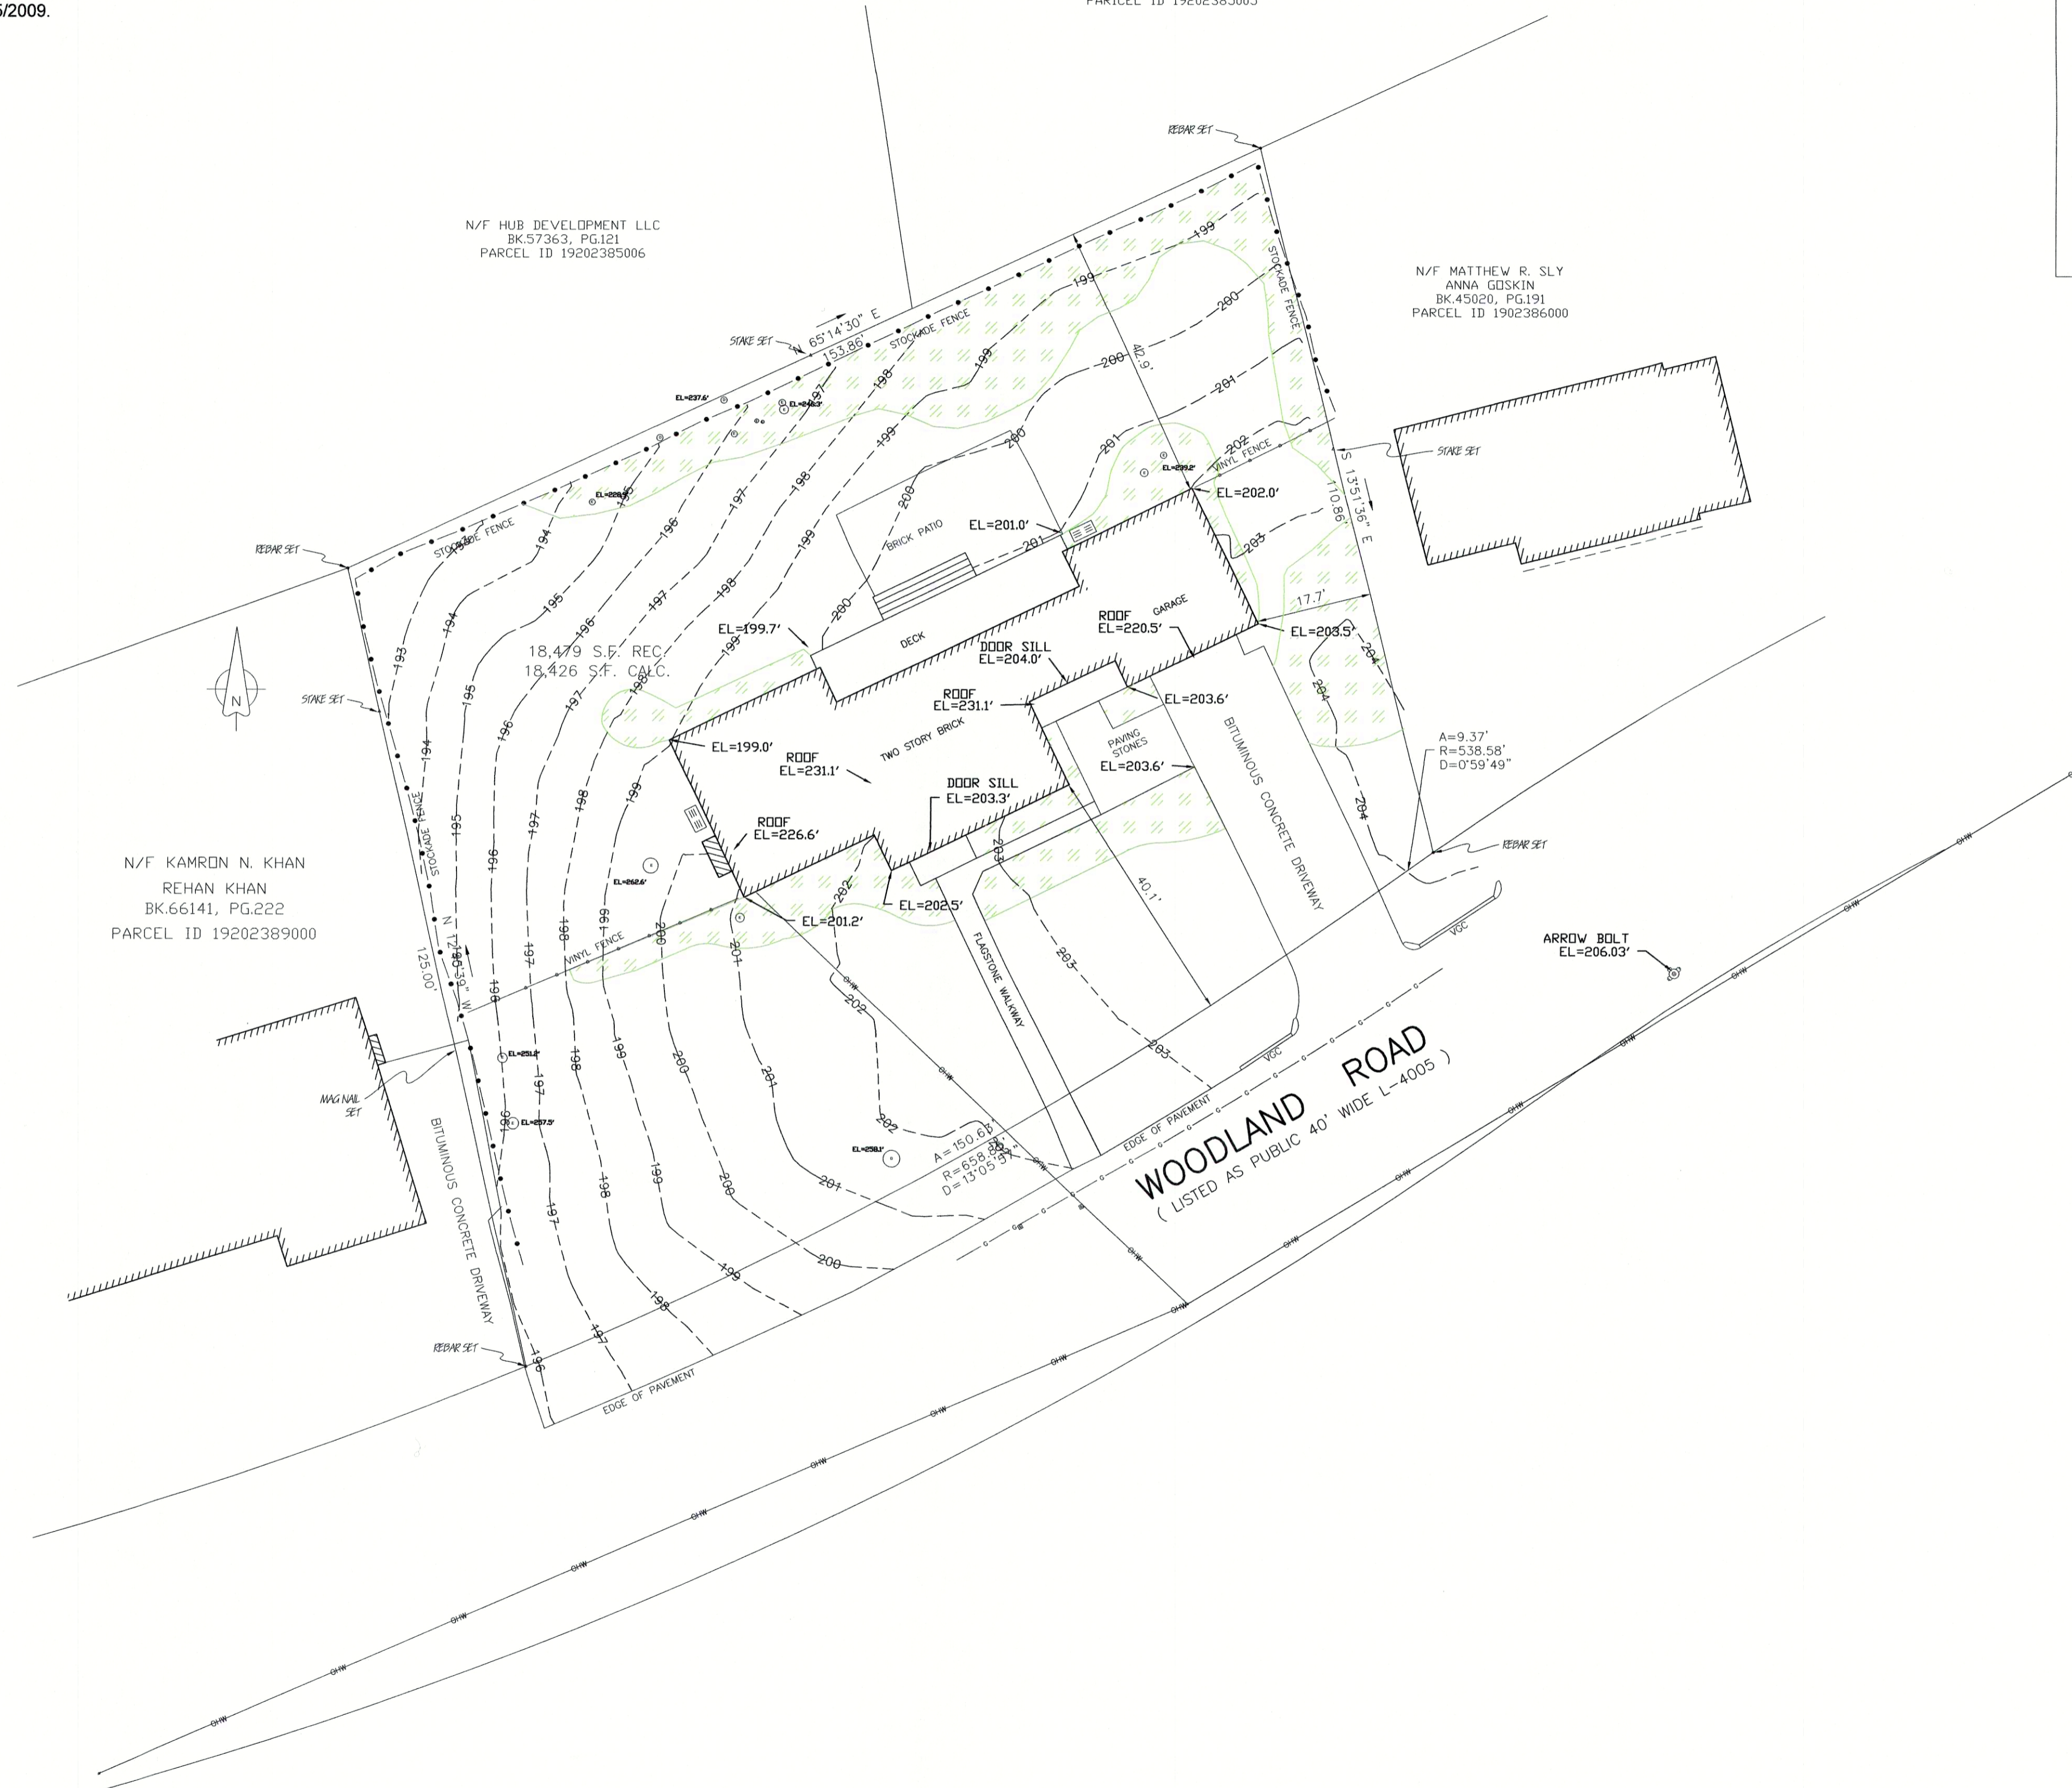

LEGEND

These standard symbols will be found in the drawing.

- ☐ HVAC UNIT
- ⊕ HYDRANT
- ⊙ MAN HOLE SEWER
- ⊙ UTILITY POLE
- ⊙ GAS GATE
- GAS LINE
- TREE EVERGREEN
- TREE DECIDUOUS
- ▨ LANDSCAPED AREA

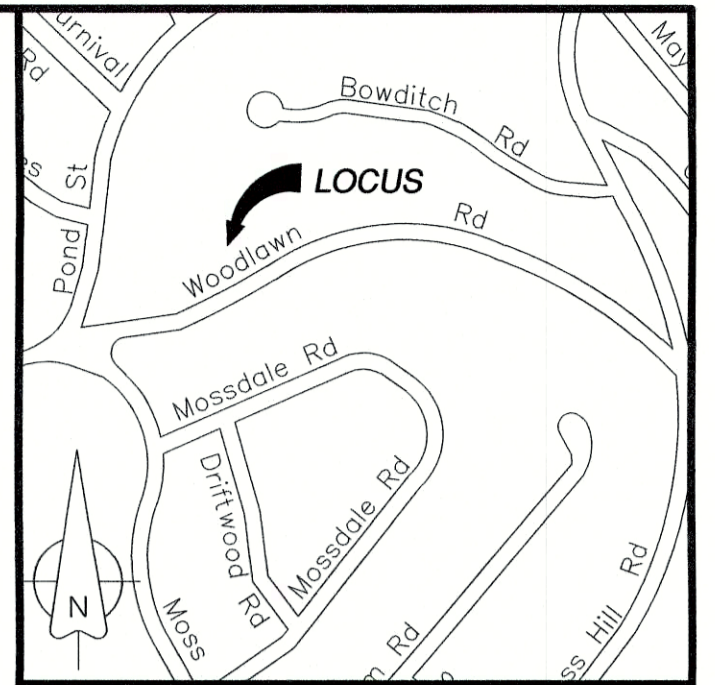

LOCUS PLAN

**EXISTING CONDITIONS PLAN
LAND IN
BOSTON,
JAMAICA PLAIN,
SUFFOLK COUNTY,
MASSACHUSETTS**


16 WOODLAND ROAD
PARCEL ID 1902387000

LISTED OWNER:
LISSA BAIRD
DEED BOOK 66318, PAGE 241
PLAN IN BOOK 6167, PAGE 583

DATE: March 9, 2022

©2022 ALL RIGHTS RESERVED
ANDERSON SURVEYS, INC.
Professional Land Surveyors
800 HIGH STREET
HANSON, MA 02341-0149
(781) 293-3349

SCALE: 1" = 16'

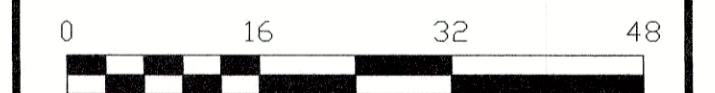

Kenneth B. Anderson, PLS # 31298

SITE PLAN NOTES

- THESE PLANS ARE FOR PERMITTING PURPOSES ONLY AND ARE NOT FOR CONSTRUCTION. NO CONSTRUCTION OR DEMOLITION SHALL BEGIN UNTIL APPROVAL OF THE FINAL PLANS IS GRANTED BY ALL GOVERNING AND REGULATORY AGENCIES.
- CONTRACTOR TO PERFORM ALL SITE WORK PROPOSED HEREON IN ACCORDANCE WITH ALL LOCAL, STATE AND FEDERAL PERMITS AND CONDITIONS OF APPROVALS ISSUED FOR THIS PROJECT.
- EXISTING BOUNDARY AND TOPOGRAPHY IS BASED ON DRAWING TITLED "EXISTING CONDITIONS PLAN LAND IN BOSTON, JAMAICA PLAIN, SUITFOLD COUNTY, MASSACHUSETTS, 16 WOODLAND ROAD, SCALE 1"=10'; DATED: 03/09/2022, BY ANDERSON SURVEYS, INC.
- THE SUBJECT SITE CONSISTS OF A TOTAL AREA OF APPROXIMATELY 0.42 ACRES, LOCATED WITHIN THE JAMAICA PLAIN NEIGHBORHOOD DISTRICT AND FURTHER WITHIN THE ONE-FAMILY RESIDENTIAL SUBDISTRICT (1) OF THE CITY OF BOSTON.
- THIS SITE LIES WITHIN AN AREA OF MINIMAL FLOOD HAZARD (ZONE X). FLOOD ZONE INFORMATION TAKEN FROM FEMA FLOOD INSURANCE RATE MAP NO. 25025C0067, DATE 09/25/2009.
- PRIOR TO DEMOLITION OR CONSTRUCTION, THE CONTRACTOR SHALL CONTACT "365 SAFE" 72 HOURS BEFORE COMMENCEMENT OF WORK AT "31" AND VERIFY ALL UTILITY AND STORM DRAINAGE SYSTEM LOCATIONS. INFORMATION ON EXISTING UTILITIES AND STORM DRAINAGE SYSTEMS HAS BEEN COMPILED FROM AVAILABLE INFORMATION INCLUDING UTILITY PROVIDER AND MUNICIPAL RECORD MAPS AND/OR FIELD SURVEY AND IS NOT GUARANTEED CORRECT OR COMPLETE. UTILITIES AND STORM DRAINAGE SYSTEMS ARE SHOWN TO ALERT THE CONTRACTOR TO THEIR PRESENCE AND THE CONTRACTOR IS SOLELY RESPONSIBLE FOR DETERMINING ACTUAL LOCATIONS AND ELEVATIONS OF ALL UTILITIES AND STORM DRAINAGE SYSTEMS INCLUDING SERVICES.
- CONTRACTOR SHALL BE RESPONSIBLE FOR SITE SAFETY AND SECURITY OF THE SITE DURING ALL PHASES OF CONSTRUCTION. THE ARCHITECT AND ENGINEER OF RECORD ARE NOT RESPONSIBLE FOR SITE SAFETY MEASURES TO BE EMPLOYED DURING CONSTRUCTION. THE ARCHITECT AND ENGINEER OF RECORD HAVE NO CONTRACTUAL DUTY TO CONTROL, THE SAFEST METHODS OR MEANS OF THE WORK, JOB SITE RESPONSIBILITIES, SUPERVISION OR TO SUPERVISE SAFETY AND DOES NOT VOLUNTARILY ASSUME ANY SUCH DUTY OR RESPONSIBILITY.
- THE OWNER IS RESPONSIBLE FOR OBTAINING ALL NECESSARY ZONING PERMITS REQUIRED BY GOVERNMENT AGENCIES PRIOR TO CONSTRUCTION. THE CONTRACTOR SHALL OBTAIN ALL LOCAL AND STATE PERMITS. THE CONTRACTOR SHALL POST ALL BONDS, PAY ALL FEES, PROVIDE PROOF OF INSURANCE AND CONDUCE TRAFFIC CONTROL NECESSARY FOR THIS WORK.
- THE CONTRACTOR SHALL REFERENCE ARCHITECTURAL PLANS FOR EXACT DIMENSIONS AND CONSTRUCTION DETAILS OF BUILDING AND BUILDING EXPANSIONS.
- SHOULD ANY UNCHARTERED OR INCORRECTLY CHARTERED, EXISTING PIPING OR OTHER UTILITY BE UNCOVERED DURING EXCAVATION, CONSULT THE ENGINEER OF RECORD IMMEDIATELY FOR DIRECTIONS BEFORE PROCEEDING FURTHER WITH WORK IN THIS AREA.
- ALL SITE DIMENSIONS ARE REFERENCED TO THE FACE OF CURBS OR EDGE OF PAVING AS APPLICABLE UNLESS OTHERWISE NOTED. ALL BUILDING DIMENSIONS ARE REFERENCED TO THE OUTSIDE FACE OF THE STRUCTURE.
- THE CONTRACTOR SHALL RESTORE ANY DRAINAGE STRUCTURE, PIPE, UTILITY, PAVEMENT, CURBS, SIDEWALKS, LANDSCAPED AREAS OR SIGNAGE DISTURBED DURING CONSTRUCTION TO THEIR ORIGINAL CONDITION OR BETTER, AS APPROVED BY THE CIVIL ENGINEER.

DRAINAGE & UTILITY NOTES

- THE CONTRACTOR IS RESPONSIBLE FOR OBTAINING ALL NECESSARY CONSTRUCTION PERMITS REQUIRED BY GOVERNMENT AND LOCAL AGENCIES PRIOR TO CONSTRUCTION. THE CONTRACTOR SHALL OBTAIN ALL NECESSARY CONSTRUCTION PERMITS FROM LOCAL GOVERNING AUTHORITIES AND STATE REQUIRED TO PERFORM ALL REQUIRED WORK, INCLUDING FOR STREET CUTS AND CONNECTIONS TO EXISTING UTILITIES. THE CONTRACTOR SHALL POST ALL BONDS EXCEPT MASSACHUSETTS DOT ENCROACHMENT PERMIT BOND, PAY ALL FEES, PROVIDE PROOF OF INSURANCE AND PROVIDE TRAFFIC CONTROL NECESSARY FOR THIS WORK.
- PRIOR TO DEMOLITION OR CONSTRUCTION, THE CONTRACTOR SHALL CONTACT "365 SAFE" 72 HOURS BEFORE COMMENCEMENT OF WORK AT "31" AND VERIFY ALL UTILITY AND STORM DRAINAGE SYSTEM LOCATIONS. INFORMATION ON EXISTING UTILITIES AND STORM DRAINAGE SYSTEMS HAS BEEN COMPILED FROM AVAILABLE INFORMATION INCLUDING UTILITY PROVIDER AND MUNICIPAL RECORD MAPS AND/OR FIELD SURVEY AND IS NOT GUARANTEED CORRECT OR COMPLETE. UTILITIES AND STORM DRAINAGE SYSTEMS ARE SHOWN TO ALERT THE CONTRACTOR TO THEIR PRESENCE AND THE CONTRACTOR IS SOLELY RESPONSIBLE FOR DETERMINING ACTUAL LOCATIONS AND ELEVATIONS OF ALL UTILITIES AND STORM DRAINAGE SYSTEMS INCLUDING SERVICES.
- UTILITIES AND STORM DRAINAGE SYSTEMS ARE SHOWN TO ALERT THE CONTRACTOR TO THEIR PRESENCE AND THE CONTRACTOR IS SOLELY RESPONSIBLE FOR DETERMINING ACTUAL LOCATIONS AND ELEVATIONS OF ALL UTILITIES AND STORM DRAINAGE SYSTEMS INCLUDING SERVICES. PRIOR TO DEMOLITION OR CONSTRUCTION, THE CONTRACTOR SHALL CONTACT "365 SAFE" 72 HOURS BEFORE COMMENCEMENT OF WORK AT "31" AND VERIFY ALL UTILITY AND STORM DRAINAGE SYSTEM LOCATIONS.
- SHOULD ANY UNCHARTERED OR INCORRECTLY CHARTERED, EXISTING PIPING OR OTHER UTILITY BE UNCOVERED DURING EXCAVATION, CONSULT THE ENGINEER OF RECORD IMMEDIATELY FOR DIRECTIONS BEFORE PROCEEDING FURTHER WITH WORK IN THIS AREA.
- THE CONTRACTOR SHALL PROVIDE AND MAINTAIN TRAFFIC DEVICES FOR PROTECTION OF VEHICLES AND PEDESTRIANS CONSISTING OF DRUMS, BARRIERS, SIGNS, LIGHTS, FENCES AND UNIFORMED TRAFFIC CONTROLLERS AS REQUIRED, ORDERED BY THE ENGINEER OR REQUIRED BY THE STATE AND LOCAL GOVERNING AUTHORITIES.
- ALL DISTURBANCE INCURRED TO CITY, COUNTY, OR STATE PROPERTY DUE TO CONSTRUCTION SHALL BE RESTORED TO ITS PREVIOUS CONDITION OR BETTER.
- IF IMPACTED OR CONTAMINATED SOIL IS ENCOUNTERED BY THE CONTRACTOR, THE CONTRACTOR SHALL STOP EXCAVATION WORK OF IMPACTED SOIL AND NOTIFY THE OWNER AND/OR OWNER'S ENVIRONMENTAL CONSULTANT PRIOR TO PROCEEDING WITH FURTHER WORK IN THE IMPACTED SOIL LOCATION UNTIL FURTHER INSTRUCTED BY THE OWNER AND/OR OWNER'S ENVIRONMENTAL CONSULTANT.
- PROPER CONSTRUCTION PROCEDURES SHALL BE FOLLOWED ON ALL IMPROVEMENTS WITHIN THIS PARCEL, SO AS TO PREVENT THE SILLING OF ANY WATERCOURSE OR WETLANDS IN ACCORDANCE WITH THE REGULATIONS OF THE MASSACHUSETTS DEPARTMENT OF ENVIRONMENTAL PROTECTION GUIDELINES FOR SOIL EROSION AND SEDIMENT CONTROL.
- GRADING CONTRACTOR SHALL RESTORE TO GRADE AND COMPACTION ALL AREAS DISTURBED BY BUILDING CONSTRUCTION PRIOR TO PAVING OPERATIONS COMMENCING.
- THE PROPERTY IS NOT LOCATED WITHIN A ZONE II WELLHEAD PROTECTION AREA.
- THE PROJECT SITE IS LOCATED WITHIN FEMA AREAS OF MINIMAL FLOOD HAZARD (ZONE X). OUTSIDE THE 500-YEAR FLOOD ZONES.
- ALL CATCH BASINS PROPOSED ARE TO BE 4' x 6' MIN. DEEP SLUMP CATCH BASINS WITH HOODED OUTLETS, SEE DETAILS ON SHEET 3.01.
- ALL WORK IN THE CITY OF BOSTON MUST BE PERFORMED BY A LICENSED DRAIN LAYER APPROVED BY THE BOSTON WATER AND SEWER COMMISSION AND MUST MAINTAIN A BOND WITH BWS.
- THE CONTRACTOR BEARS THE RESPONSIBILITY FOR CONFIRMING THE EXACT LOCATION OF UTILITIES SHOWN ON THIS PLAN AND OTHERS THAT MAY EXIST BUT ARE NOT SHOWN HERE.
- ALL WATER LATERALS AND PIPES SHALL BE INSTALLED PER THE BOSTON WATER & SEWER COMMISSION STANDARD REQUIREMENTS.
- ALL SEWER PIPES AND STRUCTURES SHALL BE INSTALLED PER THE BOSTON WATER & SEWER COMMISSION STANDARD REQUIREMENTS.


ABBREVIATIONS

ARCH.	ARCHITECTURAL
BWS.	BOSTON WATER & SEWER COMMISSION
CF.	CUBIC FEET
DPW.	DEPARTMENT OF PUBLIC WORKS
ELEV.	EAST
EX.	ELEVATION
F.F.E.	FINISHED FLOOR ELEVATION
H.DPE.	HIGH DENSITY POLYETHYLENE
INV.	INVERT
LF.	LINEAR FEET
MIN.	MINIMUM
N.	NORTH
PR.	PROPOSED
S.	SLOPE
S.F.	SOUTH
SF.	SQUARE FEET
TFP.	TOP OF FRAME
TYP.	TYPICAL
W.	WEST

ZONING COMPLIANCE TABLE

ZONING DISTRICT: ONE-FAMILY RESIDENTIAL SUBDISTRICT (1)	REQUIRED	EXISTING	PROPOSED
MINIMUM LOT AREA	9,000 SF	18,426 SF	18,426 SF
MINIMUM LOT WIDTH	70 FT	154 FT	154 FT
MINIMUM USABLE OPEN SPACE	2,000 SF	14,976 SF	13,429 SF
MINIMUM FRONT YARD	25 FT	40 FT	38 FT
MINIMUM SIDE YARD	12 FT	17 FT	13 FT
MINIMUM REAR YARD	40 FT	43 FT	43 FT
MAXIMUM BUILDING HEIGHT	35 FT / 2.5 STORIES	25 STORIES	2.5 STORIES
MAXIMUM FLOOR-TO-AREA RATIO (FAR)	0.3	< 0.3	< 0.3
MAXIMUM REAR YARD OCCUPANCY BY ACCESSORY BLDG.	25%	0%	< 25%

Rev. #:	Date	Description
1	08/28/23	Response to Comments

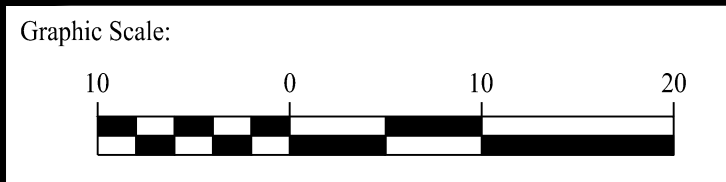

BWSC INSPECTION LIST

STRUCTURE	INSPECTOR	DATE
SYSTEM #1: SUBSURFACE CHAMBERS		
SYSTEM #2: SUBSURFACE CHAMBERS		
SYSTEM #3: DRY WELL		
TRENCH DRAIN		

LEGEND

	PROPERTY LINE
	ADJOINING LOT LINE
	BUILDING SETBACK
	EXISTING BUILDING LIMITS
	PROPOSED BUILDING LIMITS
	PROPOSED BUILDING HATCH
	SAWCUT PAVEMENT LINE
	CONCRETE SIDEWALK / PAVEMENT
	MAJOR CONTOURS
	MINOR CONTOURS
	EXISTING MAJOR CONTOURS
	EXISTING MINOR CONTOURS
	CONTOUR LABEL
	STORM DRAIN PIPE
	DRAINAGE AREA
	WATER MAIN / LATERAL
	FIRST FLOOR DOOR LOCATIONS (SEE ARCH. PLANS)
	LOWER LEVEL DOOR LOCATIONS (SEE ARCH. PLANS)
	SLIDER / OVERHEAD DOOR LOCATIONS (SEE ARCH. PLANS)

BWSC STORMWATER REQUIREMENTS & CALCULATIONS


FOR ALL RECONSTRUCTION PROJECTS WITHIN THE CITY OF BOSTON, IT IS MANDATORY TO RETAIN STORMWATER ON-SITE. A VOLUME OF RUNOFF EQUAL TO ONE INCH OF RAINFALL TIMES THE TOTAL IMPERVIOUS AREA ON-SITE MUST BE INFILTRATED PRIOR TO DISCHARGE TO A STORM DRAIN OR A COMBINED SEWER SYSTEM FOR PROJECTS LESS THAN 100,000 SQUARE FEET OF FLOOR AREA.

ON-SITE IMPERVIOUS AREA
 TOTAL IMPERVIOUS AREA ON-SITE = 43,174 SQUARE FEET = 421,648 CUBIC INCHES
 421,648 SQUARE INCHES X 1 INCH OF RAINFALL = 421,648 CUBIC INCHES
 421,648 CUBIC INCHES = 368 CUBIC FEET


SYSTEM #1: SUBSURFACE CHAMBERS
 CULTIC RECHARGER 150X150 (3) CHAMBERS
 CONTRIBUTING DRAINAGE AREA = 701 SF
 BOTTOM OF STONE = 199.00'
 BOTTOM OF CHAMBER = 196.00'
 TOP OF CHAMBER = 198.25'

SYSTEM #2: SUBSURFACE CHAMBERS
 CULTIC RECHARGER 150X150 (1) CHAMBER
 CONTRIBUTING DRAINAGE AREA = 701 SF
 BOTTOM OF STONE = 188.00'
 BOTTOM OF CHAMBER = 190.00'
 TOP OF CHAMBER = 201.20'


SYSTEM #3: DRY WELL
 ONE (1) 300 GALLON DRY WELL
 CONTRIBUTING DRAINAGE AREA = 363 SF
 BOTTOM OF STONE = 188.00'
 BOTTOM OF CHAMBER = 190.00'
 TOP OF CHAMBER = 200.50'

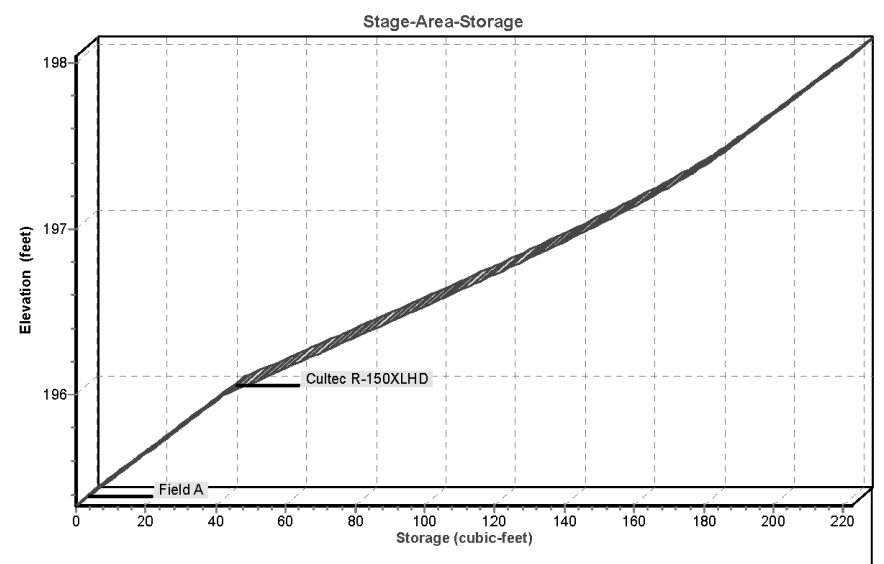

TOTAL VOLUME: 222 CF

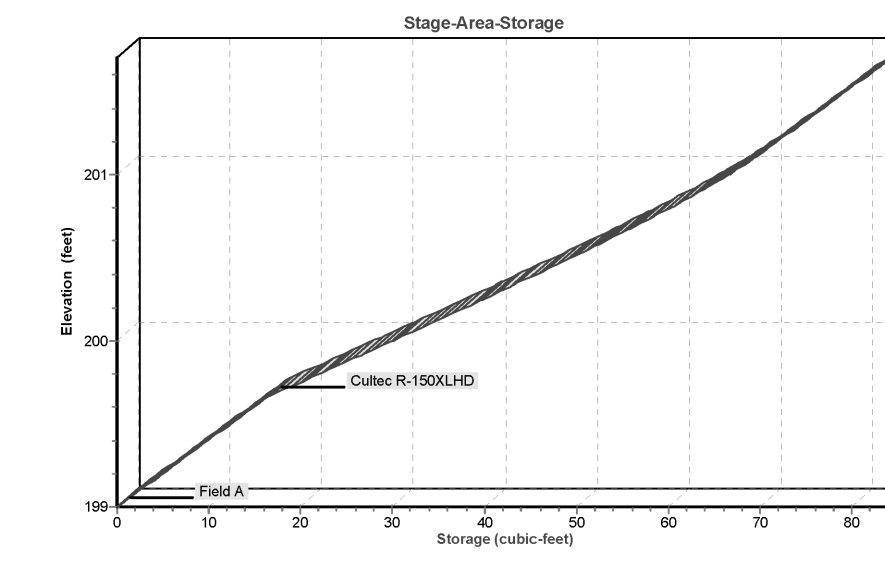


TOTAL VOLUME: 84 CF

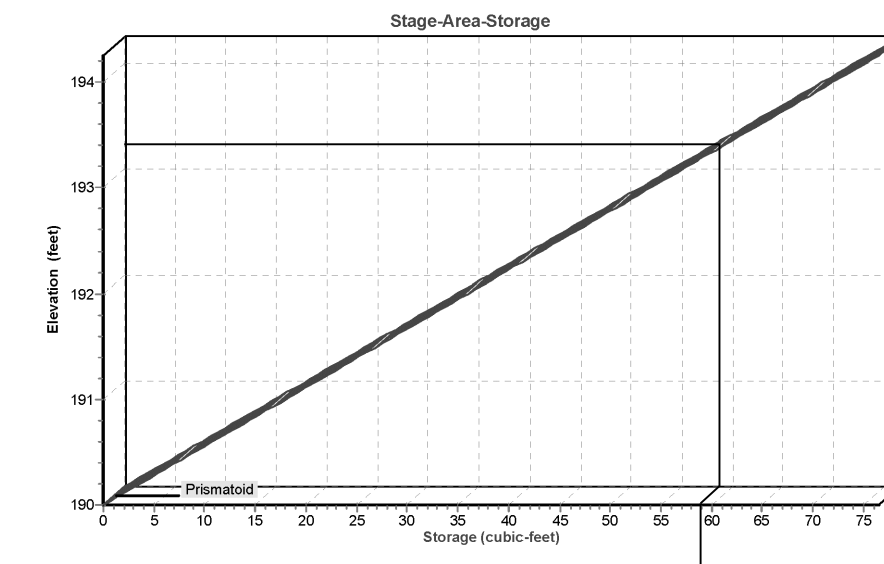

TOTAL VOLUME: 59 CF

TOTAL ON-SITE STORAGE PROVIDED = 222+ CUBIC FEET + 84+ CUBIC FEET + 59+ CUBIC FEET = 365+ CUBIC FEET
 365+ CUBIC FEET > 368+ CUBIC FEET

CONTRIBUTING DRAINAGE AREA MAP ENLARGEMENT

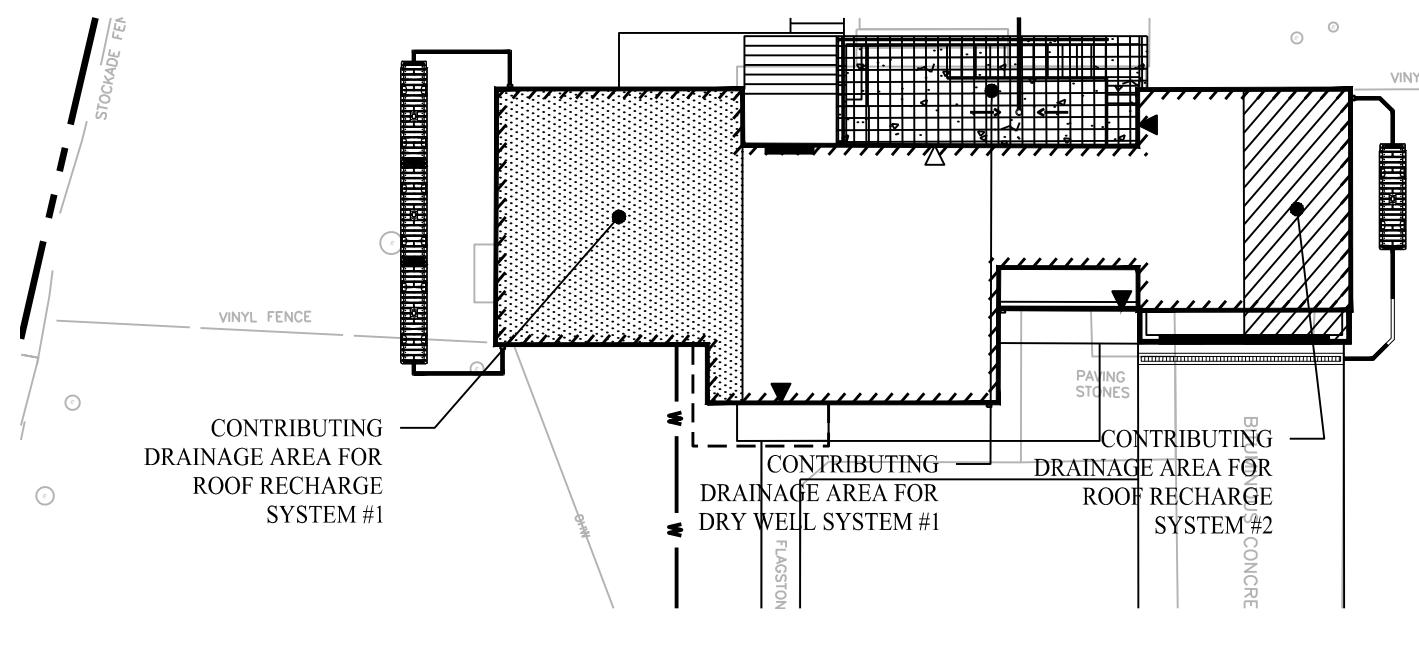

LEGEND

	CONTRIBUTING DRAINAGE AREA FOR ROOF RECHARGE SYSTEM #1
	CONTRIBUTING DRAINAGE AREA FOR ROOF RECHARGE SYSTEM #2
	CONTRIBUTING DRAINAGE AREA FOR DRY WELL SYSTEM #1
	CONTRIBUTING DRAINAGE AREA FOR DRY WELL SYSTEM #2




Drawn By:	JEP
Checked By:	CJB
Approved By:	KMS
Project #:	22205001
Plan Date:	12/22/22
Scale:	1" = 10'



PROPOSED DEVELOPMENT
 16 WOODLAND ROAD
 JAMAICA PLAIN, MASSACHUSETTS

Sheet Title: **SITE IMPROVEMENT PLAN**
 Sheet #: **2.11**

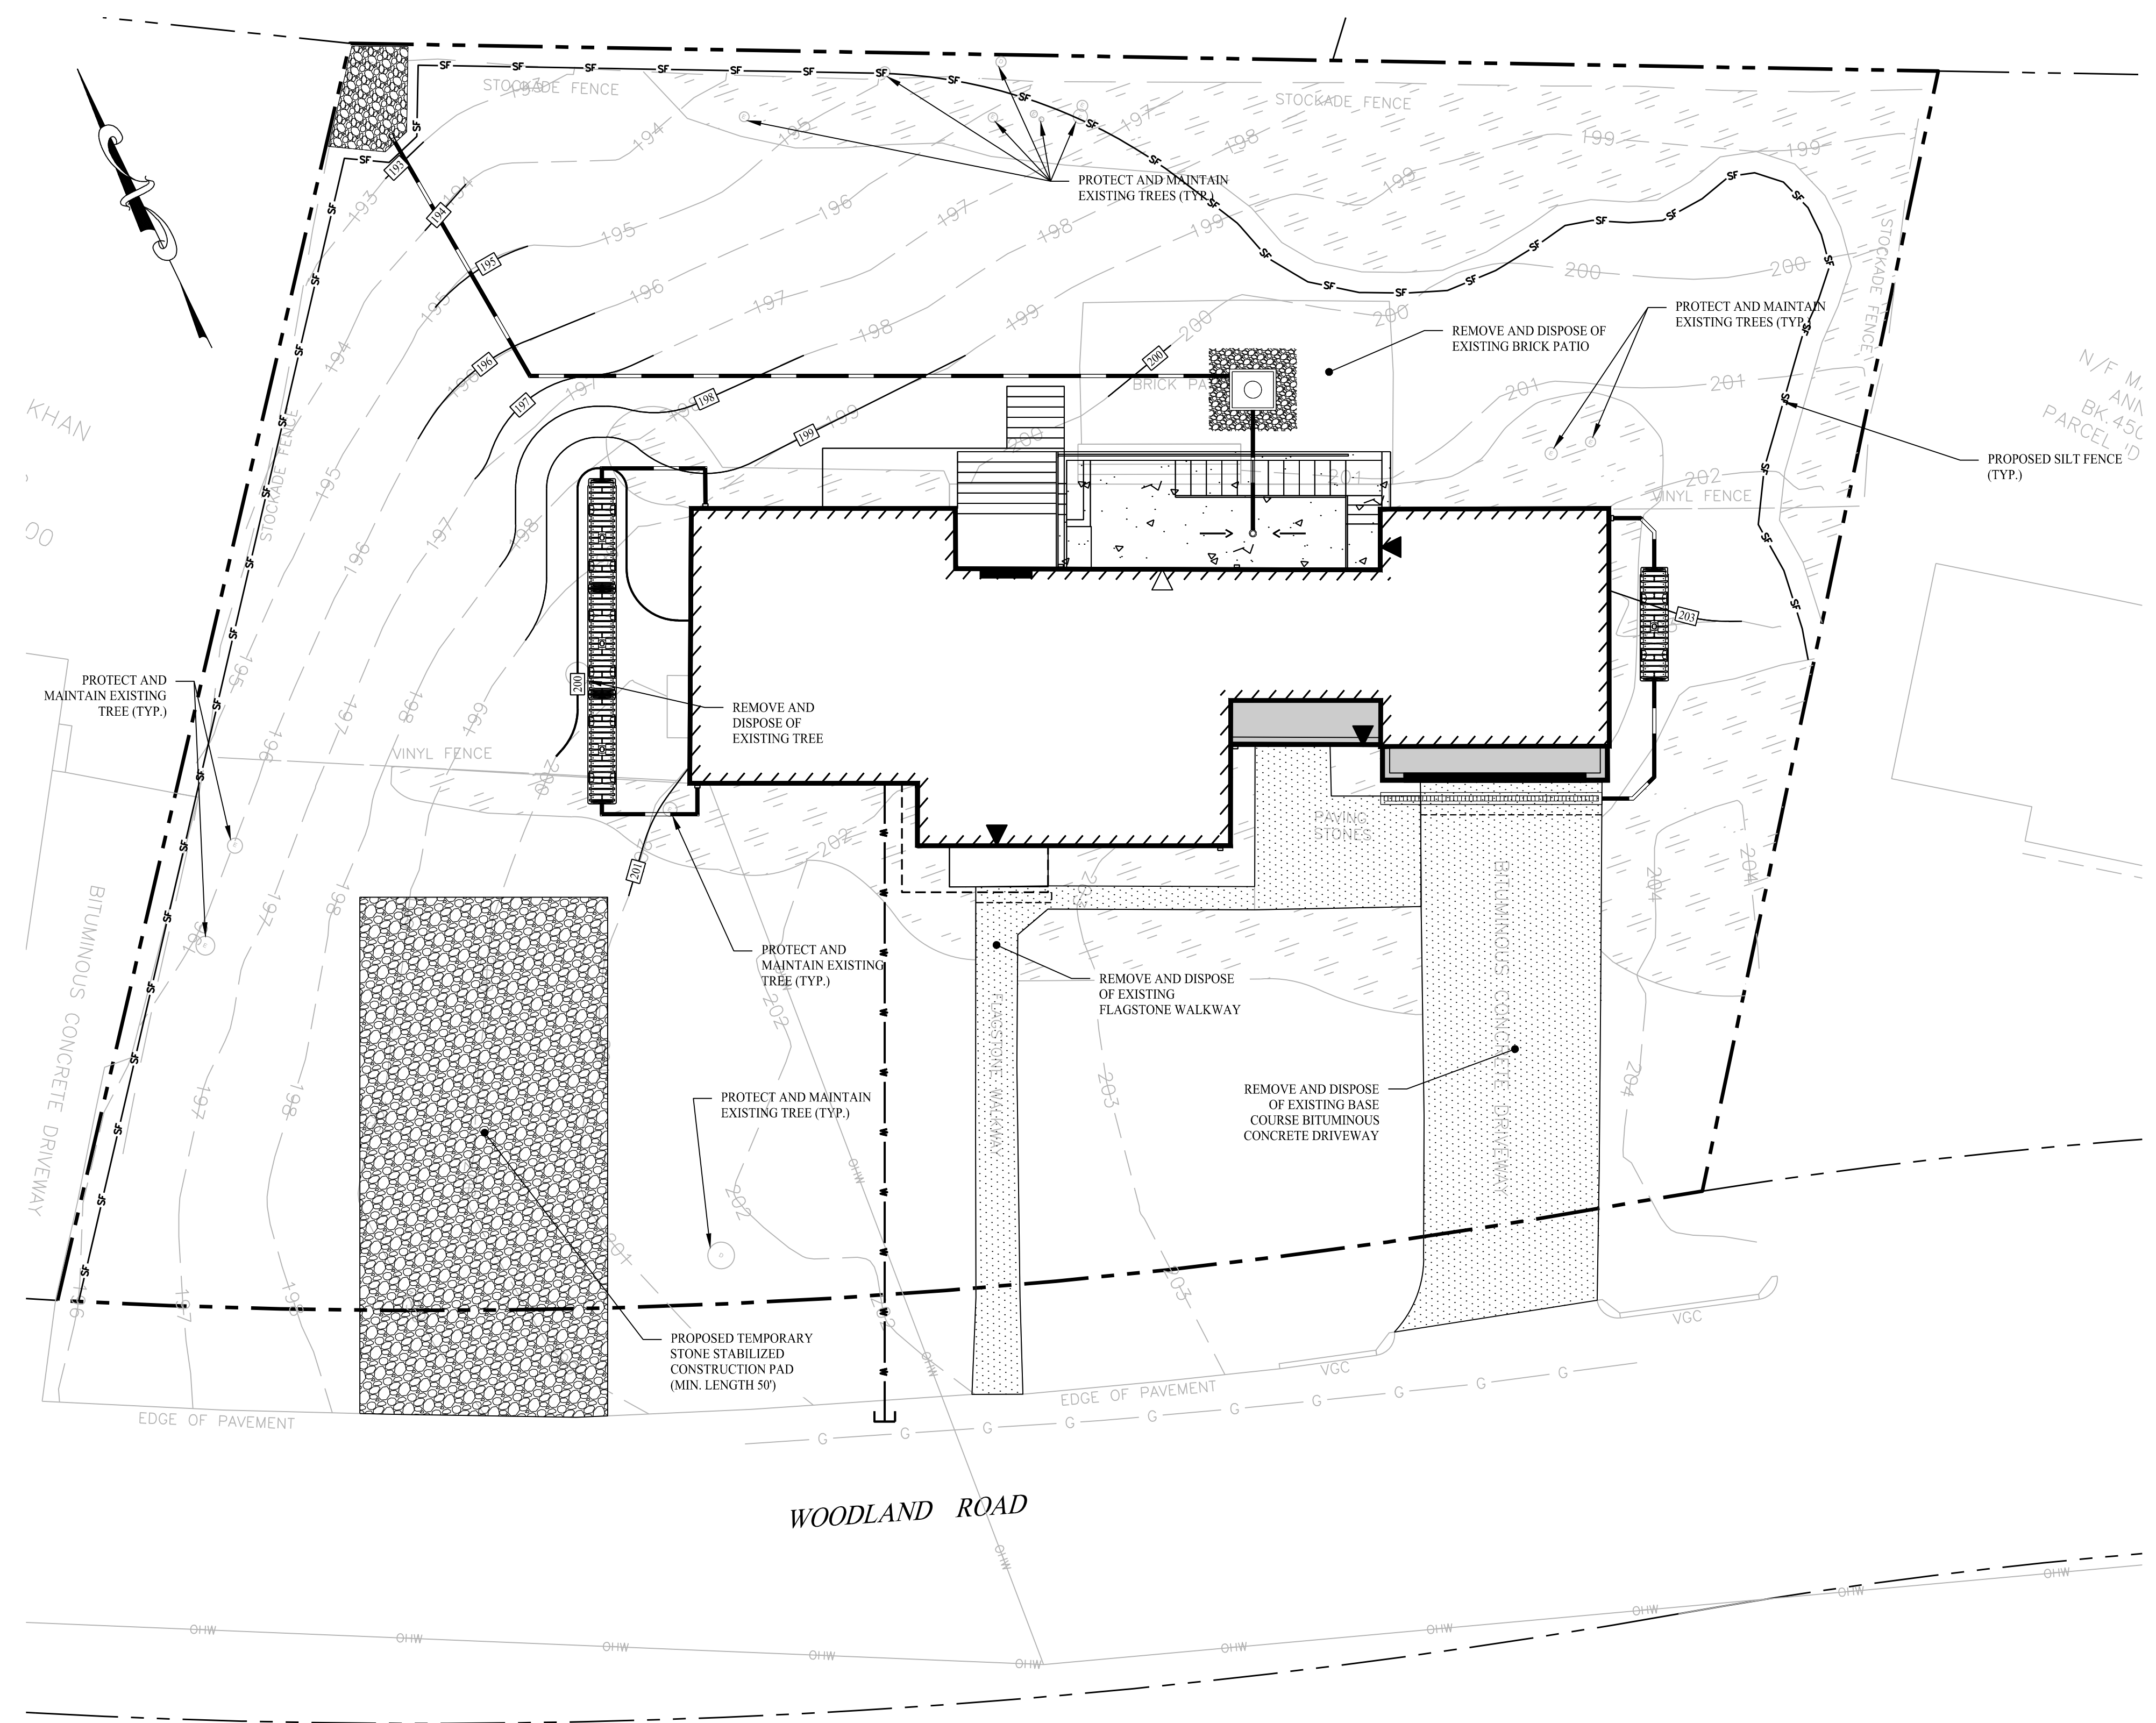

SOIL EROSION & SEDIMENT CONTROL NOTES

SEDIMENT & EROSION CONTROL NARRATIVE
 THE SEDIMENT AND EROSION CONTROL PLAN WAS DEVELOPED TO PROTECT THE EXISTING ROADWAY AND STORM DRAINAGE SYSTEMS, ADJACENT PROPERTIES, AND ANY ADJACENT WETLAND AREA AND WATER COURSE FROM SEDIMENT LADEN SURFACE RUNOFF AND EROSION.

CONTINGENCY EROSION PLAN
 THE CONTRACTOR SHALL INSTALL ALL SPECIFIED EROSION CONTROL MEASURES AND WILL BE REQUIRED TO MAINTAIN THEM IN THEIR INTENDED FUNCTIONING CONDITION. THE LAND USE AGENTS OF THE CITY OF BOSTON AND ENGINEER OF RECORD SHALL HAVE THE AUTHORITY TO REQUIRE SUPPLEMENTAL MAINTENANCE OR ADDITIONAL MEASURES IF FIELD CONDITIONS ARE ENCOUNTERED BEYOND WHAT WOULD NORMALLY BE ANTICIPATED.

- OPERATION REQUIREMENTS**
CLEARING, GRUBBING & DEMOLITION OPERATIONS:
- ALL SEDIMENTATION AND EROSION CONTROL MEASURES WILL BE INSTALLED PRIOR TO THE START OF CLEARING, GRUBBING AND DEMOLITION OPERATIONS.
 - FOLLOWING INSTALLATION OF ALL SEDIMENTATION AND EROSION CONTROL MEASURES, THE CONTRACTOR SHALL NOT PROCEED WITH GRADING, FILLING OR OTHER CONSTRUCTION OPERATIONS UNTIL THE ENGINEER HAS INSPECTED AND APPROVED ALL INSTALLATIONS.
 - THE CONTRACTOR SHALL TAKE EXTREME CARE DURING CLEARING, GRUBBING & DEMOLITION OPERATIONS SO AS NOT TO DISTURB SEDIMENTATION AND EROSION CONTROL DEVICES AS WELL AS EXISTING LANDSCAPED AREAS.
 - FOLLOWING THE COMPLETION OF CLEARING, GRUBBING AND DEMOLITION OPERATIONS, ALL AREAS SHALL BE STABILIZED WITH TOPSOIL AND SEEDING, PROCESSED AGGREGATE STONE OR DISPERSED HAY AS SOON AS PRACTICAL.

PLACEMENT OF DRAINAGE STRUCTURES, UTILITIES, AND ROADWAY CONSTRUCTION OPERATIONS:

- SILT FENCES SHALL BE INSTALLED AT THE DOWNHILL SIDES OF TEMPORARY TRAPS, MUD PUMP DISCHARGES, AND UTILITY TRENCH MATERIAL STOCKPILES. HAY BALES MAY BE USED IF SHOWN ON THE EROSION CONTROL PLANS OR IF DIRECTED BY THE ENGINEER OF RECORD.

INSTALLATION OF SEDIMENTATION AND EROSION CONTROL MEASURES

- SILTATION FENCE:**
 - DIG A SIX INCH TRENCH ON THE UPHILL SIDE OF THE DESIGNATED FENCE LINE LOCATION.
 - POSITION THE POST AT THE BACK OF THE TRENCH (DOWNHILL SIDE), AND HAMMER THE POST AT LEAST 1.5 FEET INTO THE GROUND.
 - LAY THE BOTTOM SIX INCHES OF THE FABRIC INTO THE TRENCH TO PREVENT UNDERMINING BY STORM WATER RUNOFF.
 - BACKFILL THE TRENCH AND COMPACT.
- CONSTRUCTION ENTRANCE:**
 - REMOVE ALL VEGETATION AND OTHER MATERIALS FROM THE FOUNDATION AREA. GRADE AND CROWN FOUNDATION FOR POSITIVE DRAINAGE.
 - PLACE 1-2" STONE A MINIMUM OF 100FT ALONG THE FULL WIDTH OF THE CONSTRUCTION ACCESS ROAD. AGGREGATE SHOULD BE PLACED AT LEAST 6" THICK.
 - GEOTEXTILE FILTER FABRIC SHALL BE PLACED BETWEEN STONE FILL AND EARTH SURFACE TO REDUCE THE MIGRATION OF SOIL PARTICLES FROM THE UNDERLYING SOIL INTO THE STONE AND VICE VERSA.
 - ALL SURFACE WATER THAT IS FLOWING TO OR DIVERTED TOWARD THE CONSTRUCTION ENTRANCE SHALL BE PIPED BENEATH THE ENTRANCE.
 - FILTER FABRIC FENCE SHALL BE INSTALLED DOWN GRADIENT FROM THE CONSTRUCTION ENTRANCE IN ORDER TO CONTAIN ANY SEDIMENT-LADEN RUNOFF FROM THE ENTRANCE.

OPERATION AND MAINTENANCE OF SEDIMENTATION AND EROSION CONTROL MEASURES

- SILTATION FENCE:**
 - ALL SILTATION FENCES SHALL BE INSPECTED AS A MINIMUM WEEKLY OR AFTER EACH RAINFALL. ALL DETERIORATED FABRIC AND DAMAGED POSTS SHALL BE REPLACED AND PROPERLY REPOSITIONED IN ACCORDANCE WITH THIS PLAN.
 - SEDIMENT DEPOSITS SHALL BE REMOVED FROM BEHIND THE FENCE WHEN THEY EXCEED A HEIGHT OF ONE FOOT.
- CONSTRUCTION ENTRANCE:**
 - THE CONSTRUCTION ENTRANCE AND FENCE SHALL BE INSPECTED AT A MINIMUM WEEKLY AND AFTER HEAVY RAINS OR HEAVY USE.
 - REMOVE MUD AND HEAVY SEDIMENT TRACKED OR WASHED ONTO PUBLIC ROAD IMMEDIATELY.
 - THE GRAVEL PAD SHALL BE TOPDRESSED WITH NEW STONE WHEN MUD AND SOIL PARTICLES CLOG THE VOIDS IN THE GRAVEL.
 - RESHAPE PAD AS NEEDED FOR DRAINAGE AND RUNOFF CONTROL.
 - REPAIR ANY BROKEN ROAD PAVEMENT IMMEDIATELY.


EROSION AND SEDIMENT CONTROL PLAN

- SILTATION FENCE WILL BE INSTALLED AT ALL CULVERT OUTLETS IF CULVERT OUTLETS ARE APPLICABLE TO THIS PROJECT AND ALONG THE TOE OF ALL CRITICAL CUT AND FILL SLOPES.
- CULVERT DISCHARGE AREAS WILL BE PROTECTED WITH RIP RAP CHANNELS; ENERGY DISSIPATORS WILL BE INSTALLED AS SHOWN ON THESE PLANS AND AS NECESSARY.
- CATCH BASINS WILL BE PROTECTED WITH HAY BALE FILTERS, SILT SACKS, SILTATION FENCE, OR OTHER INLET PROTECTION DEVICES PER DETAILS, THROUGHOUT THE CONSTRUCTION PERIOD AND UNTIL ALL DISTURBED AREAS ARE THOROUGHLY STABILIZED.
- ALL EROSION AND SEDIMENT CONTROL MEASURES WILL BE INSTALLED IN ACCORDANCE WITH THE STANDARDS AND SPECIFICATIONS OF THE MASSACHUSETTS SOIL EROSION AND SEDIMENT CONTROL GUIDELINES MANUAL, LATEST EDITION.
- EROSION AND SEDIMENT CONTROL MEASURES WILL BE INSTALLED PRIOR TO CONSTRUCTION WHENEVER POSSIBLE.
- ALL CONTROL MEASURES WILL BE MAINTAINED IN EFFECTIVE CONDITION THROUGHOUT THE CONSTRUCTION PERIOD.
- ADDITIONAL CONTROL MEASURES WILL BE INSTALLED DURING THE CONSTRUCTION PERIOD, IF NECESSARY OR REQUIRED OR AS DIRECTED BY THE ENGINEER OF RECORD OR BY LOCAL GOVERNING OFFICIALS.
- SEDIMENT REMOVED FROM EROSION CONTROL STRUCTURES WILL BE DISPOSED IN A MANNER WHICH IS CONSISTENT WITH THE INTENT AND REQUIREMENTS OF THE EROSION CONTROL PLANS, NOTES, AND DETAILS.
- THE OWNER IS ASSIGNED THE RESPONSIBILITY FOR IMPLEMENTING THIS EROSION AND SEDIMENT CONTROL PLAN. THIS RESPONSIBILITY INCLUDES THE INSTALLATION AND MAINTENANCE OF CONTROL MEASURES, INFORMING ALL PARTIES ENGAGED ON THE CONSTRUCTION SITE OF THE REQUIREMENTS AND OBJECTIVES OF THE PLAN.


SEDIMENT & EROSION CONTROL NOTES

- THESE PLANS ARE FOR PERMITTING PURPOSES ONLY AND ARE NOT FOR CONSTRUCTION. NO CONSTRUCTION OR DEMOLITION SHALL BEGIN UNTIL APPROVAL OF THE FINAL PLANS IS GRANTED BY ALL GOVERNING AND REGULATORY AGENCIES.
- ALL SITE WORK TO BE COMPLETED IN ACCORDANCE WITH ALL PERMITS, APPROVALS AND CONDITIONS OF APPROVALS ISSUED BY THE CITY OF BOSTON FOR THIS PROJECT.
- EXISTING BOUNDARY AND TOPOGRAPHY IS BASED ON DRAWING TITLED "EXISTING CONDITIONS PLAN LAND IN BOSTON, JAMAICA PLAIN, SUFFOLK COUNTY, MASSACHUSETTS, 16 WOODLAND ROAD", SCALE 1"=10'; DATED: 03/09/2022; BY ANDERSON SURVEYS, INC.
- PRIOR TO STARTING ANY OTHER WORK ON SITE, THE CONTRACTOR SHALL NOTIFY APPROPRIATE AGENCIES AND SHALL INSTALL EROSION CONTROL MEASURES AS SHOWN ON THE PLANS AND AS IDENTIFIED STATE AND LOCAL APPROVAL DOCUMENTS PERTAINING TO THIS PROJECT. EROSION CONTROLS TO BE INSTALLED AT THE EDGE OF PROPOSED WORK.
- EROSION CONTROLS TO ACT AS A LIMIT OF WORK LINE TO ENSURE THAT NO EQUIPMENT ENCROACHES ON THE ADJACENT PROPERTIES.
- EROSION CONTROLS SHALL REMAIN IN PLACE AND BE MAINTAINED FOR THE DURATION OF THE PROJECT TO LIMIT THE MOVEMENT OF SILTATION AND SEDIMENTS FROM ENTERING EXISTING DRAINAGE SYSTEMS OR FROM LEAVING THE PARCEL. ANY ACCUMULATED SEDIMENTS ARE TO BE REMOVED FROM THE EROSION CONTROLS AND DISPOSED TO PROPERLY. ADDITIONALLY, ALL EROSION CONTROLS ARE TO BE INSPECTED AFTER A STORM EVENT AND THE CONTROLS REPLACED OR ARMORED AS NECESSARY AND ACCUMULATED SEDIMENTS REMOVED.
- ADDITIONAL EROSION CONTROLS ARE TO BE UTILIZED AS NECESSARY AND AS DIRECTED BY THE ENGINEER OF RECORD TO LIMIT SEDIMENTS FROM DISCHARGING TO ADJACENT PROPERTIES OR INTO EXISTING STORM DRAIN SYSTEMS.
- CONTRACTOR SHALL BE RESPONSIBLE TO CONTROL CONSTRUCTION SUCH THAT EROSION SHALL NOT AFFECT OFF-SITE AREAS, WHETHER SUCH EROSION IS CAUSED BY WATER, WIND, OR DIRECT DEPOSIT.
- A RESERVE AMOUNT OF EROSION CONTROL MATERIALS ARE TO BE KEPT WITHIN EASY ACCESS ON SITE AT ALL TIMES.
- CONTRACTOR SHALL PERFORM CONSTRUCTION SEQUENCING SUCH THAT EARTH MATERIALS ARE EXPOSED FOR A MINIMUM OF THE TIME BEFORE THEY ARE COVERED, SEED, OR OTHERWISE STABILIZED TO PREVENT EROSION.
- TEMPORARY STOCKPILING OF MATERIALS RELATED TO THE CONSTRUCTION ACTIVITIES ARE TO BE PROPERLY STABILIZED, PROTECTED AND DEMARCATED TO LIMIT MOVEMENT OF MATERIAL INTO STORM DRAIN SYSTEM OR ONTO ADJACENT PARCELS.
- REFUELING AND ANY WORK ASSOCIATED WITH THE MAINTENANCE OF CONSTRUCTION EQUIPMENT TO BE PERFORMED IN COMPLIANCE WITH APPLICABLE REGULATIONS.
- THE AREAS OF CONSTRUCTION SHALL REMAIN IN A STABLE CONDITION AT THE CLOSE OF EACH CONSTRUCTION DAY. EROSION CONTROLS SHALL BE CHECKED AT THIS TIME AND MAINTAINED OR REINFORCED IF NECESSARY.
- EROSION CONTROLS SHALL REMAIN IN PLACE UNTIL ALL DISTURBED AREAS HAVE BEEN STABILIZED WITH PAVEMENT, PLANTINGS, OR WITH AN ESTABLISHED STAND OF GRASS. EROSION CONTROLS SHALL NOT BE REMOVED UNTIL SITE STABILIZATION IS COMPLETE. CONTRACTOR SHALL REMOVE AND DISPOSE OF EROSION CONTROL MEASURES AND CLEAN SEDIMENT AND DEBRIS FROM ENTIRE DRAINAGE AND SEWER SYSTEMS AS DIRECTED BY THE ENGINEER OF RECORD, DPW AND/OR BOSTON LAND USE AGENT.
- UTILIZE APPROPRIATE Dewatering SYSTEMS AND TECHNIQUES TO MAINTAIN THE EXCAVATED AREA SUFFICIENTLY DRY FROM GROUNDWATER AND/OR SURFACE RUNOFF SO AS TO NOT ADVERSELY AFFECT CONSTRUCTION PROCEDURES OR CAUSE EXCESSIVE DISTURBANCE OF UNDERLYING NATURAL GROUND.
- WATER FROM TRENCHES AND EXCAVATIONS SHALL NOT BE DISCHARGED DIRECTLY TO STORM DRAIN SYSTEMS. PROPER TREATMENT TO A SEDIMENTATION AREA IS TO TAKE PLACE PRIOR TO DISCHARGE TO ANY DRAINAGE SYSTEMS.
- THE CONTRACTOR SHALL REPAIR ANY DAMAGE RESULTING FROM THE FAILURE OF THE Dewatering OPERATIONS OR FROM FAILURE TO MAINTAIN ALL THE AREAS OF WORK IN SUITABLE DRY CONDITION.
- PRECAUTIONS SHALL BE TAKEN TO PROTECT NEW WORK FROM FLOODING DURING STORMS OR FROM OTHER CAUSES. GRADING IN THE AREAS SURROUNDING ALL EXCAVATIONS SHALL BE PROPERLY SLOPED TO PREVENT WATER FROM RUNNING INTO THE EXCAVATED AREA OR TO ADJACENT PROPERTIES. WHERE REQUIRED, TEMPORARY DITCHES SHALL BE PROVIDED FOR DRAINAGE UPON COMPLETION OF THE WORK AND WHEN DIRECTED, ALL AREAS SHALL BE RESTORED IN A SATISFACTORY MANNER AND AS DIRECTED.
- ALL PIPELINES OR STRUCTURES NOT STABLE AGAINST UPLIFT DURING CONSTRUCTION OR PRIOR TO COMPLETION SHALL BE THOROUGHLY BRACED OR OTHERWISE PROTECTED.
- REFER TO SHEET 3.01 FOR DETAILS OF THE PROPOSED SOIL EROSION AND SEDIMENT CONTROL (SEC) MEASURES AND ADDITIONAL INFORMATION REGARDING CONSTRUCTION SEQUENCE, SEC MEASURE INSTALLATION, AND MAINTENANCE.

LEGEND

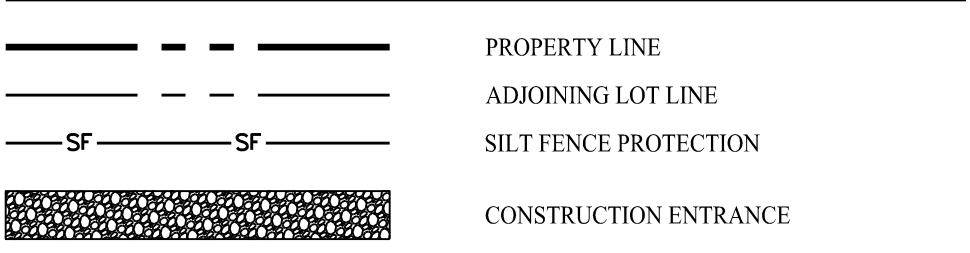

Rev. #:	Date	Description
1	08/28/23	Response to Comments

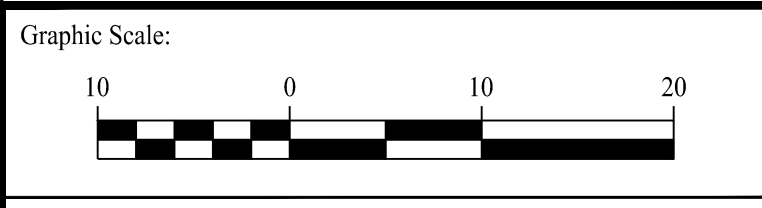

SOLLI ENGINEERING
 501 Main Street, Monroeville, CT 06468 T: (203) 880-5455 F: (203) 880-9695
 11 Vandalia Ave, Norwood, MA 02062 T: (781) 352-8491 F: (203) 880-9695


Drawn By:	JEP
Checked By:	CJB
Approved By:	KMS
Project #:	22205001
Plan Date:	12/22/22
Scale:	1" = 10'



PROPOSED DEVELOPMENT
 16 WOODLAND ROAD
 JAMAICA PLAIN, MASSACHUSETTS

Sheet Title:	SOIL EROSION & SEDIMENT CONTROL PLAN
Sheet #:	2.31


Aug 28, 2023 - 10:16am chertford
 B:\SE Firm\Project Data\2023\22205001 - 16 Woodland Rd - Jamaica Plain, MA\Cad Data\22205001-2.31.dwg

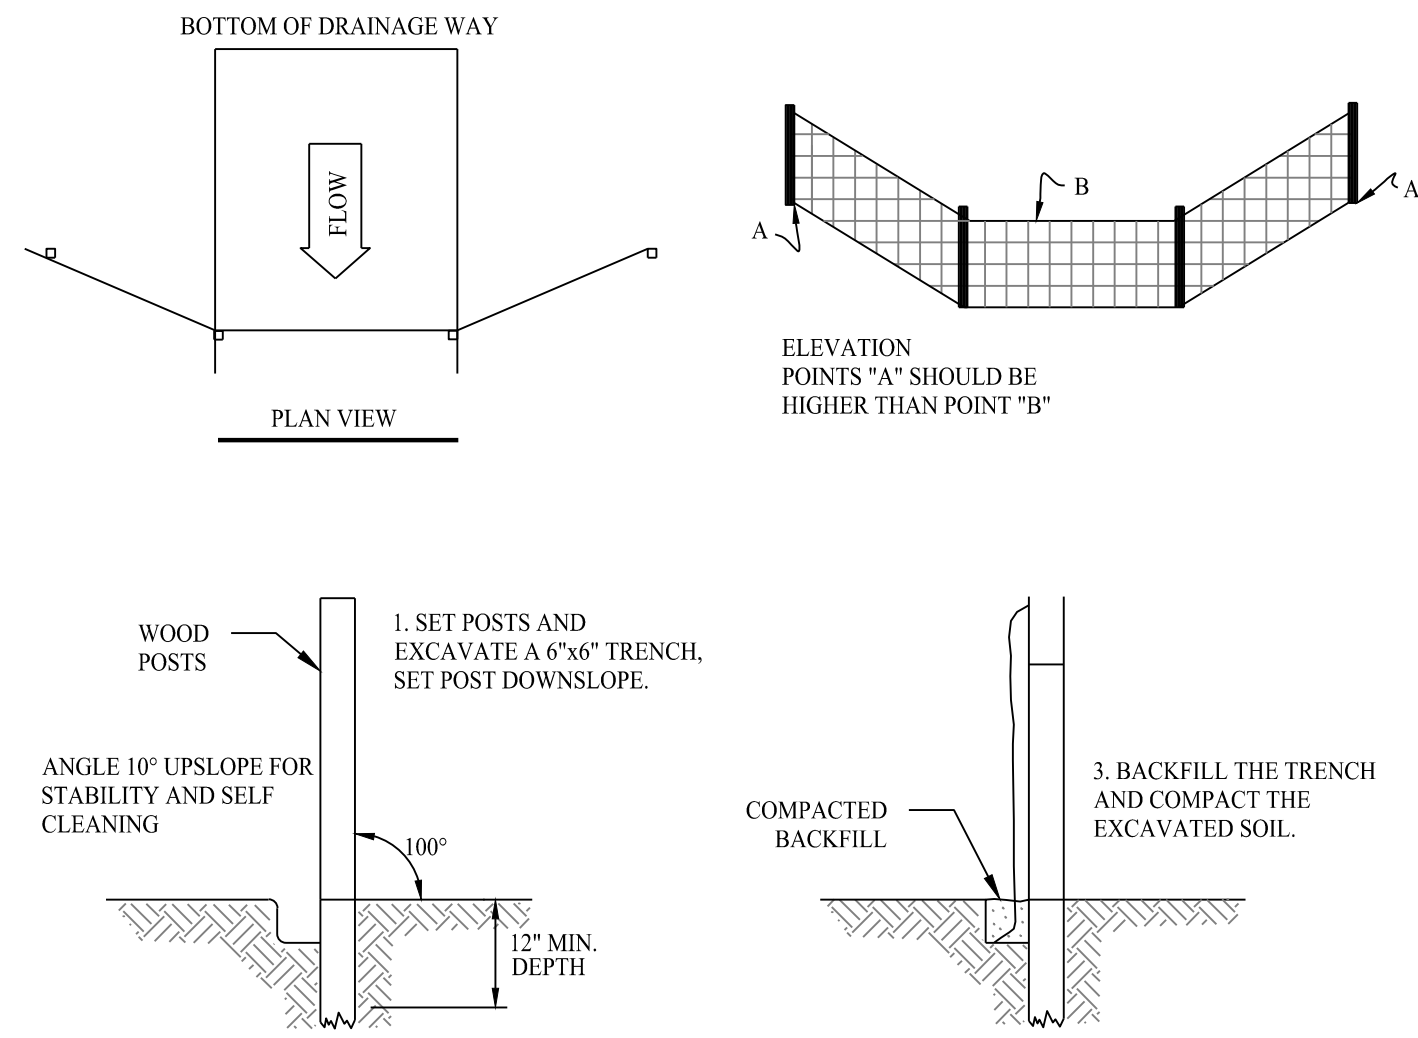

WHEREVER SILT FENCE RUNS ACROSS OR PERPENDICULAR TO SURFACE CONTOURS, 10-FOOT LONG WINGS OF SILT FENCE PLACED PERPENDICULAR TO THE MAIN RUN OF SILT FENCE SHOULD BE PROVIDED AT APPROXIMATE INTERVALS OF 50-FEET.


SILT FENCE PROTECTION DETAIL

SCALE: NTS

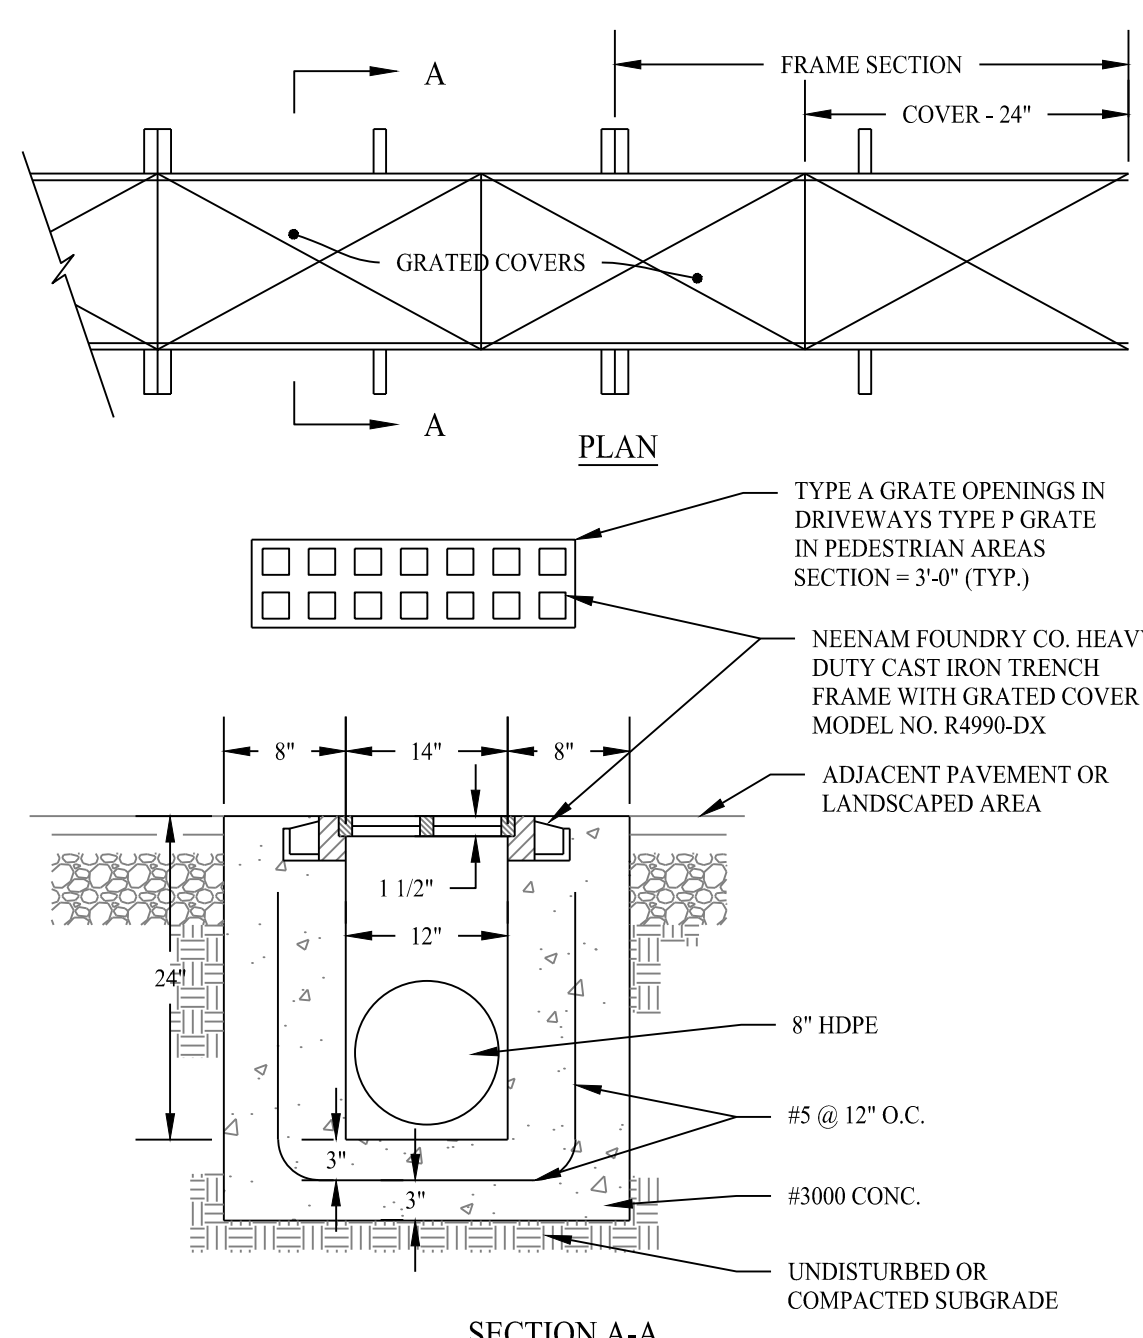


TRENCH DRAIN DETAIL

SCALE: NTS

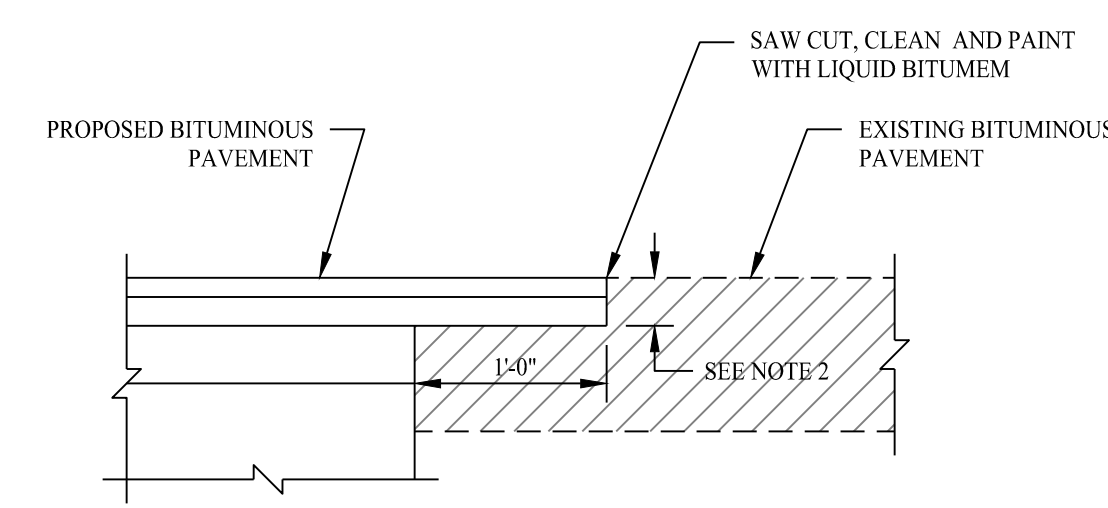


PAVEMENT MATCH TREATMENT (SAWCUT) DETAIL

SCALE: NTS

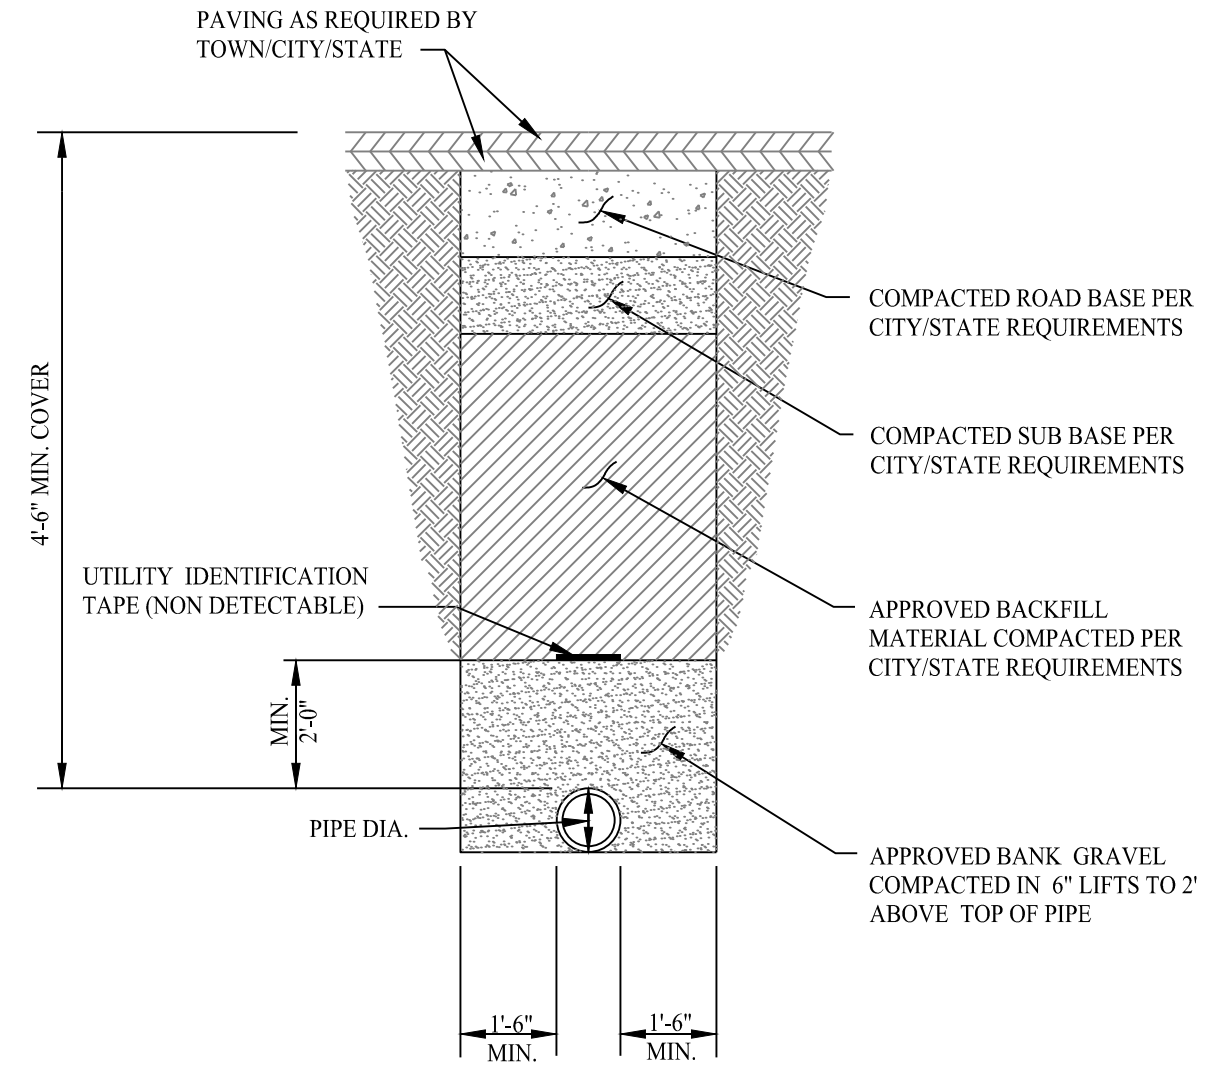

TYPICAL WATER MAIN TRENCH


SCALE: NTS

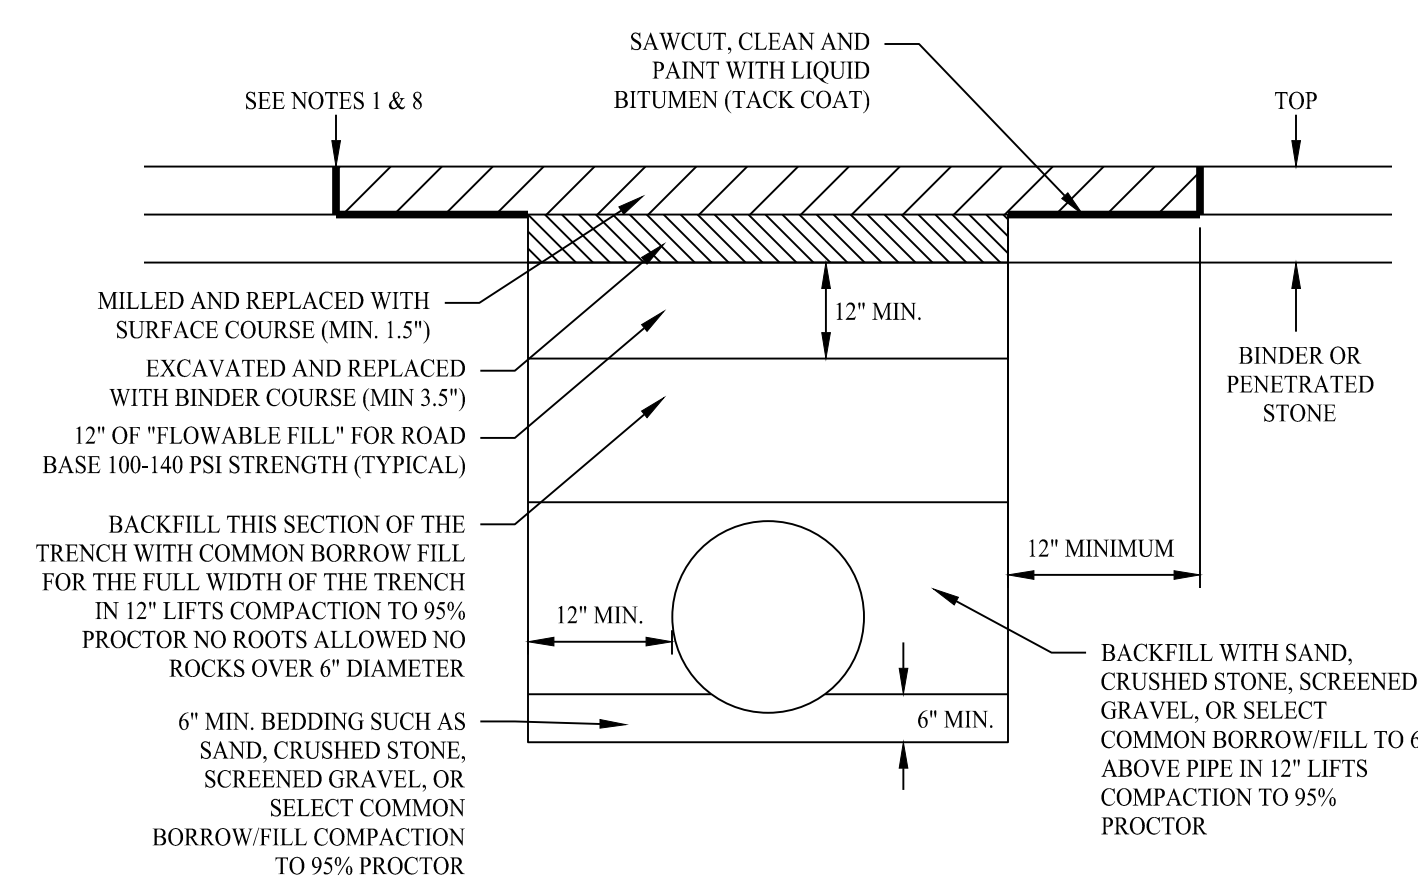

PAVEMENT REPAIR OVER TRENCH


SCALE: NTS

- NOTES
1. SAW CUT OUTER EDGE OF UTILITY PATCH
 2. MILL TO REMOVE TOP COURSE
 3. LEAVE 12" MIN. LIP BETWEEN EDGE OF TOP AND EDGE OF BINDER COURSE
 4. REPLACE LAYERS OF BINDER AND DEEP BASE; THE THICKNESS OF SURFACE COURSE AND BINDER COURSE TO MATCH SAME DEPTH AS EXISTING ASPHALT MINIMUM GALLON PER 25 SQUARE YARDS
 5. TACK AREA OF MILLING 1
 6. REPLACE TOP COURSE
 7. SEAL EDGES OF UTILITY PATCH WITH HOT POURED RUBBERIZED ASPHALT SEALANT
 8. ALL ROAD CUTS 2' OR LESS FROM THE CURB MUST BE MILLED AND REPAIRED FROM THE OUTER MOST EDGE OF CUT TO THE CURB

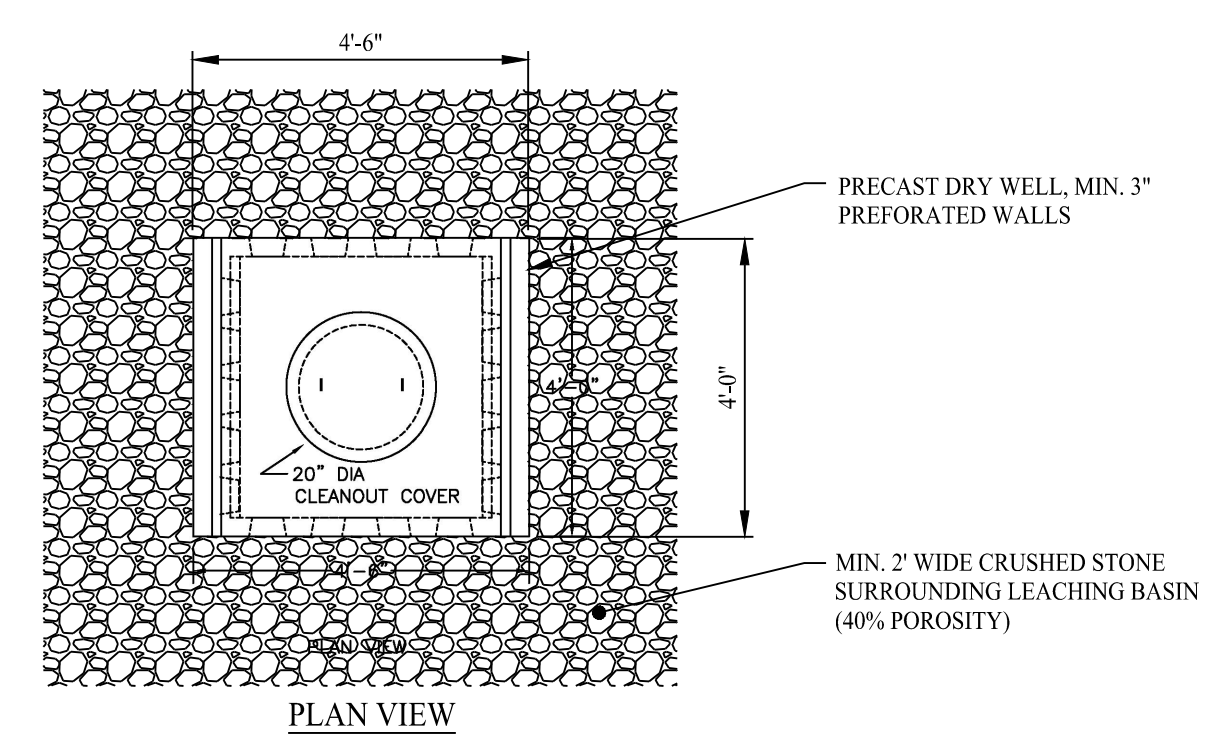

300 GALLON PRECAST CONCRETE DRY WELL DETAIL


SCALE: NTS

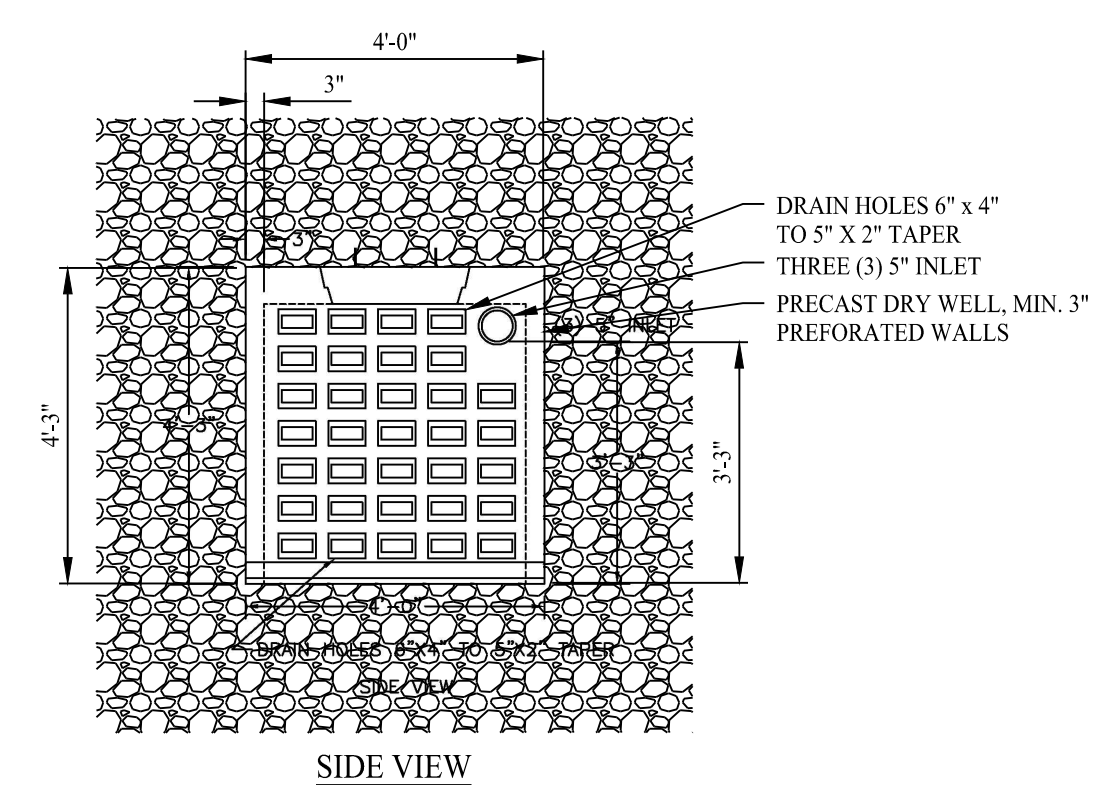

CONSTRUCTION ENTRANCE

SCALE: NTS


		PIPE DIAMETER, in (mm)					
		12	15	18	24	30	36
Diameter	in (mm)	(300)	(375)	(450)	(600)	(750)	(900)
A	in (mm)	6.5 (165)	6.5 (165)	7.5 (191)	7.5 (191)	7.5 (191)	7.5 (191)
B (max)	in (mm)	10.0 (254)	10.0 (254)	15.0 (381)	18.0 (475)	22.0 (559)	25.0 (635)
H	in (mm)	6.5 (165)	6.5 (165)	6.5 (165)	6.5 (165)	8.6 (218)	8.6 (218)
L	in (mm)	25.0 (635)	25.0 (635)	32.0 (813)	36.0 (914)	58.0 (1473)	58.0 (1473)
W	in (mm)	29.0 (737)	29.0 (737)	35.0 (889)	45.0 (1143)	63.0 (1600)	63.0 (1600)

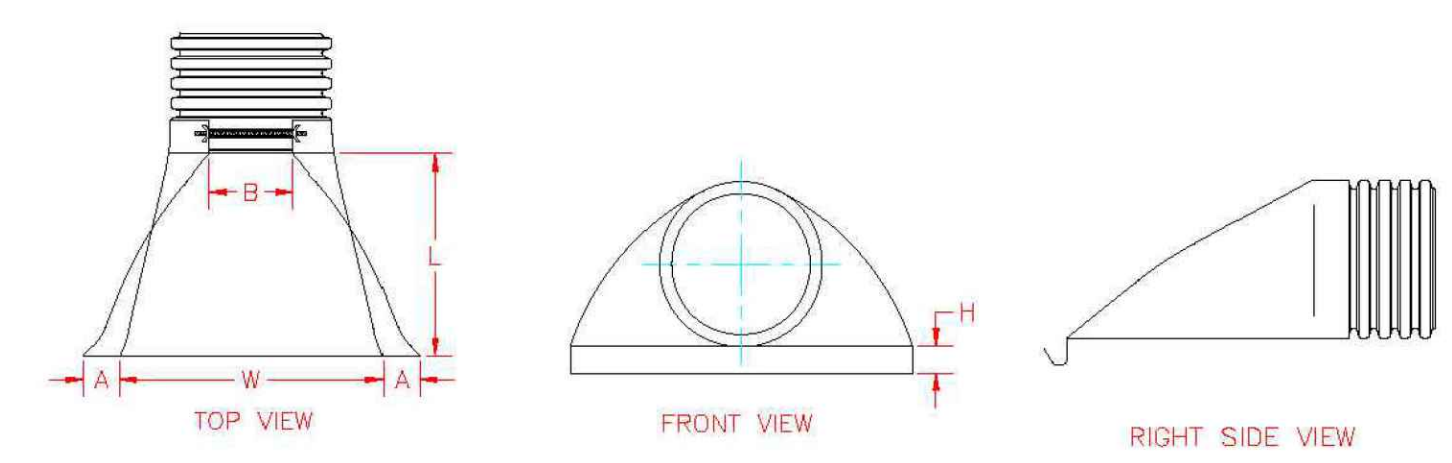


FLARED END SECTION DETAILS

SCALE: NTS

DETAIL PER ADVANCED DRAINAGE SYSTEMS, INC.

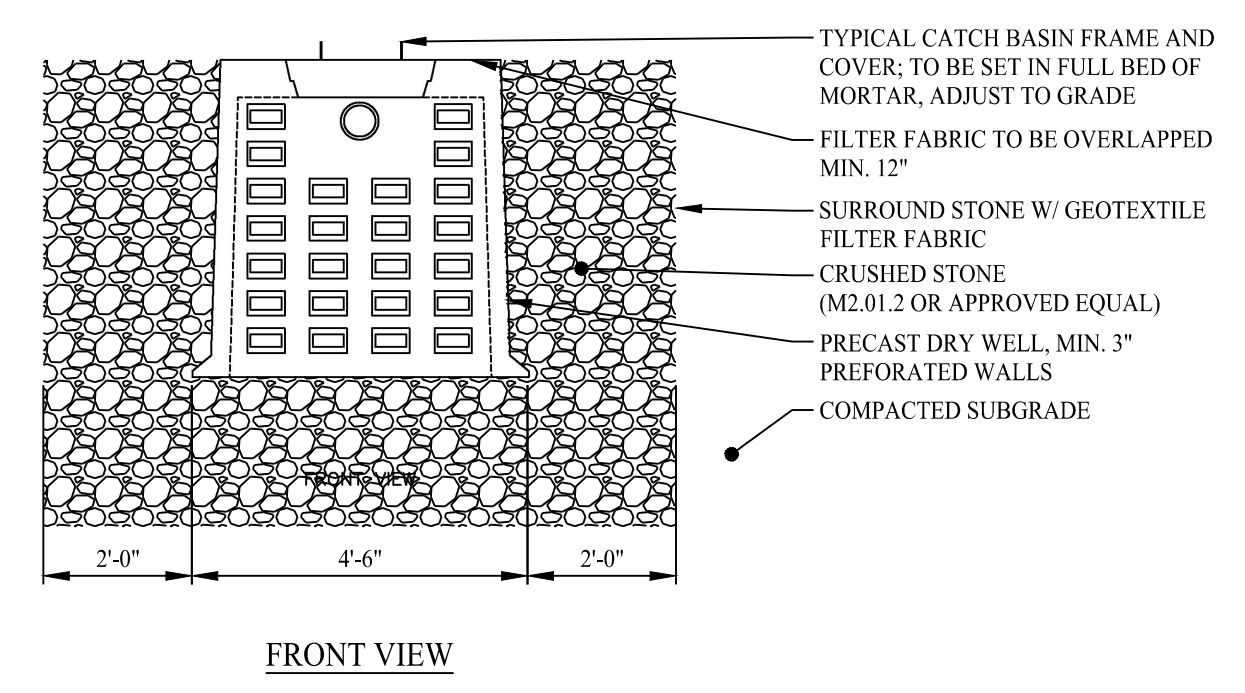

FRONT VIEW

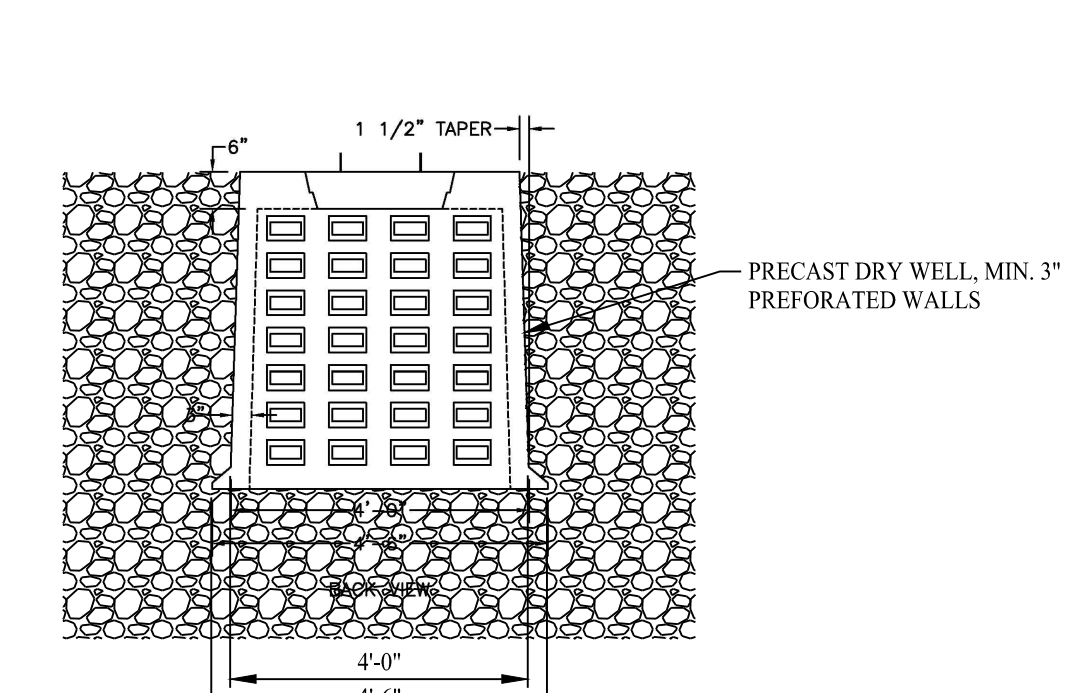

BACK VIEW

DETAIL PROVIDED BY SHEA CONCRETE PRODUCTS

Rev. #:	Date	Description


SOLLI ENGINEERING
 501 Main Street, Monroeville, CT 06468 T: (203) 880-5455 F: (203) 880-9695
 11 Vanderbilt Ave., Norwood, MA 02062 T: (781) 352-8491 F: (203) 880-9695

Drawn By: JEP
 Checked By: CJB
 Approved By: KMS
 Project #: 22205001
 Plan Date: 12/22/22
 Scale: NTS



Project:
PROPOSED DEVELOPMENT
 16 WOODLAND ROAD
 JAMAICA PLAIN, MASSACHUSETTS


Sheet Title: CONSTRUCTION DETAILS
 Sheet #: 3.01

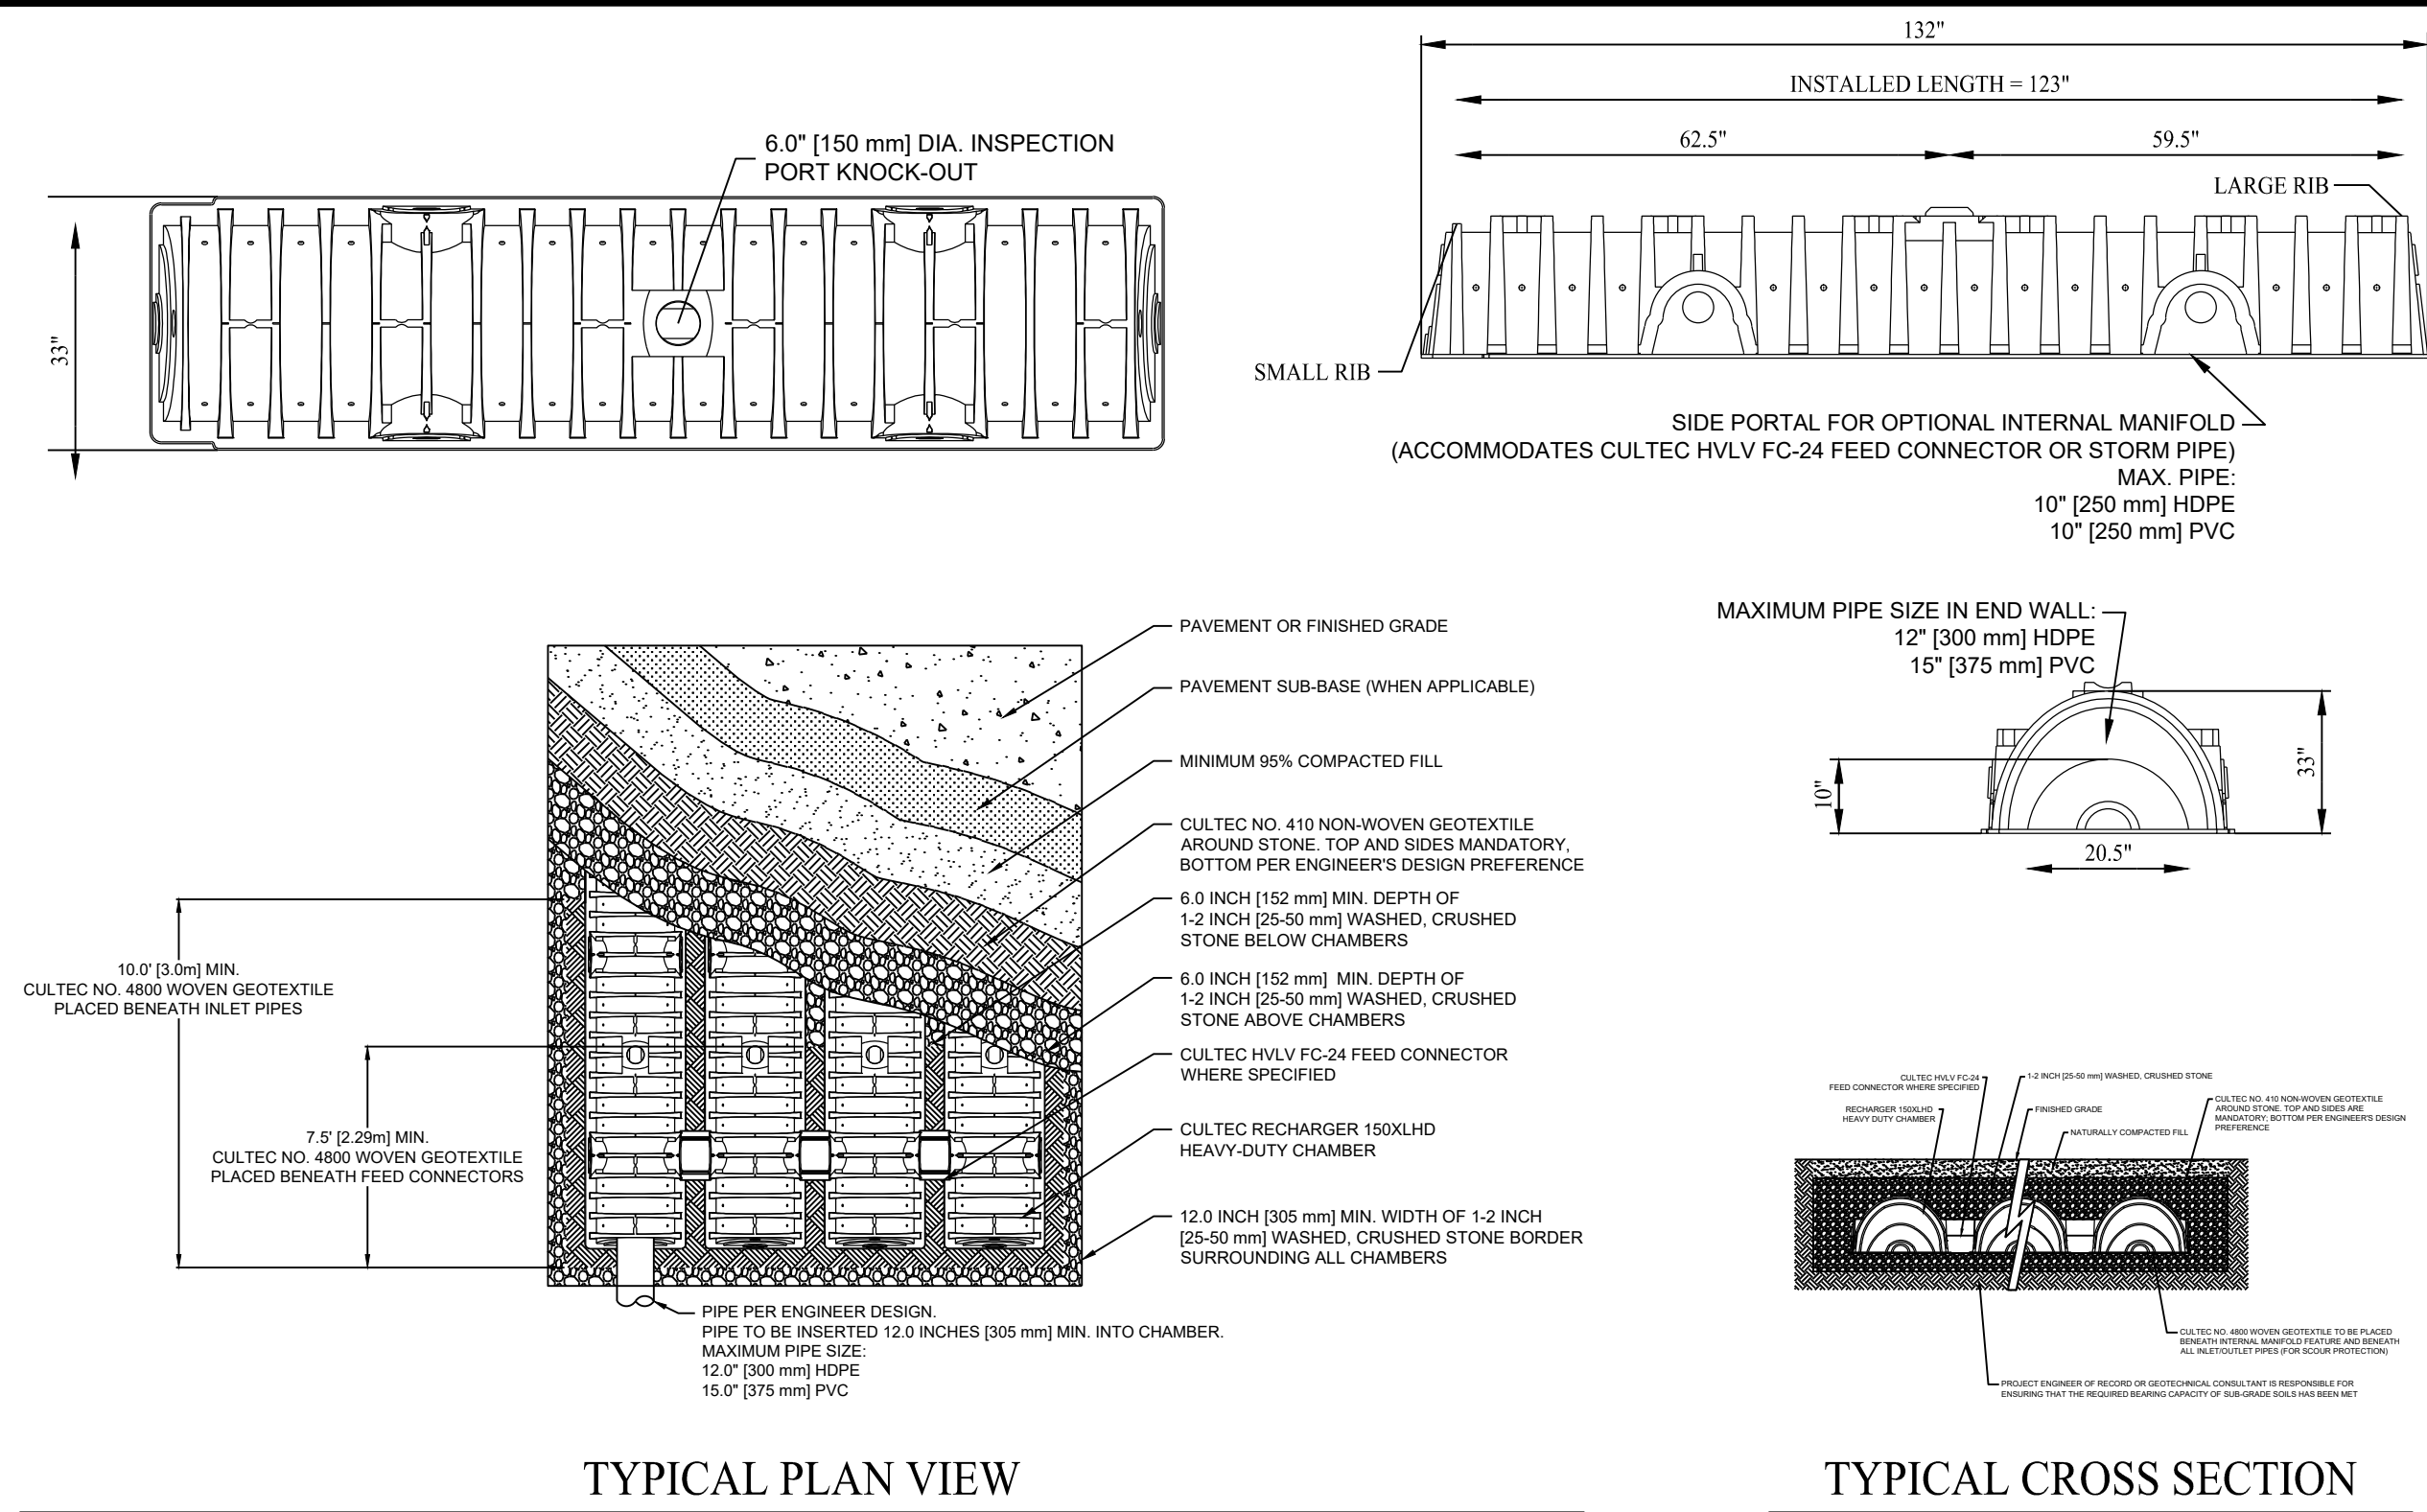

CULTEC RECHARGER 150XLHD STORMWATER CHAMBER DETAIL


SCALE: NTS

DETAIL PROVIDED BY CULTEC

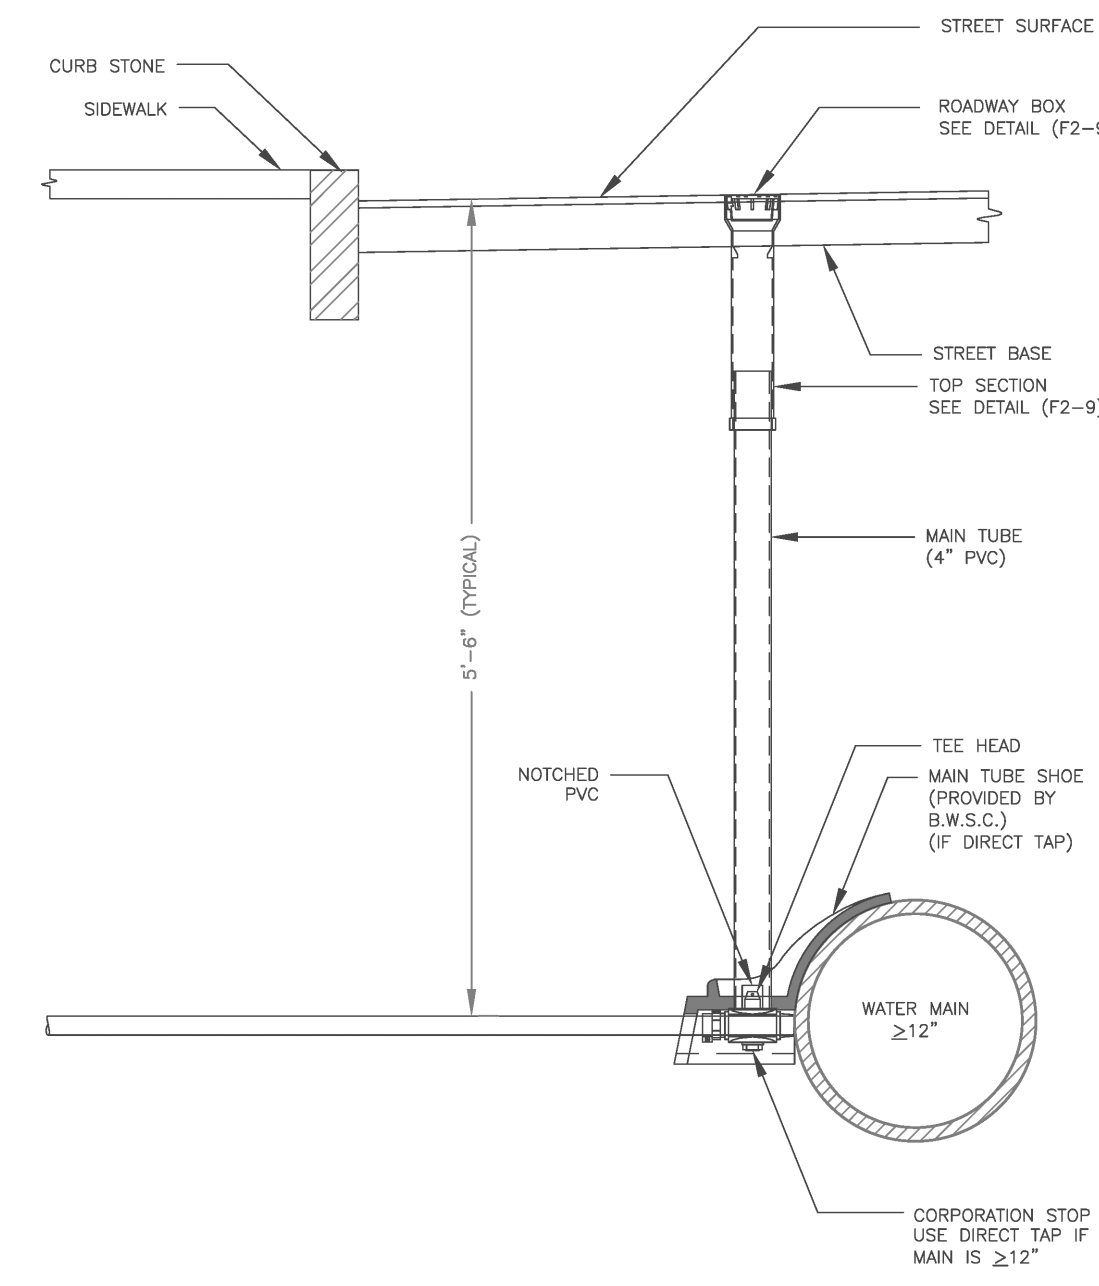


SCALE: NTS

DETAIL PROVIDED BY BOSTON WATER & SEWER COMMISSION

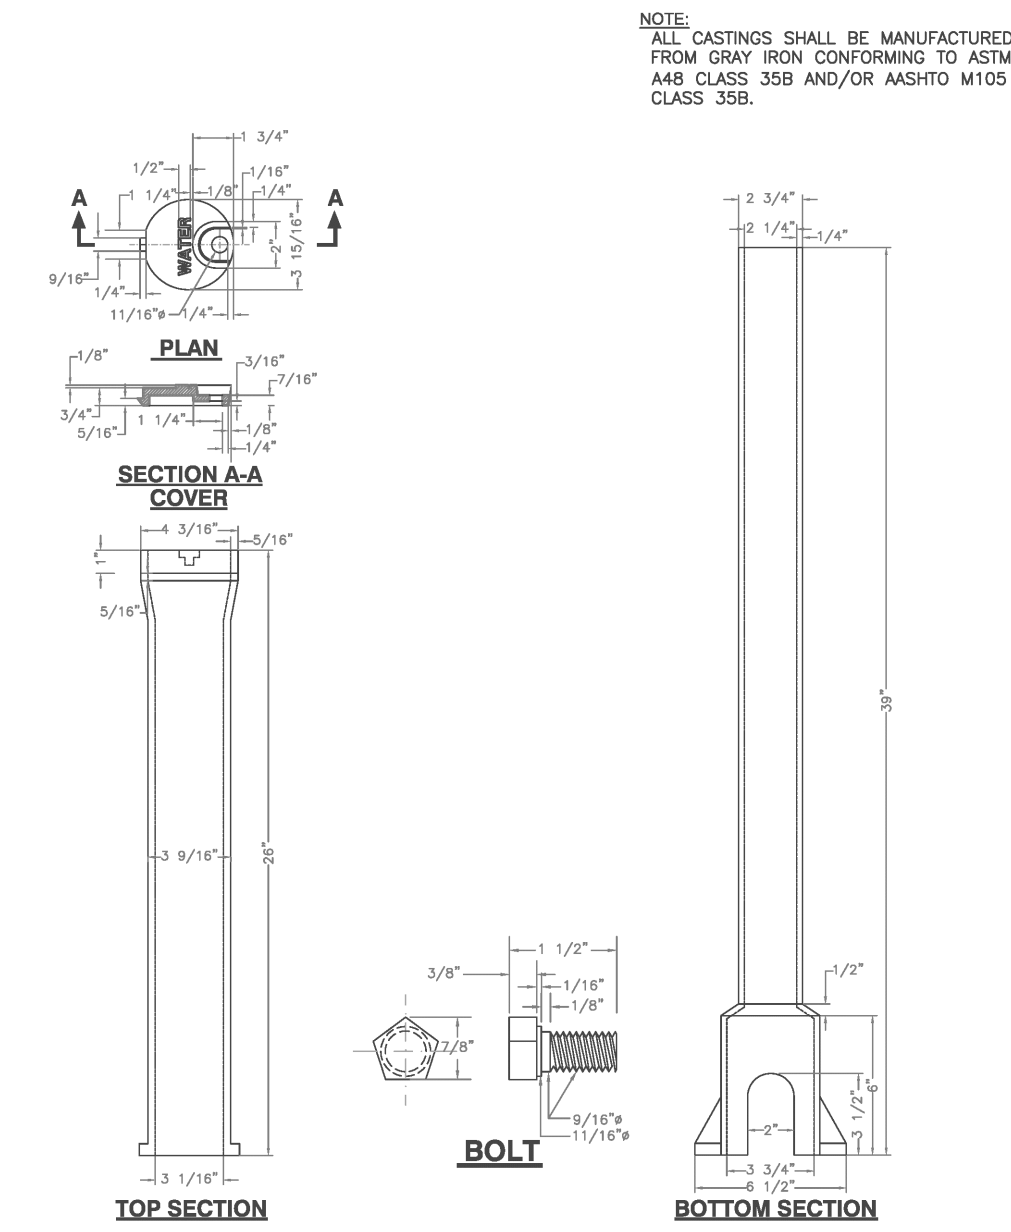


SCALE: NTS

DETAIL PROVIDED BY BOSTON WATER & SEWER COMMISSION

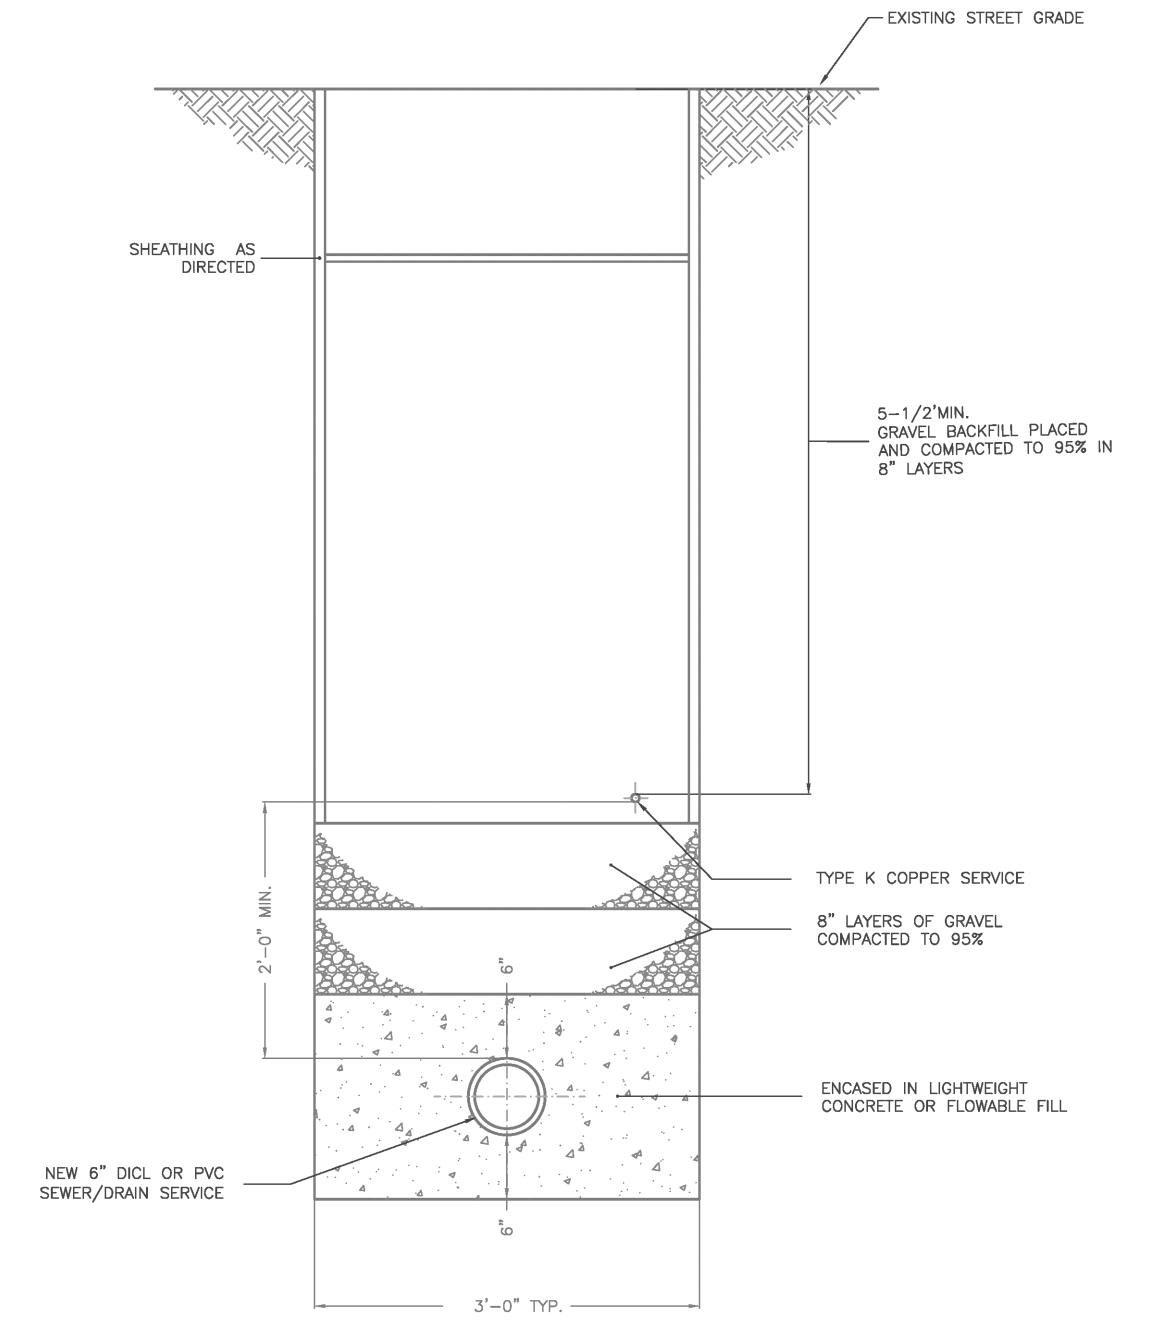


SCALE: NTS

DETAIL PROVIDED BY BOSTON WATER & SEWER COMMISSION

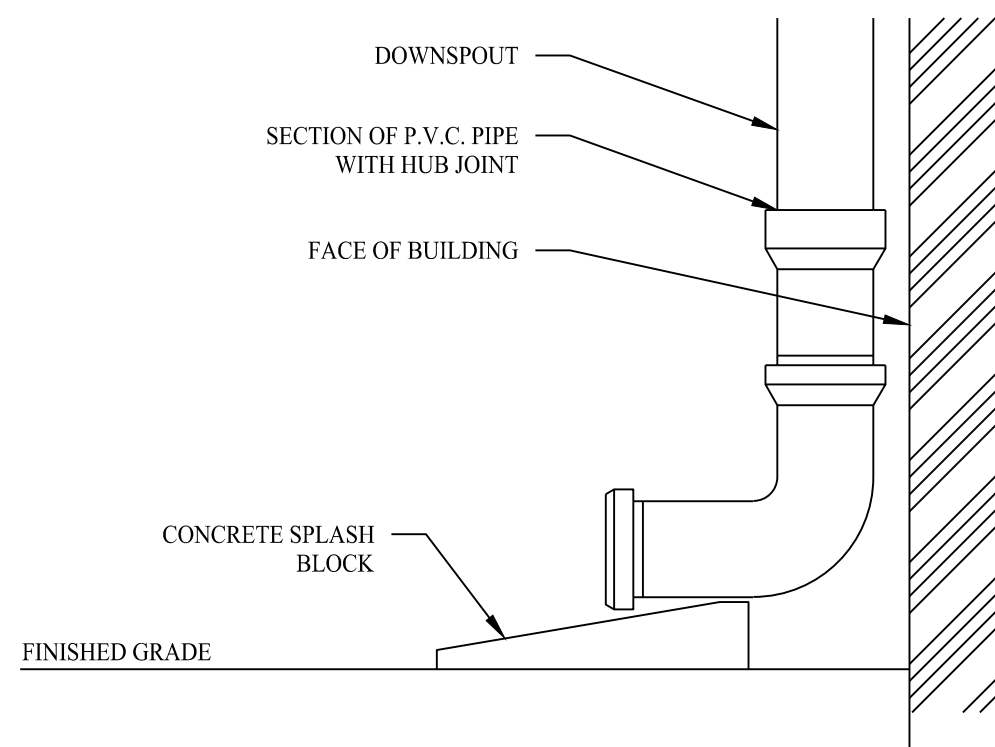


SCALE: NTS

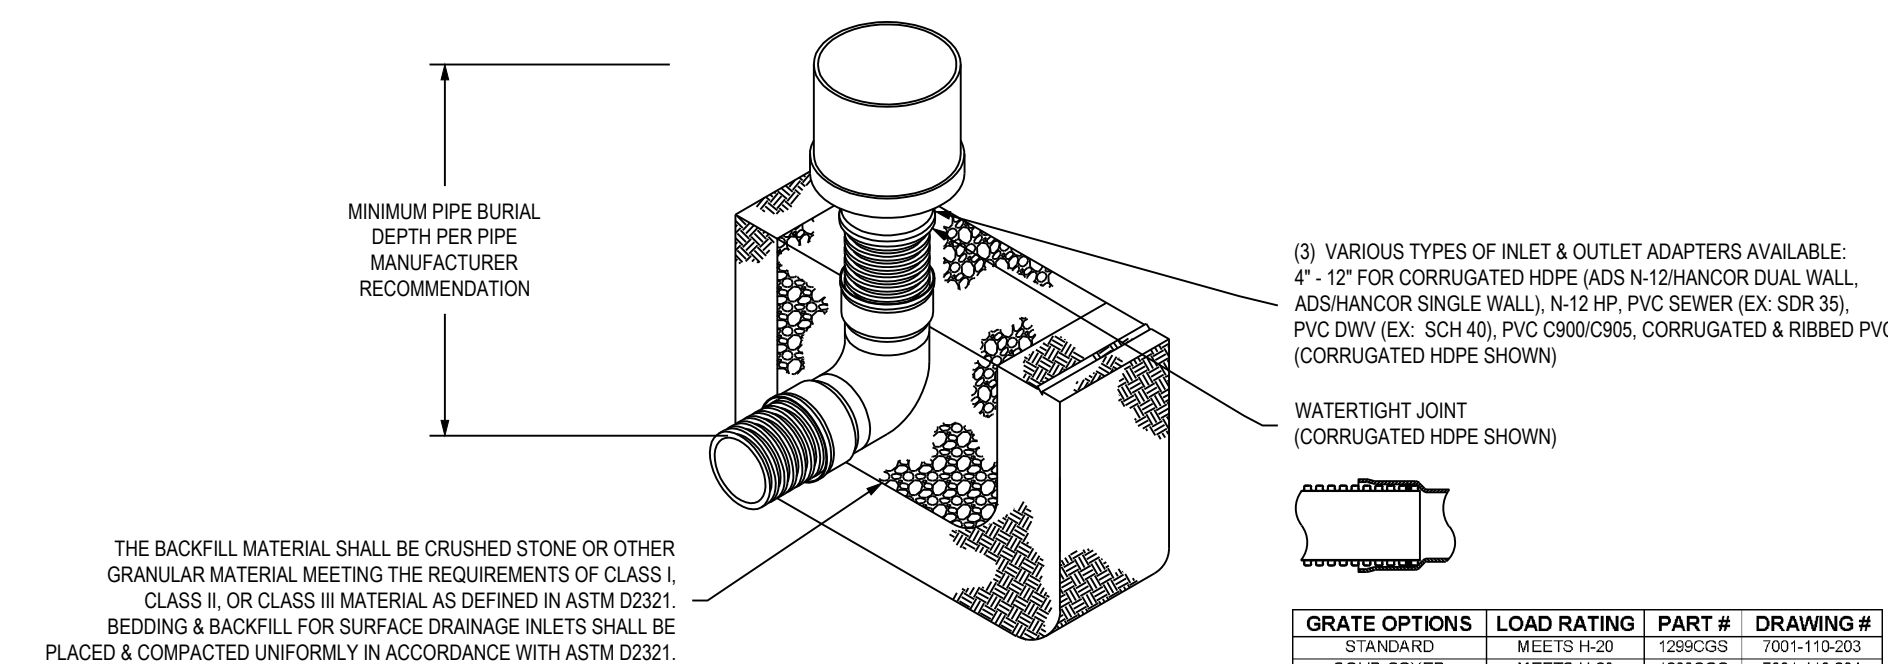


SCALE: NTS

DETAIL PROVIDED BY ADS

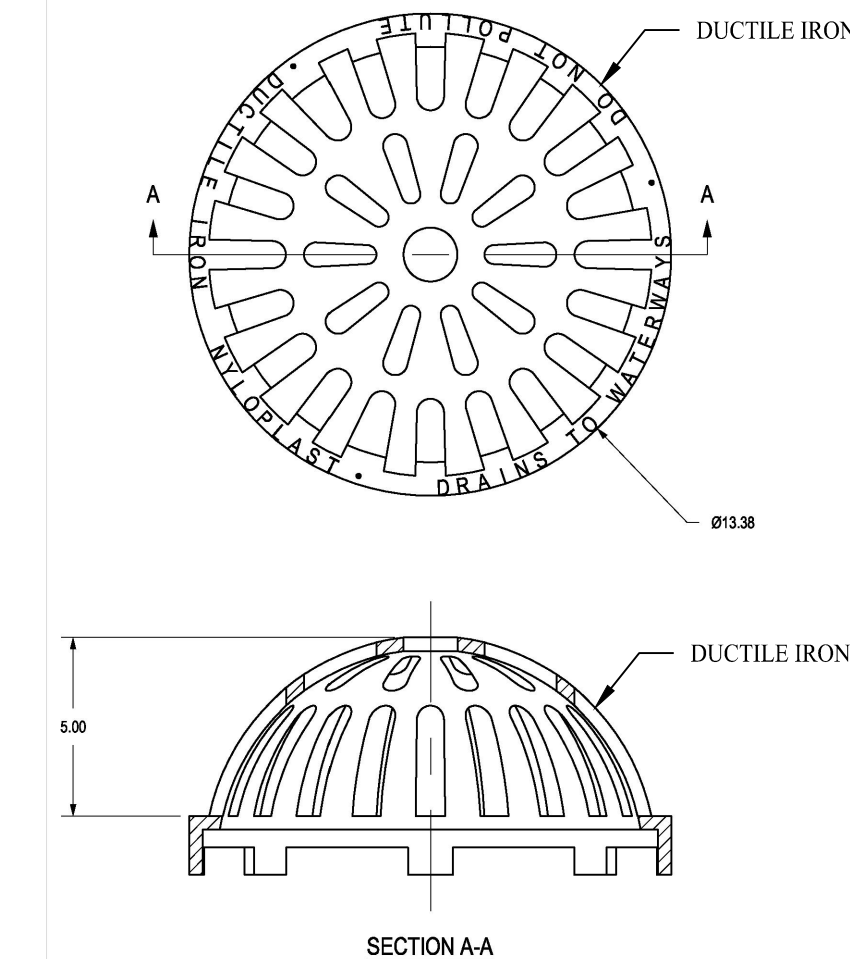

SCALE: NTS

DETAIL PROVIDED BY ADS

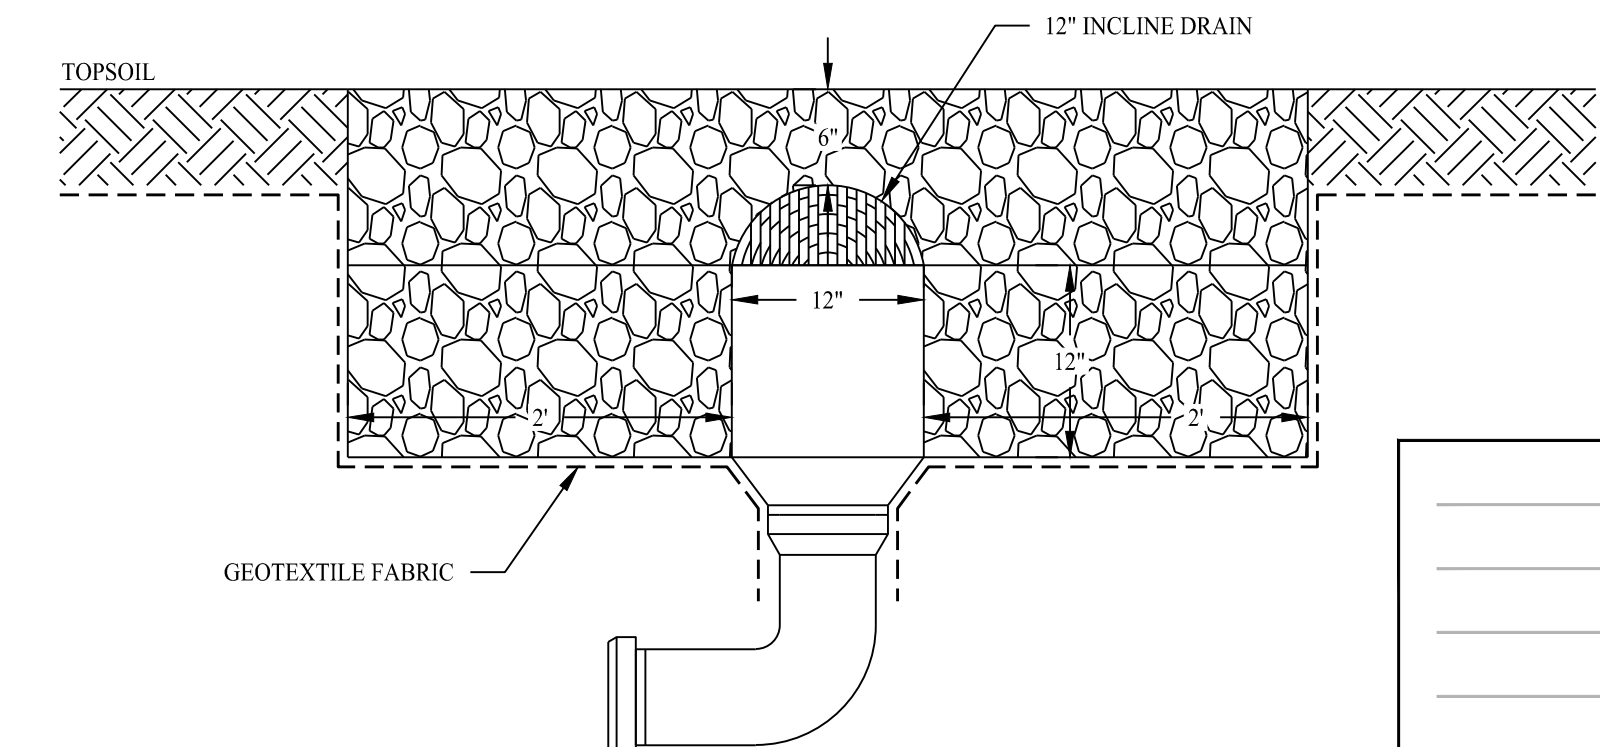

SCALE: NTS

Rev. #: Date Description

SOLLI ENGINEERING
 501 Main Street, Monroeville, CT 06468 T: (203) 880-5455 F: (203) 880-9695
 11 Vanderbilt Ave., Norwood, MA 02062 T: (781) 352-8491 F: (203) 880-9695

Drawn By: JEP
 Checked By: CJB
 Approved By: KMS
 Project #: 22205001
 Plan Date: 12/22/22
 Scale: NTS

Kevin M. Solli, P.E.
 MA 51952

PROPOSED DEVELOPMENT
 16 WOODLAND ROAD
 JAMAICA PLAIN, MASSACHUSETTS

Sheet Title:

CONSTRUCTION DETAILS

Sheet #:

3.02

GENERAL NOTES

- STRUCTURAL DESIGN IS IN ACCORDANCE WITH THE MASSACHUSETTS STATE BUILDING CODE, 9TH EDITION FOR 1 & 2 FAMILY DWELLINGS. ALL STRUCTURAL WORK TO BE COMPLETED IN ACCORDANCE WITH THIS CODE.
- DESIGN LOAD ASSUMPTIONS:
LIVE LOAD FLOORS.....40 PSF
SNOW LOAD GROUND SNOW LOAD P_g.....40 PSF
FLAT ROOF SNOW LOAD P_f.....30 PSF
WIND LOAD BASIC WIND SPEED.....128 MPH
EXPOSURE.....B
RISK CATEGORY.....II
MWFRS LATERAL LOAD.....32 PSF
C&C LATERAL LOAD.....
-FIELD -44 PSF
-CORNER -52 PSF
- THE CONTRACTOR SHALL COMPARE STRUCTURAL DRAWINGS WITH THE ARCHITECTURAL DRAWINGS BEFORE COMMENCING WITH THE WORK AND SHALL NOTIFY THE ARCHITECT AND ENGINEER OF ANY DISCREPANCIES REQUIRING CLARIFICATION OR REVISIONS. DO NOT SCALE STRUCTURAL DRAWINGS.
- THE CONTRACTOR SHALL SUBMIT COMPLETE SHOP DRAWINGS FOR THE ENGINEER'S APPROVAL FOR ALL PARTS OF THE WORK, INCLUDING CONCRETE AND STRUCTURAL STEEL FABRICATION OR ERECTION OF NEW STRUCTURAL ELEMENTS SHALL NOT COMMENCE WITHOUT ENGINEER'S REVIEW AND APPROVAL OF THE SHOP DRAWINGS.
- IN THE EVENT THAT CERTAIN DETAILS OF THE CONSTRUCTION ARE NOT FULLY SHOWN OR NOTED ON THE DRAWINGS, THEIR CONSTRUCTION SHALL BE OF THE SAME TYPE AS FOR SIMILAR CONDITIONS WHICH ARE SHOWN AND NOTED, SUBJECT TO THE STRUCTURAL ENGINEER'S APPROVAL.
- SEE THE ARCHITECTURAL DRAWINGS FOR THE FOLLOWING:
A. SIZE AND LOCATION OF ALL INTERIOR AND EXTERIOR NON BEARING PARTITIONS.
B. SIZE AND LOCATION OF ALL CONCRETE CURBS, FLOOR DRAINS, SLOPES, INSERTS, ETC. EXCEPT AS SHOWN.
C. SIZE AND LOCATION OF ALL DOOR AND WINDOW OPENINGS EXCEPT AS SHOWN.
D. FLOOR AND ROOF FINISHES.
E. WATERPROOFING AND DAMPROOFING DETAILS.
F. FINISHED FLOOR AND EXTERIOR ELEVATIONS.
G. DIMENSIONS NOT SHOWN ON STRUCTURAL DRAWINGS.
- SEE THE MECHANICAL, PLUMBING AND ELECTRICAL DRAWINGS FOR THE FOLLOWING:
A. PIPE AND DUCT RUNS, SLEEVES, HANGERS, TRENCHES, WALL AND SLAB OPENINGS, ETC. EXCEPT AS SHOWN OR NOTED.
B. ELECTRICAL CONDUIT RUNS, BOXES, OUTLETS IN WALLS AND SLABS.
C. CONCRETE INSERTS FOR ELECTRICAL, MECHANICAL, OR PLUMBING FIXTURES.
D. SIZE AND LOCATION OF MACHINE OR EQUIPMENT BASES, ANCHOR BOLTS FOR MOTOR MOUNTS, EXCEPT AS SHOWN OR NOTED.
- THE OWNER WILL RETAIN AN INDEPENDENT TESTING AGENCY TO INSPECT THE FOLLOWING TYPES OF WORK. SEE THE PROJECT SPECIFICATIONS FOR SPECIFIC REQUIREMENTS.
A. SUBGRADE, INCLUDING SOIL PREPARATION, COMPACTION AND BEARING CAPACITY
B. INSTALLATION OF EXPANSION AND ADHESIVE ANCHORS
C. STEEL FRAMING AND CONNECTIONS (BOLTS)
D. WHERE INDICATED ON THE DRAWINGS OR PROJECT SPECIFICATIONS.
- BOLTS AND ANCHOR RODS MUST BE OF SUFFICIENT LENGTH TO PROTRUDE BEYOND THE END OF THE NUT WHEN FULLY INSTALLED.
- CUTTING, SPLICING, OR NOTCHING OF STRUCTURAL MEMBERS IS NOT PERMITTED UNLESS NOTED OTHERWISE IN THE STRUCTURAL DRAWINGS FOR SPECIFIC LOCATIONS.

FOUNDATION

- FOUNDATIONS ON THIS PROJECT CONSIST OF CAST IN PLACE CONCRETE WALLS OVER CONTINUOUS SPREAD FOOTINGS AND CAST IN PLACE CONCRETE PIERS.
- PROVIDE 4"-0" MINIMUM FROST COVER FOR FOOTINGS.
- ALLOWABLE SOIL BEARING PRESSURE ASSUMED TO BE 3,000 PSF. BEARING CAPACITY OF SOIL SHALL BE CONFIRMED BY A GEOTECHNICAL ENGINEER PRIOR TO POURING FOOTINGS.
- NO FOUNDATION CONCRETE SHALL BE PLACED INTO STANDING WATER. WATER SHALL NOT BE ALLOWED TO STAND IN TRENCHES BEFORE OR AFTER CONCRETE IS PLACED. IF TRENCHES BECOME SOFTENED DUE TO RAIN OR OTHER WATER BEFORE THE CONCRETE IS CAST, THE CONTRACTOR SHALL EXCAVATE THE SOFTENED MATERIAL AND REPLACE WITH CONCRETE OR WELL COMPACTED CRUSHED STONE.
- FOUNDATION UNITS SHALL BE CENTERED UNDER SUPPORTED STRUCTURAL MEMBER, UNLESS NOTED OTHERWISE ON THE DRAWINGS.
- ALL EXCAVATIONS FOR FOUNDATIONS SHALL BE APPROVED BY THE OWNER'S GEOTECHNICAL ENGINEER PRIOR TO PLACING REINFORCEMENT AND CASTING CONCRETE.
- BACKFILL UNDER ANY PORTION OF THE STRUCTURE SHALL BE COMPACTED IN 6 INCH LIFTS.
- FOUNDATION WALLS SHALL NOT BE BACKFILLED UNTIL FIRST FLOOR DECK IS INSTALLED UNLESS APPROVED BY ENG.

MASONRY

- CONCRETE MASONRY UNITS TO BE NORMAL WEIGHT HOLLOW BLOCK ASTM C90 TYPE 1 GRADE N, 12X8X16 INCH UNITS, 10X8X16 INCH UNITS, 8X8X16 INCH UNITS OR 6X8X16 INCH UNITS. MINIMUM STRENGTH OF UNITS TO BE 2800 PSI.
- MORTAR FOR USE IN FOUNDATIONS WALLS, RETAINING WALLS, AND BELOW-GRADE CMU TO BE ASTM C270 TYPE M. ADMIXTURES ARE NOT ALLOWED.
- MORTAR FOR USE IN ABOVE GRADE STRUCTURAL MASONRY WALLS TO BE ASTM C270 TYPE S.
- MORTAR FOR USE IN NON-STRUCTURAL ABOVE GRADE WALLS/VENEERS TO BE ASTM C270 TYPE S OR TYPE N
- GROUT TO CONFORM TO ASTM C476, FINE, WITH A MINIMUM STRENGTH OF 3000 PSI.
- REINFORCING BARS SHALL CONFORM TO THE REQUIREMENTS OF ASTM A615 GRADE 60.
- MASONRY OPENINGS FOR MORE THAN 16" WIDE REQUIRE APPROVED LINTELS.
- PROVIDE AND INSTALL LINTELS FOR VENEER OPENINGS IN ACCORDANCE WITH THE FOLLOWING SCHEDULE:
MAX. OPENINGS LINTEL PER 4" OF MASONRY WIDTH
4'-0" 1-L6x4#6
7'-0" 1-L6x4#6
- PROVIDE 1-#5 VERTICAL REINFORCING BAR AT 32" O.C. AT CMU WALLS, UNO. THIS REINFORCING SHALL BE CONTINUOUS FOR THE FULL HEIGHT OF THE WALL. MASONRY BLOCK CELLS CONTAINING VERTICAL REINFORCING SHALL BE GROUTED SOLID. FILLING CELLS WITH MORTAR IS NOT ACCEPTABLE.
- REINFORCED MASONRY WALLS SHALL HAVE 9 GA LONGITUDINAL WIRES, LADDER OR TRUSS TYPE, AT 16 INCHES O.C. HORIZONTAL REINFORCEMENT, UNO.
- PROVIDE BOND BEAM AT EACH FLOOR LEVEL AND 8 FEET ON CENTER VERTICALLY.

CONCRETE AND REINFORCEMENT

- CONCRETE 28 DAYS COMPRESSIVE STRENGTH TO BE 3500 PSI MINIMUM (4,000 PSI FOR EXTERIOR CONCRETE).
- NOMINAL COARSE AGGREGATE SIZE SHALL NOT EXCEED 3/4" U.N.O..
- STEEL REINFORCING IN CONCRETE TO BE ASTM A615 GRADE 60.
- WELDED WIRE FABRIC TO BE ASTM A185 WITH ULTIMATE TENSILE STRENGTH OF 70,000 PSI.
- OVERLAP STEEL REINFORCING BARS BY 24" TYP. RETURN BARS BY 1'-0" MIN. AROUND CORNERS.
- MINIMUM LAP OF WELDED WIRE FABRIC SHALL BE 6" OR ONE FULL MESH, WHICHEVER IS GREATER, AND SHALL BE WIRED TOGETHER.
- PROVIDE CLEAR COVERAGE OF OUTER REINFORCEMENT AS FOLLOWS:
LOCATION IN STRUCTURE CLEAR COVERAGE
SURFACE CAST AGAINST AND PERMANENTLY IN CONTACT WITH EARTH.....3"
FORMED SURFACES EXPOSED TO EARTH OR WEATHER
#5 BAR OR SMALLER.....1/2"
#6 BAR TO #18 BAR.....2"
FORMED SLABS, WALLS AND JOISTS NOT EXPOSED TO EARTH OR WEATHER.....3/4" **
**MAX COARSE AGGREGATE SIZE FOR 3/4" COVER IS 3/8" NOMINAL DIAMETER
FORMED BEAMS AND COLUMNS NOT EXTERIOR SLABS AND EQUIPMENT PADS.....1/2"
- THE MINIMUM CLEAR SPACING BETWEEN PARALLEL REINF. BARS IN A LAYER SHALL BE EQUAL TO THE BAR DIAMETER, BUT NOT LESS THAN ONE INCH.
- CAST IN PLACE OPENING, POCKETS, ETC. LARGER THAN 6" SHALL NOT BE PLACED IN CONCRETE SLABS, DECKS, OR WALLS UNLESS SPECIFICALLY DETAILED ON THE STRUCTURAL DRAWINGS. NOTIFY THE STRUCTURAL ENGINEER WHEN DRAWINGS BY OTHERS SHOW OPENINGS, POCKETS, ETC. LARGER THAN 6" WHICH ARE NOT SHOWN ON THE STRUCTURAL DRAWINGS, BUT WHICH ARE LOCATED IN STRUCTURAL MEMBERS.
- CAST IN PLACE STRUCTURAL CONCRETE SHALL NOT BE CUT OR CORED WITHOUT PRIOR APPROVAL OF THE ENGINEER.
- ALL REINFORCEMENT SHALL BE DETAILED IN ACCORDANCE WITH THE LATEST EDITION OF THE ACI 315 DETAILING MANUAL.
- ALL REINFORCING STEEL SHALL BE SECURELY HELD IN PROPER POSITION WHILE POURING CONCRETE. IF REQUIRED, ADDITIONAL BARS AND STIRRUPS SHALL BE PROVIDED BY THE CONTRACTOR TO FURNISH SUPPORT TO THE REINFORCING STEEL.
- CONTRACTOR SHALL SUBMIT REBAR SHOP DRAWINGS AND CONCRETE MIX DESIGN FOR ENGINEER'S APPROVAL. SHOP DRAWINGS SHALL SHOW EXTENTS OF CONCRETE AS WELL AS REBAR PLACEMENT.
- NO CONCRETE SHALL BE POURED UNTIL ALL REINFORCEMENT AND INSTALLATIONS HAVE BEEN INSPECTED AND APPROVED BY THE OWNER'S TESTING AGENCY. THE CONTRACTOR SHALL NOTIFY THE OWNER'S TESTING AGENCY 48 HOURS BEFORE POURING CONCRETE TO ALLOW FOR ALL NECESSARY INSPECTIONS.
- NO PIPES OR CONDUIT SHALL BE EMBEDDED IN THE STRUCTURAL CONCRETE FLOOR SLABS WITHOUT APPROVAL OF STRUCTURAL ENGINEER.
- PROVIDE VAPOR BARRIER UNDER INTERIOR GROUND LEVEL SLABS.
- ALL CONCRETE EXPOSED TO THE WEATHER SHALL BE AIR ENTRAINED. PROVIDE AIR CONTENT OF 4% TO 7%.

STRUCTURAL STEEL

- STRUCTURAL STEEL SHAPES SHALL CONFORM TO THE FOLLOWING GRADES:
ROLLED SHAPES.....ASTM A992 GRADE 50
PLATES AND BARS.....ASTM A36
RECT HSS.....ASTM A500 OR B-48KSI
ROUND HSS.....ASTM A500 OR B-42KSI
STEEL PIPE.....ASTM A53 TYPE S GRADE B
- STEEL CONNECTION BOLTS TO BE ASTM A325. ANCHOR BOLTS TO BE ASTM F1554. WELDED STEEL CONNECTIONS TO BE MINIMUM 3/16" CONTINUOUS FILLET WELD, UNLESS LARGER WELDS ARE REQUIRED.
- SHOP DRAWINGS SHALL BE SUBMITTED FOR ENGINEER'S REVIEW AND APPROVAL.
- BOLT HOLES IN STEEL TO BE 1/16" LARGER IN DIAMETER THAN THE NOMINAL SIZE OF BOLTS USED.
- BOLTED CONNECTIONS SHALL BE AS FOLLOWS:
A. MIN (2) 3/8" INCH DIAMETER BOLTS WITH STANDARD OR HORIZONTAL SHORT SLOTTED HOLES IN WEBS OF BEAMS.
B. BOLTS AT MOMENT CONNECTIONS SHALL BE PREPARED AND INSTALLED FOR SLIP CRITICAL SERVICE.
C. SIMPLE SHEAR CONNECTIONS SHALL BE EITHER SLIP CRITICAL OR BEARING TYPE HIGH STRENGTH BOLTS (ASSUME TYPE N BOLTS FOR ALLOWABLE VALUES).
- SIMPLY SUPPORTED BEAM CONNECTIONS, UNLESS SHOWN ON PLAN OR NOTED OTHERWISE, SHALL PROVIDE CONNECTION CAPACITY EQUAL TO 1/2 OF THE TOTAL UNIFORM LOAD CAPACITY OF THE BEAM BASED ON SHAPE, SPAN, AND GRADE OF STEEL, PER "ALLOWABLE LOADS ON BEAMS" PART 2, ASD MANUAL OF STEEL CONSTRUCTION, 13TH ED. ADD FULL REACTIONS OF SUPPORTED BEAMS FRAMING IN WITHIN L/10 OF CONNECTIONS.
- PROVIDE MINIMUM 3/4" THICK BASE PLATE WITH 4-3/8" NUT AND WASHER TYPE ANCHOR BOLTS FOR COLUMNS. U.N.O. EMBED ANCHOR BOLTS 12" MINIMUM IN CONCRETE.
- WHERE STEEL COLUMNS ARE WITHIN STUD WALLS, ANCHOR STUDS TO STEEL USING A MINIMUM OF (2) HILTI X-U POWDER ACTUATED FASTENERS @ 8 INCHES O.C., UNO.
- WHERE PENETRATIONS THROUGH STEEL BEAMS ARE NECESSARY, LOCATIONS AND SIZES OF PROPOSED PENETRATIONS SHALL BE MARKED ON PLAN AND SUBMITTED TO ENGINEER FOR REVIEW. WRITTEN APPROVAL OF ENGINEER IS REQUIRED PRIOR TO CUTTING OR MODIFYING STEEL BEAMS.

PRESSURE PRESERVATIVE TREATED (P.T.) WOOD

- ALL P.T. LUMBER SHALL BE SOUTHERN PINE NO. 2 OR BETTER.
- ALL P.T. LUMBER SHALL BE UNKILNED.
- ALL WOOD IN CONTACT WITH THE GROUND, OR CONCRETE, OR EXPOSED TO THE WEATHER, SHALL BE PRESSURE-PRESERVATIVE TREATED AND SUITABLE FOR EXTERIOR USE AND GROUND CONTACT IN ACCORDANCE WITH ANPA STANDARDS, UNO.
- FIELD-CUT ENDS, NOTCHES, AND DRILLED HOLES OF PRESERVATIVE-TREATED WOOD SHALL BE TREATED IN THE FIELD WITH COMPATIBLE PRESERVATIVE IN ACCORDANCE WITH ANPA M4.
- ALL HARDWARE AND STEEL CONNECTORS USED IN CONTACT WITH P.T. LUMBER SHALL BE HOT-DIP GALVANIZED, STAINLESS STEEL, OR OTHERWISE NOTED BY THE MANUFACTURER AS APPROVED FOR EXTERIOR USE AND FOR CONTACT WITH ALL P.T. LUMBER PRESERVATIVES. CARE SHALL BE TAKEN NOT TO MIX GALVANIZED MILD STEEL WITH STAINLESS STEEL IN CONNECTIONS.

WOOD & ENGINEERED WOOD CONSTRUCTION

- DIMENSIONAL LUMBER TO BE SPRUCE-PINE-FIR (SPF) NO. 2 OR BETTER UNO.
- ALL ENGINEERED LUMBER SHALL BE INSTALLED PER MANUFACTURER'S SPECIFICATIONS.
- ALTERNATE PRODUCTS SHALL NOT BE SUBSTITUTED UNLESS APPROVED IN WRITING BY ENGINEER OF RECORD.
- LVL'S (LAMINATED VENEER LUMBER) TO BE 1.9E MICROLAM LVL BY ILEVEL.
- PSL'S (PARALLEL STRAND LUMBER) TO BE 2.0E PARALLAM PSL BY ILEVEL.
- 1 3/4" LSL'S (LAMINATED STRAND LUMBER) TO BE 1.55E TIMBERSTRAND LSL BY ILEVEL.
- 1 1/2" LSL'S TO BE 1.5E TIMBERSTRAND LSL BY ILEVEL.
- WOOD I-JOISTS TO BE TJI 230 BY ILEVEL.
- PROVIDE SIMPSON CONNECTORS AT POST/BEAM, POST BASE, JOIST/BEAM AND BEAM/BEAM CONNECTIONS. USAGE AND INSTALLATION TO BE IN ACCORDANCE WITH MANUFACTURER'S INSTRUCTIONS. PROVIDE SIMPSON HURRICANE TIES AT ROOF RAFTER CONNECTIONS TO STUD WALL CONNECTIONS OR SUPPORTING BEAMS.
- PROVIDE MINIMUM 3/4" PLYWOOD SHEATHING FOR FLOORS AND ROOFS. PLYWOOD TO BE APA-RATED EXPOSURE 1 GRADE C-D (CDX) OR APPROVED EQUAL. PROVIDE 1/2" SPACE BETWEEN EDGES OF ADJACENT PLYWOOD PANELS AND STAGGER PANEL JOINTS BETWEEN ROWS OF SHEATHING.
- ALL PLYWOOD FLOOR AND ROOF SHEATHING SHALL BE GLUED AND SCREWED TO SUPPORTING WOOD FRAMING. GLUE SHALL CONSIST OF CONSTRUCTION GRADE ADHESIVE. SCREWS NOT TO BE PLACED WITHIN 3/8" OF PANEL EDGES. MAXIMUM SCREW SPACING TO BE 6", UNO. SCREWS TO BE MIN #8-3/4" LONG. SCREW LENGTH SHALL BE SUFFICIENT TO PROVIDE EMBEDMENT OF 10X SCREW DIA INTO FRAMING.
- FOR JOIST SPANS UP TO 14'-0", PROVIDE A SINGLE ROW OF FULL DEPTH BLOCKING BETWEEN JOISTS AT MIDSPAN. FOR SPANS EXCEEDING 14'-0", PROVIDE TWO ROWS OF FULL DEPTH BLOCKING BETWEEN JOISTS AT THIRD POINTS OF THE SPAN.
- IN ADDITION TO THE FLOOR JOISTS SHOWN ON THE PLANS, CONTRACTOR SHALL INSTALL DOUBLE JOISTS UNDER ALL PARTITION WALLS RUNNING PARALLEL TO THE DIRECTION OF FRAMING.
- PROVIDE MINIMUM 1/2" PLYWOOD SHEATHING FOR EXTERIOR WALLS AND SHEAR WALLS. FASTEN SHEATHING TO STUDS WITH MINIMUM #3 NAILS @ 4" O.C.
- PROVIDE CONTINUOUS BLOCKING ABOVE INTERIOR SHEAR WALLS.
- MAXIMUM MOISTURE CONTENT OF DIMENSIONAL LUMBER AT TIME OF INSTALLATION TO BE 19%.
- SILL PLATE ANCHOR BOLTS: PROVIDE 1/2" ANCHOR BOLTS AT 3'-0" O.C. TWO BOLTS MINIMUM PER SILL PIECE WITH A BOLT WITHIN 10" OF EACH END OF EACH PIECE. BOLT SPACING SHALL BE COORDINATED PRIOR TO PLACING OF STUDS AND POSTS TO AVOID CONFLICTS. ALL BOLTS SHALL HAVE STEEL WASHERS. SEE TYPICAL DETAILS AND SHEAR WALL SCHEDULE FOR ADDITIONAL SILL BOLT REQUIREMENTS.
- PROVIDE PERPENDICULAR BLOCKING AT 32 INCHES O.C. BETWEEN ALL PERIMETER JOISTS AND EXTERIOR WALLS OR PERIMETER BEAMS.
- STAND-ALONE WOOD POSTS OVER CONCRETE SHALL BEAR UPON SIMPSON POST BASE EMBEDDED IN OR ANCHORED TO CONCRETE FOUNDATION.
- WASHERS SHALL ALWAYS BE INSTALLED BETWEEN BOLT HEADS OR NUTS AND WOOD OR ENGINEERED WOOD.

ABBREVIATION LIST

ASTM	AMERICAN SOCIETY FOR TESTING AND MATERIALS	MAX MECH	MAXIMUM MECHANICAL
BOTTOM		MEZZ	MEZZANINE
B or BOT	BOTTOM EACH WAY	MFR	MANUFACTURER
BEM	BEAM	MID	MIDDLE
BM	BOTH SIDES	MP	MEASUREMENT
BS		MIN	MINIMUM
CANT	CANTILEVER	NF	NEAR FACE
CJ	CONTROL JOINTS	NIC	NOT IN CONTRACT
CL	CENTERLINE	NO or #	NUMBER
CL	CLEAR	NIS	NOT TO SCALE
CL	CONCRETE MASONRY UNIT	NWC	NORMAL WEIGHT CONCRETE
CMU	CLEAN OUT	OC or O/C	ON CENTER
CO	COLUMN	OD	OUTSIDE DIAMETER
COL	CONCRETE	OF	OUTSIDE FACE
CONC	CONNECTION	OH	OPPOSITE HAND
CONV	CONSTRUCTION JOINT	OPNG	OPENING
CONST	CONTINUOUS	OPP	OPPOSITE
CONT	DEPTH	P/C	PRE-CAST
D	DIAMETER	PC	PILE CAP
DIA or #	DIMENSION	PCI	PRECAST CONCRETE INSTITUTE
DM	DIRECTION	PCN	PENETRATION
DIR	DRAWING	PL	PLATE
DWG	DOWELS	PSF	POUNDS/SQUARE FOOT
DWLS		PSI	POUNDS/SQUARE INCH
EA	EACH END	PT	PRESSURE-TREATED
EE	EACH FACE	PVC	POLYVINYL CHLORIDE
EF	ELEVATION	R or RAD	RADIUS
EL or ELEV	EQUAL	RD	ROOF DRAIN
EQ	EACH SIDE	REF	REFERENCE
ES	EACH WAY	REINF	REINFORCE or REINFORCEMENT/NG
EW	EXISTING	REQD	REQUIRED
EXIST	EXPANSION BOLT	RET	RETURN
EXP BOLT	EXPANSION JOINT	REV	REVISION
EXT	EXTERIOR	SAD	SEE ARCHITECTS DRAWINGS
EXT	FLOOR DRAIN	SC	SLIP CRITICAL
FD	FAR FACE	SCHED	SCHEDULE
FF	FINISH	SECT	SECTION
FIN	FINISHED FLOOR	SF	STEP FOOTING
FIN FL	FLOOR	SM	SIMILAR
FL	FOUNDATION	SOG	SLAB ON GROUND / GRADE
FND	FULL PENETRATION	SPECS	SPECIFICATIONS
FP	FAR SIDE	SS	STAINLESS STEEL
FS	FOOTING	STD	STANDARD
FTG	GAUSE	STIFF	STIFFENER
GA	GALVANIZED	STL	STEEL
GALV	GRADE BEAM	STR	STRUCTURAL
GB	GROUND	T	TOP
GR	GRADE	TB	THE BEAM
GR	GUSSET PLATE	TEMP	TEMPORARY
GUS PL	HORIZONTAL	THK	THICK or THICKNESS
H or HORIZ	HORIZONTAL EACH FACE	THRD	THREADED
HEF	HORIZONTAL INSIDE FACE	T/SLAB	TOP OF SLAB
HIF	HORIZONTAL OUTSIDE FACE	TOS or T/CONC	TOP OF CONCRETE
HOF	HIGH POINT	TOS or T/ST	TOP OF STEEL
HP	HIGH STRENGTH BOLT	TOW or T/W	TOP OF WALL
HSB	HEIGHT	TYP	TYPICAL
HT	INSIDE DIAMETER	UL	UPPER LAYER
ID	INSIDE FACE	UNO	UNLESS NOTED OTHERWISE
IF	INTERIOR	V or VERT	VERTICAL
INT	INVERT	VEF	VERTICAL EACH FACE
INV	JOIST	VF	VERTICAL IN FIELD
JST	JOINT	VOF	VERTICAL OUTSIDE FACE
JT	KIP (1000 POUNDS)	W/	WITH
K	LOWER LAYER	W/O	WITHOUT
LL	LONG LEG HORIZONTAL	WP	WORKING POINT
LLH	LONG LEG VERTICAL	WWF	WELDED WIRE FABRIC
LLV	LOCATION		
LOC	LOW POINT		
LP	LIGHTWEIGHT		

REVISION HISTORY


NO.	DESCRIPTION	DATE
-----	-------------	------

CONSTRUCTION DOCUMENTS


DATE: AUG 16, 2023
SCALE: As Indicated
DRAWN BY: EAC
CHECKED BY: BW
SHEET TITLE: PROJECT # 40305

GENERAL NOTES


\$0.00

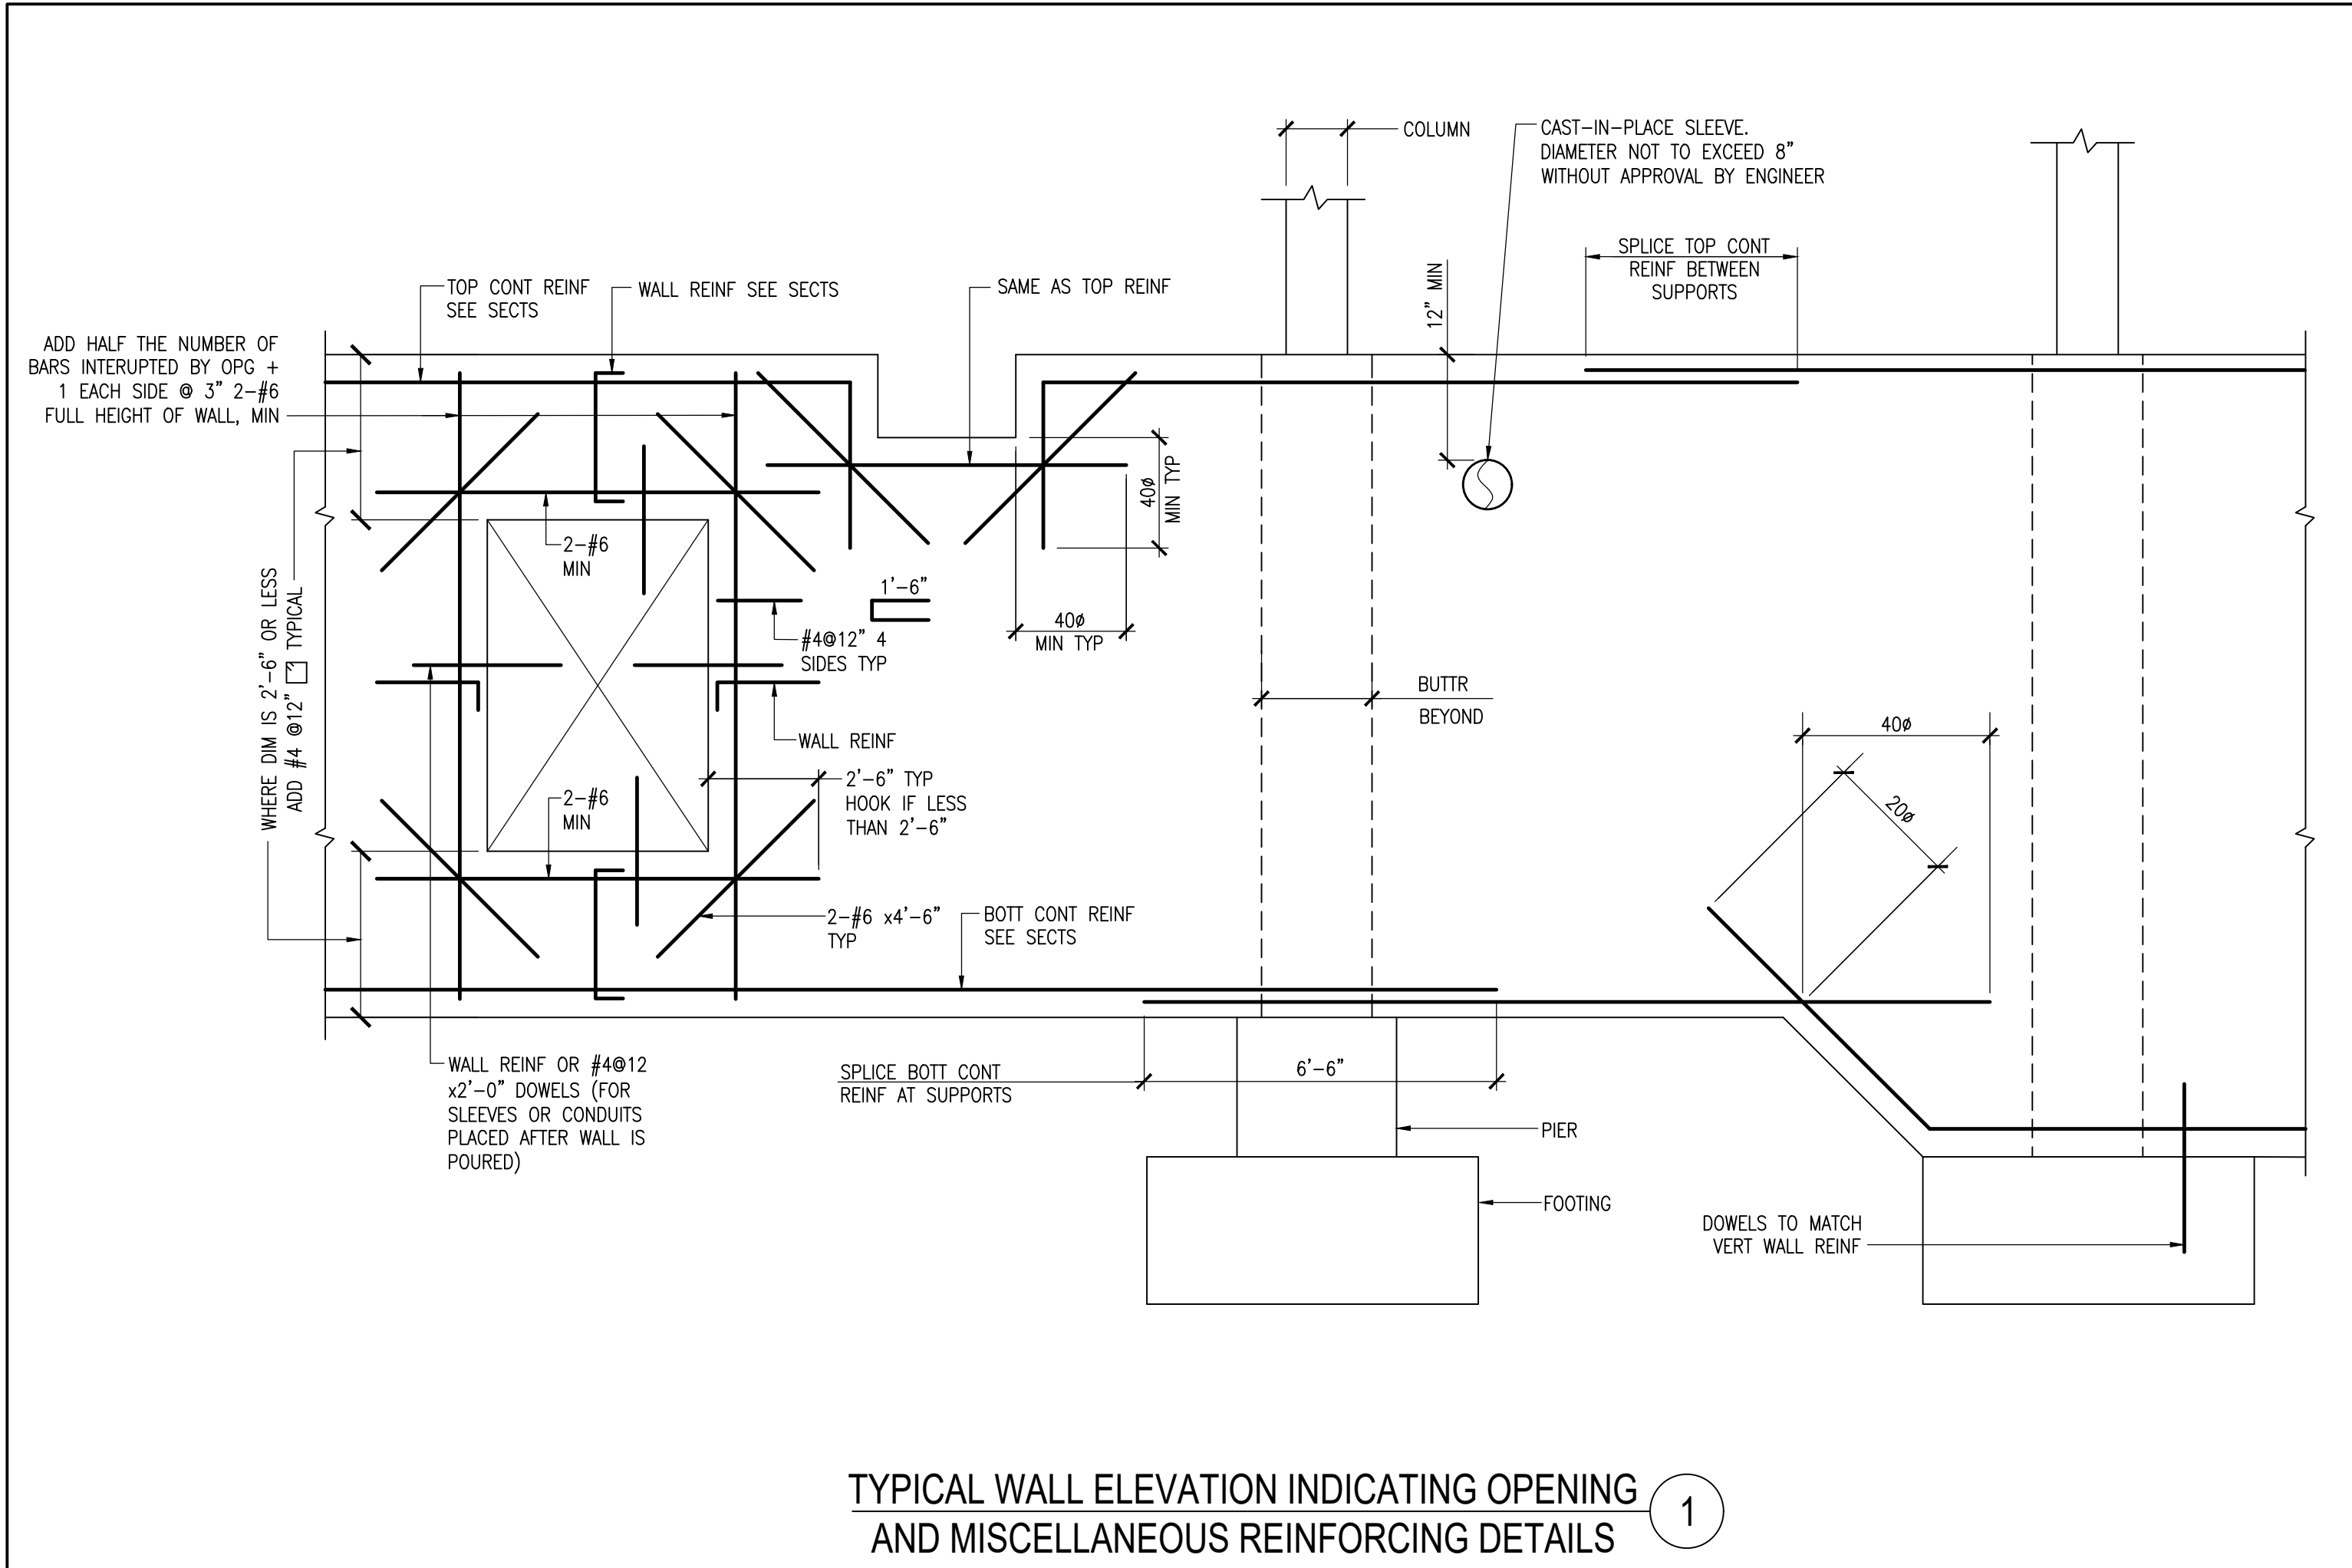


TYPICAL WALL ELEVATION INDICATING OPENING AND MISCELLANEOUS REINFORCING DETAILS 1

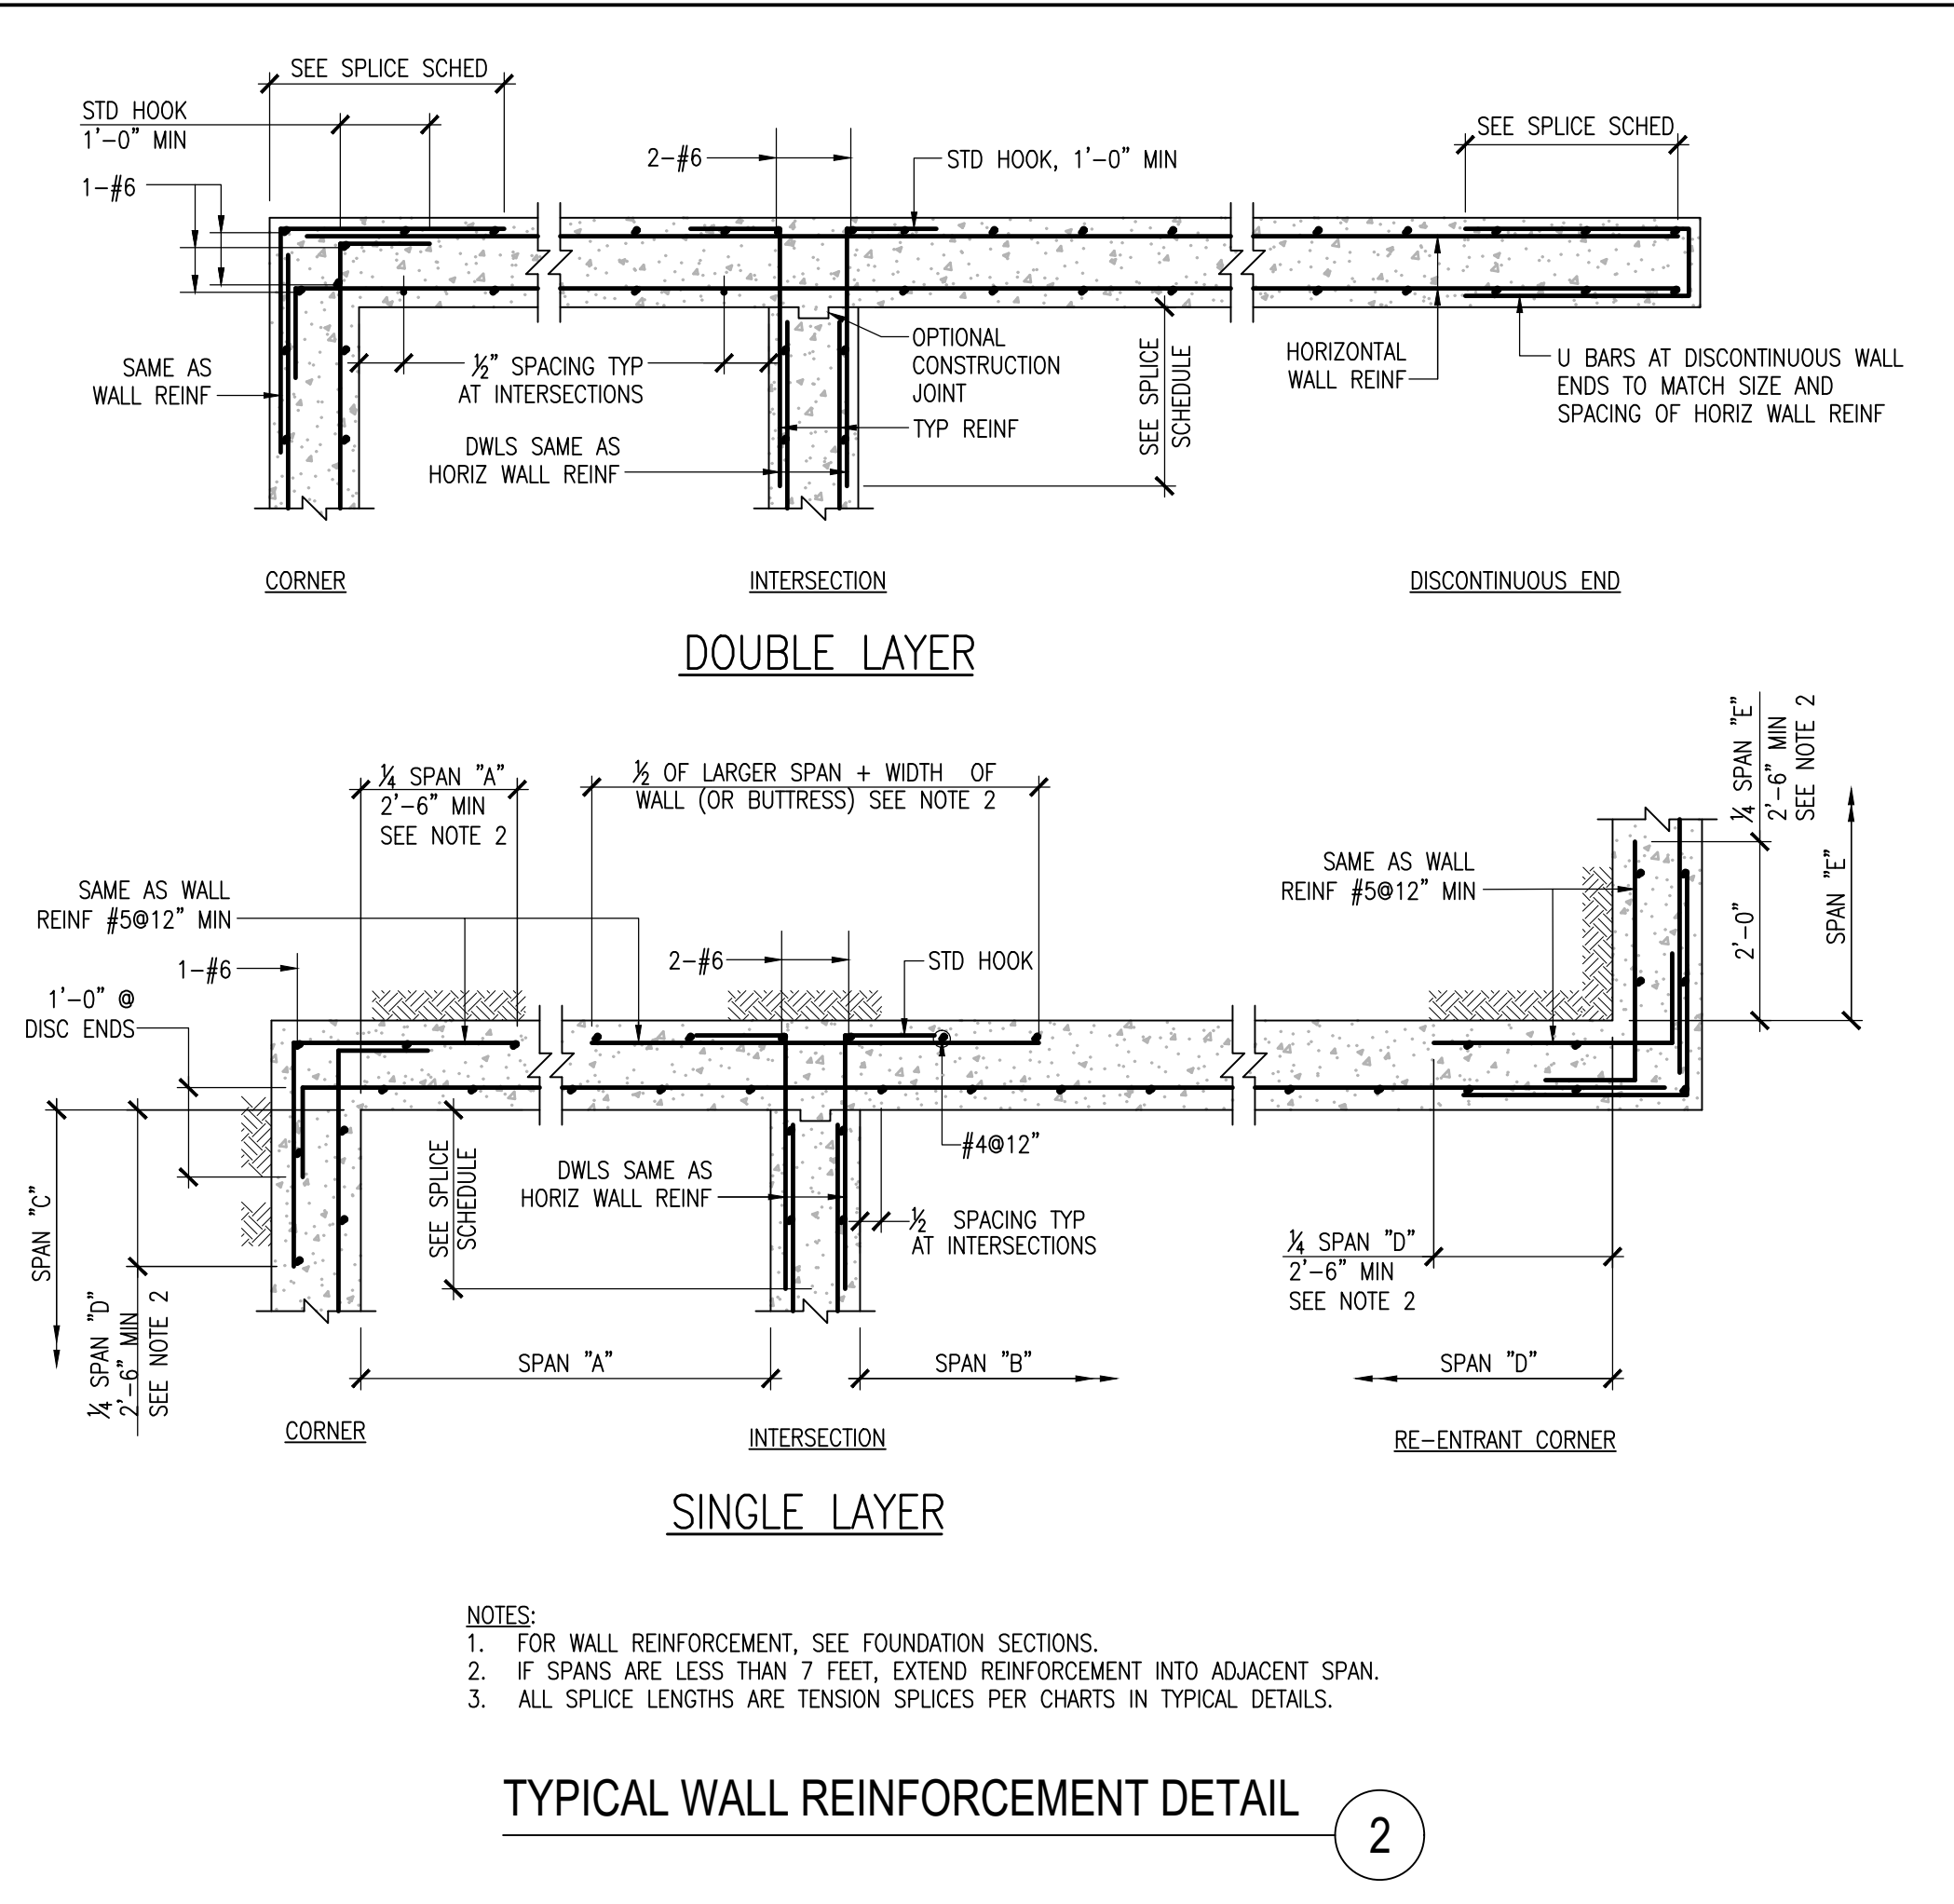


TYPICAL WALL REINFORCEMENT DETAIL 2

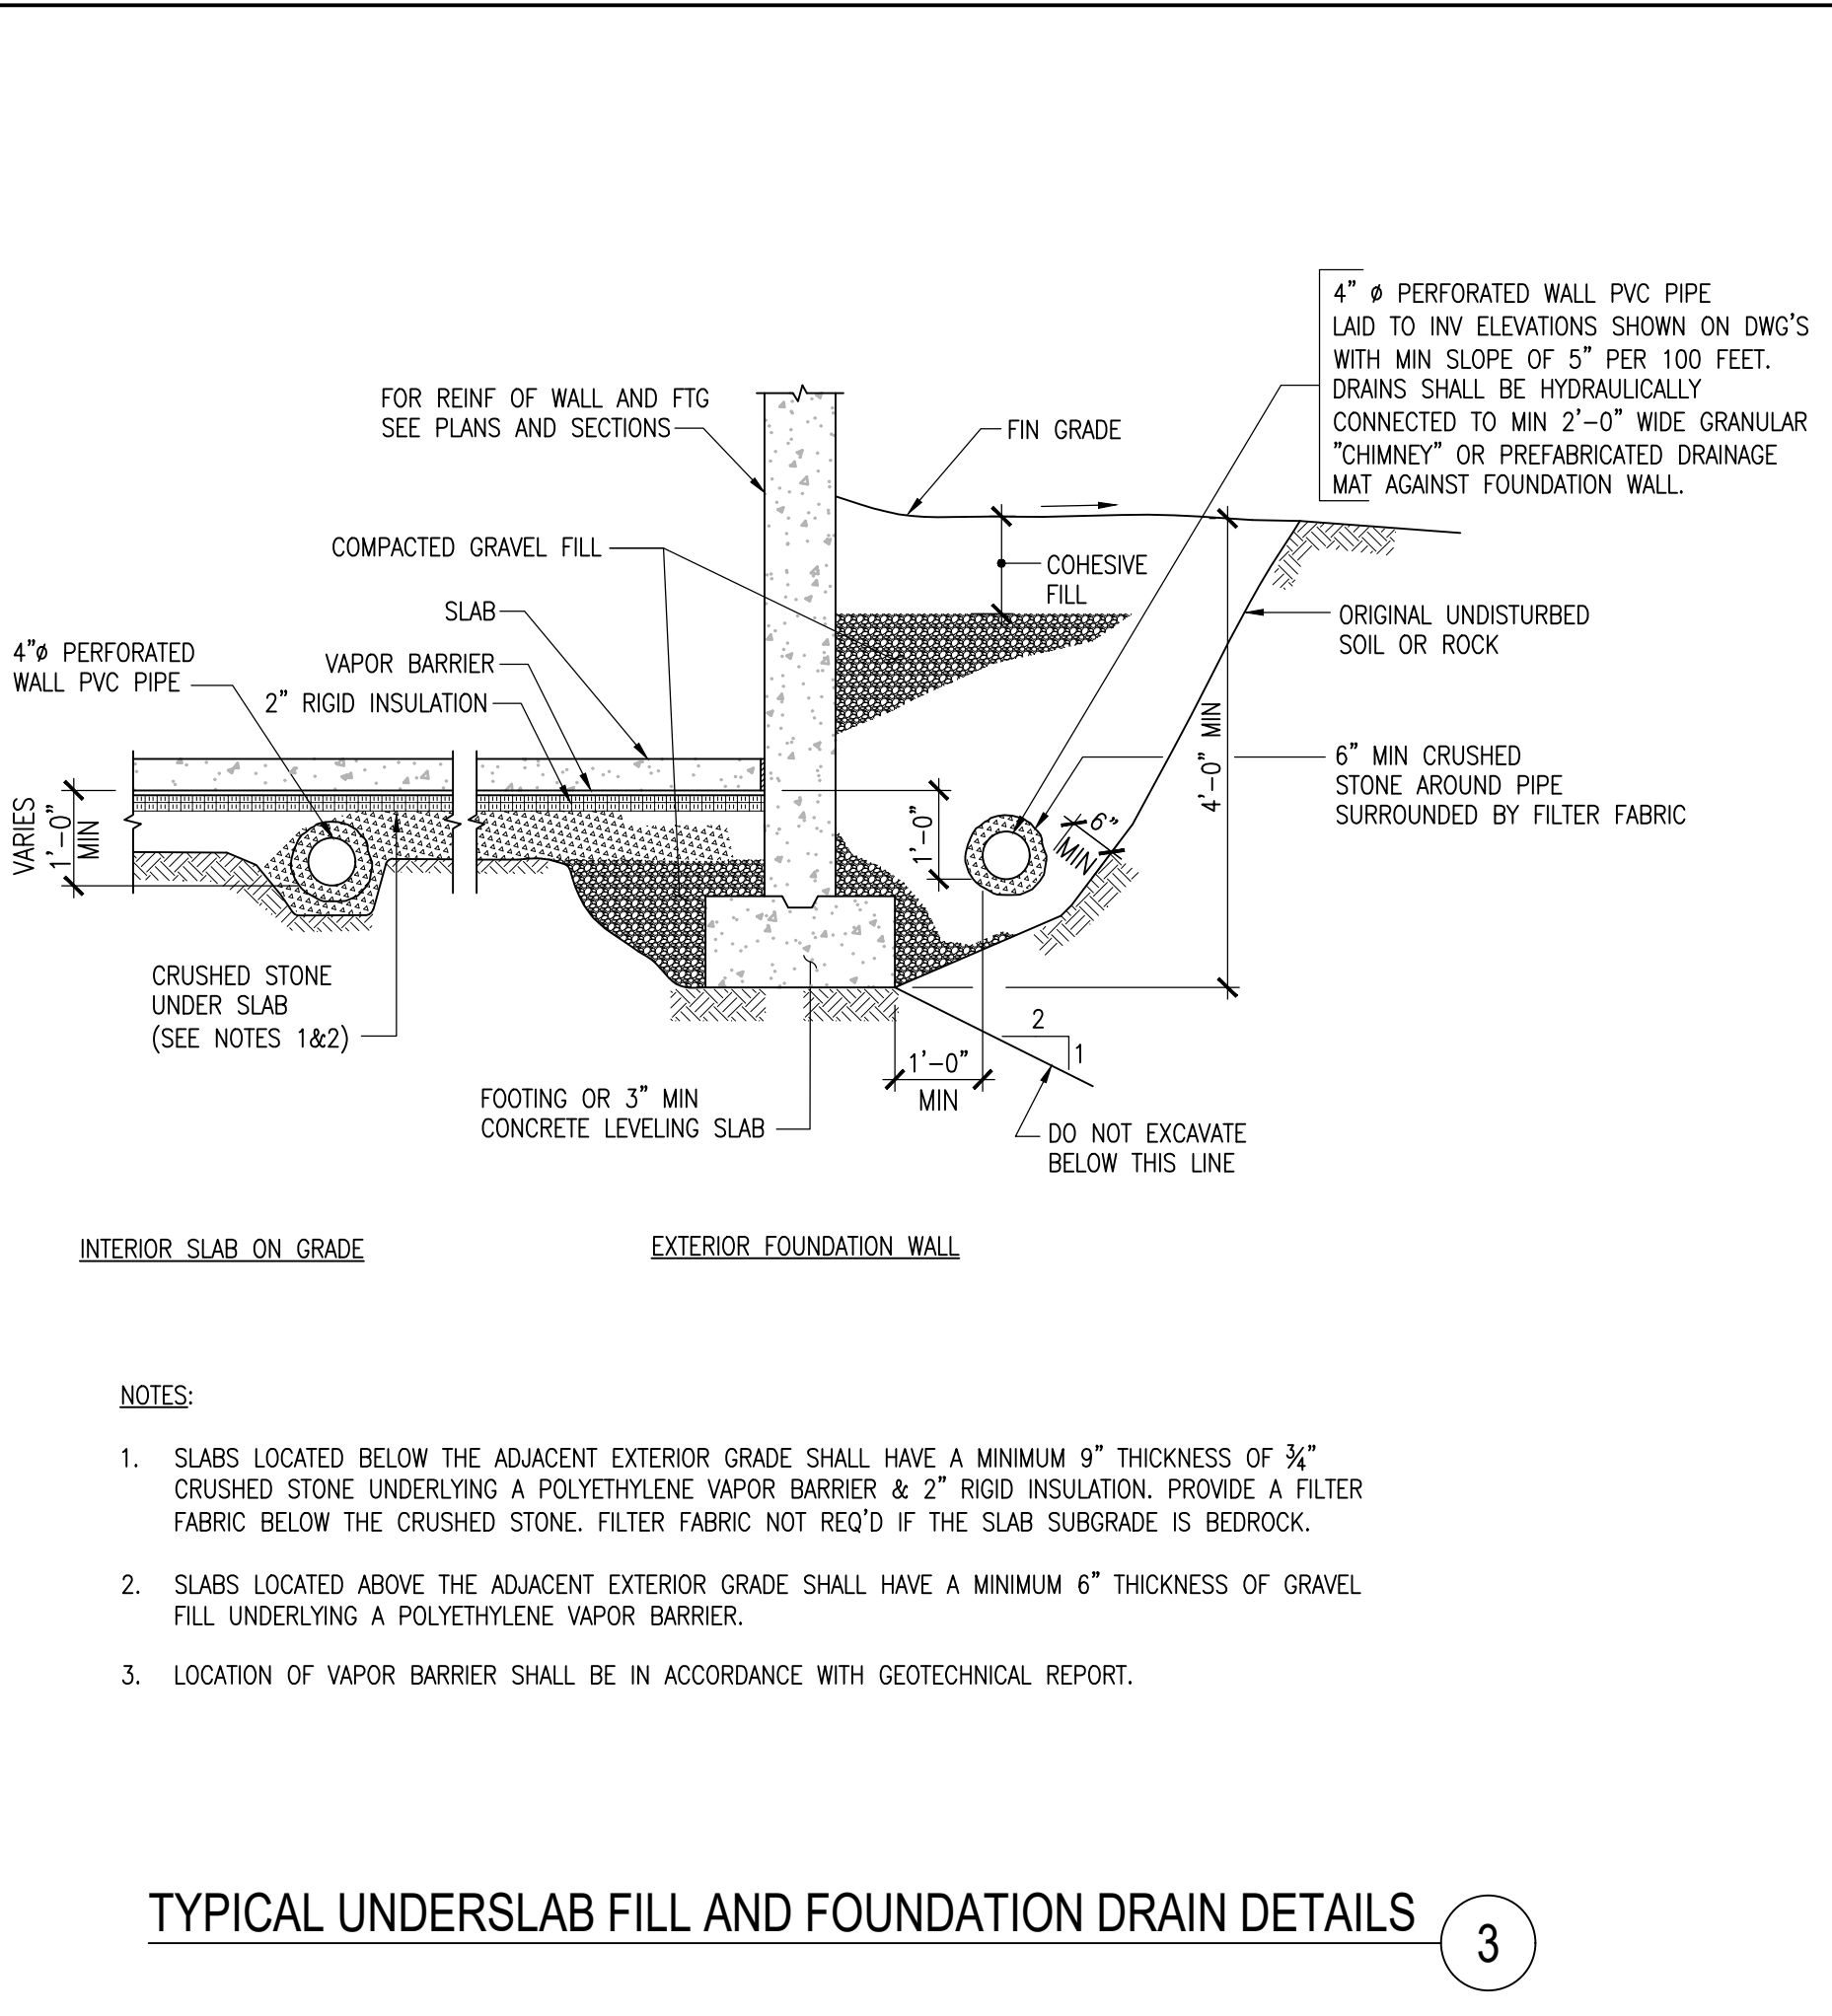


TYPICAL UNDERSLAB FILL AND FOUNDATION DRAIN DETAILS 3

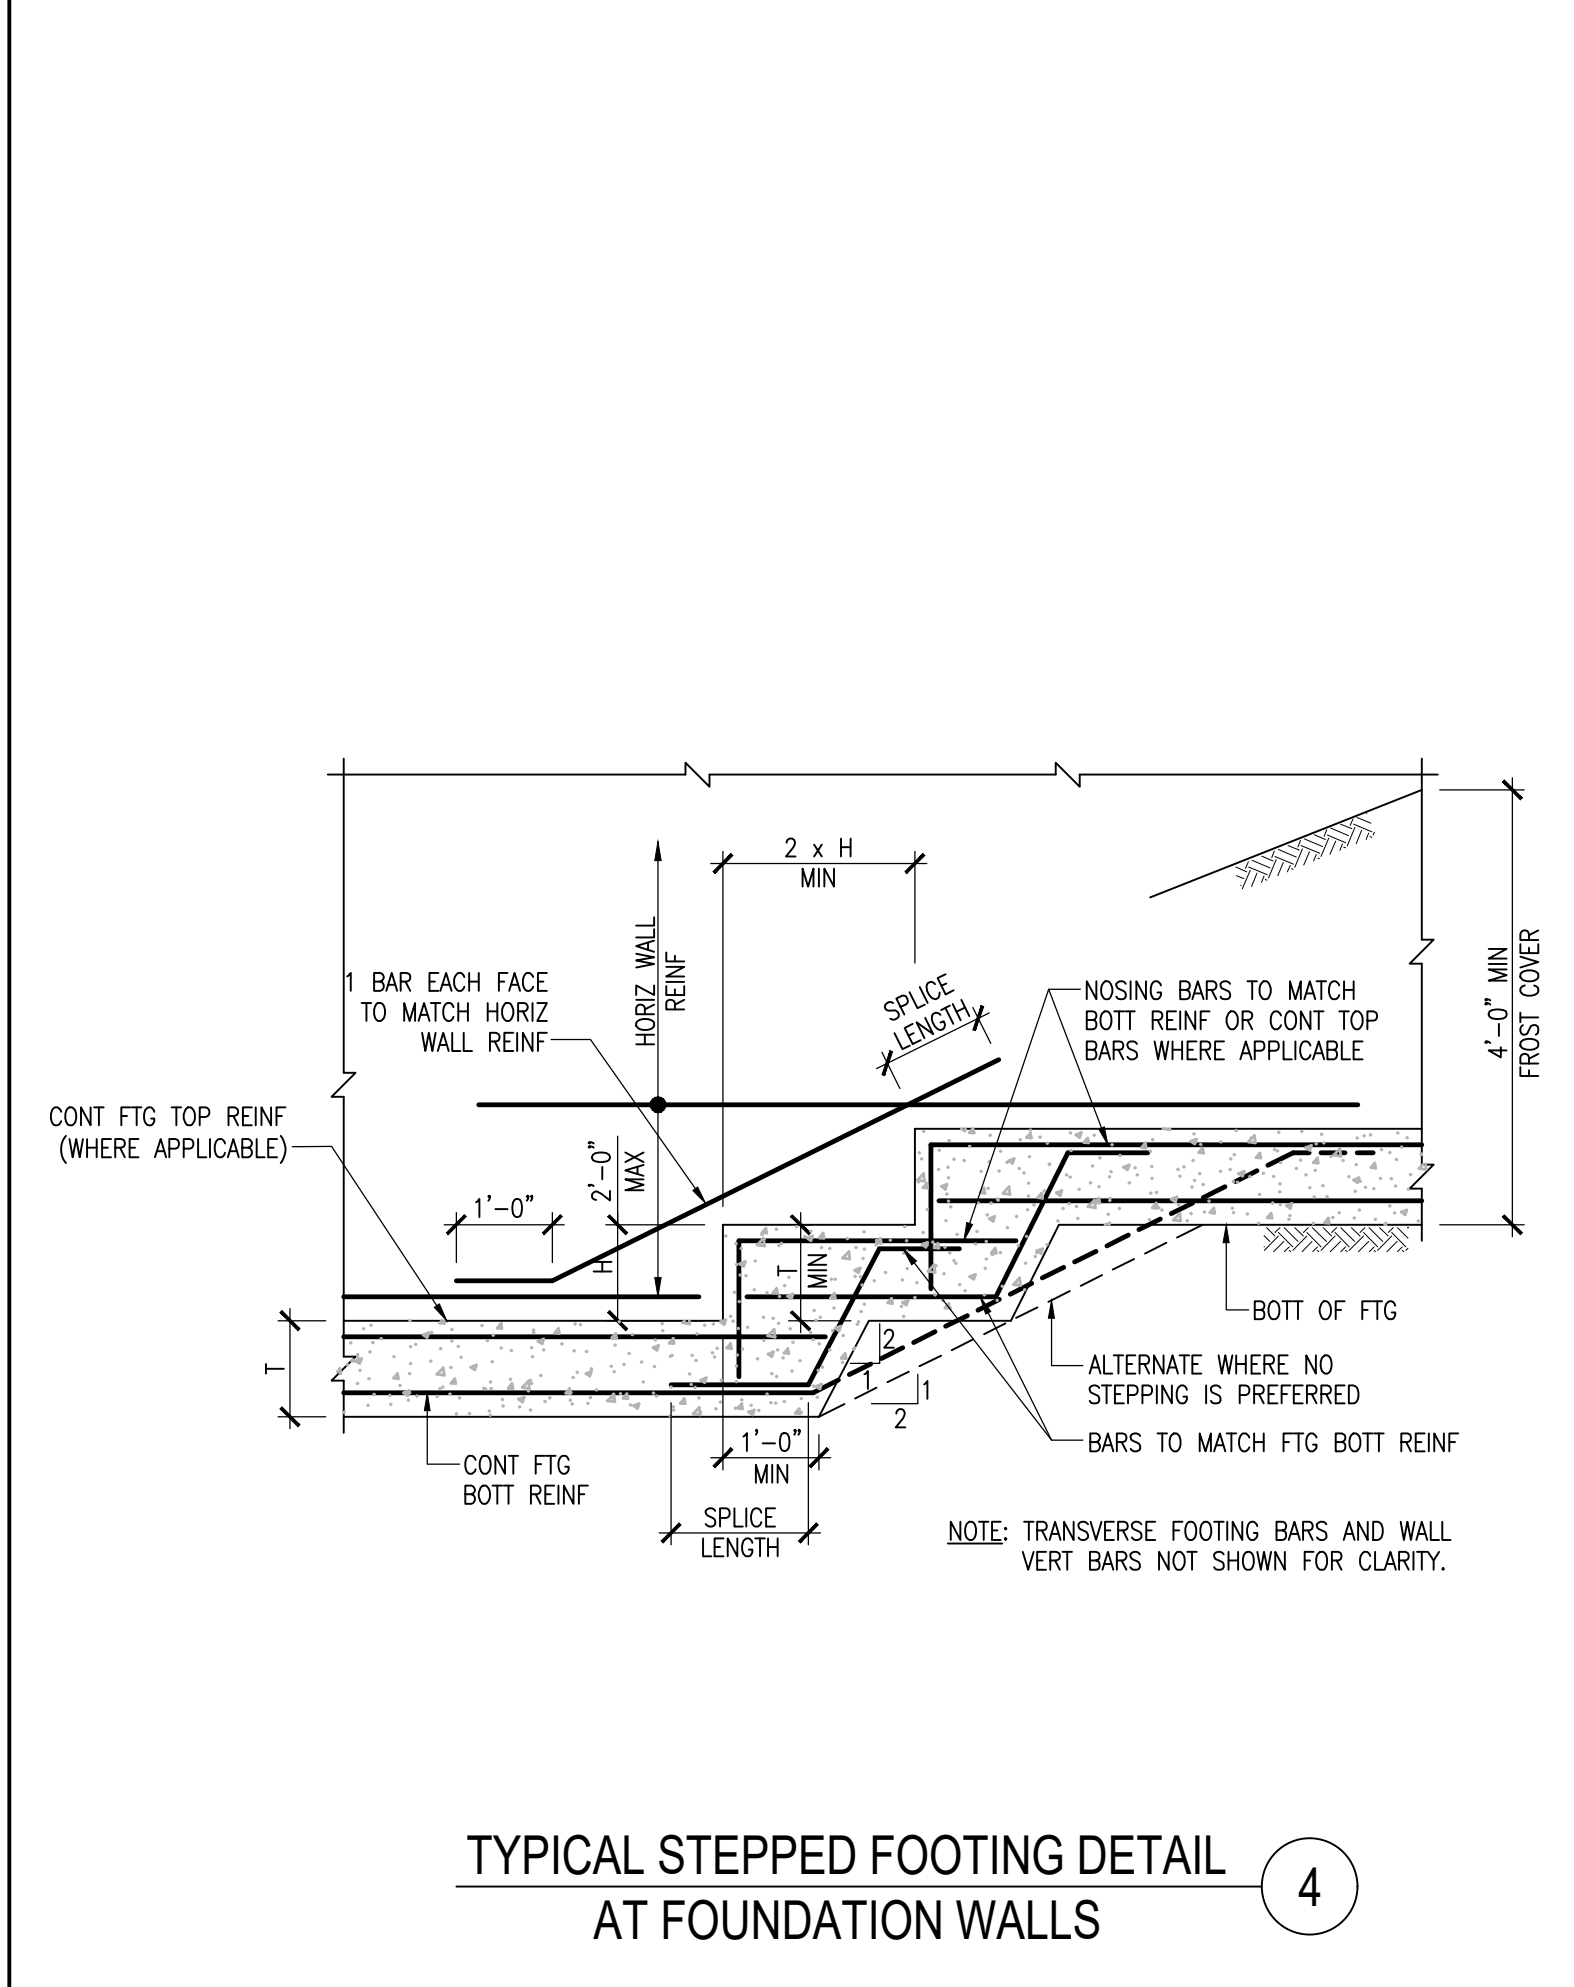


TYPICAL STEPPED FOOTING DETAIL AT FOUNDATION WALLS 4

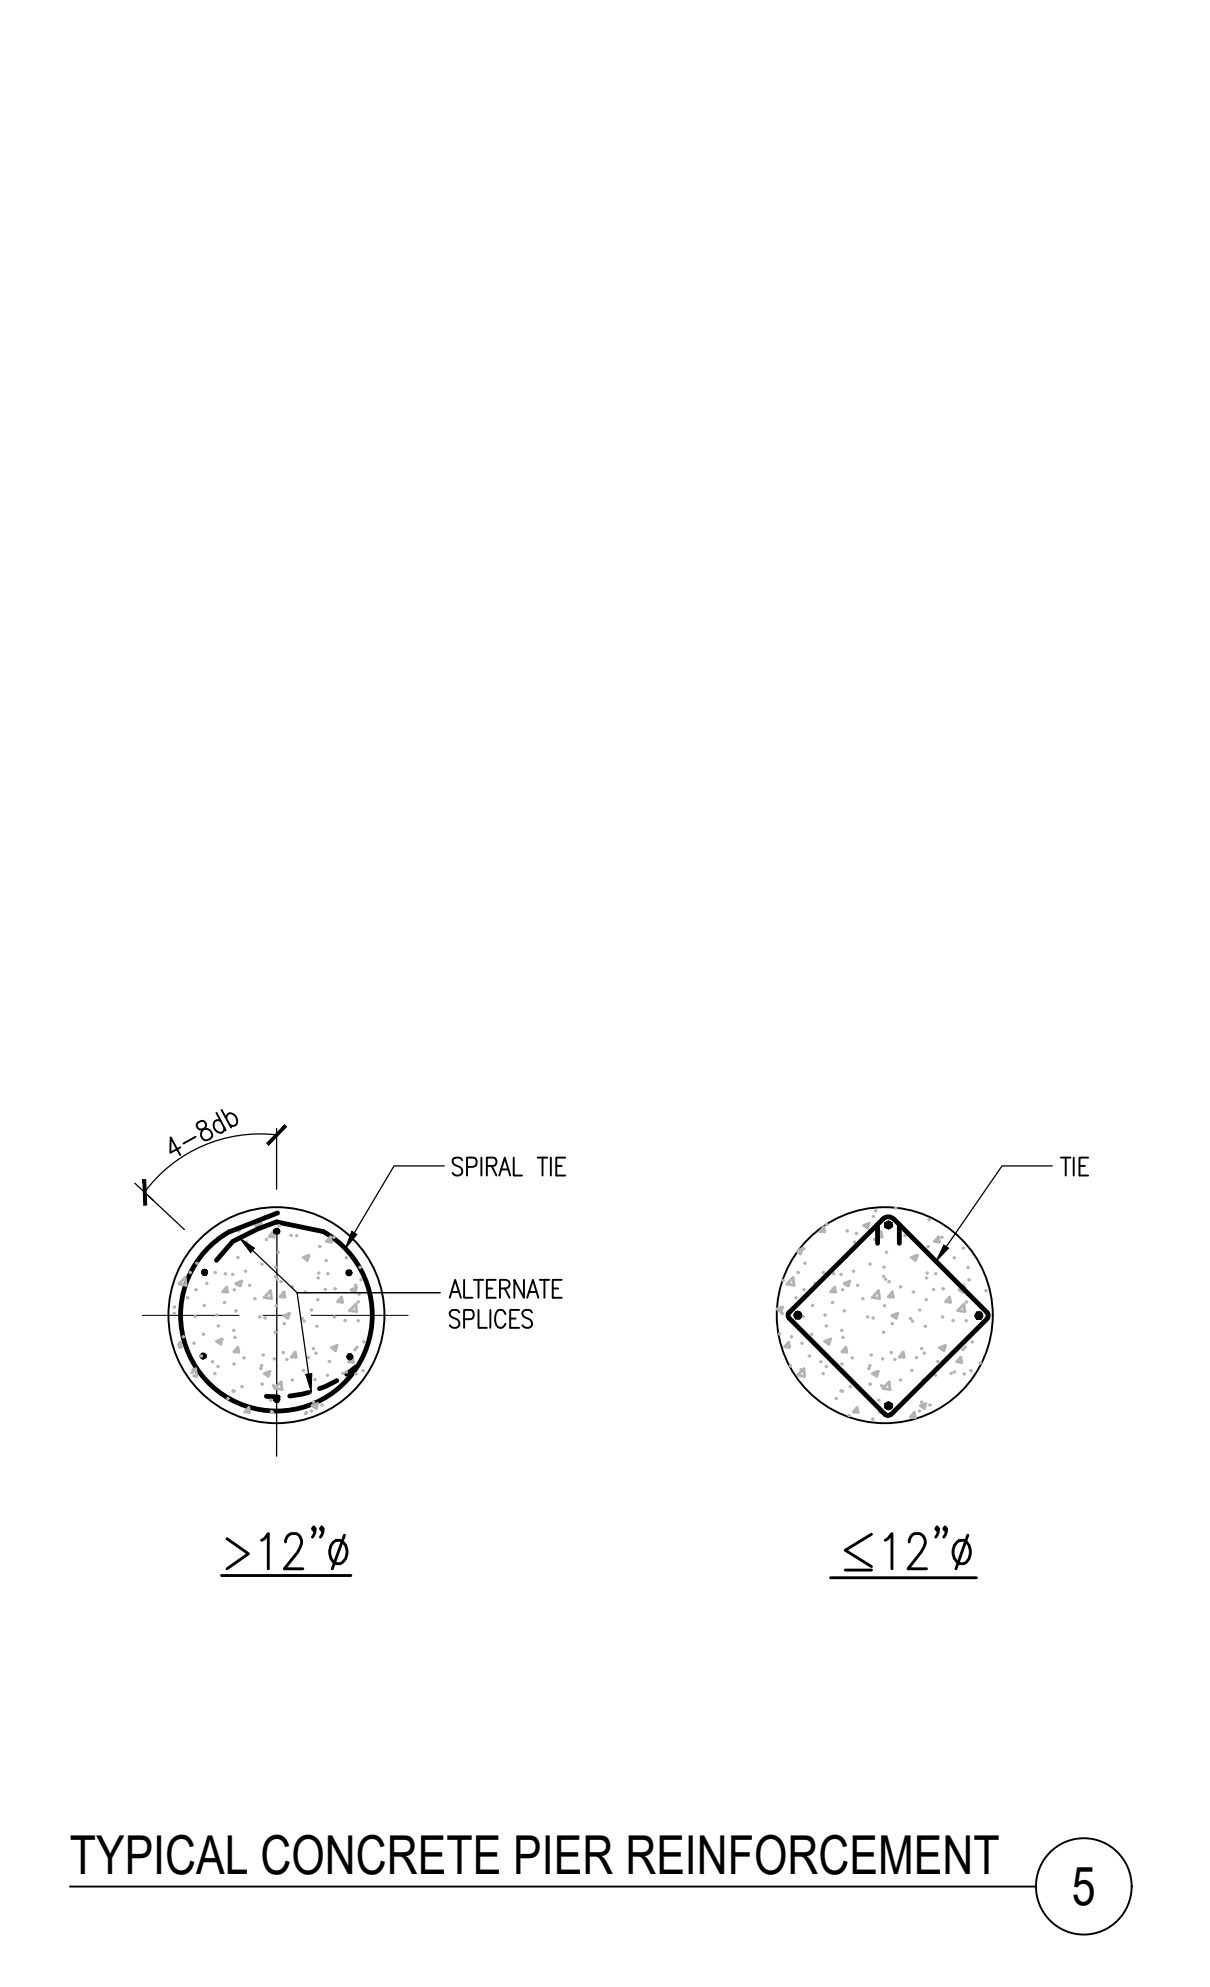


TYPICAL CONCRETE PIER REINFORCEMENT 5

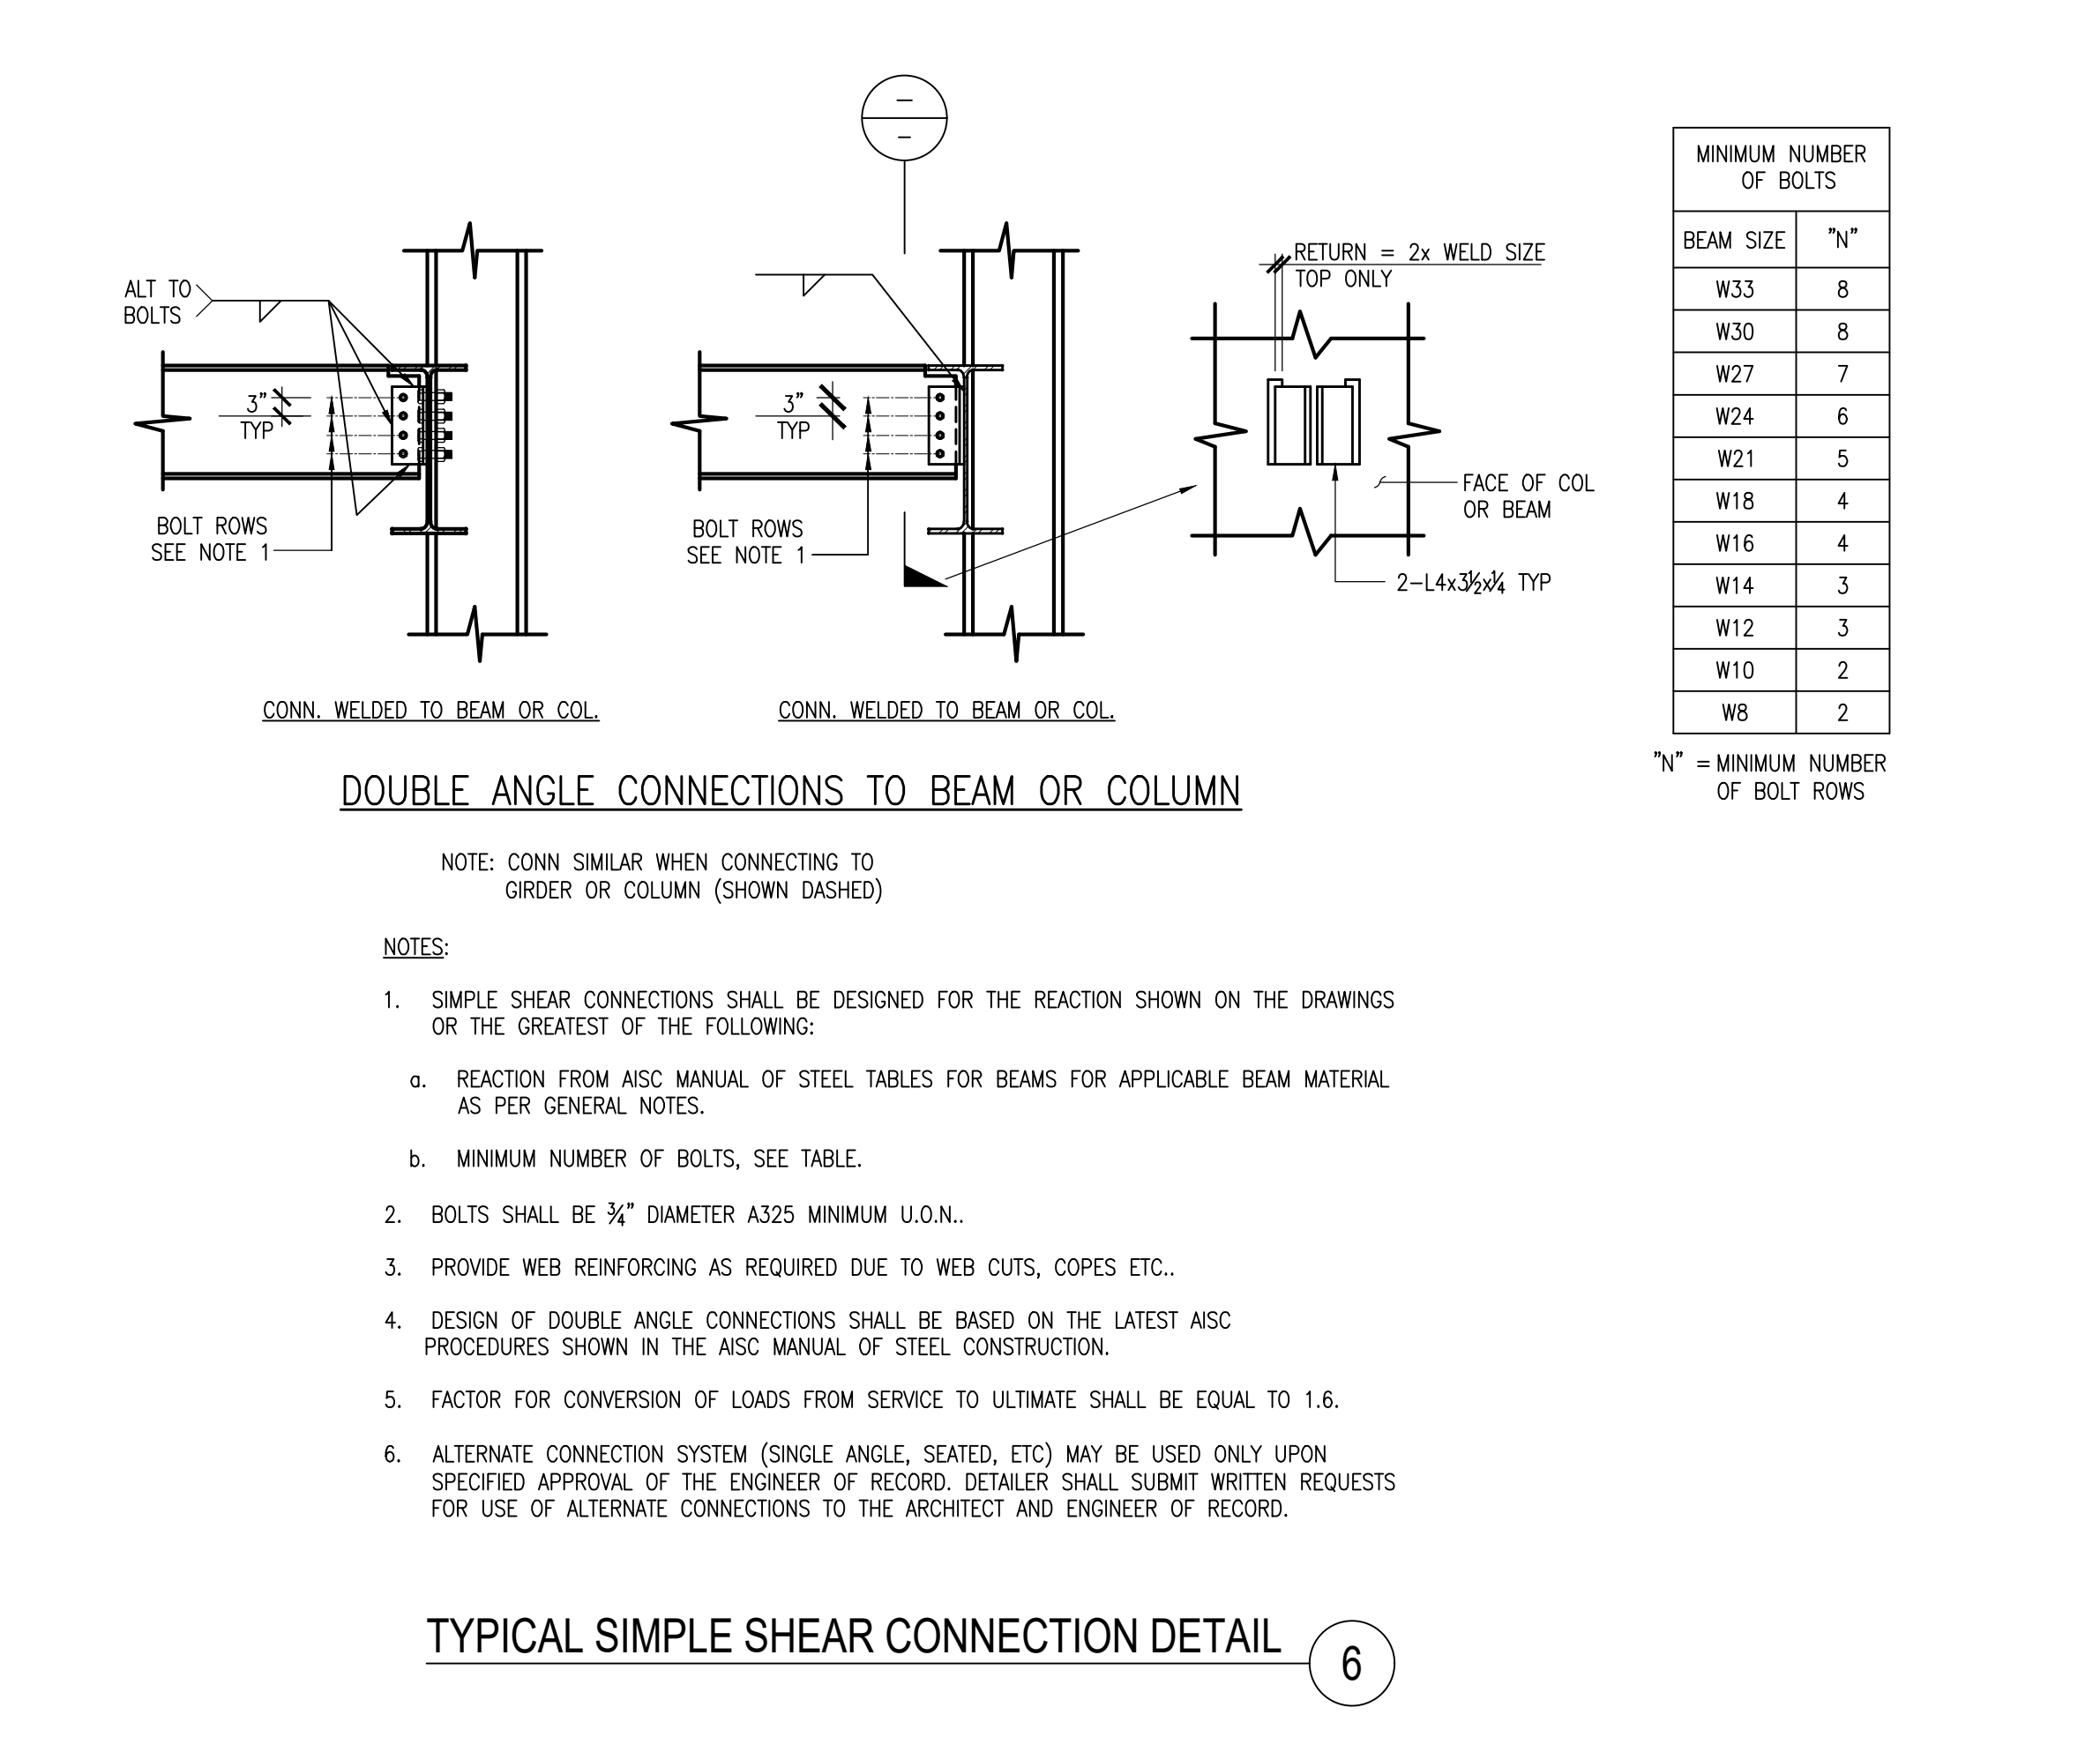


TYPICAL SIMPLE SHEAR CONNECTION DETAIL 6

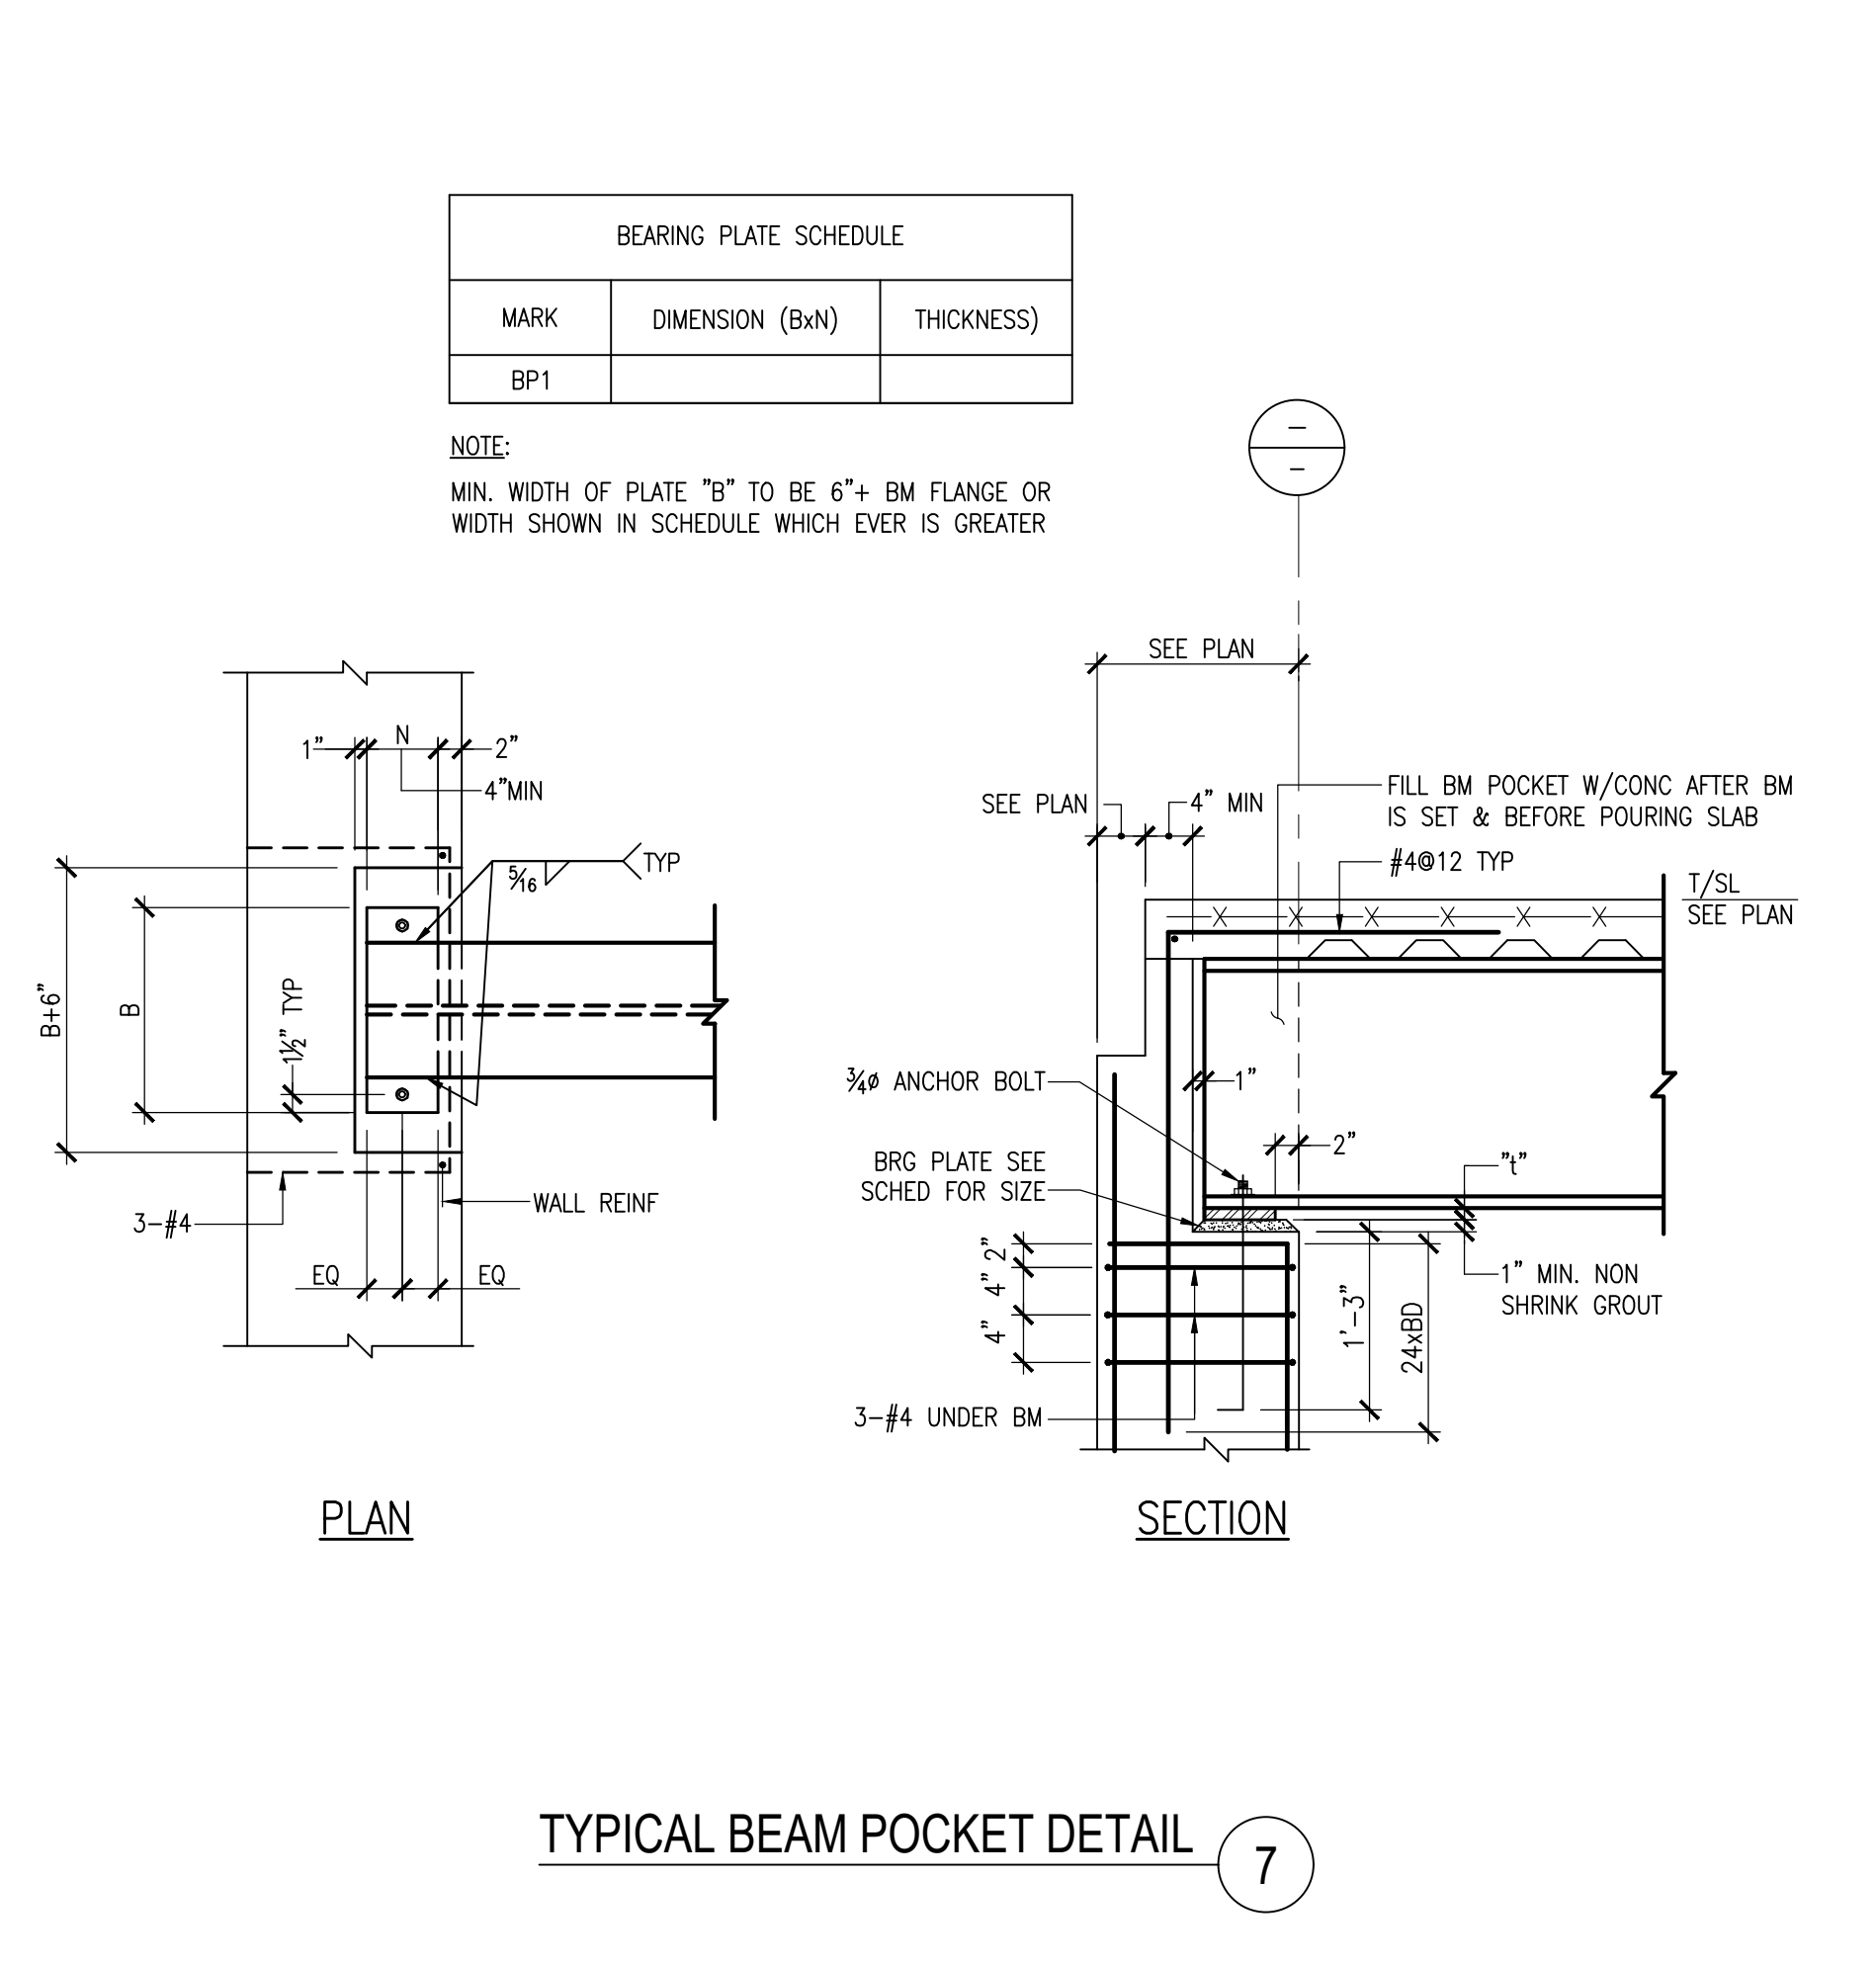


TYPICAL BEAM POCKET DETAIL 7

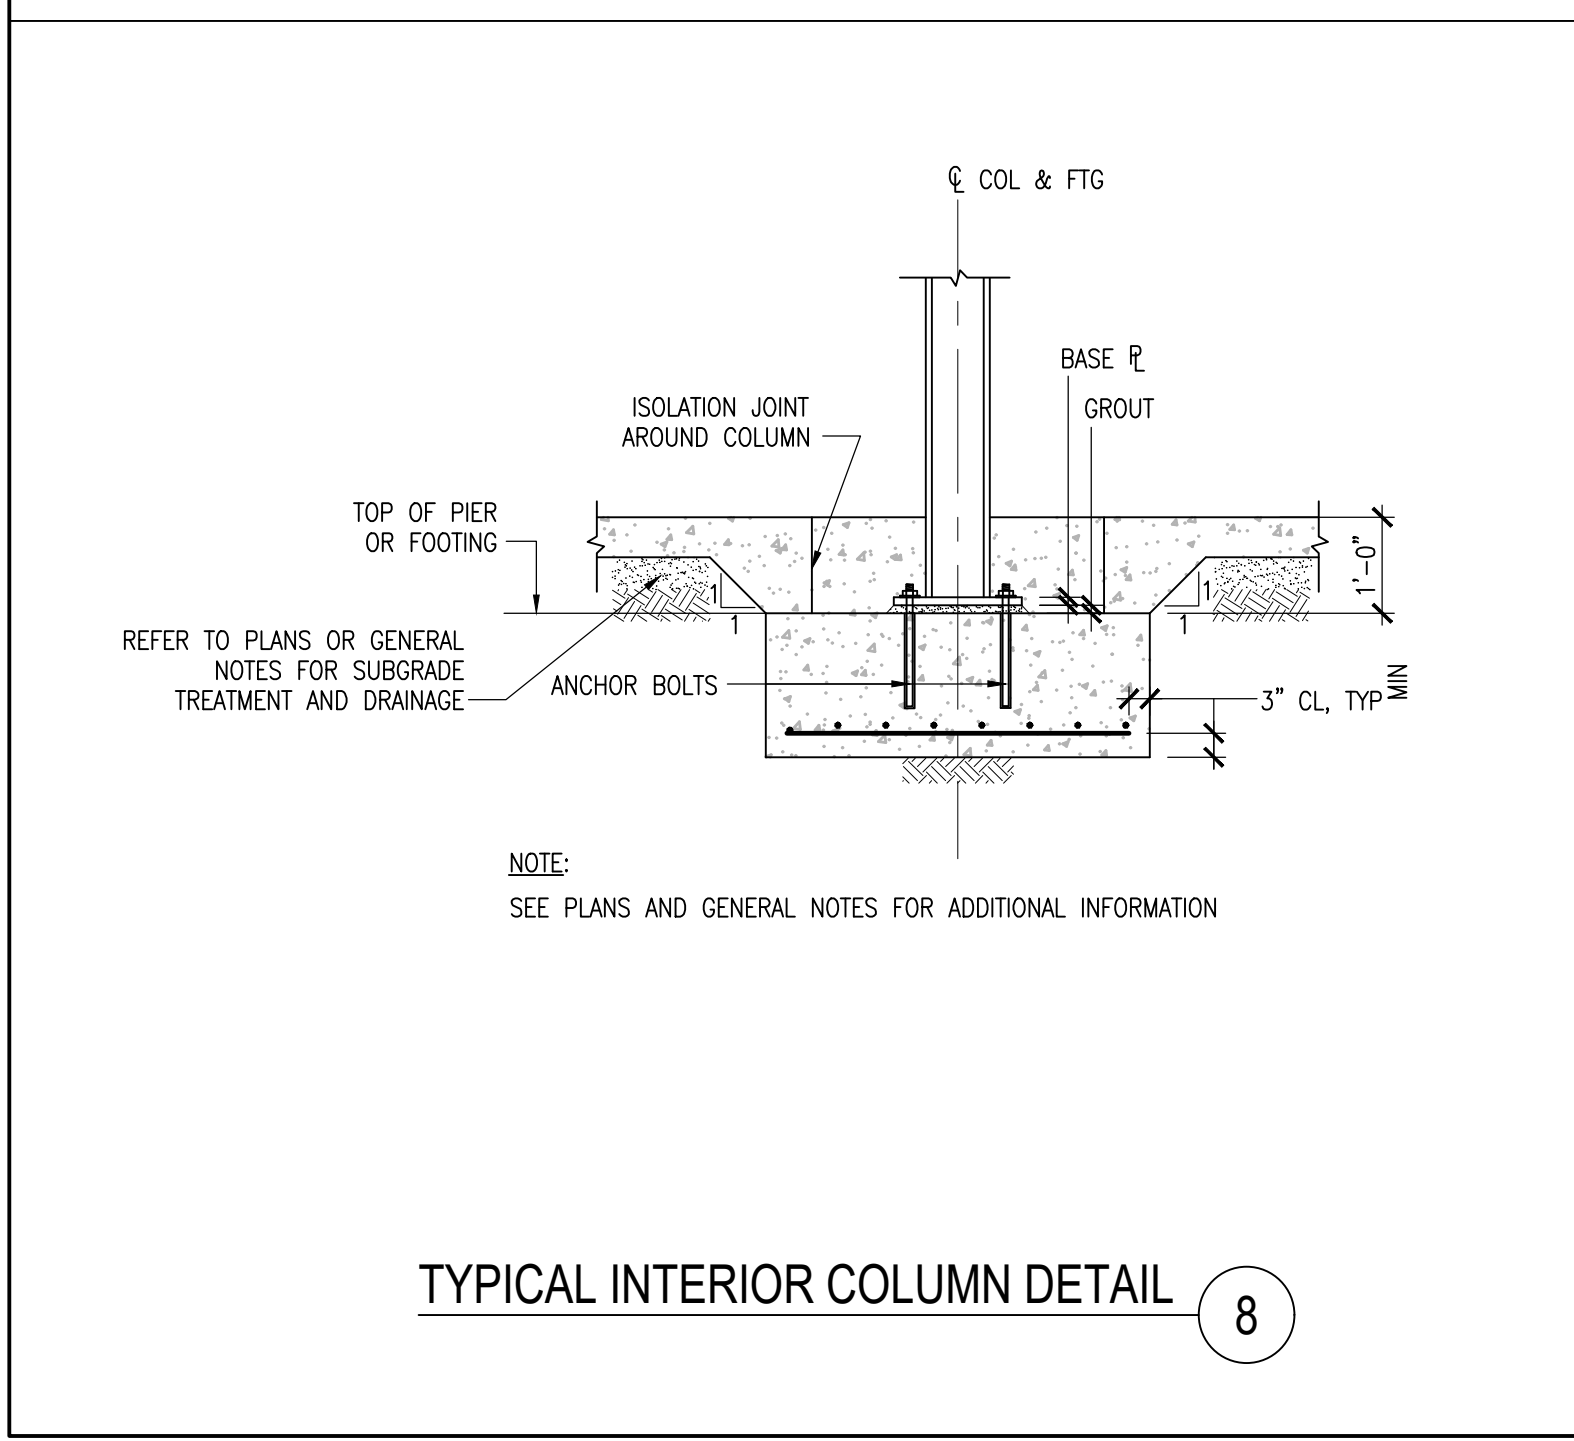


TYPICAL INTERIOR COLUMN DETAIL 8

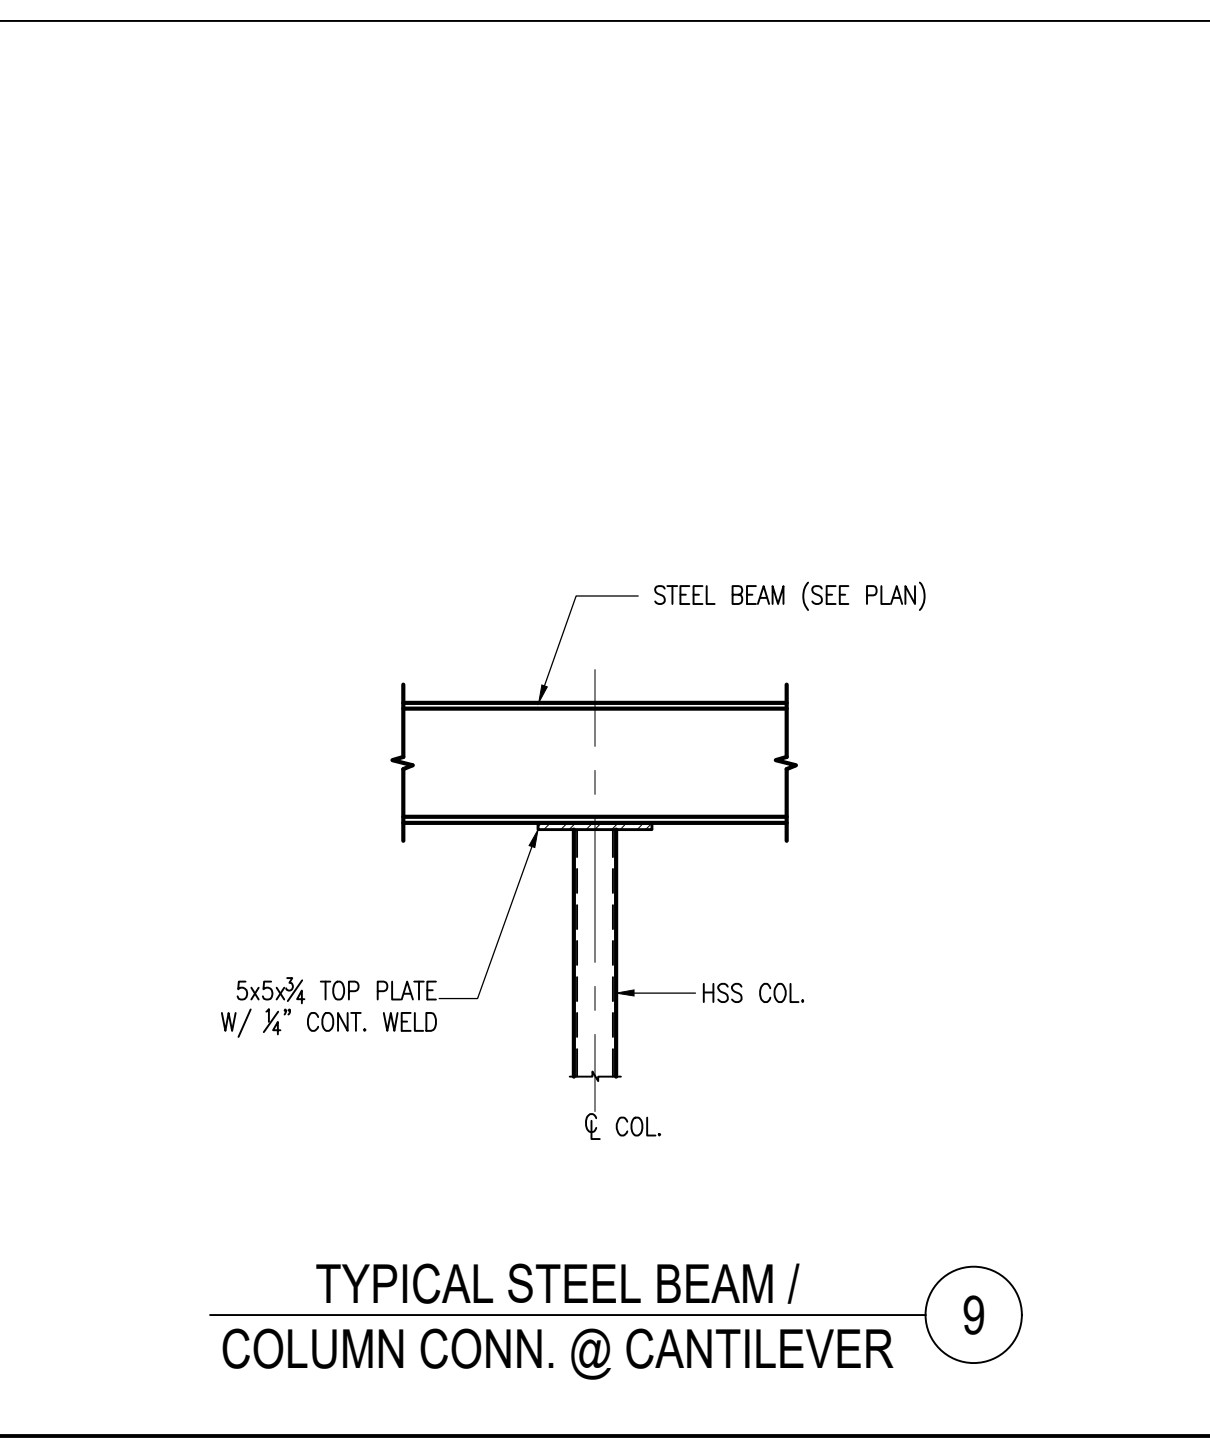


TYPICAL STEEL BEAM / COLUMN CONN. @ CANTILEVER 9

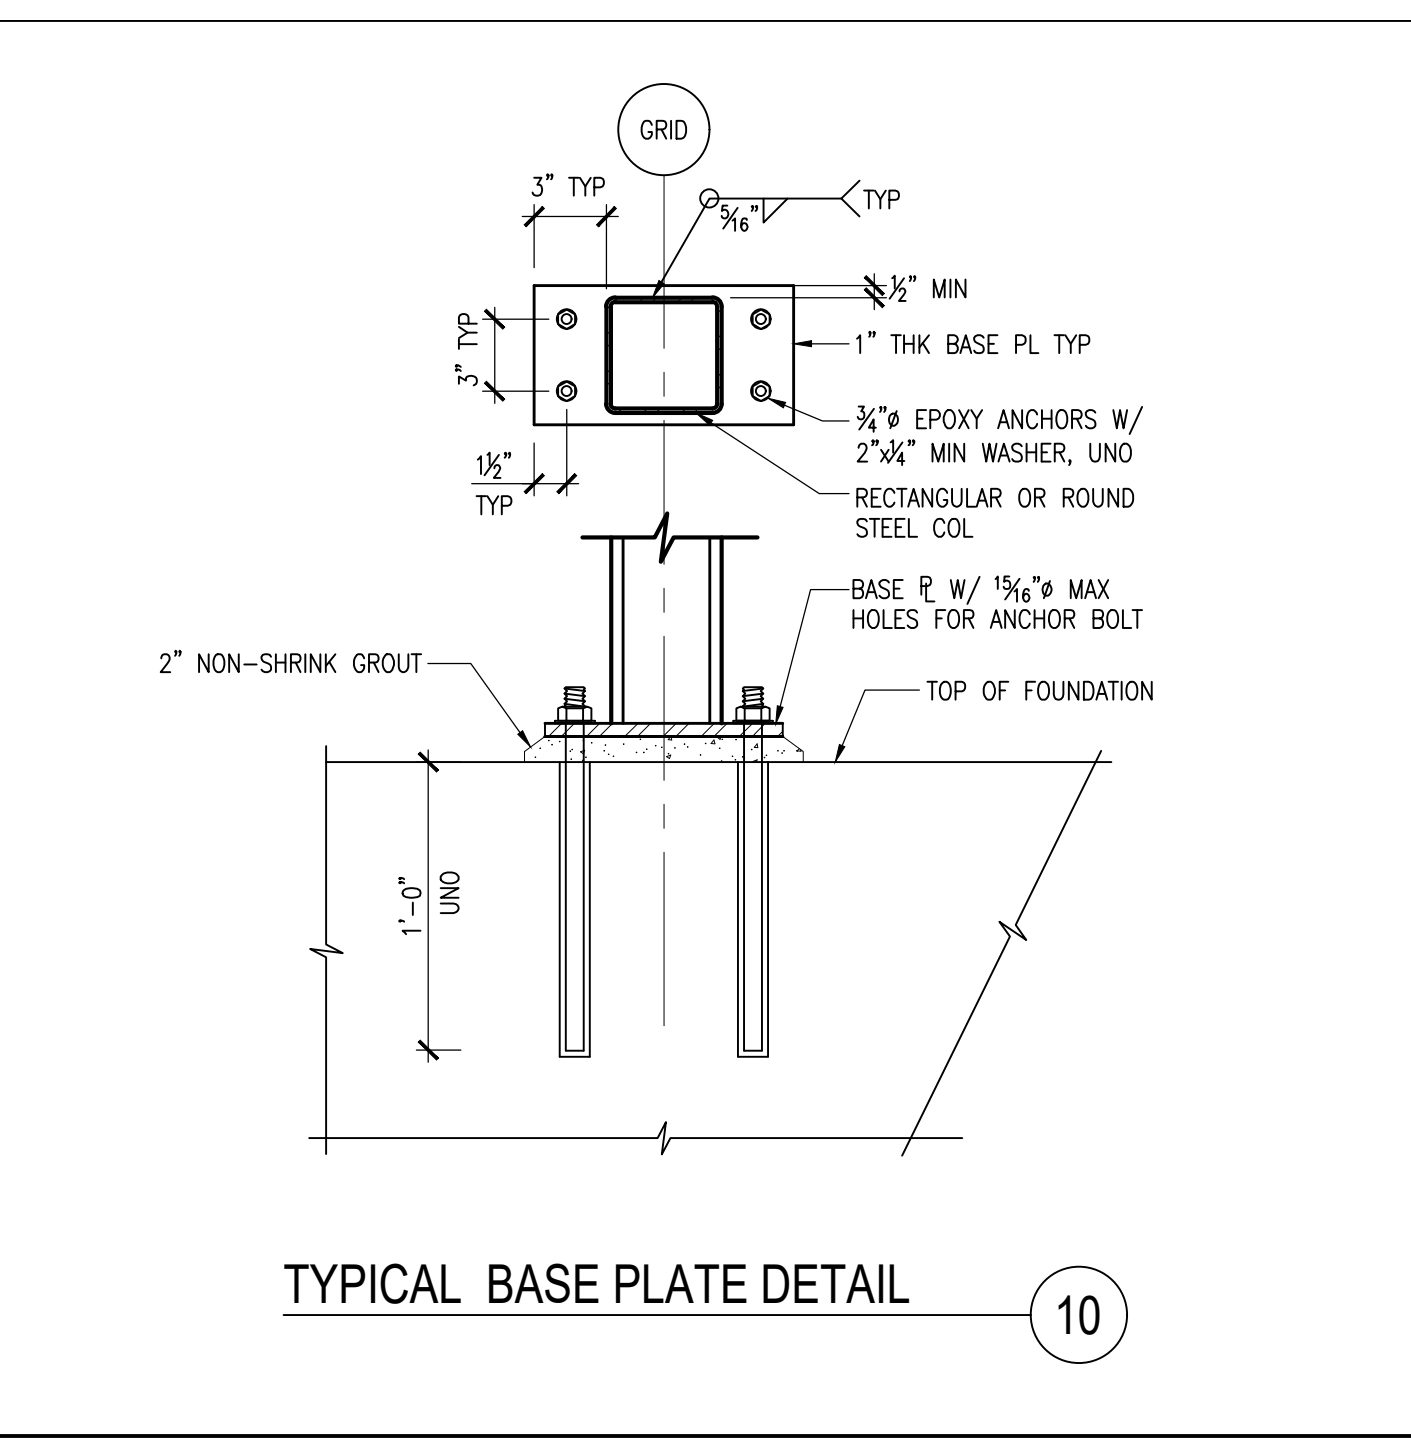

TYPICAL BASE PLATE DETAIL 10

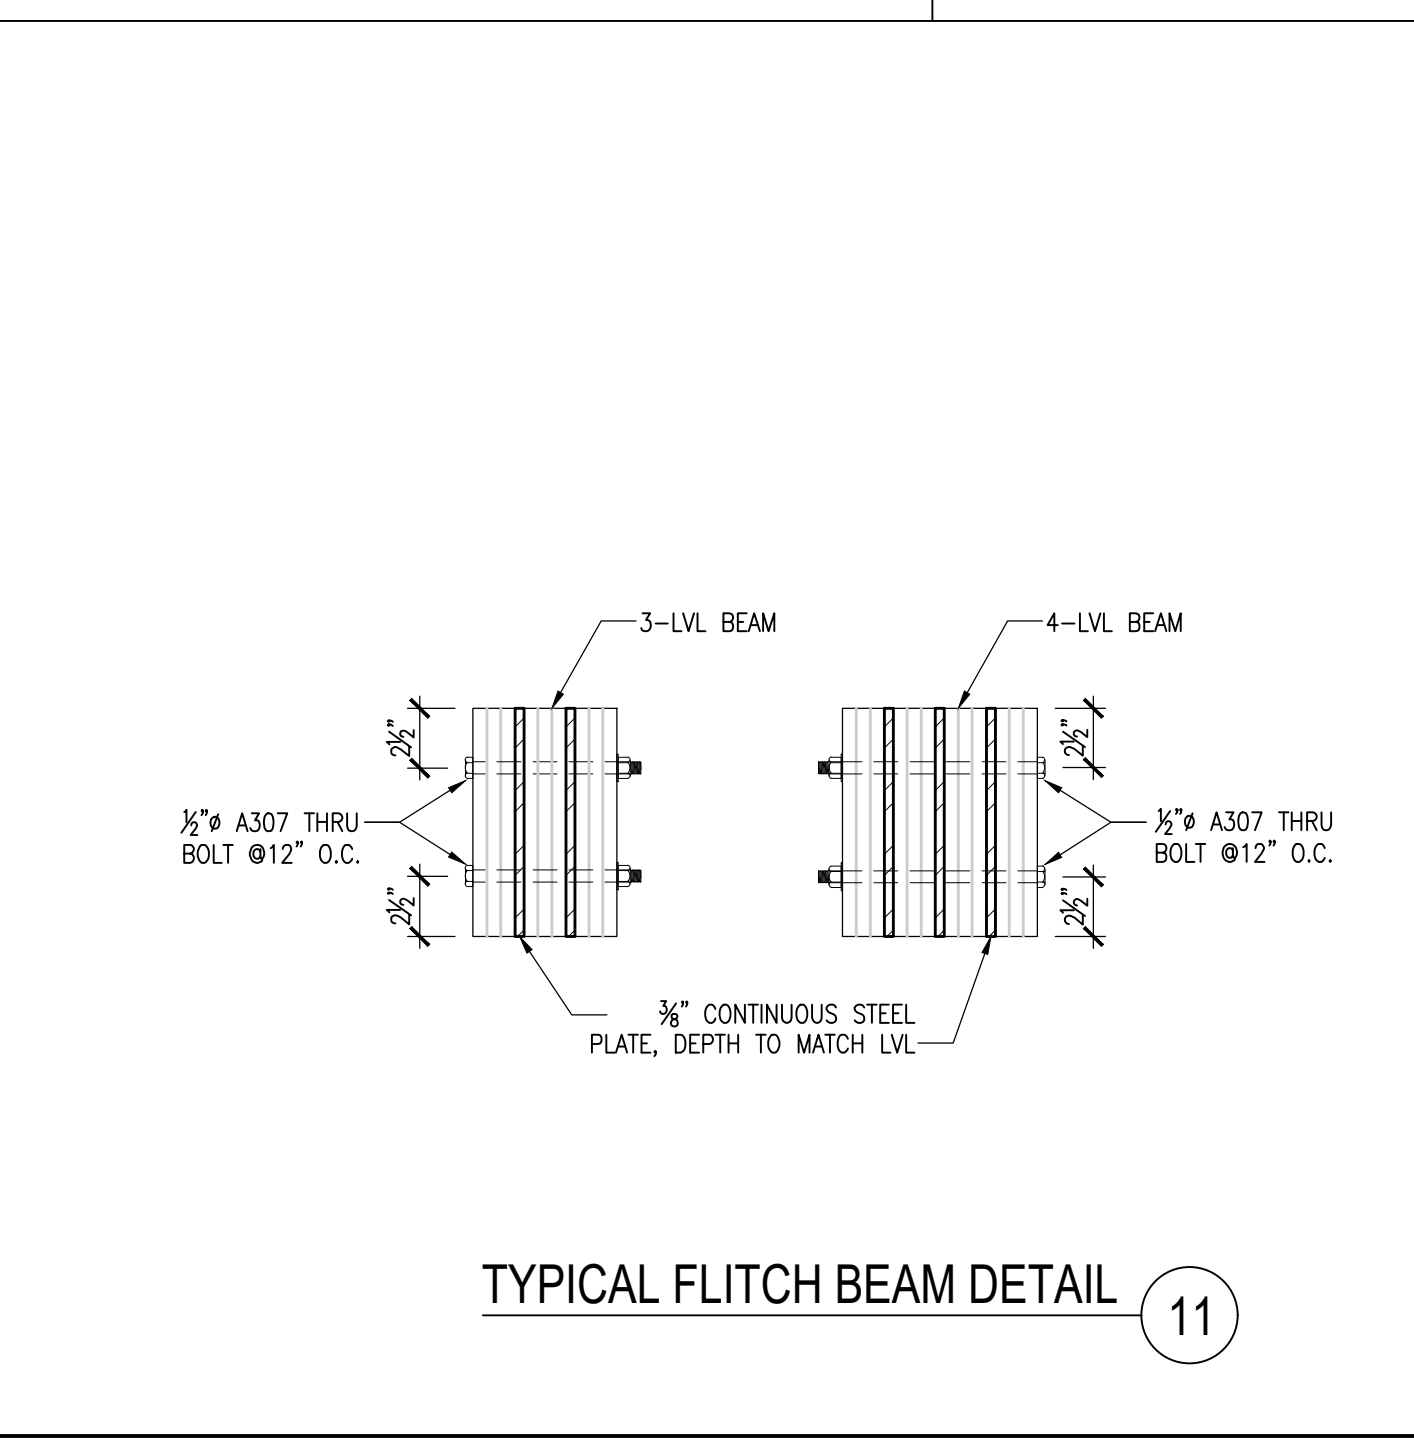

TYPICAL FLITCH BEAM DETAIL 11

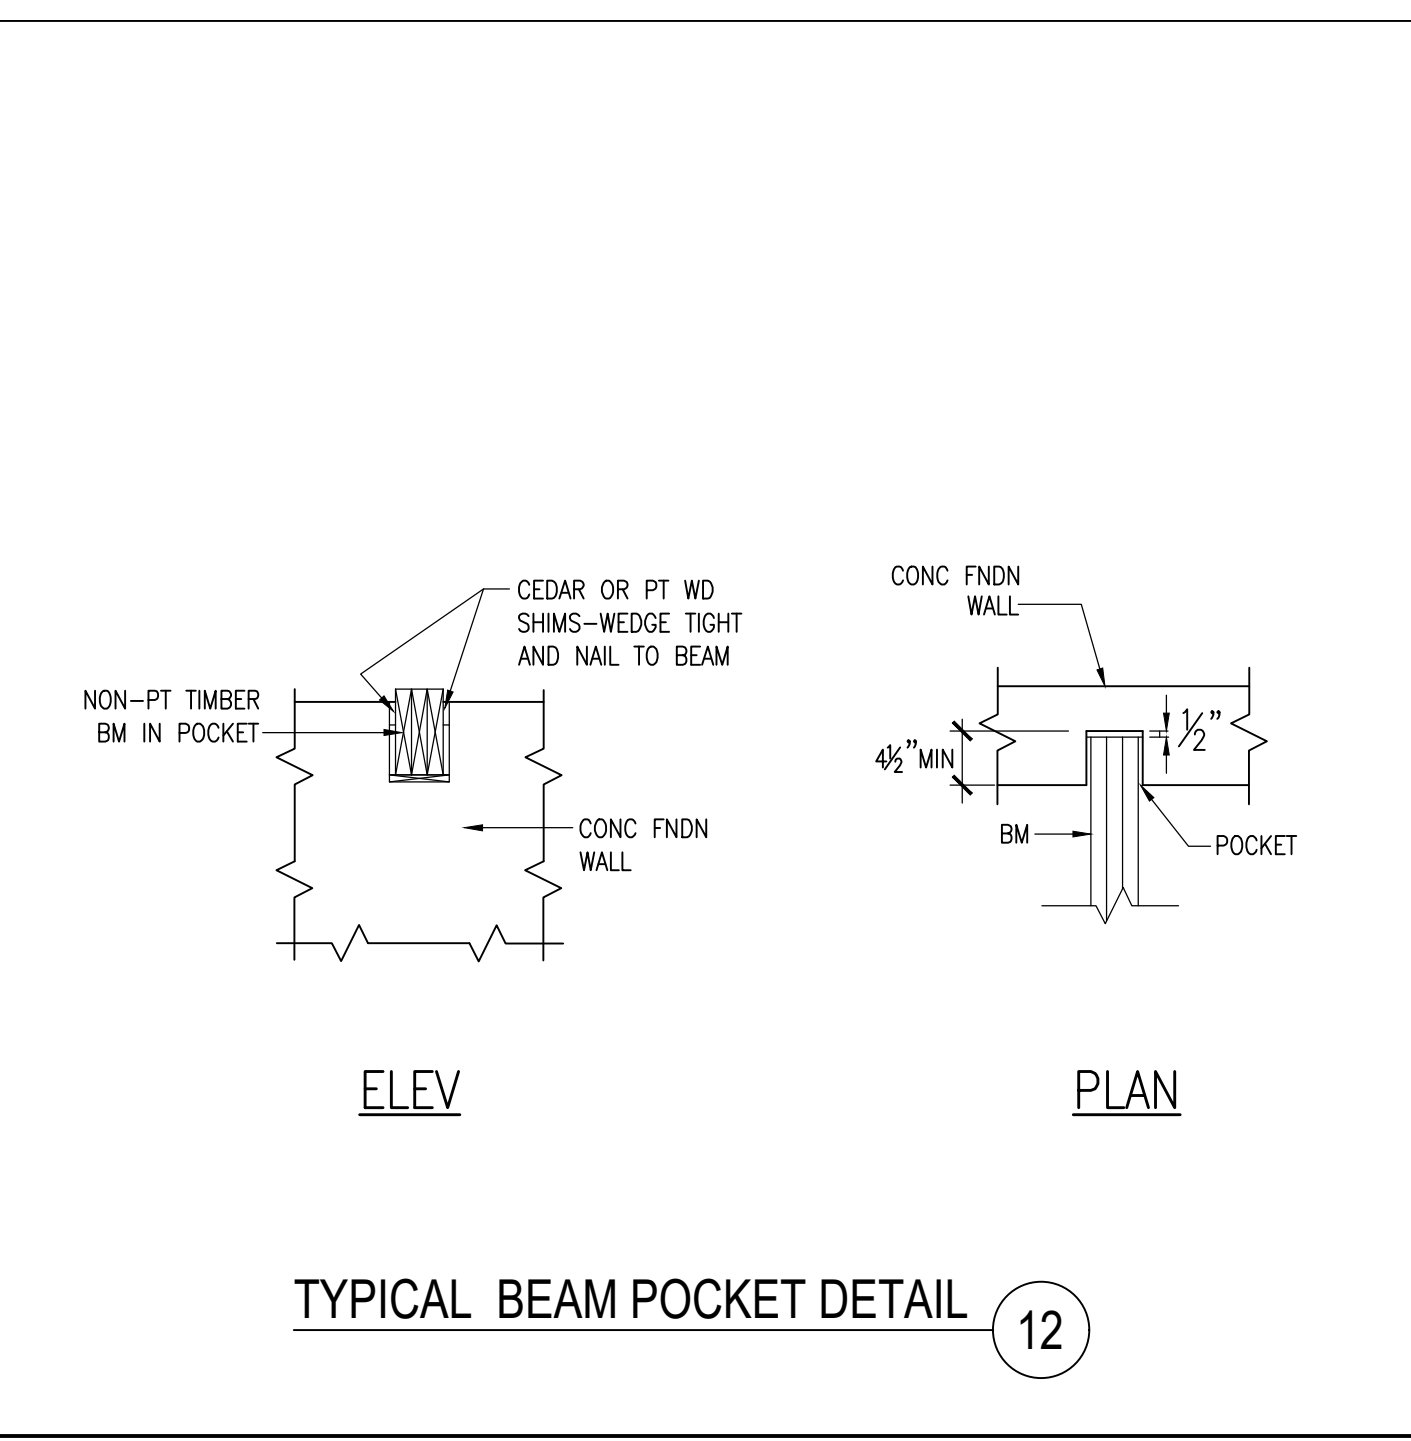

TYPICAL BEAM POCKET DETAIL 12

CHARLES ROSE ARCHITECTS INC
 115 WILLOW AVENUE
 SOMERVILLE, MA 02144
 TEL 617.628.5033
 WWW.CHARLESROSEARCHITECTS.COM
 © CHARLES ROSE ARCHITECTS INC

CONSULTANT
RSE ASSOCIATES INC.
STRUCTURAL ENGINEERS
 63 PLEASANT STREET
 WATERTOWN, MA 02472
 TEL (617) 928-8300
 FAX (617) 928-8301
 WWW.RSEASSOCIATES.COM

CERTIFICATION
 REGISTERED PROFESSIONAL ENGINEER
 RICHARD S. ROSE
 No. 49888
 STATE OF MASSACHUSETTS

BAIRD RESIDENCE
 16 WOODLAND ROAD
 JAMAICA PLAIN, BOSTON, MA 02130

REVISION HISTORY



NO.	DESCRIPTION	DATE

CONSTRUCTION DOCUMENTS


DATE: AUG 16, 2023
 SCALE: As Indicated
 DRAWN BY: EAC
 CHECKED BY: SW
 SHEET TITLE: PROJECT # 40035

TYPICAL DETAILS


S0.01

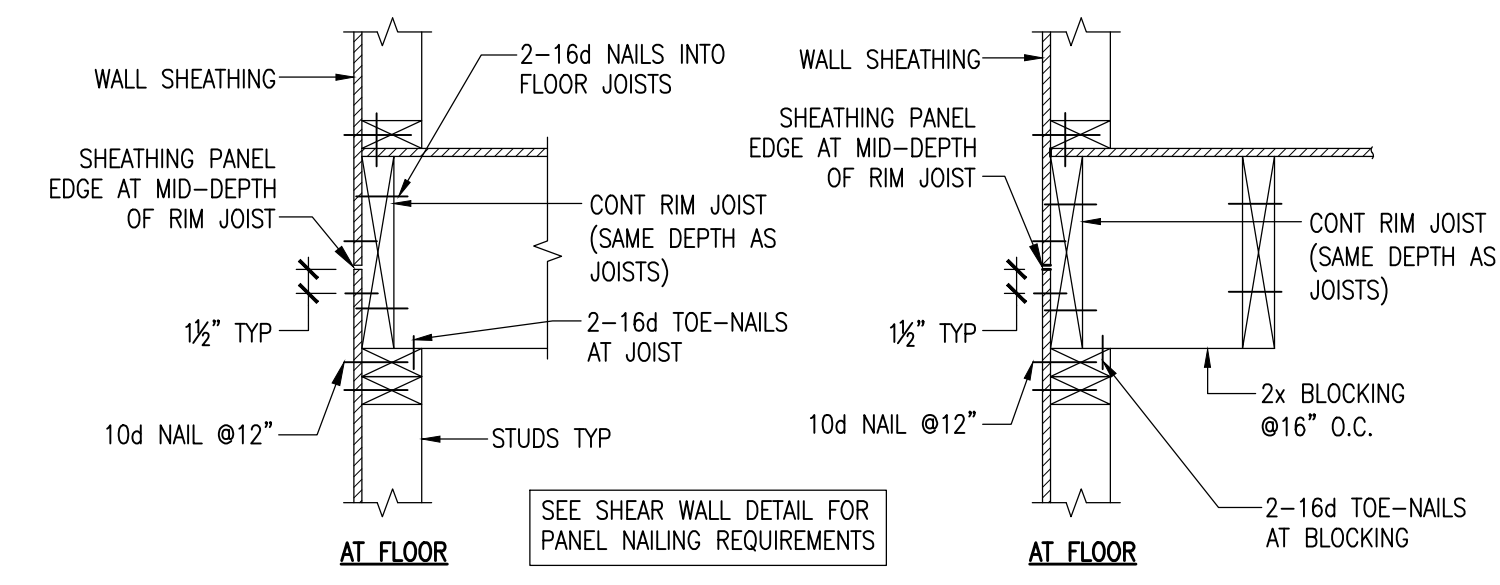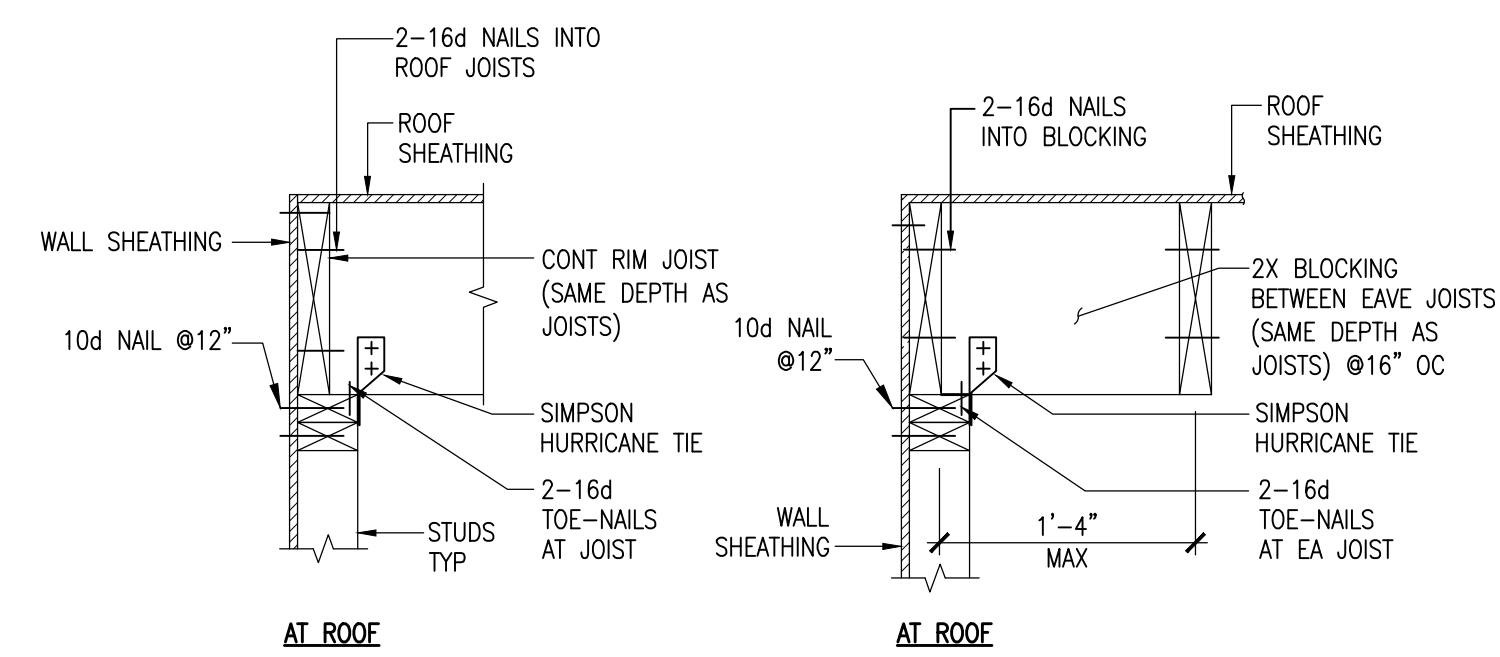


JOIST PERPENDICULAR TO WALL JOIST PARALLEL TO WALL
TYPICAL JOIST-STUD FRAMING DETAILS 1

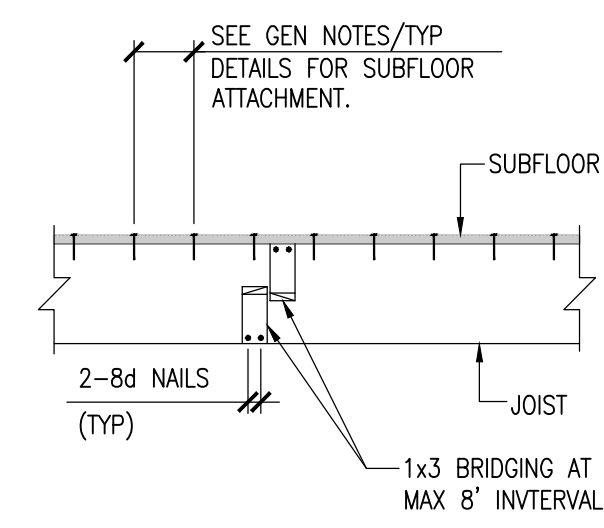


SEE GEN NOTES/TYP DETAILS FOR SUBFLOOR ATTACHMENT.
TYPICAL DETAIL FOR JOIST AND SUBFLOOR FRAMING 2

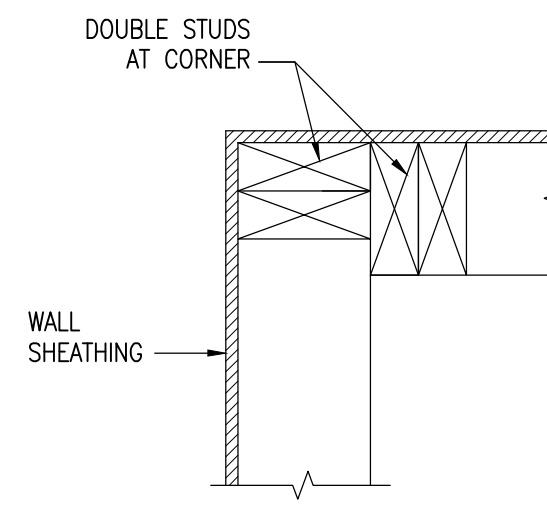


TYPICAL STUD WALL CORNER DETAIL 3

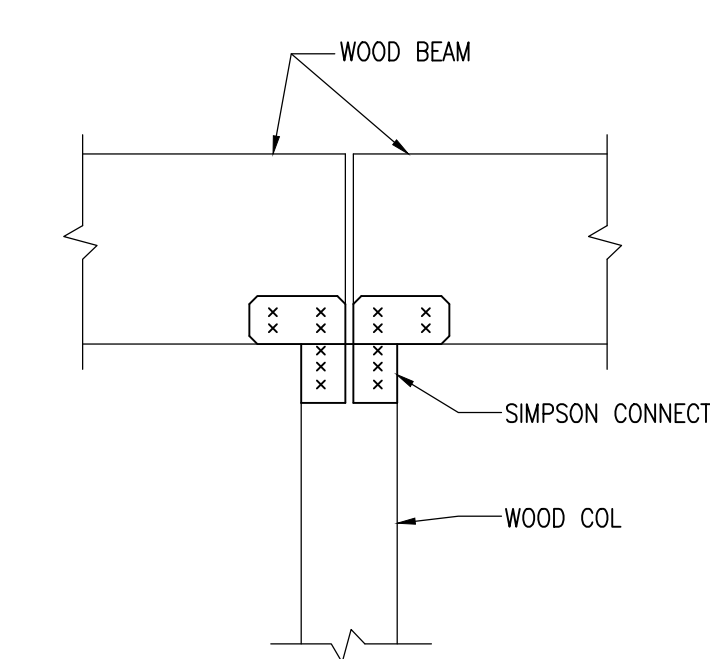


TYPICAL WOOD BEAM/WOOD COLUMN CONNECTION 4

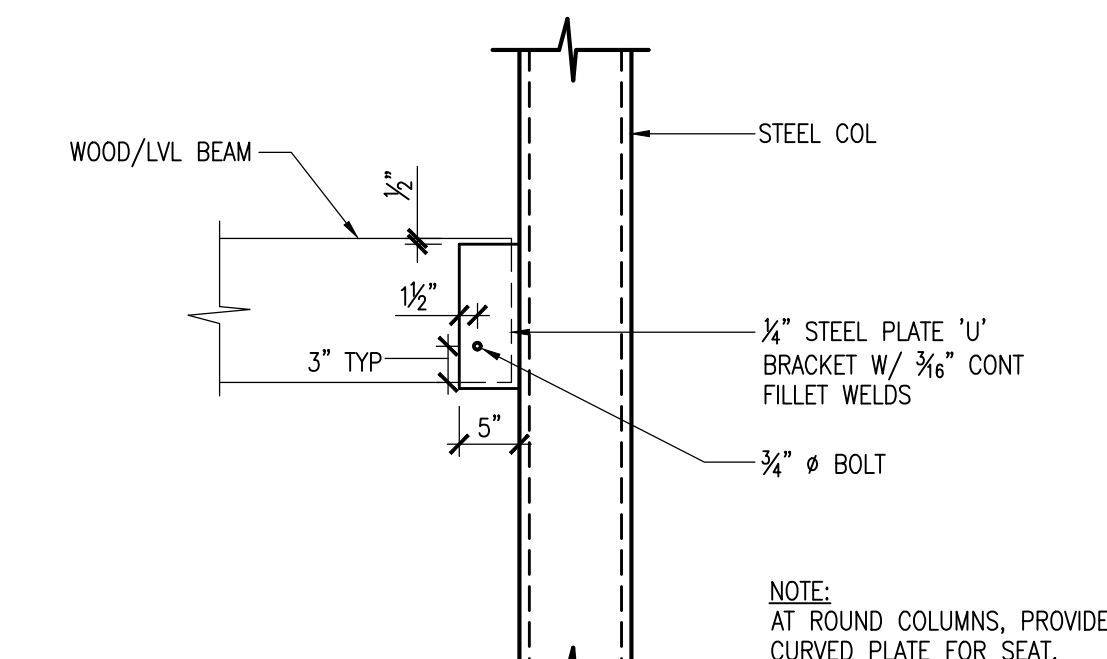


TYPICAL WOOD/LVL BEAM CONNECTION AT STEEL COLUMN 5

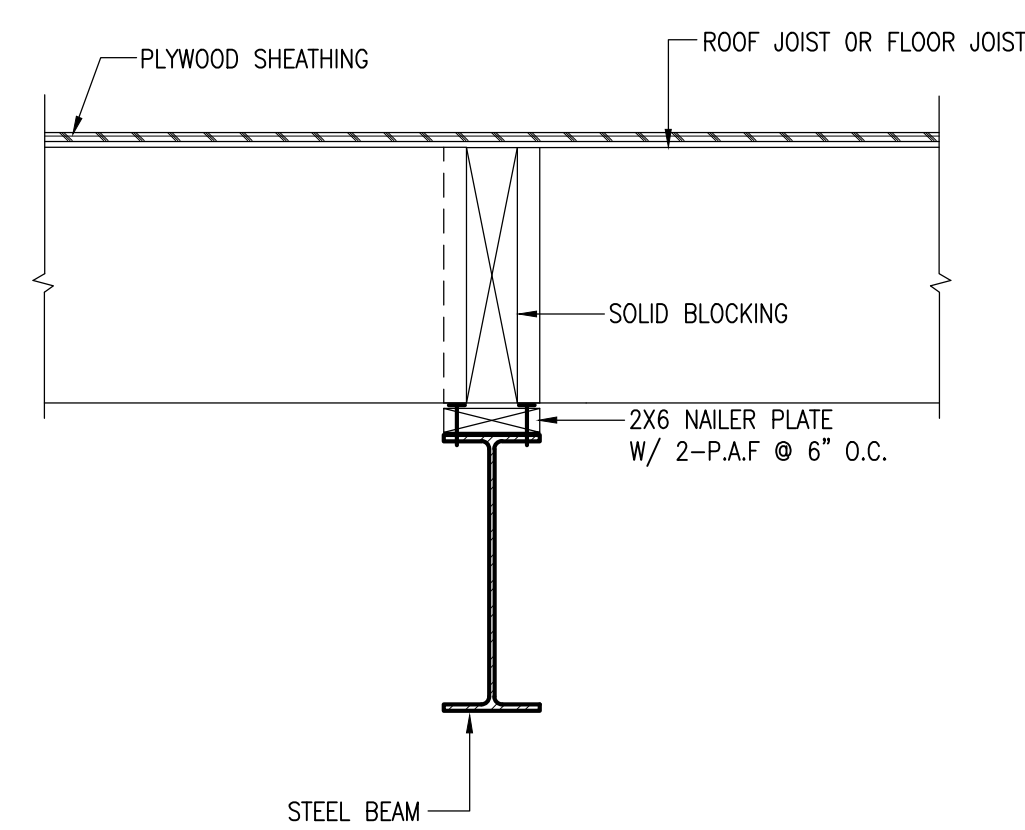


TYPICAL DROPPED STEEL BEAM DETAIL 6

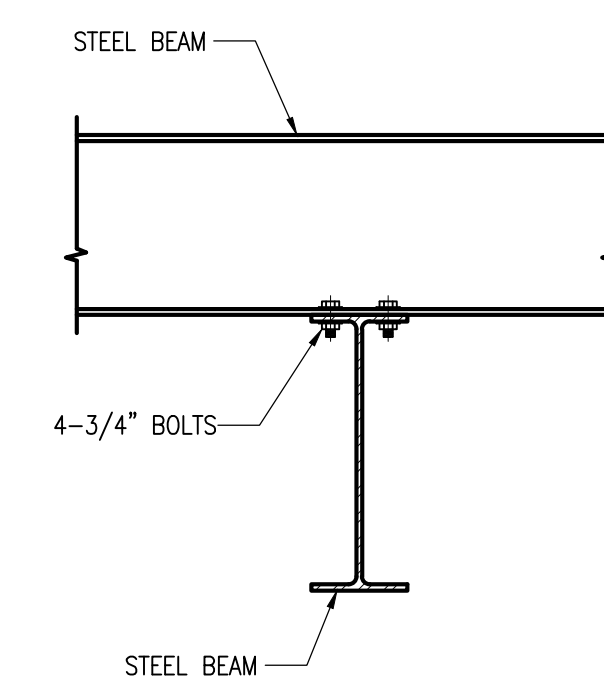


TYPICAL STEEL BEAM SUPPORT ON STEEL BEAM 7

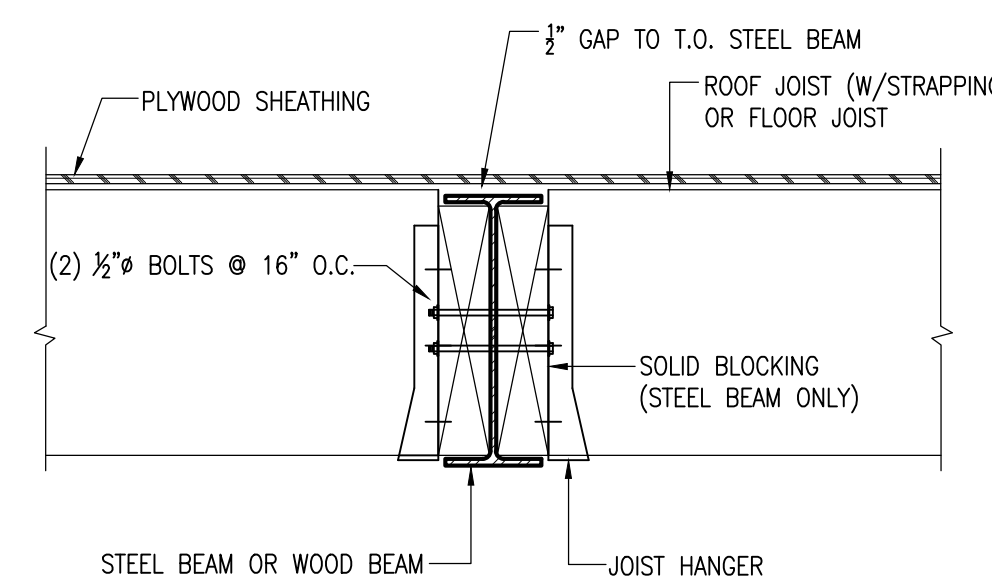


TYPICAL FLUSH BEAM/JOISTS CONNECTION 8

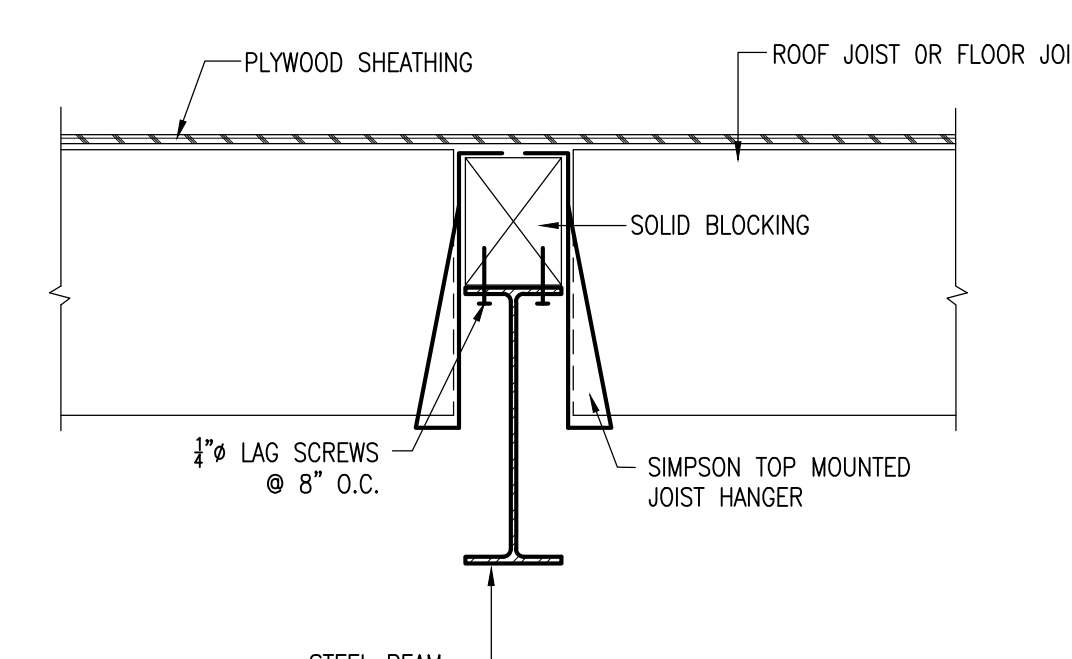


PARTIALLY DROPPED STEEL BEAM CONNECTION 9

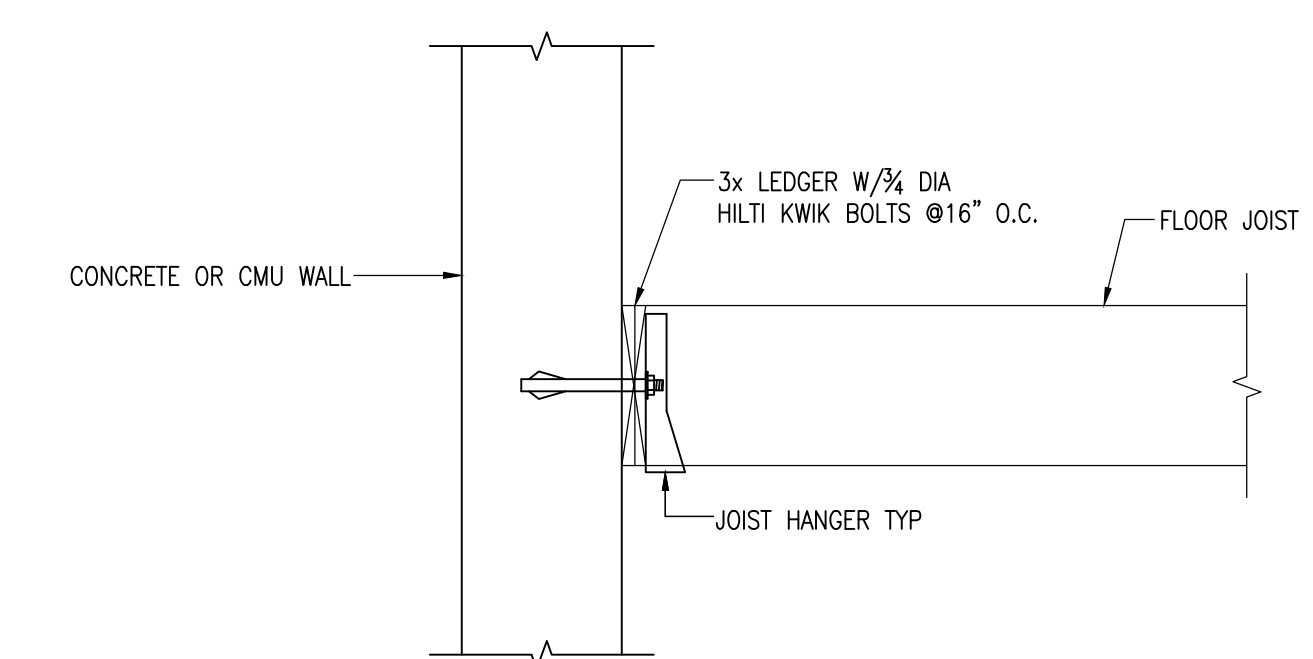


TYPICAL LEDGER AT CONCRETE OR CMU WALL 10

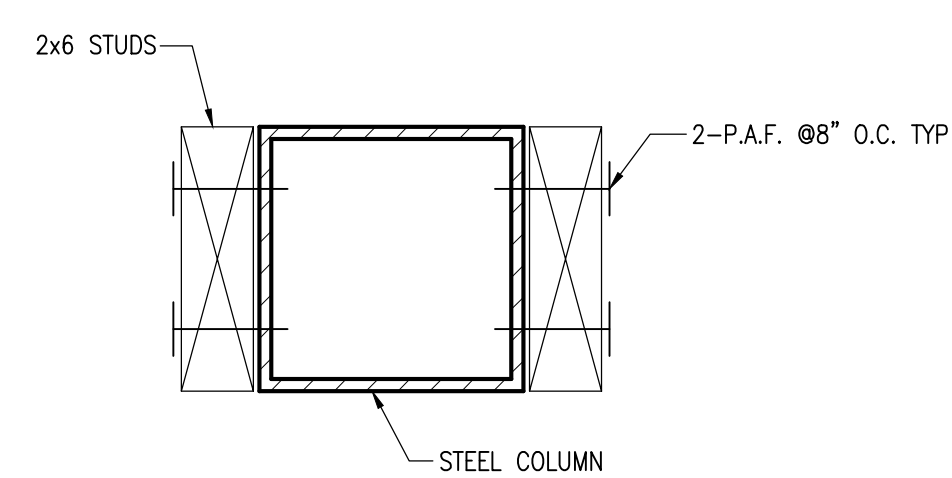


TYPICAL STEEL COLUMN/STUD CONNECTION 11

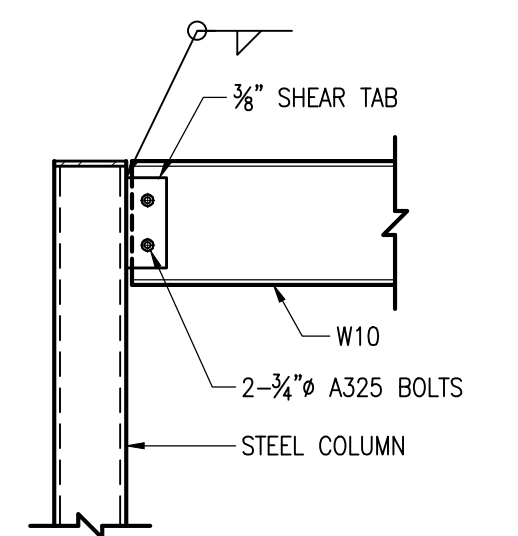


TYPICAL SHEAR TAB CONNECTION AT HSS COLUMN 12

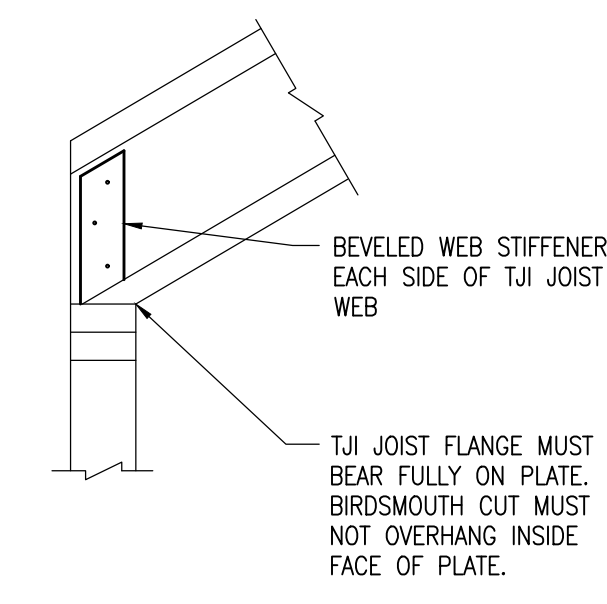


BC BIRDsmouth CUT ALLOWED AT LOW END OF JOIST ONLY

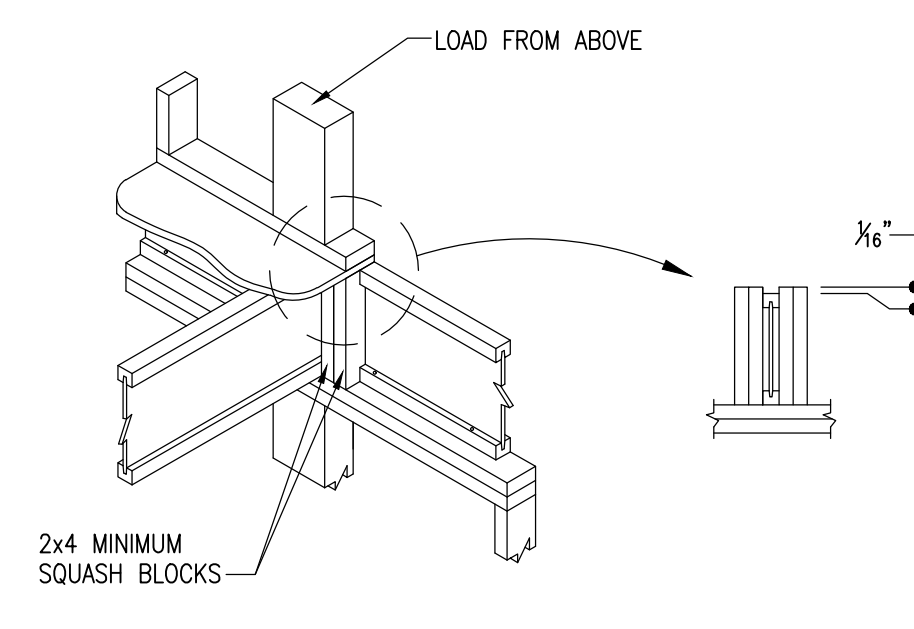


CS USE 2x4 MINIMUM SQUISH BLOCKS TO TRANSFER LOAD AROUND TJI JOIST

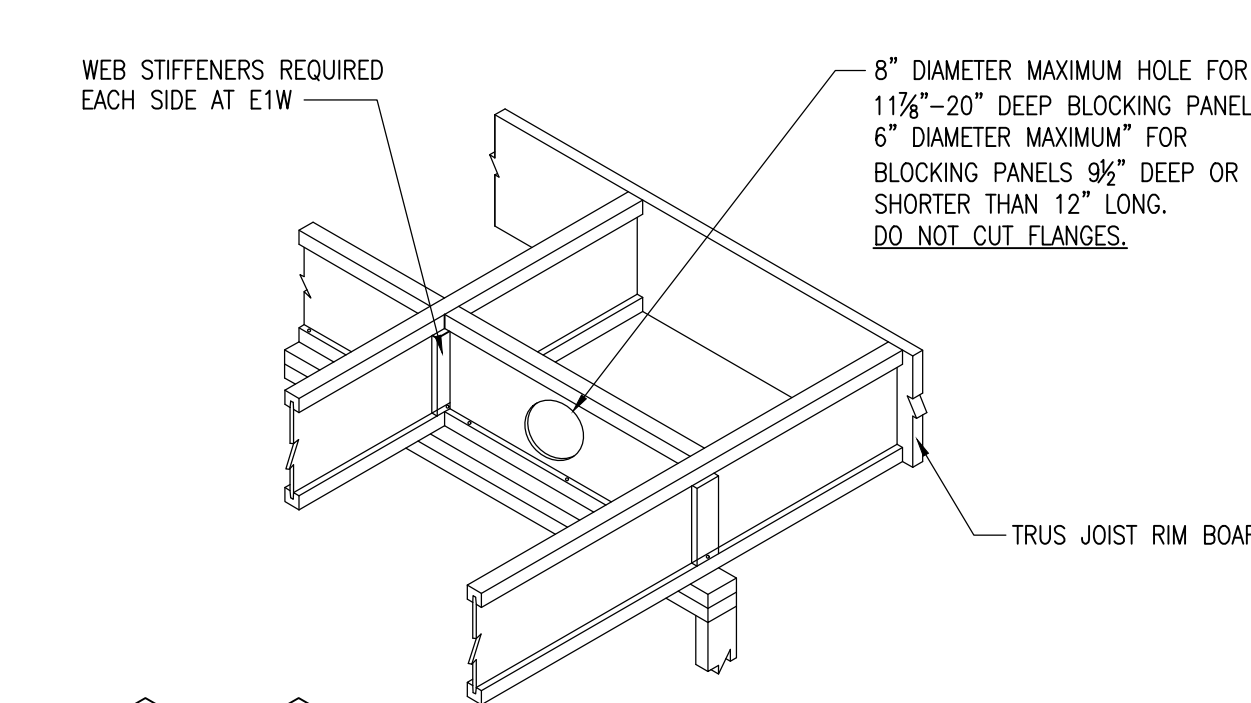


E1 E1W

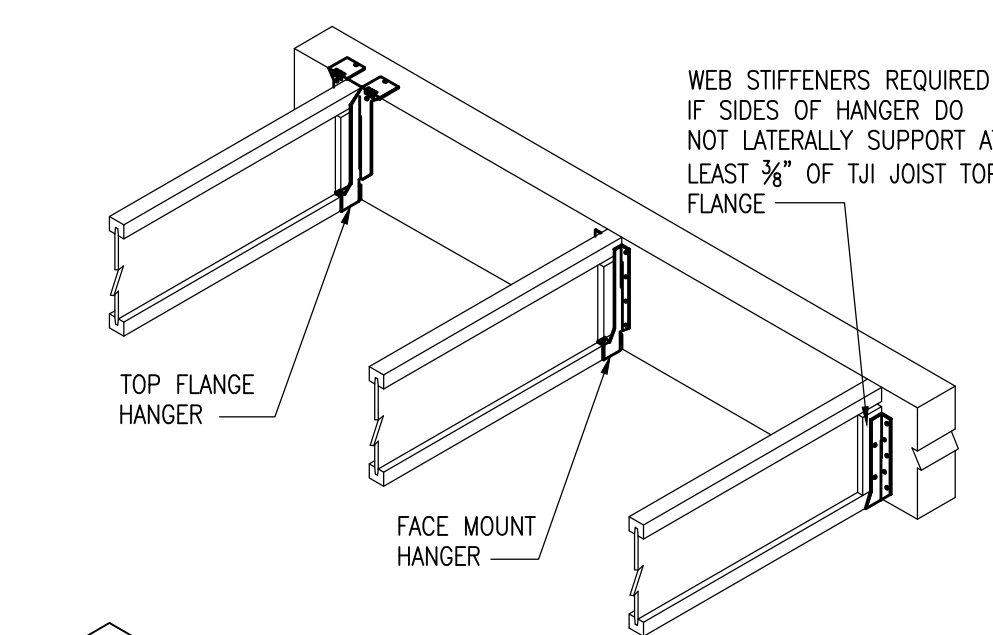


H1

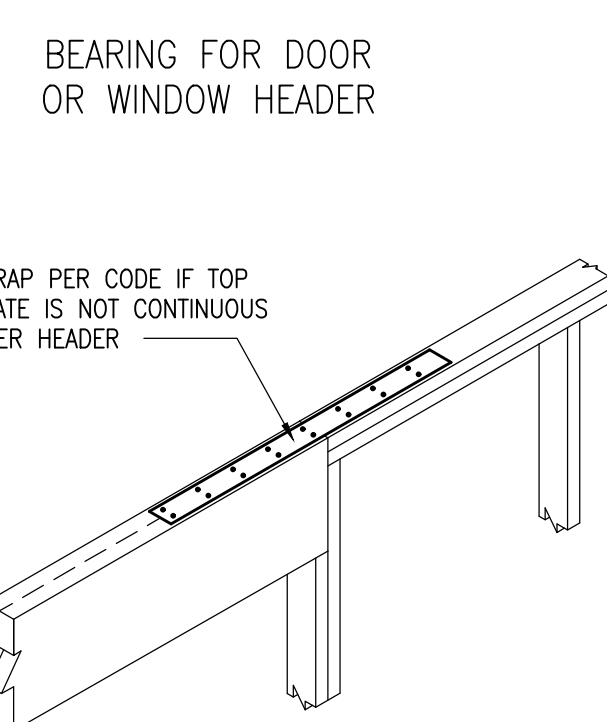

L2

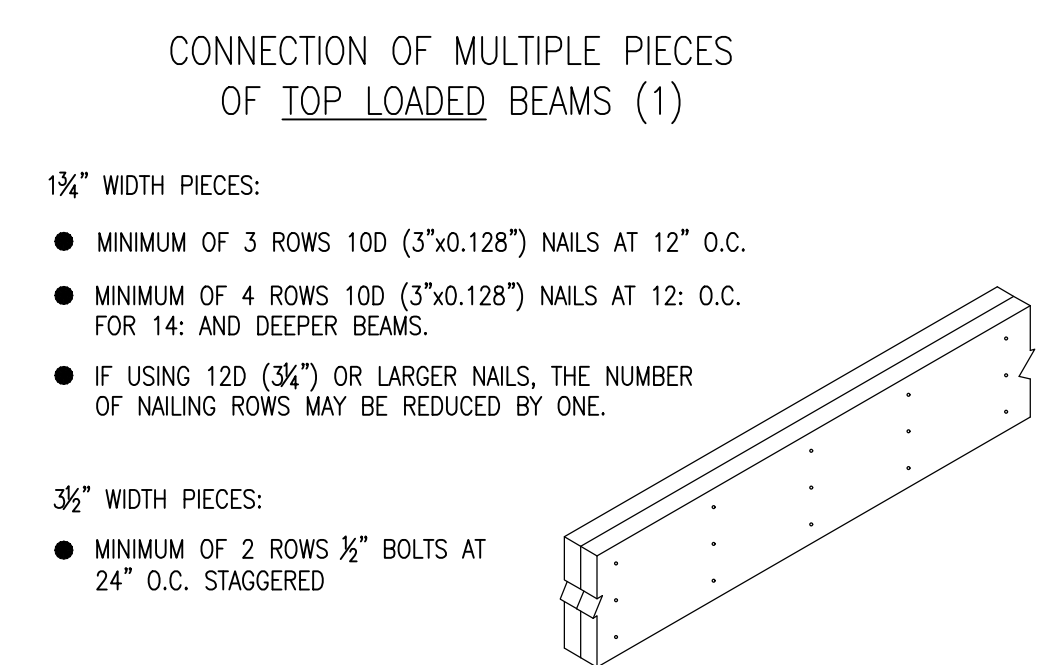


L6

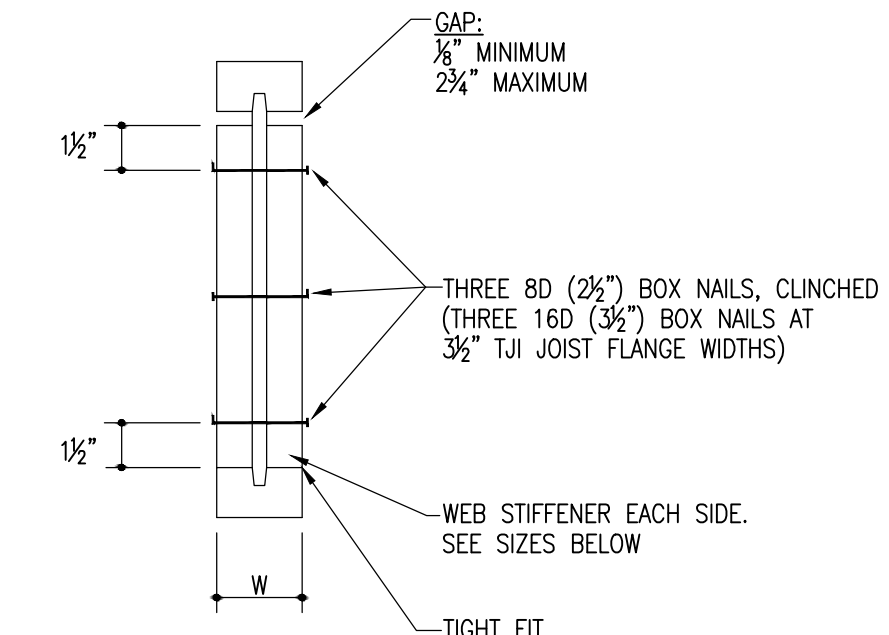

W

W	WEB STIFFENER SIZE	W	WEB STIFFENER SIZE
1 1/2"	1/2" x 2 3/8" MINIMUM	2 3/8"	3/8" x 2 3/8" MINIMUM
1 3/4"	5/8" x 2 3/8" MINIMUM	2 1/2"	1" x 2 3/8" MINIMUM
2 1/8"	3/4" x 2 3/8" MINIMUM	3 1/2"	2x4

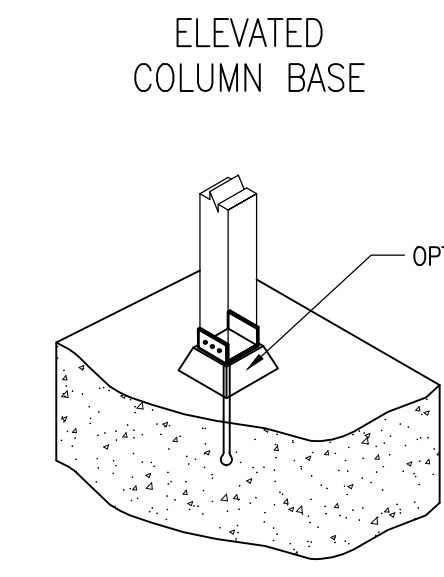

P3

REVISION HISTORY


NO.	DESCRIPTION	DATE

CONSTRUCTION DOCUMENTS

DATE: AUG 16, 2023
 SCALE: As Indicated
 DRAWN BY: EAC
 CHECKED BY: SW
 SHEET TITLE: PROJECT #: 40035

TYPICAL DETAILS

S0.02

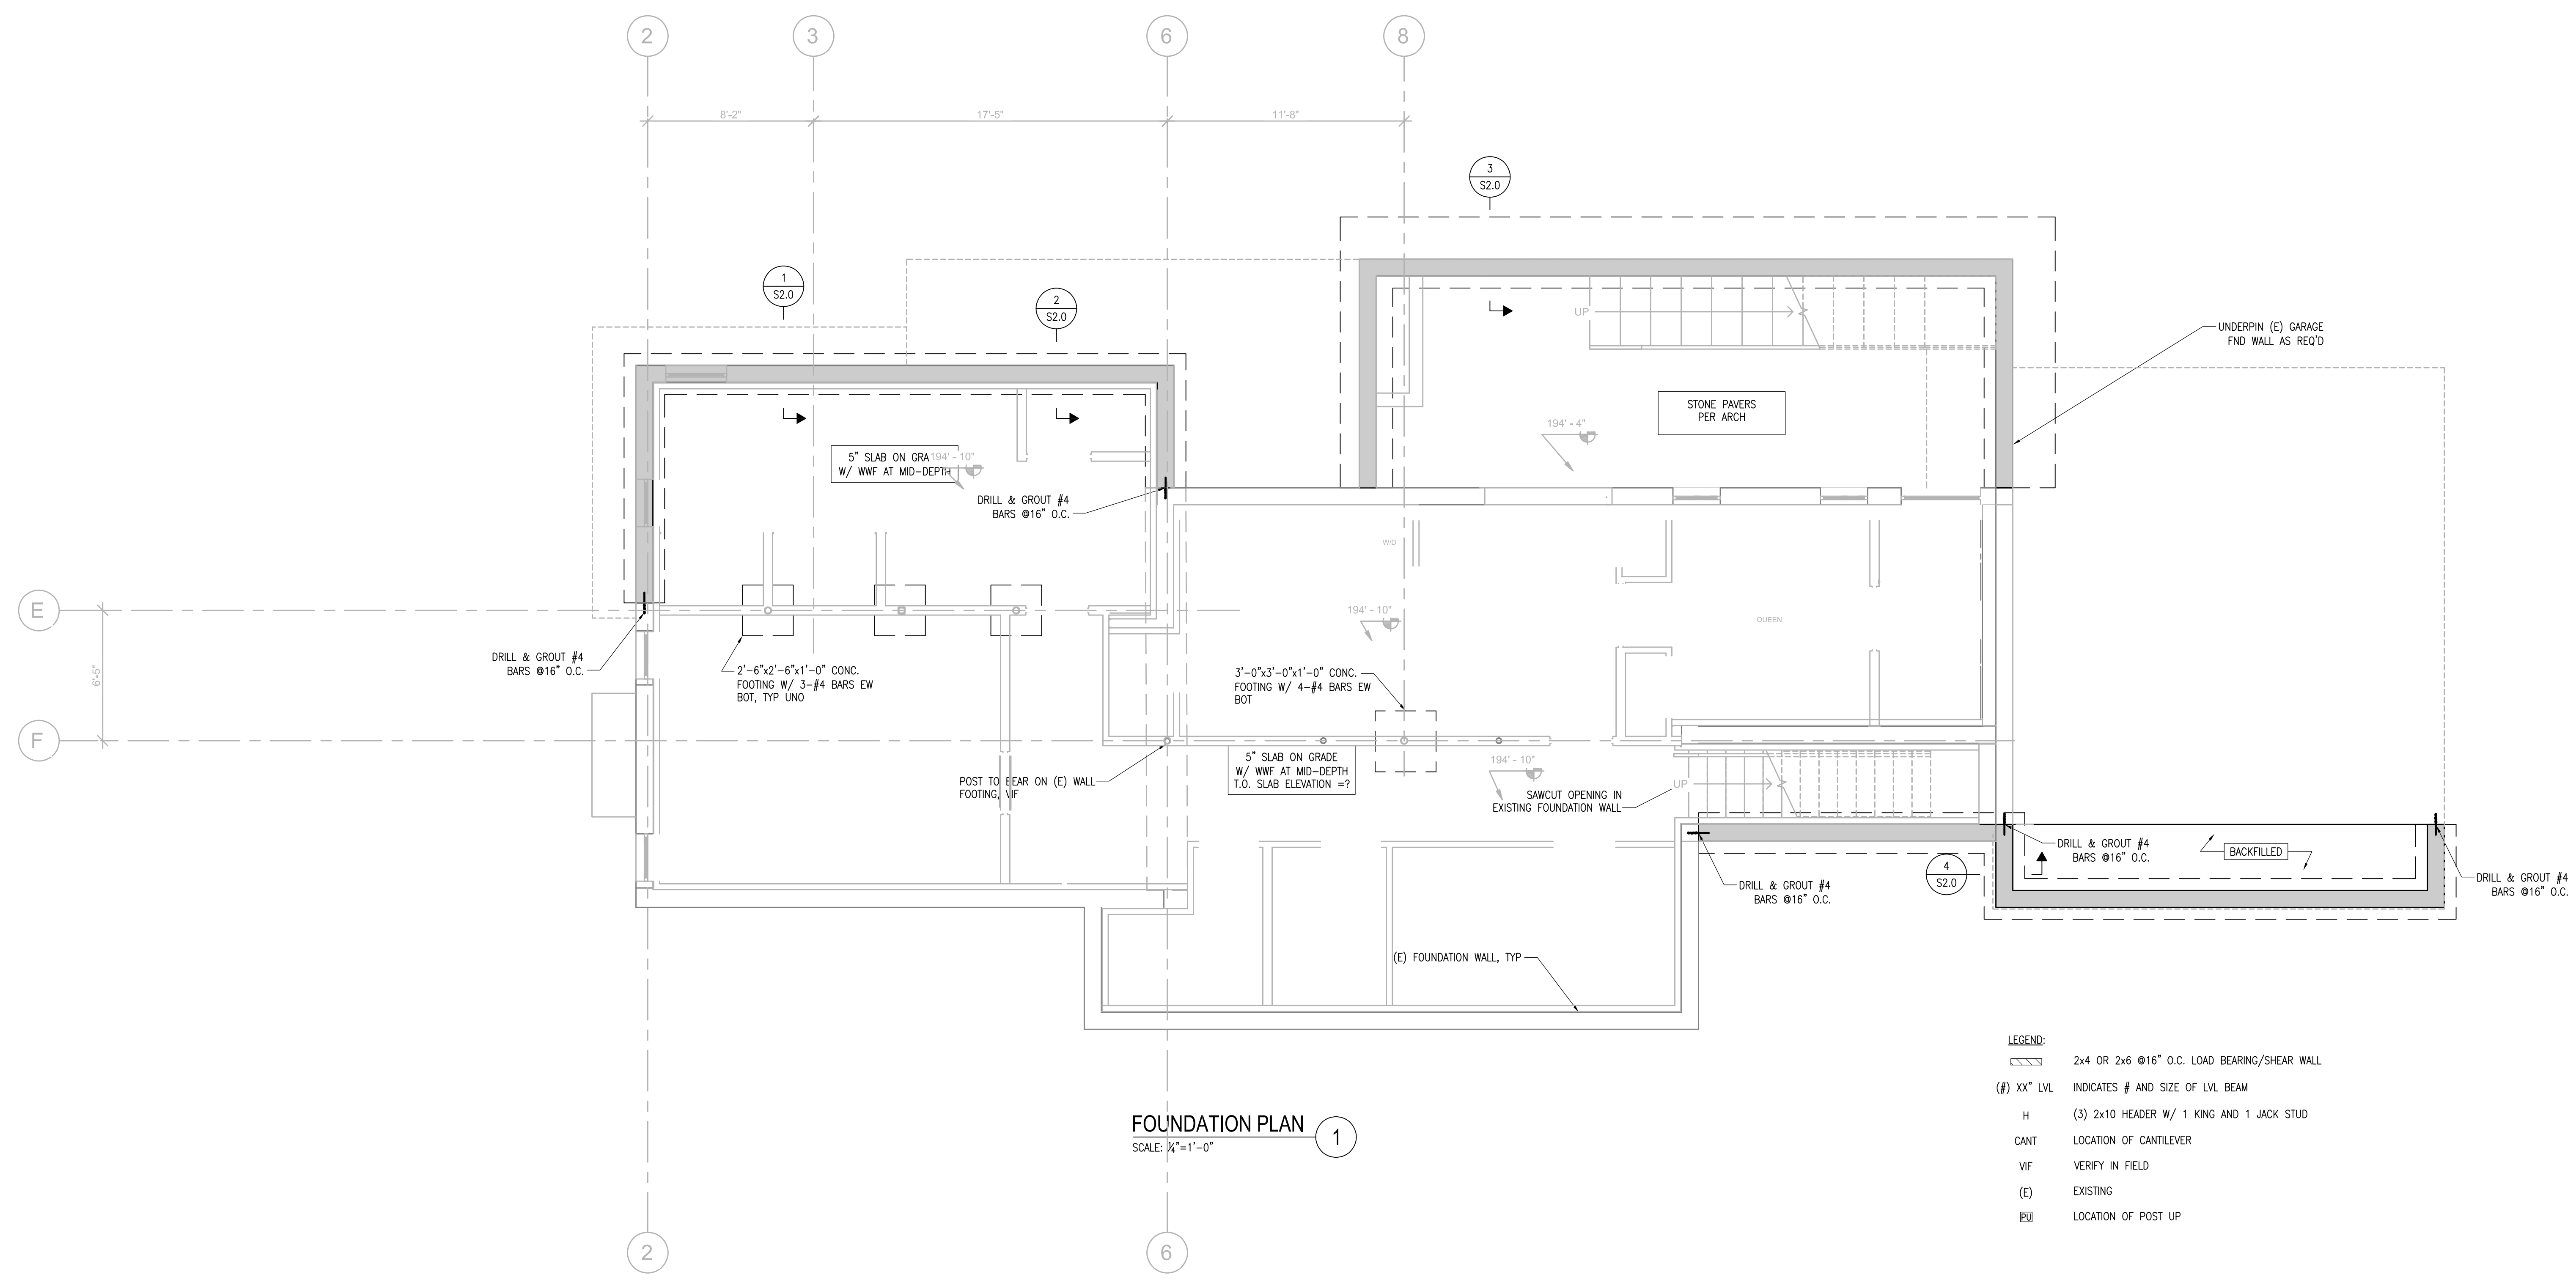

FOUNDATION PLAN
SCALE: 1/4"=1'-0"

- LEGEND:**
- 2x4 OR 2x6 @16" O.C. LOAD BEARING/SHEAR WALL
 - (XX)" LVL INDICATES # AND SIZE OF LVL BEAM
 - H (3) 2x10 HEADER W/ 1 KING AND 1 JACK STUD
 - CANT LOCATION OF CANTILEVER
 - WF VERIFY IN FIELD
 - (E) EXISTING
 - LOCATION OF POST UP

- NOTES:**
1. ALL EXTERIOR FOOTINGS SHALL BE 4'-0" BELOW FINAL GRADE.
 2. SEE ARCH DWGS FOR FLOOR ELEVATIONS.


REVISION HISTORY

NO.	DESCRIPTION	DATE

CONSTRUCTION DOCUMENTS

DATE:	AUG 16, 2023
SCALE:	As Indicated
DRAWN BY:	EAC
CHECKED BY:	SW

SHEET TITLE	PROJECT #
FOUNDATION PLAN	4005

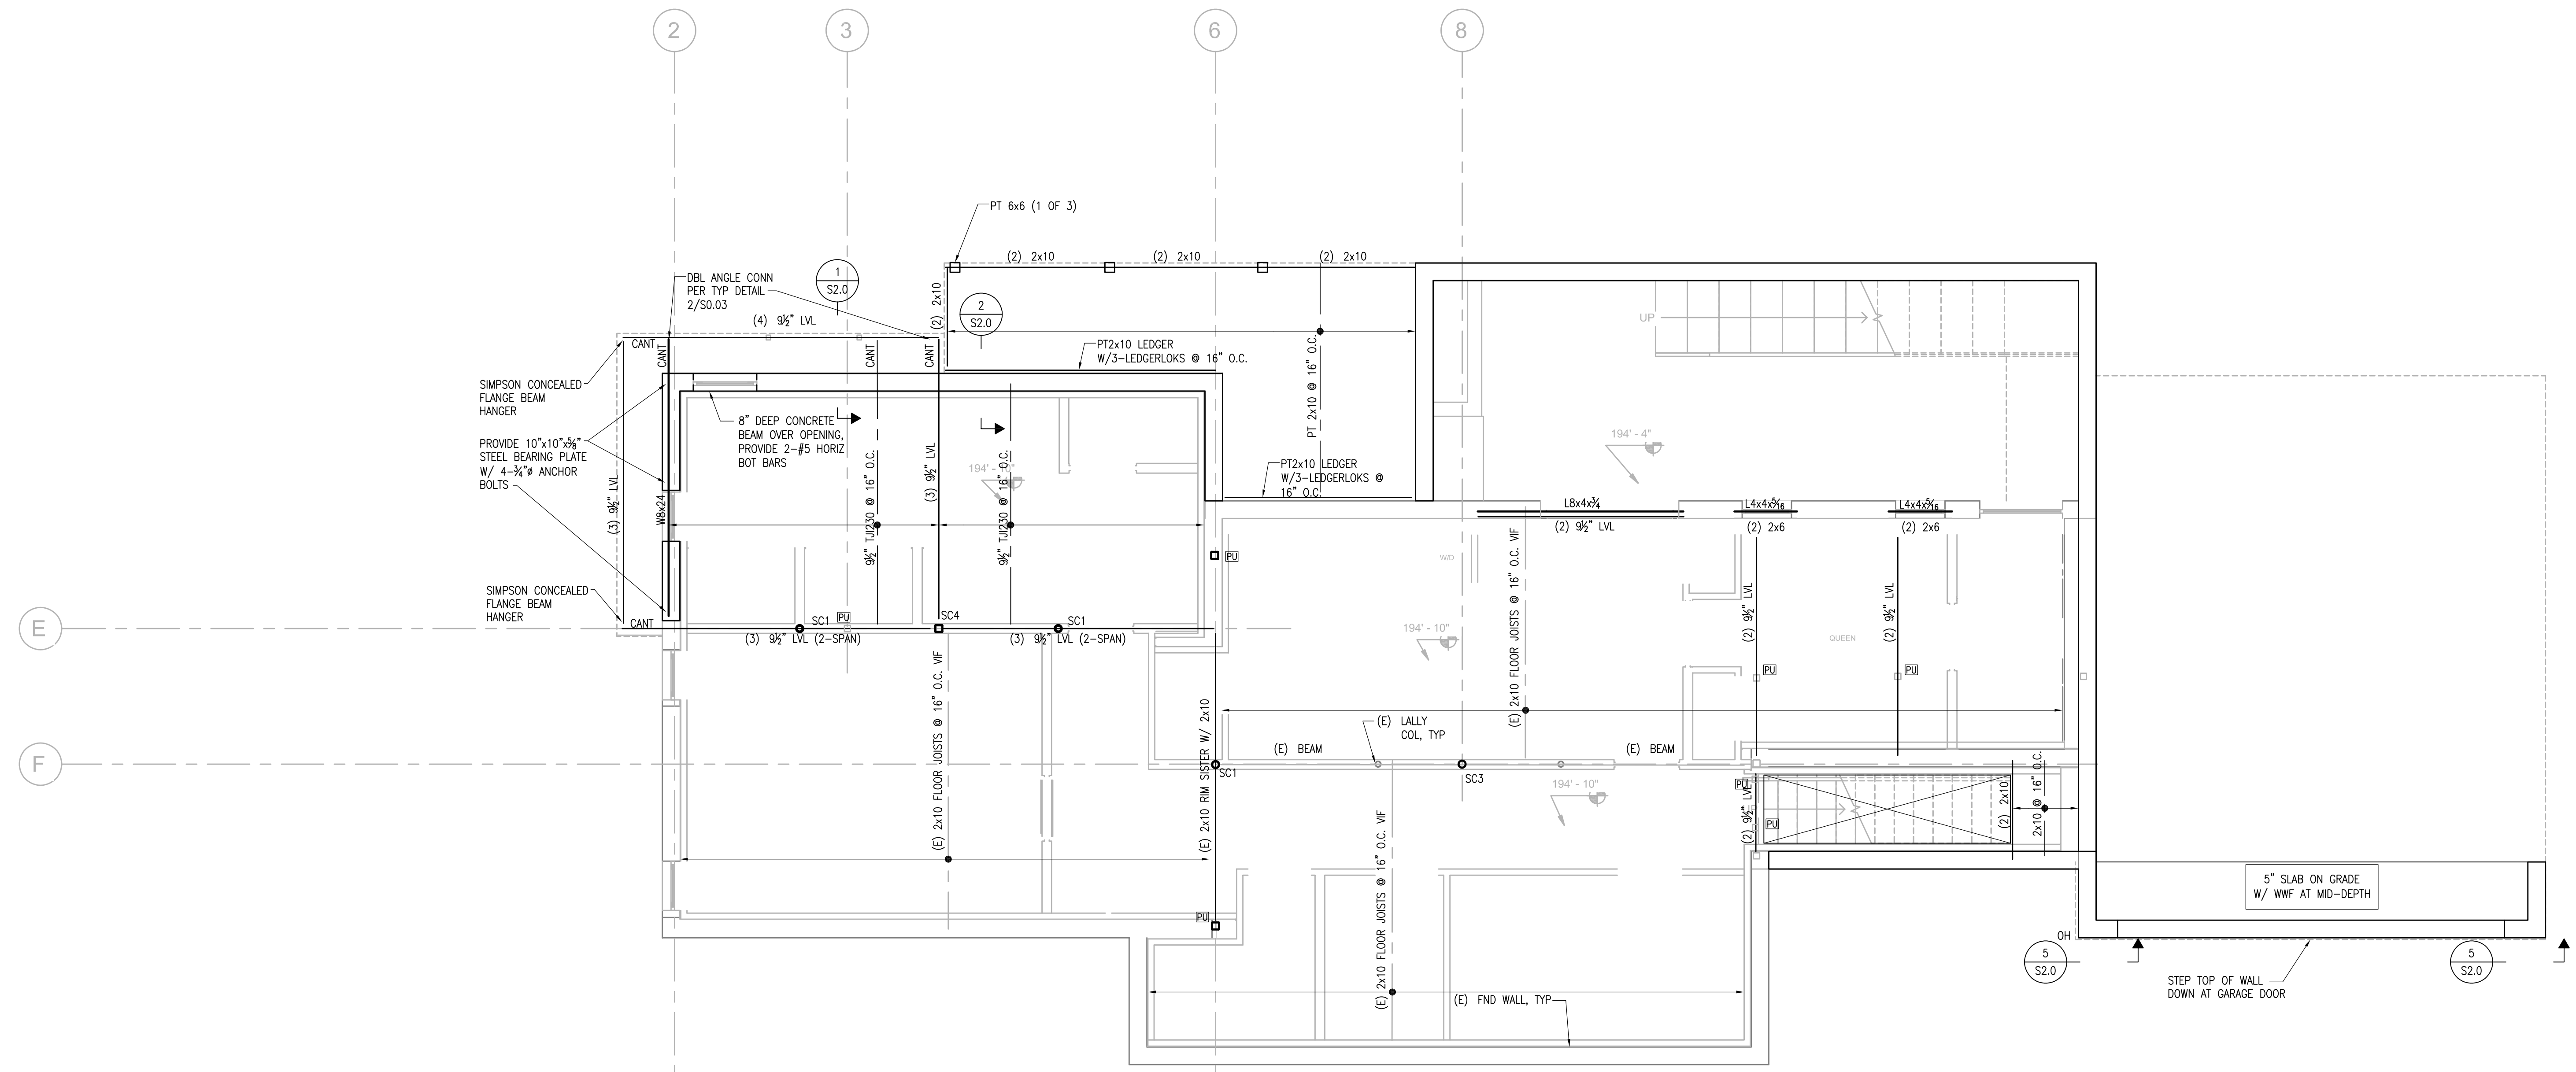

FIRST FLOOR FRAMING PLAN
 SCALE: 1/4"=1'-0"

LEGEND:

- (#) XX" LVL INDICATES # AND SIZE OF LVL BEAM
- H (3) 2x10 HEADER W/ 1 KING AND 1 JACK STUD
- CANT LOCATION OF CANTILEVER
- VF VERIFY IN FIELD
- (E) EXISTING
- PU LOCATION OF POST UP

WOOD COLUMN SCHEDULE	
MARK	SIZE
C1	(2) 2x4
C2	(2) 2x6
C3	3/4" x 3/4" PSL
C4	3/4" x 3/4" PSL
C5	5/4" x 3/4"
C6	5/4" x 7" PSL

STEEL COLUMN SCHEDULE	
MARK	SIZE
SC1	3/4" CONCRETE FILLED LALLY COLUMN
SC2	HSS2.5x2.5x1/4"
SC3	3/4" STD STEEL PIPE
SC4	HSS4x4x1/4"
SC5	HSS5x5x1/4"
SC6	HSS6x6x1/4"

- NOTES:**
- ALL INDIVIDUAL LVLS ARE 1 1/2" THICK.
 - BEAMS DESIGNATED AS (LOW) ARE AT LIVING ROOM LEVEL. BEAMS DESIGNATED AS (HIGH) ARE AT ENTRY LEVEL.
 - ALL BEAMS FLUSH FRAMED WITH SIMPSON JOIST HANGERS, UNO.
 - ALL WOOD BEAMS ON WOOD POSTS REQUIRE SIMPSON CONNECTOR.
 - PROVIDE SIMPSON HDUS-SDS2.5 HOLDDOWN AT EACH END OF LOAD-BEARING/SHEAR WALL. IF THERE IS A BEAM BELOW, PROVIDE (2) SIMPSON MSTC48B3 PRE-BENT STRAP TIES.
 - ALL EXTERIOR WALLS SHALL BE SW1, UNO.

REVISION HISTORY


NO.	DESCRIPTION	DATE

CONSTRUCTION DOCUMENTS

DATE: AUG 16, 2023
 SCALE: As Indicated
 DRAWN BY: EAC
 CHECKED BY: BW

SHEET TITLE PROJECT # 4005

FIRST FLOOR FRAMING PLAN

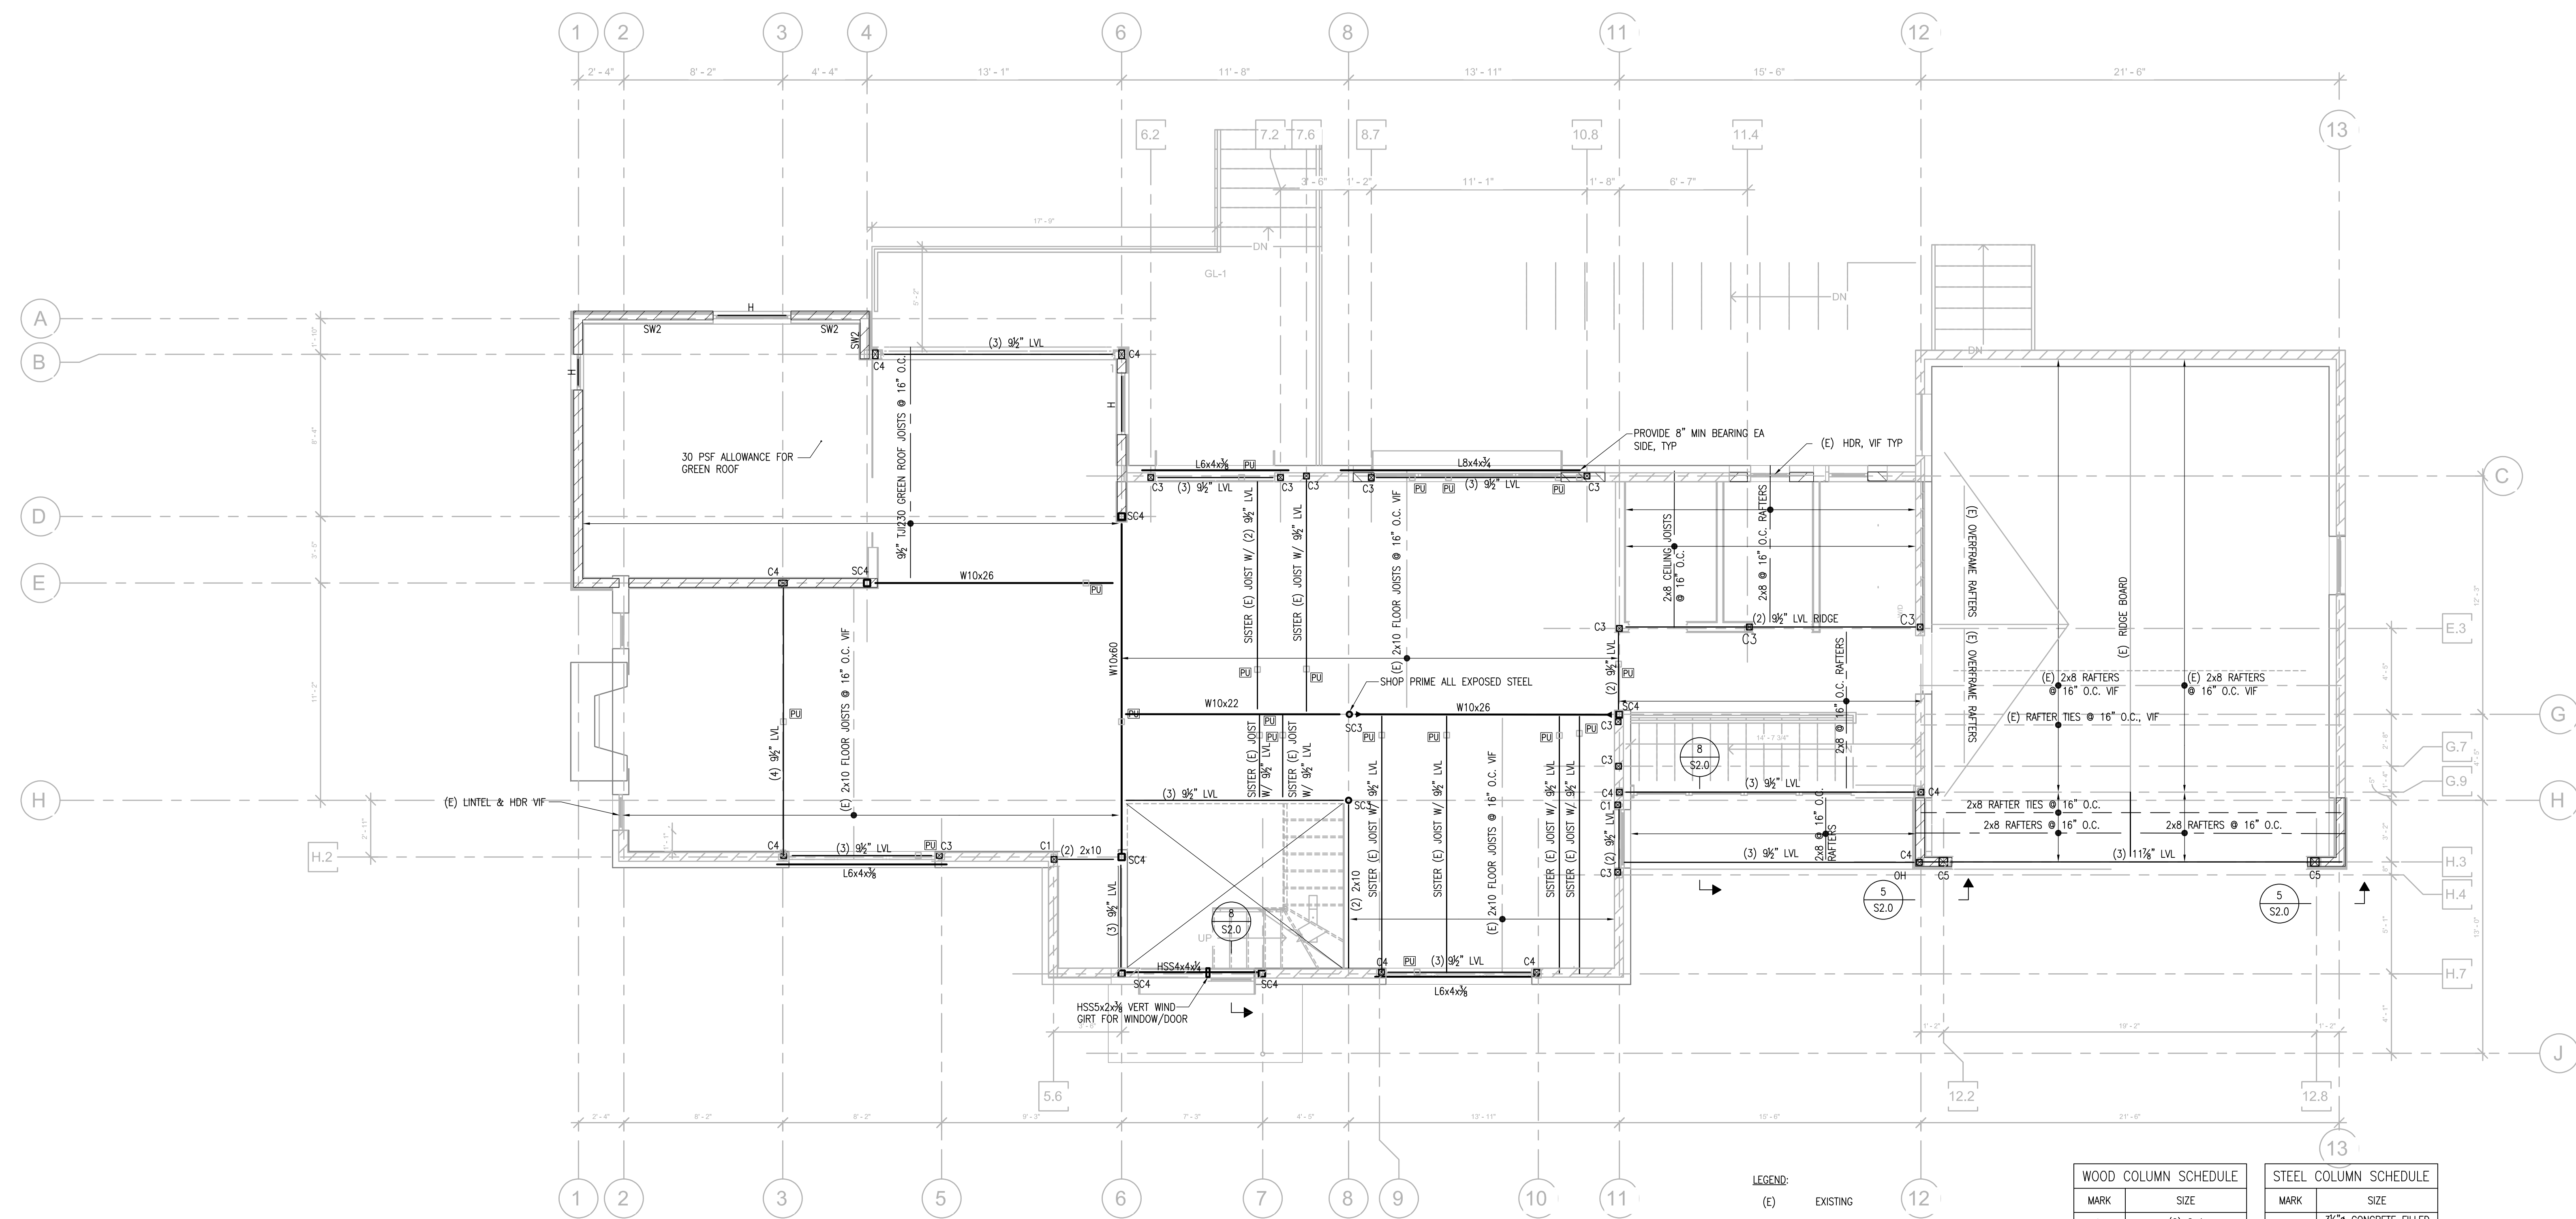

SECOND FLOOR FRAMING PLAN
SCALE: 1/8"=1'-0"

- LEGEND:**
- (E) EXISTING
 - (E) 2x4 @ 16" O.C. LOAD BEARING/SHEAR WALL
 - 2x4 OR 2x6 @ 16" O.C. LOAD BEARING/SHEAR WALL
 - (#) XX" LVL INDICATES # AND SIZE OF LVL BEAM
 - H (3) 2x10 HEADER W/ 1 KING AND 1 JACK STUD
 - CANT LOCATION OF CANTILEVER
 - VIF VERIFY IN FIELD
 - PU LOCATION OF POST UP
 - MOMENT CONNECTION

- NOTES:**
1. ALL INDIVIDUAL LVLS ARE 1 1/2" THICK.
 2. BEAMS DESIGNATED AS (LOW) ARE AT LIVING ROOM LEVEL. BEAMS DESIGNATED AS (HIGH) ARE AT ENTRY LEVEL.
 3. ALL BEAMS FLUSH FRAMED WITH SIMPSON JOIST HANGERS, UNO.
 4. ALL WOOD BEAMS ON WOOD POSTS REQUIRE SIMPSON CONNECTOR.
 5. PROVIDE SIMPSON HDUS-SDS2.5 HOLD-DOWN AT EACH END OF LOAD-BEARING/SHEAR WALL. IF THERE IS A BEAM BELOW, PROVIDE (2) SIMPSON MSTC48B3 PRE-BENT STRAP TIES.
 6. ALL EXTERIOR WALLS SHALL BE SW1, UNO.

WOOD COLUMN SCHEDULE	
MARK	SIZE
C1	(2) 2x4
C2	(2) 2x6
C3	3 1/2" x 3 1/2" PSL
C4	3 1/2" x 3 1/2" PSL
C5	5 1/2" x 5 1/2" PSL
C6	5 1/2" x 7" PSL

STEEL COLUMN SCHEDULE	
MARK	SIZE
SC1	3/8" CONCRETE FILLED LALLY COLUMN
SC2	NOT USED
SC3	3/8" STD STEEL PIPE
SC4	HSS4x4x1/2

SHEAR WALL SCHEDULE							
MARK	BLOCKED	SHEATHING	S1 (E.N.)	S2 (F.N.)	SHEAR TRANSFER AT TOP PLATE	SILL PLATE NAILING	CAPACITY (PLF)
SW1	YES	1/2" PLYWOOD, 1 SIDE	10d @ 6" O.C.	10d @ 12" O.C.	A35 CLIP @ 16" O.C.	16d @ 4" O.C.	VALL= 422
SW2	YES	1/2" PLYWOOD, 1 SIDES	10d @ 4" O.C.	10d @ 12" O.C.	A35 CLIP @ 9" O.C.	16d @ 3" O.C.	VALL = 715


REVISION HISTORY		
NO.	DESCRIPTION	DATE

CONSTRUCTION DOCUMENTS		
DATE	DESCRIPTION	DATE
AUG 16, 2023	As indicated	
	EAC	
	BW	

SHEET TITLE PROJECT # 4005

SECOND FLOOR FRAMING PLAN

S1.12

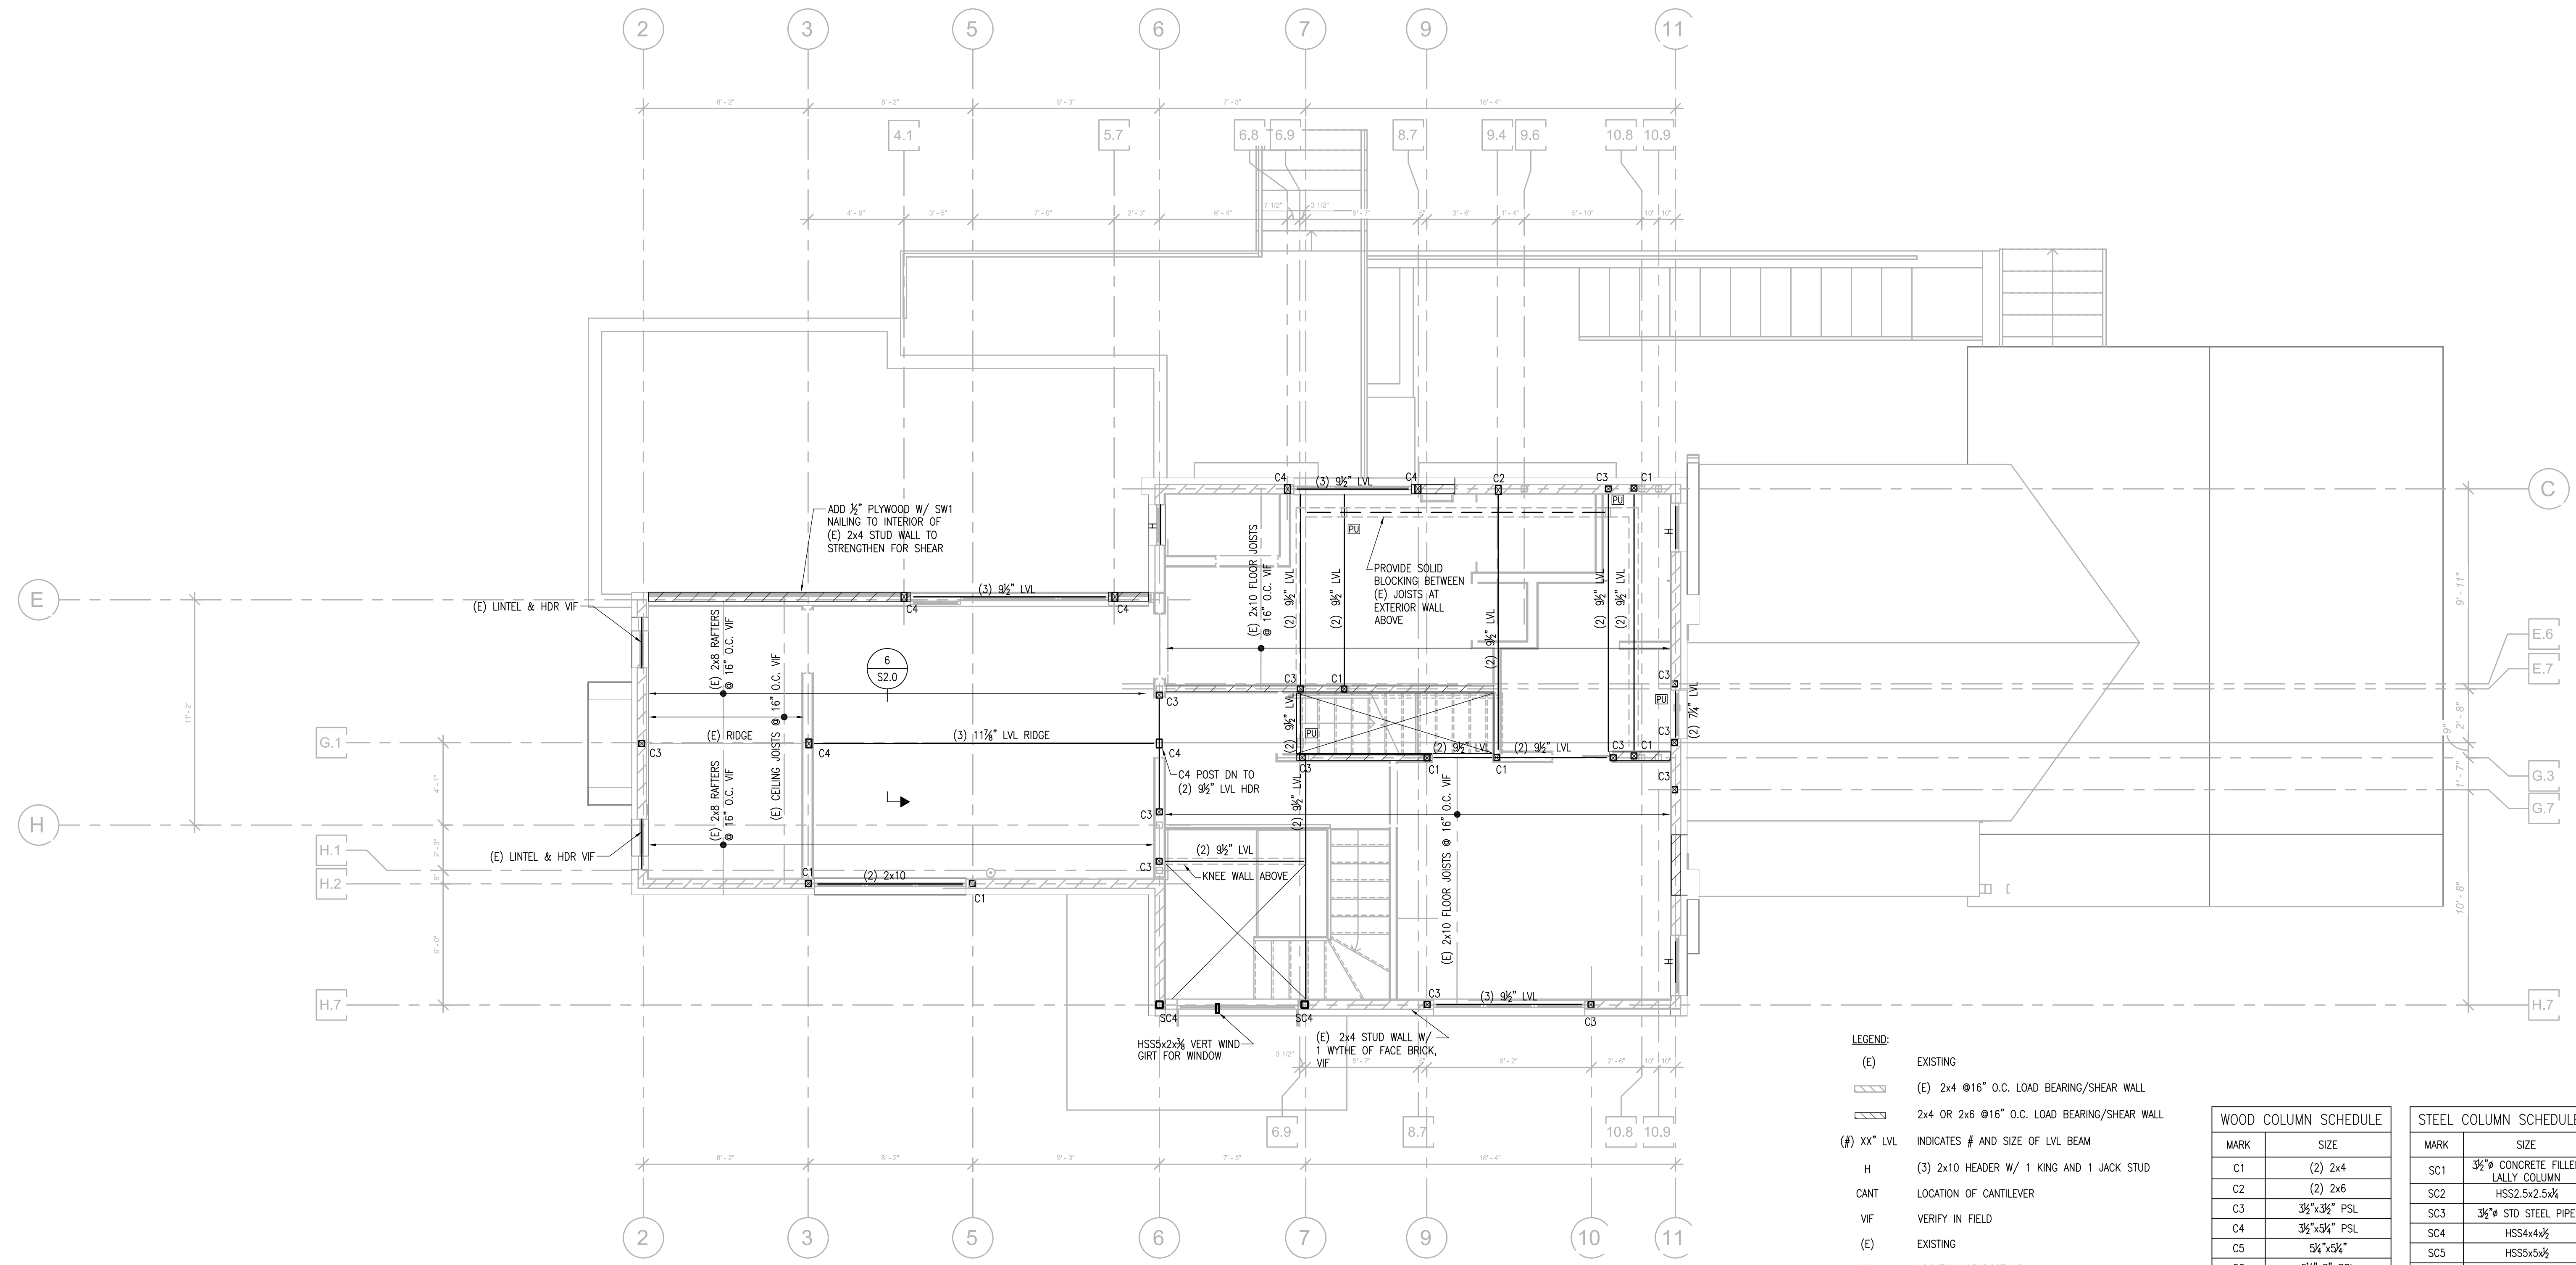

THIRD FLOOR FRAMING PLAN
 SCALE: 1/4"=1'-0"

- LEGEND:**
- (E) EXISTING
 - (E) 2x4 @16" O.C. LOAD BEARING/SHEAR WALL
 - 2x4 OR 2x6 @16" O.C. LOAD BEARING/SHEAR WALL
 - (B) XX" LVL INDICATES # AND SIZE OF LVL BEAM
 - H (3) 2x10 HEADER W/ 1 KING AND 1 JACK STUD
 - CANT LOCATION OF CANTILEVER
 - VF VERIFY IN FIELD
 - (E) EXISTING
 - (P) LOCATION OF POST UP
 - ▶ MOMENT CONNECTION

WOOD COLUMN SCHEDULE	
MARK	SIZE
C1	(2) 2x4
C2	(2) 2x6
C3	3/4"x3/4" PSL
C4	3/4"x3/4" PSL
C5	5/8"x3/4"
C6	5/8"x7" PSL

STEEL COLUMN SCHEDULE	
MARK	SIZE
SC1	3/4" CONCRETE FILLED LALLY COLUMN
SC2	HSS2.5x2.5x1/4
SC3	3/4" STD STEEL PIPE
SC4	HSS4x4x1/2
SC5	HSS5.5x5 1/2
SC6	HSS6x6x1/2


- NOTES:**
- ALL INDIVIDUAL LVLS ARE 1 1/2" THICK.
 - BEAMS DESIGNATED AS (LOW) ARE AT LIVING ROOM LEVEL. BEAMS DESIGNATED AS (HIGH) ARE AT ENTRY LEVEL.
 - ALL BEAMS FLUSH FRAMED WITH SIMPSON JOIST HANGERS, UNO.
 - ALL WOOD BEAMS ON WOOD POSTS REQUIRE SIMPSON CONNECTOR.
 - PROVIDE SIMPSON HDU5-SDS2.5 HOLDDOWN AT EACH END OF LOAD-BEARING/SHEAR WALL. IF THERE IS A BEAM BELOW, PROVIDE (2) SIMPSON MSTC4B83 PRE-BENT STRAP TIES.
 - ALL EXTERIOR WALLS SHALL BE SW1, UNO.

REVISION HISTORY		
REV	DESCRIPTION	DATE

CONSTRUCTION DOCUMENTS

DATE:	AUG 16, 2023
SCALE:	As Indicated
DRAWN BY:	EAC
CHECKED BY:	BW

SHEET TITLE	PROJECT #
THIRD FLOOR FRAMING PLAN	4005

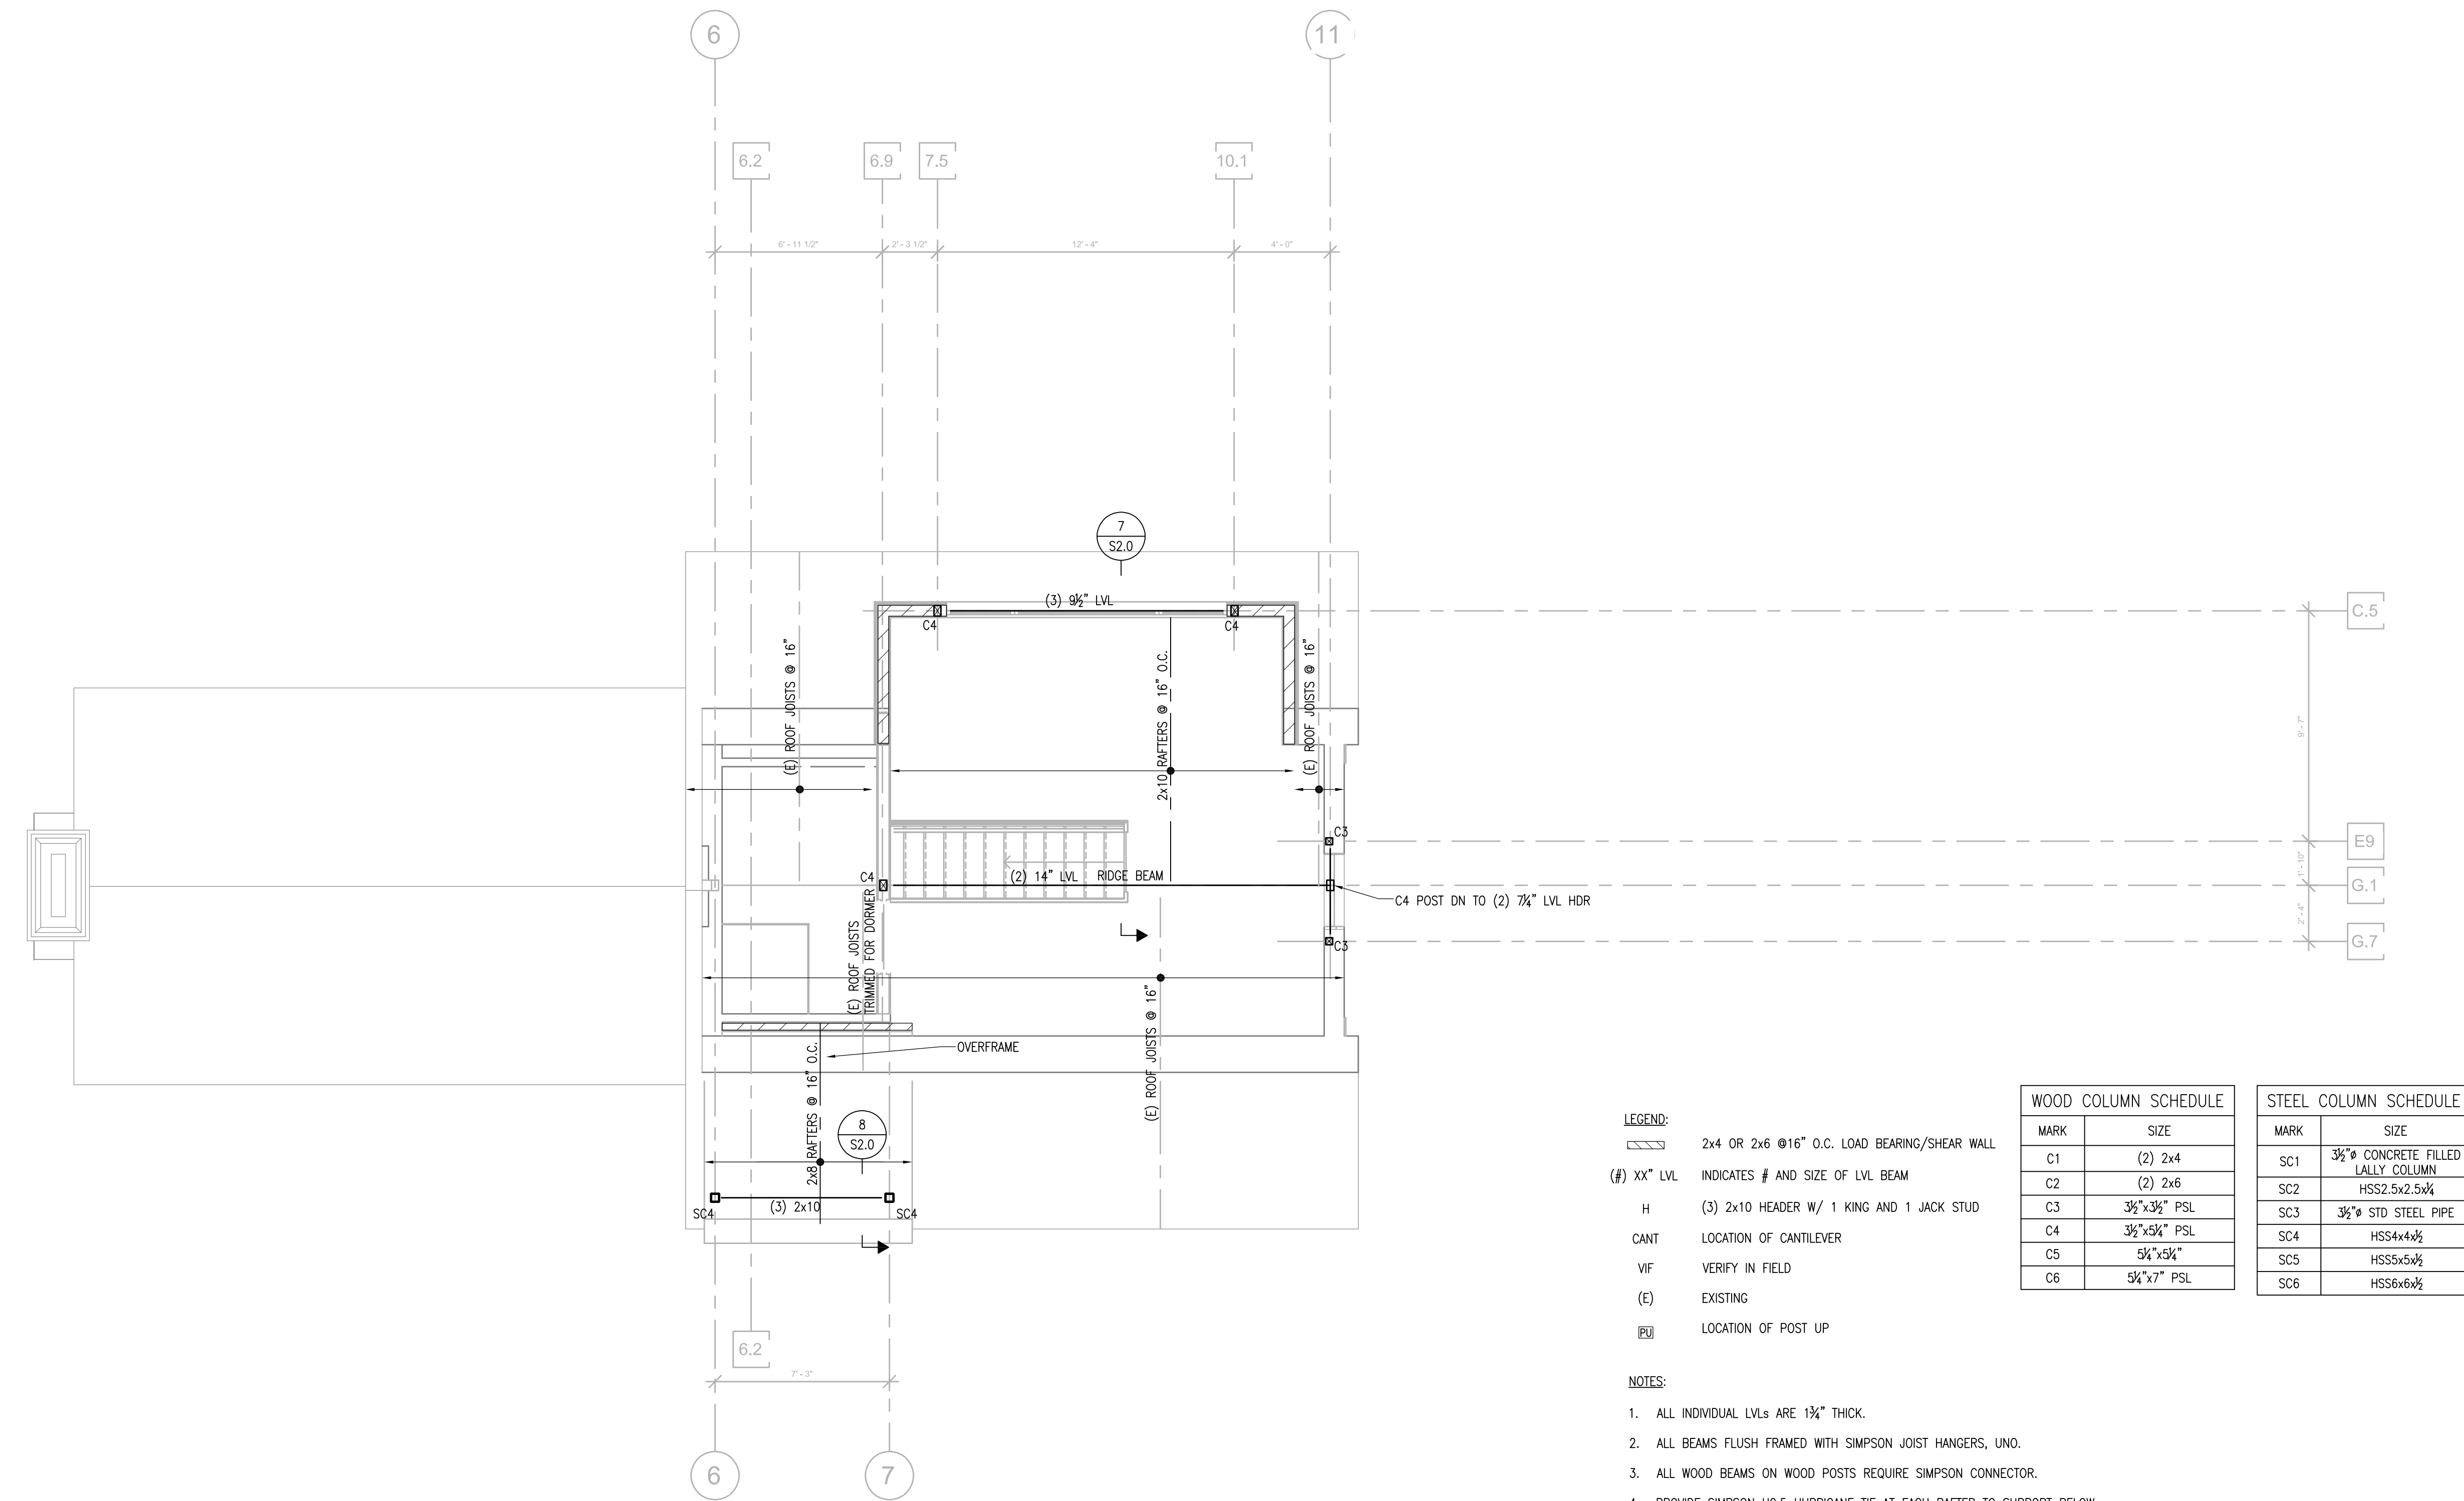

ROOF FRAMING PLAN 1
SCALE: 1/8"=1'-0"

REVISION HISTORY


NO.	DESCRIPTION	DATE

CONSTRUCTION DOCUMENTS


DATE: AUG 16, 2023
SCALE: As Indicated
DRAWN BY: EAC
CHECKED BY: SW

SHEET TITLE: PROJECT #: 4005


ROOF FRAMING PLAN

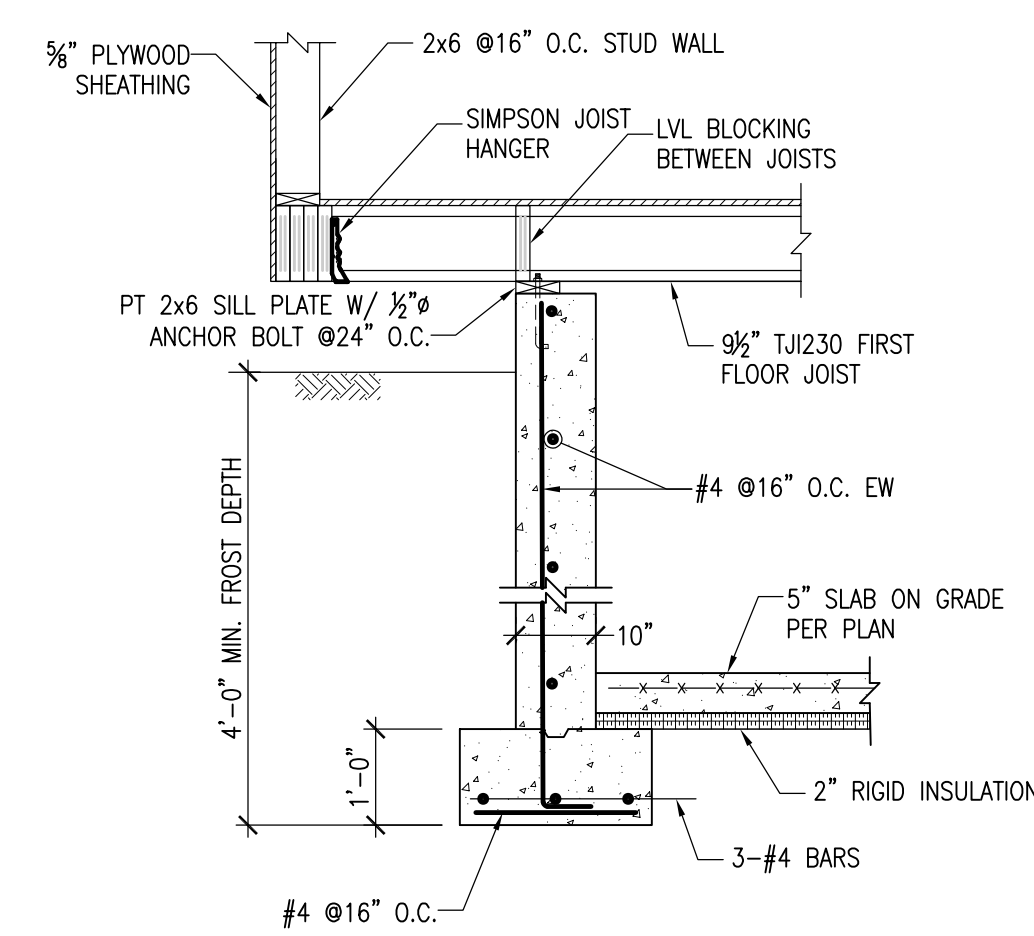


SECTION 1
SCALE: 1/2"=1'-0"

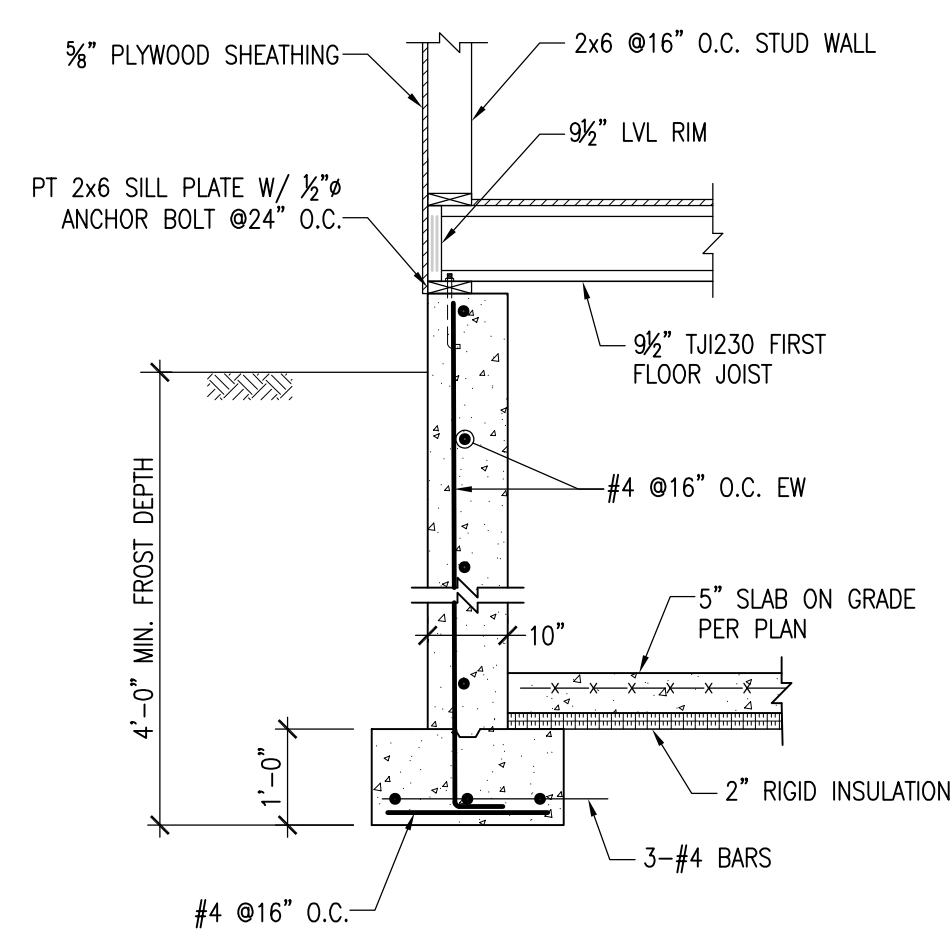


SECTION 2
SCALE: 1/2"=1'-0"

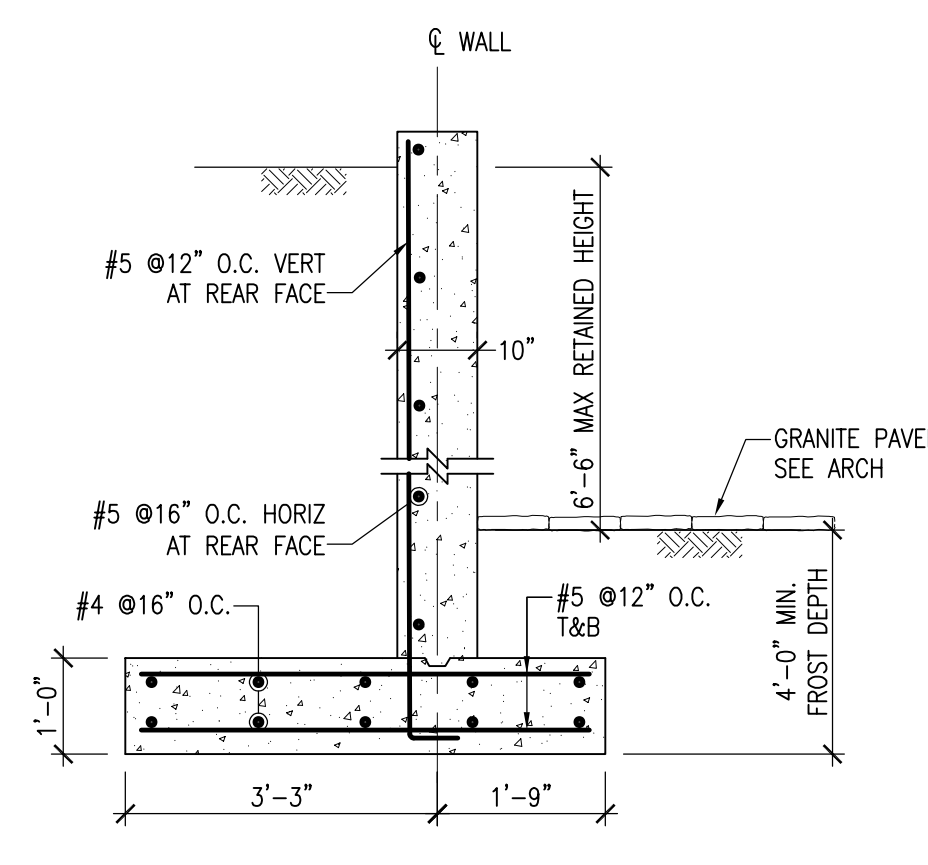


SECTION 3
SCALE: 1/2"=1'-0"

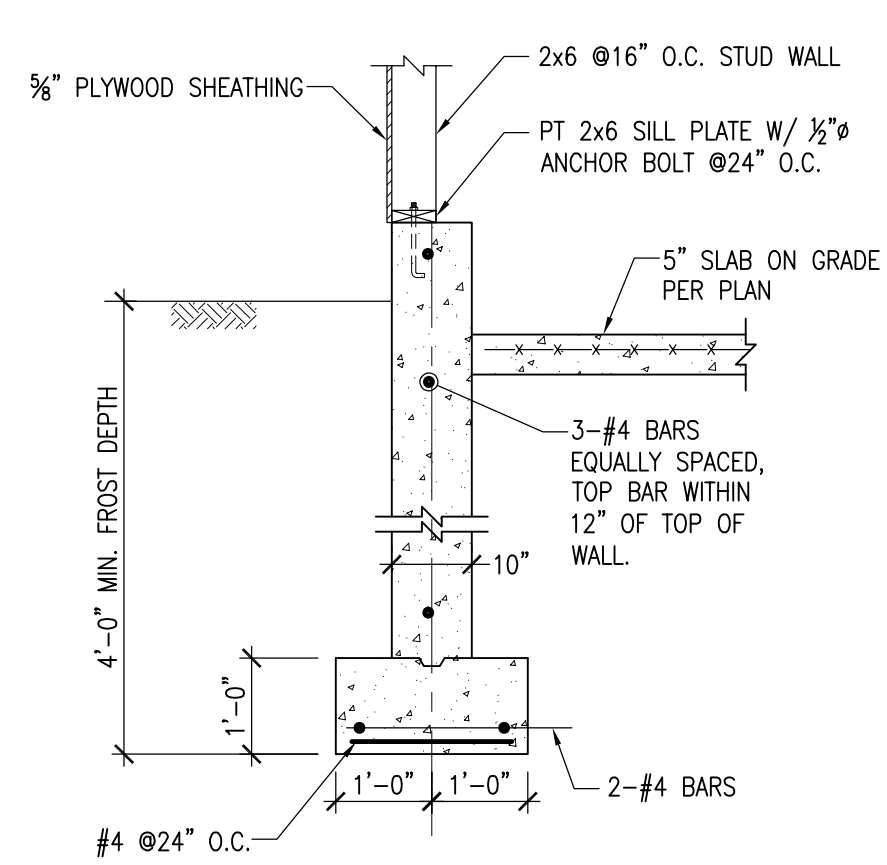


SECTION 4
SCALE: 1/2"=1'-0"

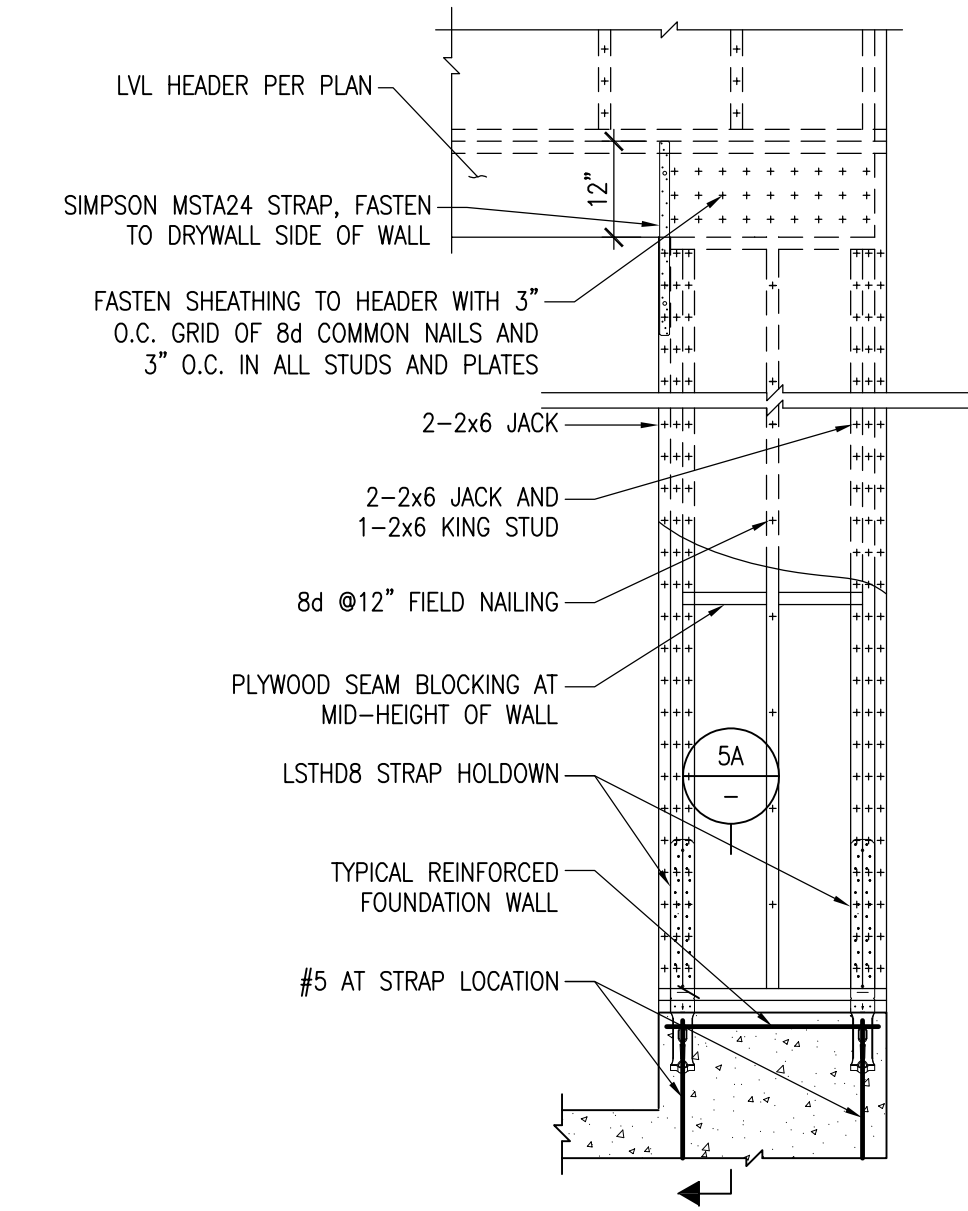


SECTION 5
SCALE: 1/2"=1'-0"

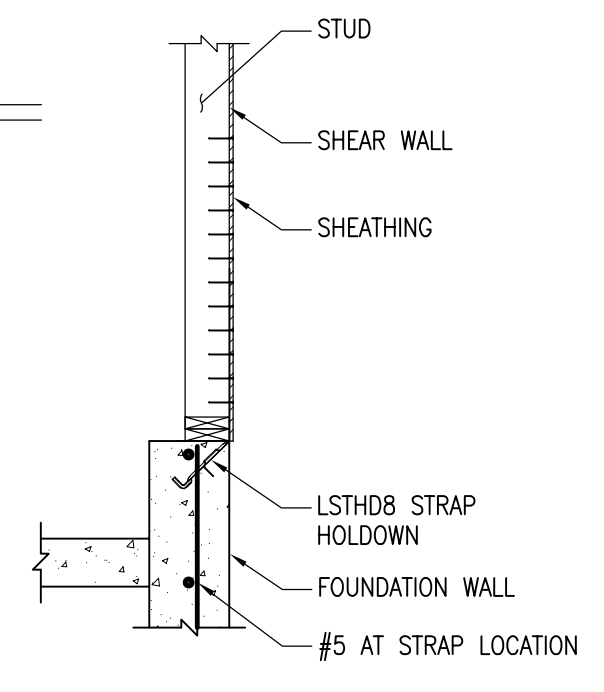


SECTION 5A
SCALE: 1/2"=1'-0"

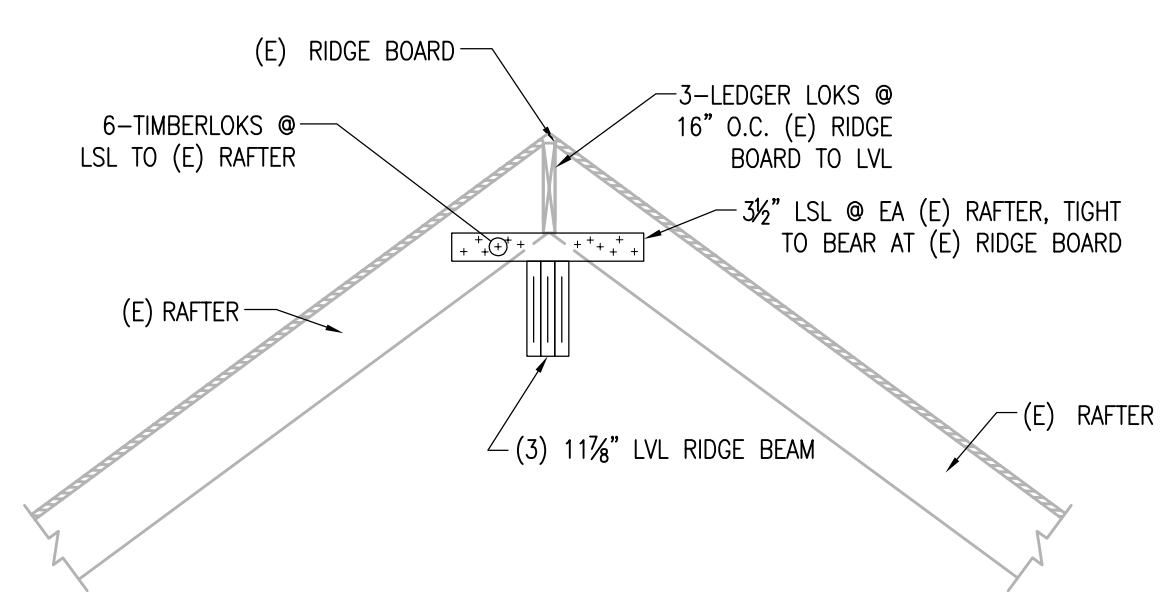


SECTION 6
SCALE: 1/2"=1'-0"

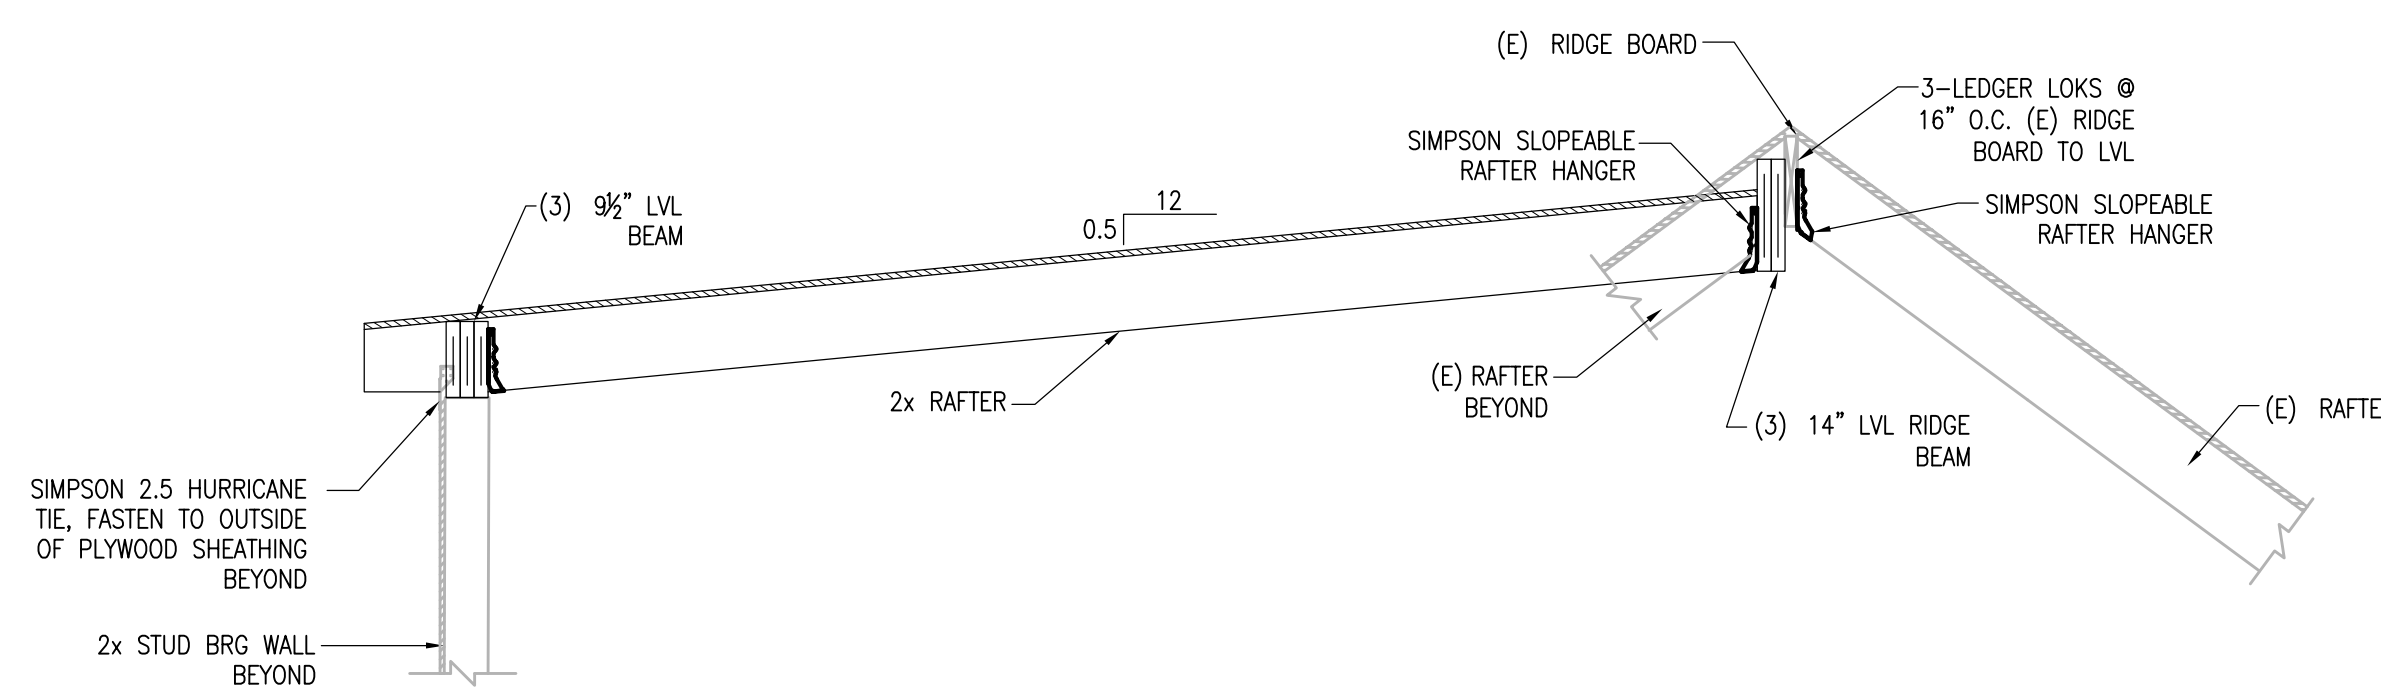

SECTION 7
SCALE: 1/2"=1'-0"

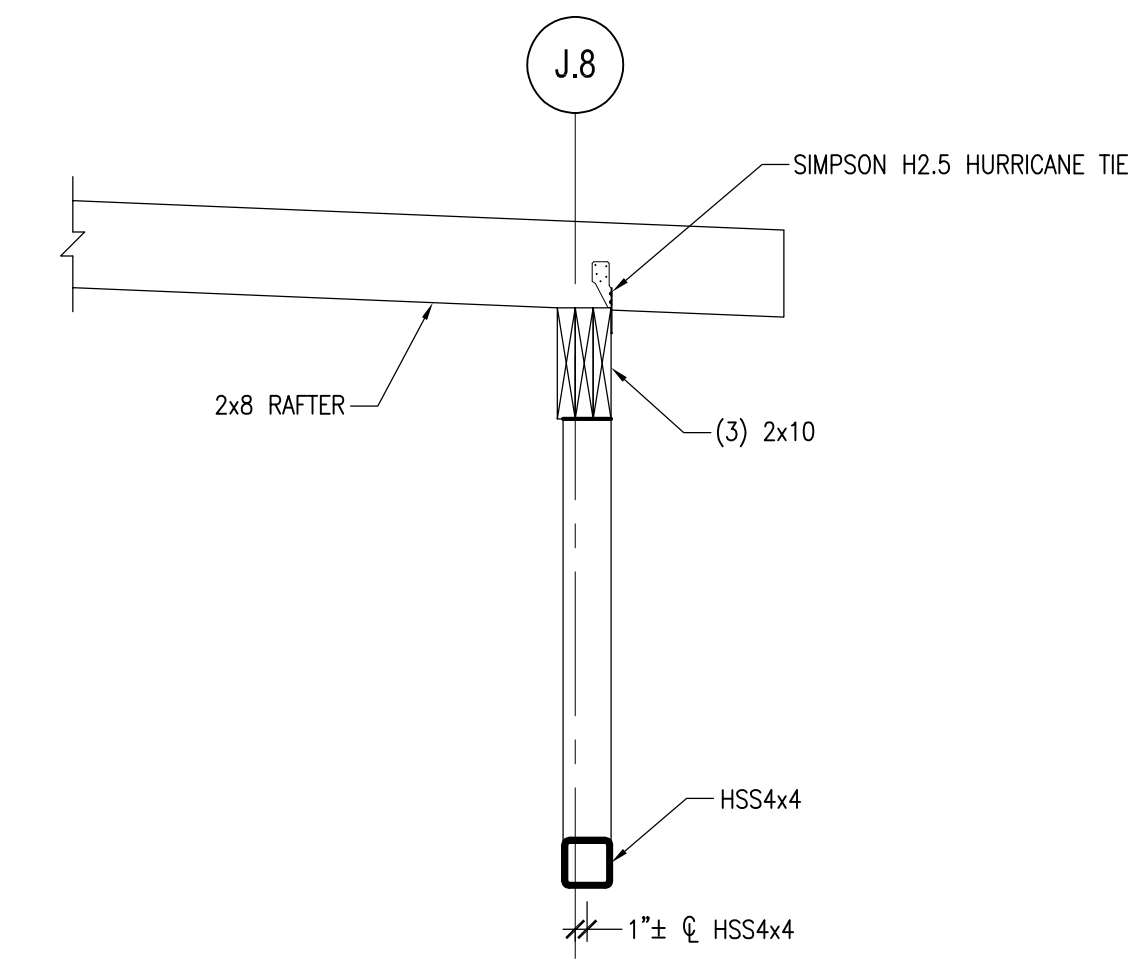

SECTION 8
SCALE: 1/2"=1'-0"

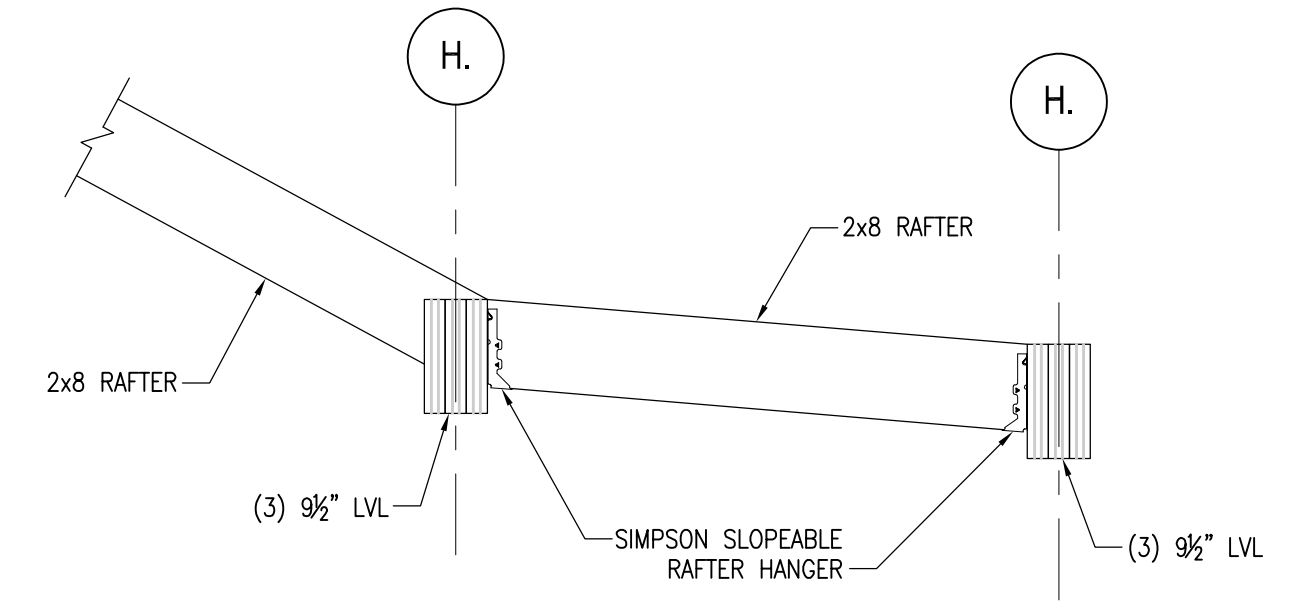



SECTION 9
SCALE: 1/2"=1'-0"

NO.	DESCRIPTION	DATE

CONSTRUCTION DOCUMENTS

DATE:	AUG 16, 2023
SCALE:	As Indicated
DRAWN BY:	EAC
CHECKED BY:	SW

SHEET TITLE	PROJECT #
SECTIONS	40035

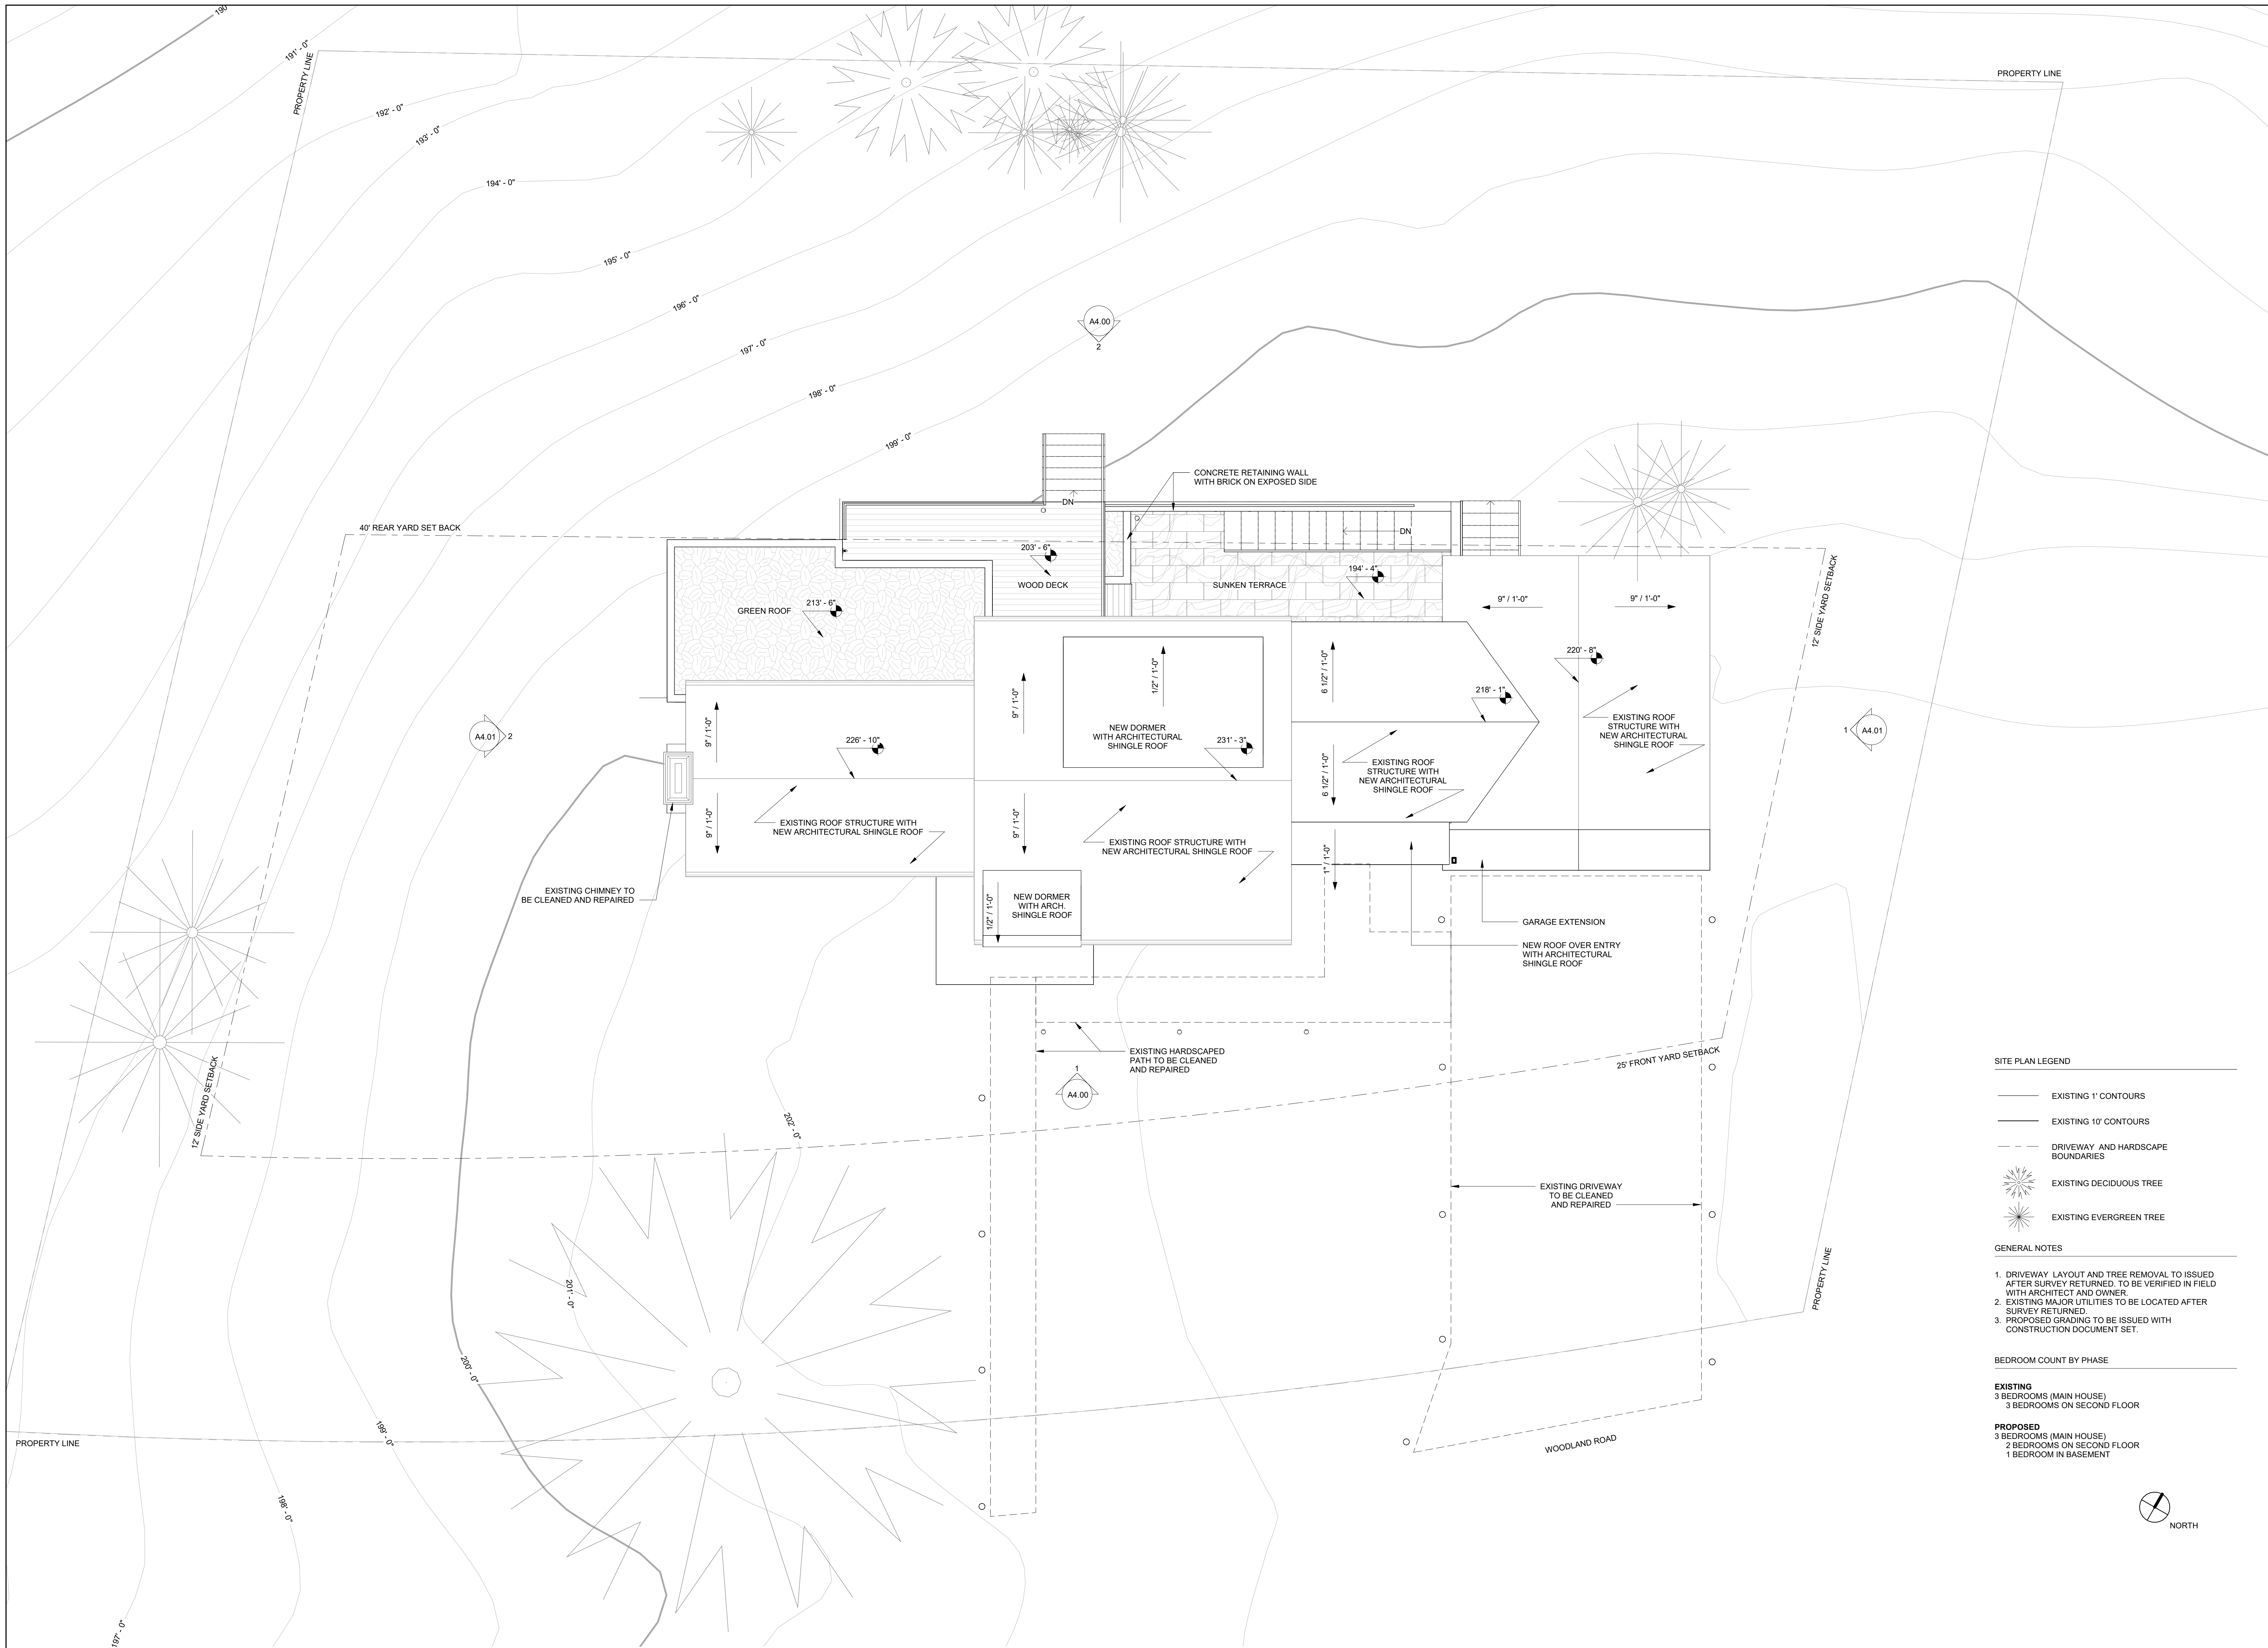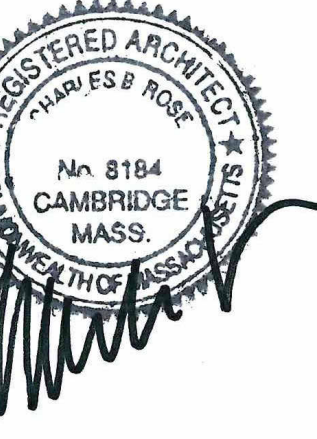

SITE PLAN LEGEND

- EXISTING 1' CONTOURS
- EXISTING 10' CONTOURS
- - - DRIVEWAY AND HARDSCAPE BOUNDARIES
- ☀ EXISTING DECIDUOUS TREE
- ☀ EXISTING EVERGREEN TREE

GENERAL NOTES

1. DRIVEWAY LAYOUT AND TREE REMOVAL TO BE ISSUED AFTER SURVEY RETURNED. TO BE VERIFIED IN FIELD WITH ARCHITECT AND OWNER.
2. EXISTING MAJOR UTILITIES TO BE LOCATED AFTER SURVEY RETURNED.
3. PROPOSED GRADING TO BE ISSUED WITH CONSTRUCTION DOCUMENT SET.

BEDROOM COUNT BY PHASE

- EXISTING**
 3 BEDROOMS (MAIN HOUSE)
 3 BEDROOMS ON SECOND FLOOR
- PROPOSED**
 3 BEDROOMS (MAIN HOUSE)
 2 BEDROOMS ON SECOND FLOOR
 1 BEDROOM IN BASEMENT



REVISION HISTORY


NO.	DESCRIPTION	DATE

PERMIT REVISION


DATE:	AUG 18, 2023
SCALE:	As indicated
DRAWN BY:	CJ
CHECKED BY:	CR

SHEET TITLE	PROJECT #
-------------	-----------

SITE PLAN

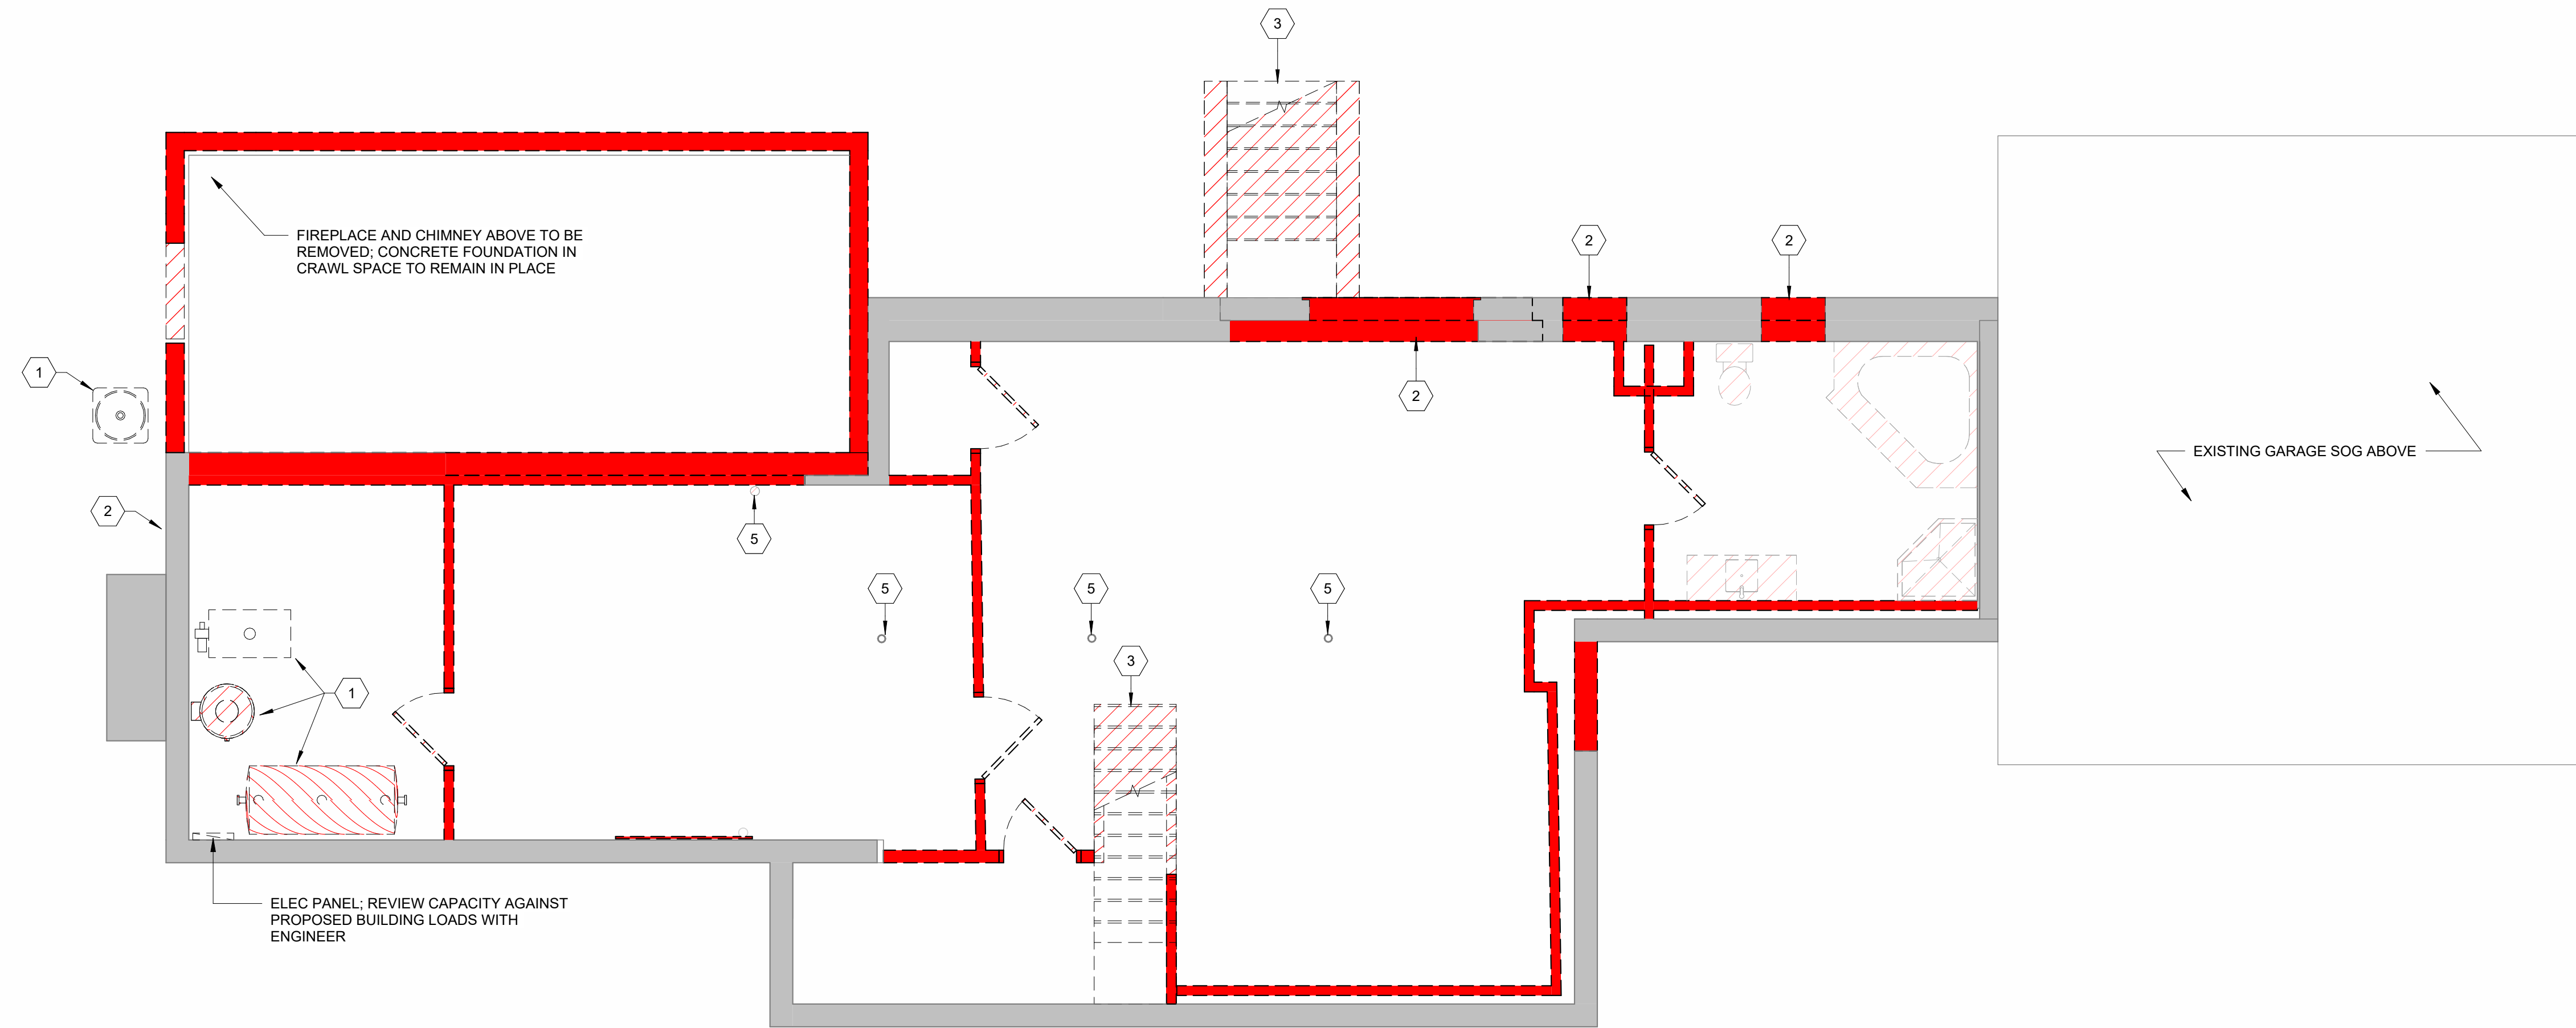

1 BASEMENT DEMO PLAN
1/4" = 1'-0"

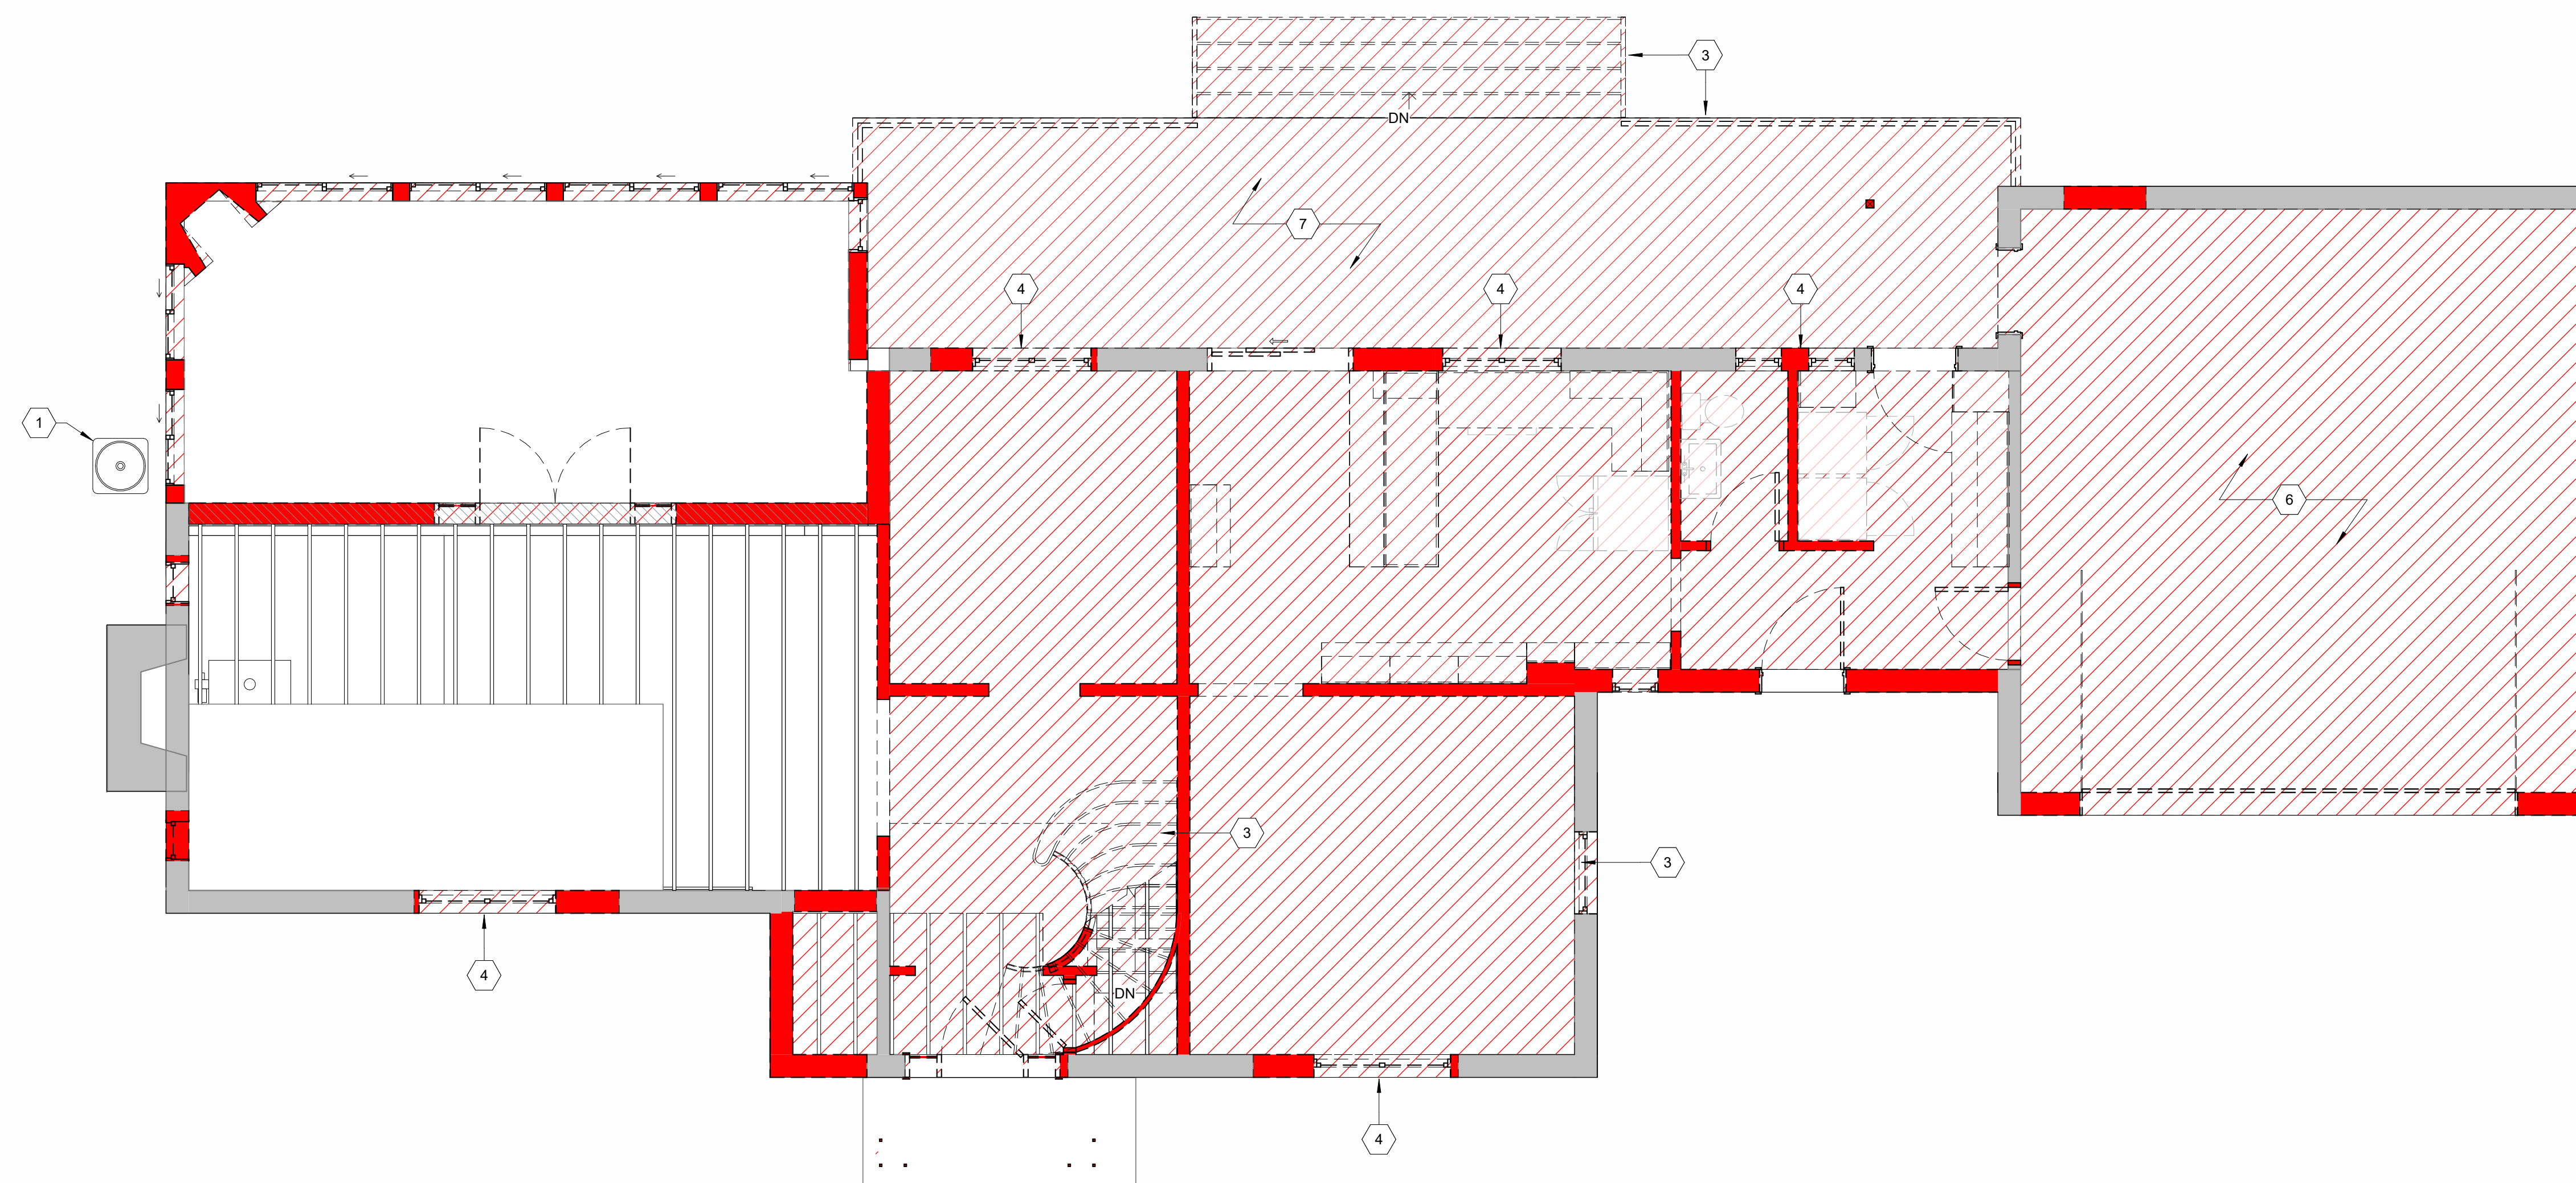

2 FIRST FLOOR DEMO PLAN
1/4" = 1'-0"

DEMOLITION NOTES

1. THE CONTRACTOR IS RESPONSIBLE FOR DAMAGE TO THE EXISTING BUILDING AND GROUNDS ARISING FROM DEMOLITION OPERATIONS.
2. DASHED LINES INDICATE EXISTING CONSTRUCTION TO BE REMOVED. REMOVE ALL CONSTRUCTION THAT CONFLICTS WITH THE INTENT OF THE NEW CONSTRUCTION. NOTIFY ARCHITECT OF ALL M.E.P. ITEMS LOCATED IN PARTITIONS OR CEILINGS NOT NOTED ON M.E.P. DRAWINGS.
3. REMOVAL OF DOORS ALSO INCLUDES REMOVAL OF DOOR FRAMES AND HARDWARE U.N.O.
4. RETURN ALL SALVAGED DOORS, FRAMES, HARDWARE, LIGHT FIXTURES AND EQUIPMENT NOT REUSED IN THIS PROJECT TO OWNER FOR REUSE ELSEWHERE.
5. REMOVE ALL EXISTING DEBRIS, ABANDONED DUCT, WIRING AND CONDUIT FROM ABOVE CEILING AREAS THAT ARE TO REMAIN.
6. LIGHTING TO BE REMOVED AND/OR RELOCATED IS INDICATED ON THE REFLECTED CEILING PLAN, OR A SEPARATE CEILING DEMOLITION PLAN.
7. RELOCATION OF EXISTING DUCTWORK TO REMAIN IN ORDER TO AVOID CONFLICT WITH NEW CONSTRUCTION IS THE RESPONSIBILITY OF THE MECHANICAL CONTRACTOR.
8. RELOCATION OF EXISTING ELECTRICAL WORK TO REMAIN IN ORDER TO AVOID CONFLICT WITH NEW CONSTRUCTION IS THE RESPONSIBILITY OF THE ELECTRICAL CONTRACTOR.
9. RELOCATION OF EXISTING PLUMBING WORK TO REMAIN IN ORDER TO AVOID CONFLICT WITH NEW CONSTRUCTION IS THE RESPONSIBILITY OF THE PLUMBING CONTRACTOR.
10. NOTIFY ARCHITECT OF ALL NOTICEABLE DEFECTS IN EXISTING CONSTRUCTION PRIOR TO BEGINNING DEMOLITION OPERATIONS, AS WELL AS DEFECTS UNCOVERED DURING DEMOLITION OPERATIONS.
11. REMOVE ELECTRICAL BOXES, WIRING AND CONDUIT IN DEMOLISHED PARTITIONS BACK TO THEIR RESPECTIVE PANELS, UNLESS INDICATED TO BE REROUTED.
12. ELECTRICAL BOXES TO BE REMOVED FROM PARTITIONS TO REMAIN ARE INDICATED ON THE PLANS. REMOVE DEVICES AND REPAIR PARTITION, READY TO RECEIVE NEW FINISHES.


DEMOLITION DRAWING LEGEND

- █ EXISTING WALL TO BE DEMOLISHED
- ▨ EXISTING SURFACE/FINISH TO BE DEMOLISHED
- █ EXISTING WALLS TO REMAIN
- NEW WALLS


DEMOLITION KEYNOTES

- ① REMOVE EXISTING MECHANICAL EQUIPMENT
- ② CUT OPENING IN EXISTING CONCRETE WALL, COORDINATE CLEAR DIM WITH WINDOW SCHEDULE AND STRUC.
- ③ REMOVE EXISTING STAIR, INCL. RAILS, TREADS, STRUCTURE
- ④ CUT OPENING IN EXISTING MASONRY WALL, COORDINATE CLEAR DIM WITH WINDOW SCHEDULE AND STRUC; PROVIDE CLEAN, TRUE AND PLUMB R.G. FOR WINDOW INSTAL
- ⑤ PROTECT EXISTING COLUMNS TO REMAIN DURING DEMOLITION. CLEAN SURFACE TO SP-3 TO PREP FOR PAINT.
- ⑥ REMOVE EXISTING CONCRETE SLAB; PREP FOR NEW CONCRETE SLAB
- ⑦ REMOVE EXISTING DECK

ORTHOGRAPHIC VIEWS

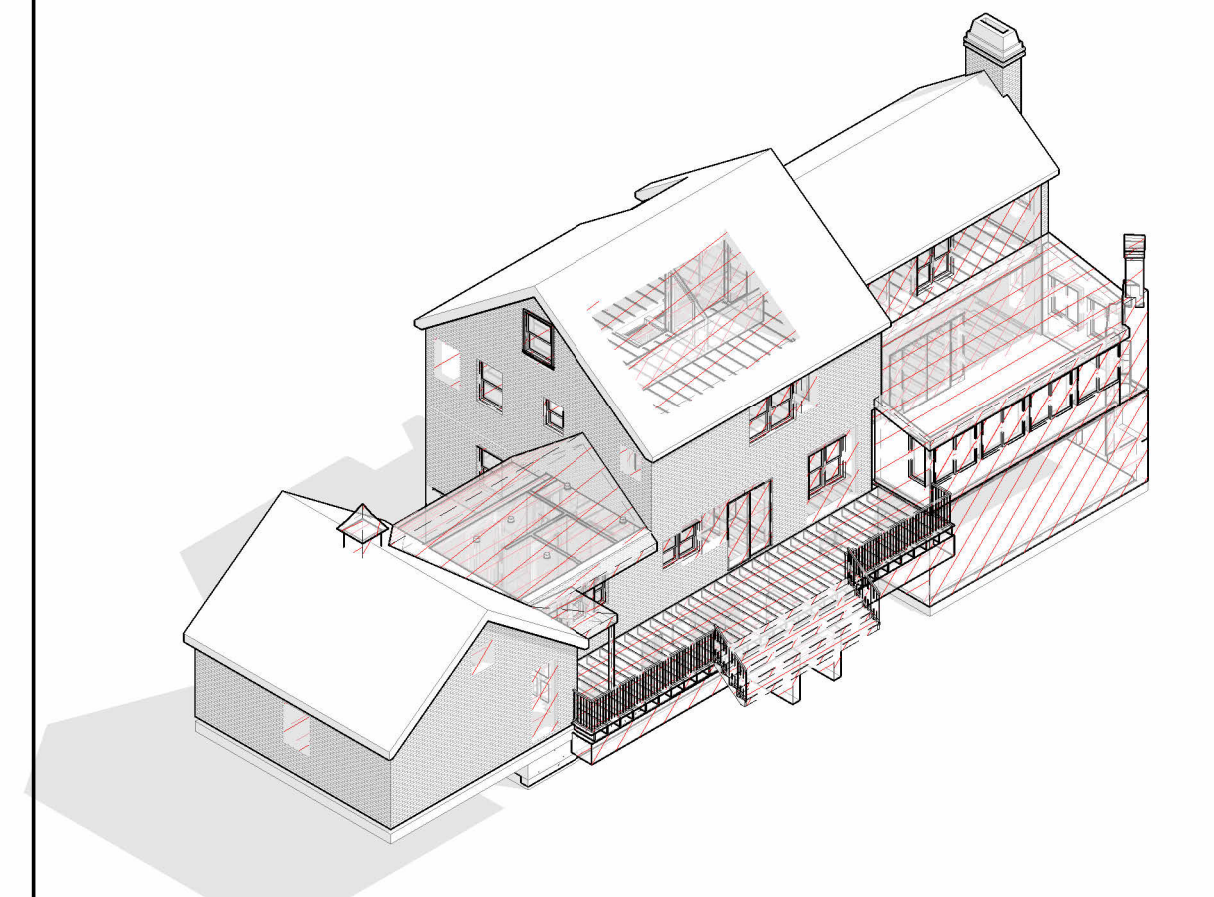


DEMOLITION - ORTHOGRAPHIC VIEW A

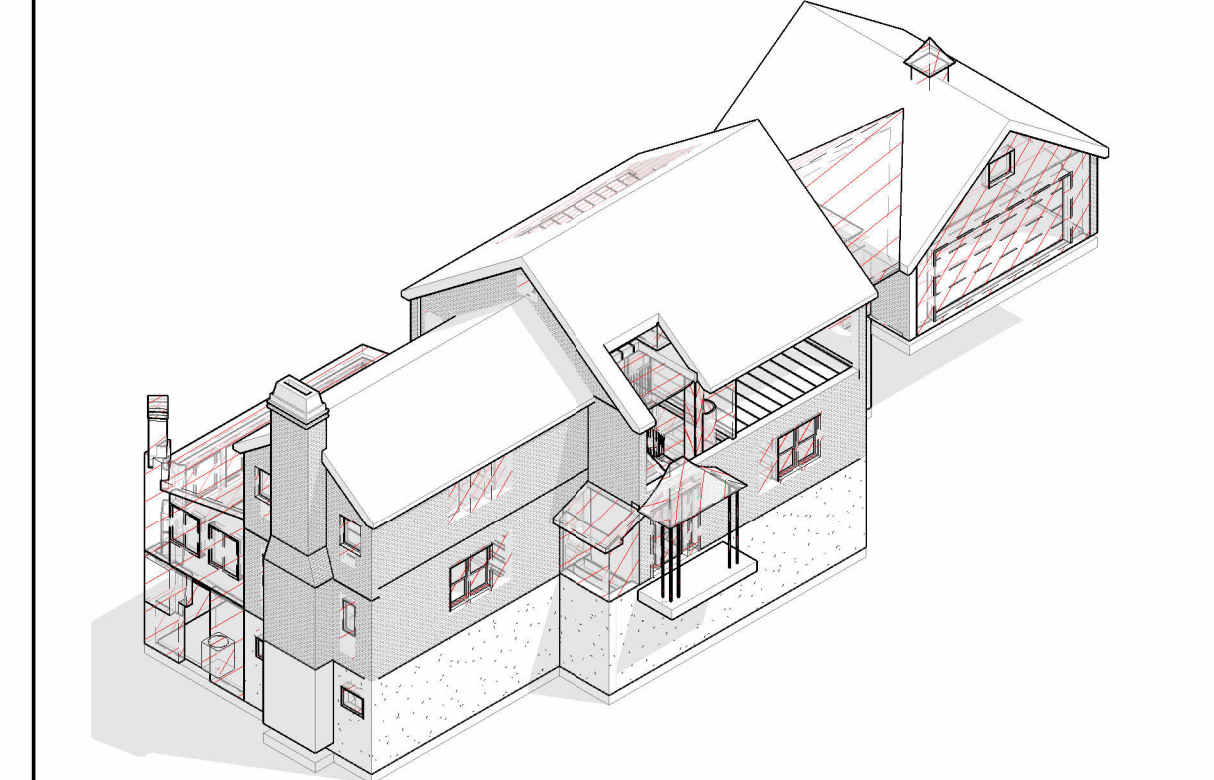

DEMOLITION - ORTHOGRAPHIC VIEW B

CHARLES ROSE ARCHITECTS INC
115 WILLOW AVENUE
SOMERVILLE, MA 02144
TEL 617.628.5033
WWW.CHARLESROSEARCHITECTS.COM
© CHARLES ROSE ARCHITECTS INC

CONSULTANT

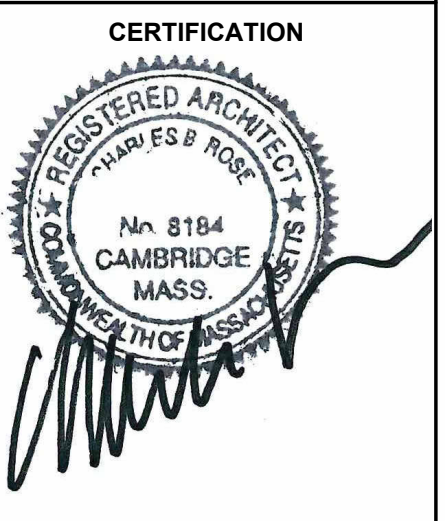

BAIRD RESIDENCE
16 WOODLAND ROAD
JAMAICA PLAIN, BOSTON, MA 02130

REVISION HISTORY		
NO.	DESCRIPTION	DATE


PERMIT REVISION

DATE:	AUG 18, 2023
SCALE:	1/4" = 1'-0"
DRAWN BY:	CJ
CHECKED BY:	CR


SHEET TITLE:	PROJECT #:	40035
--------------	------------	-------

LOWER LEVEL & FIRST FLOOR DEMO PLAN

A2.00

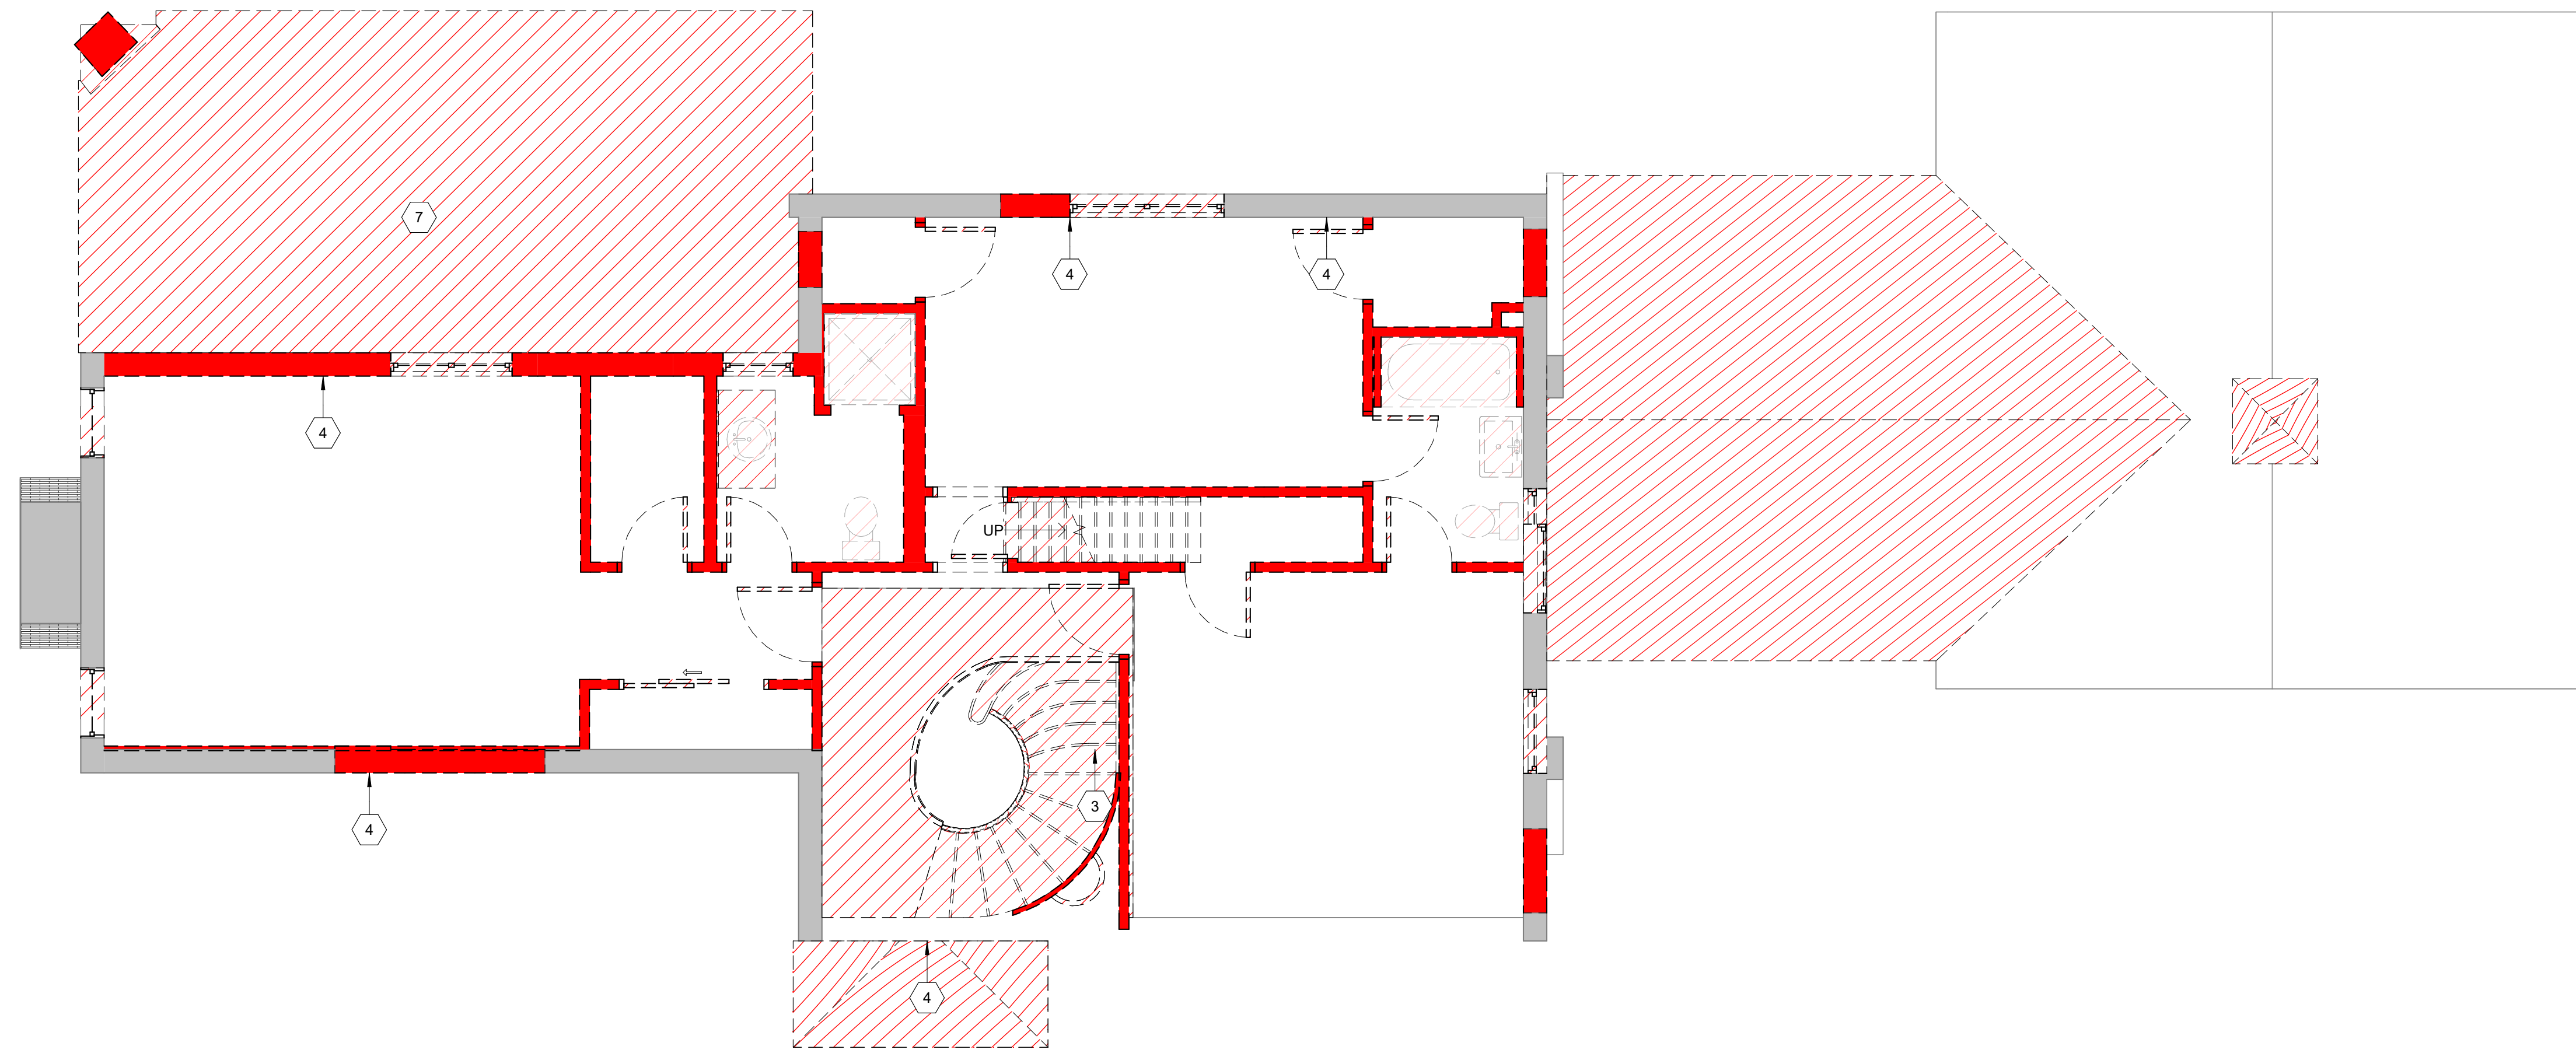

1 SECOND FLOOR DEMO PLAN
1/4" = 1'-0"

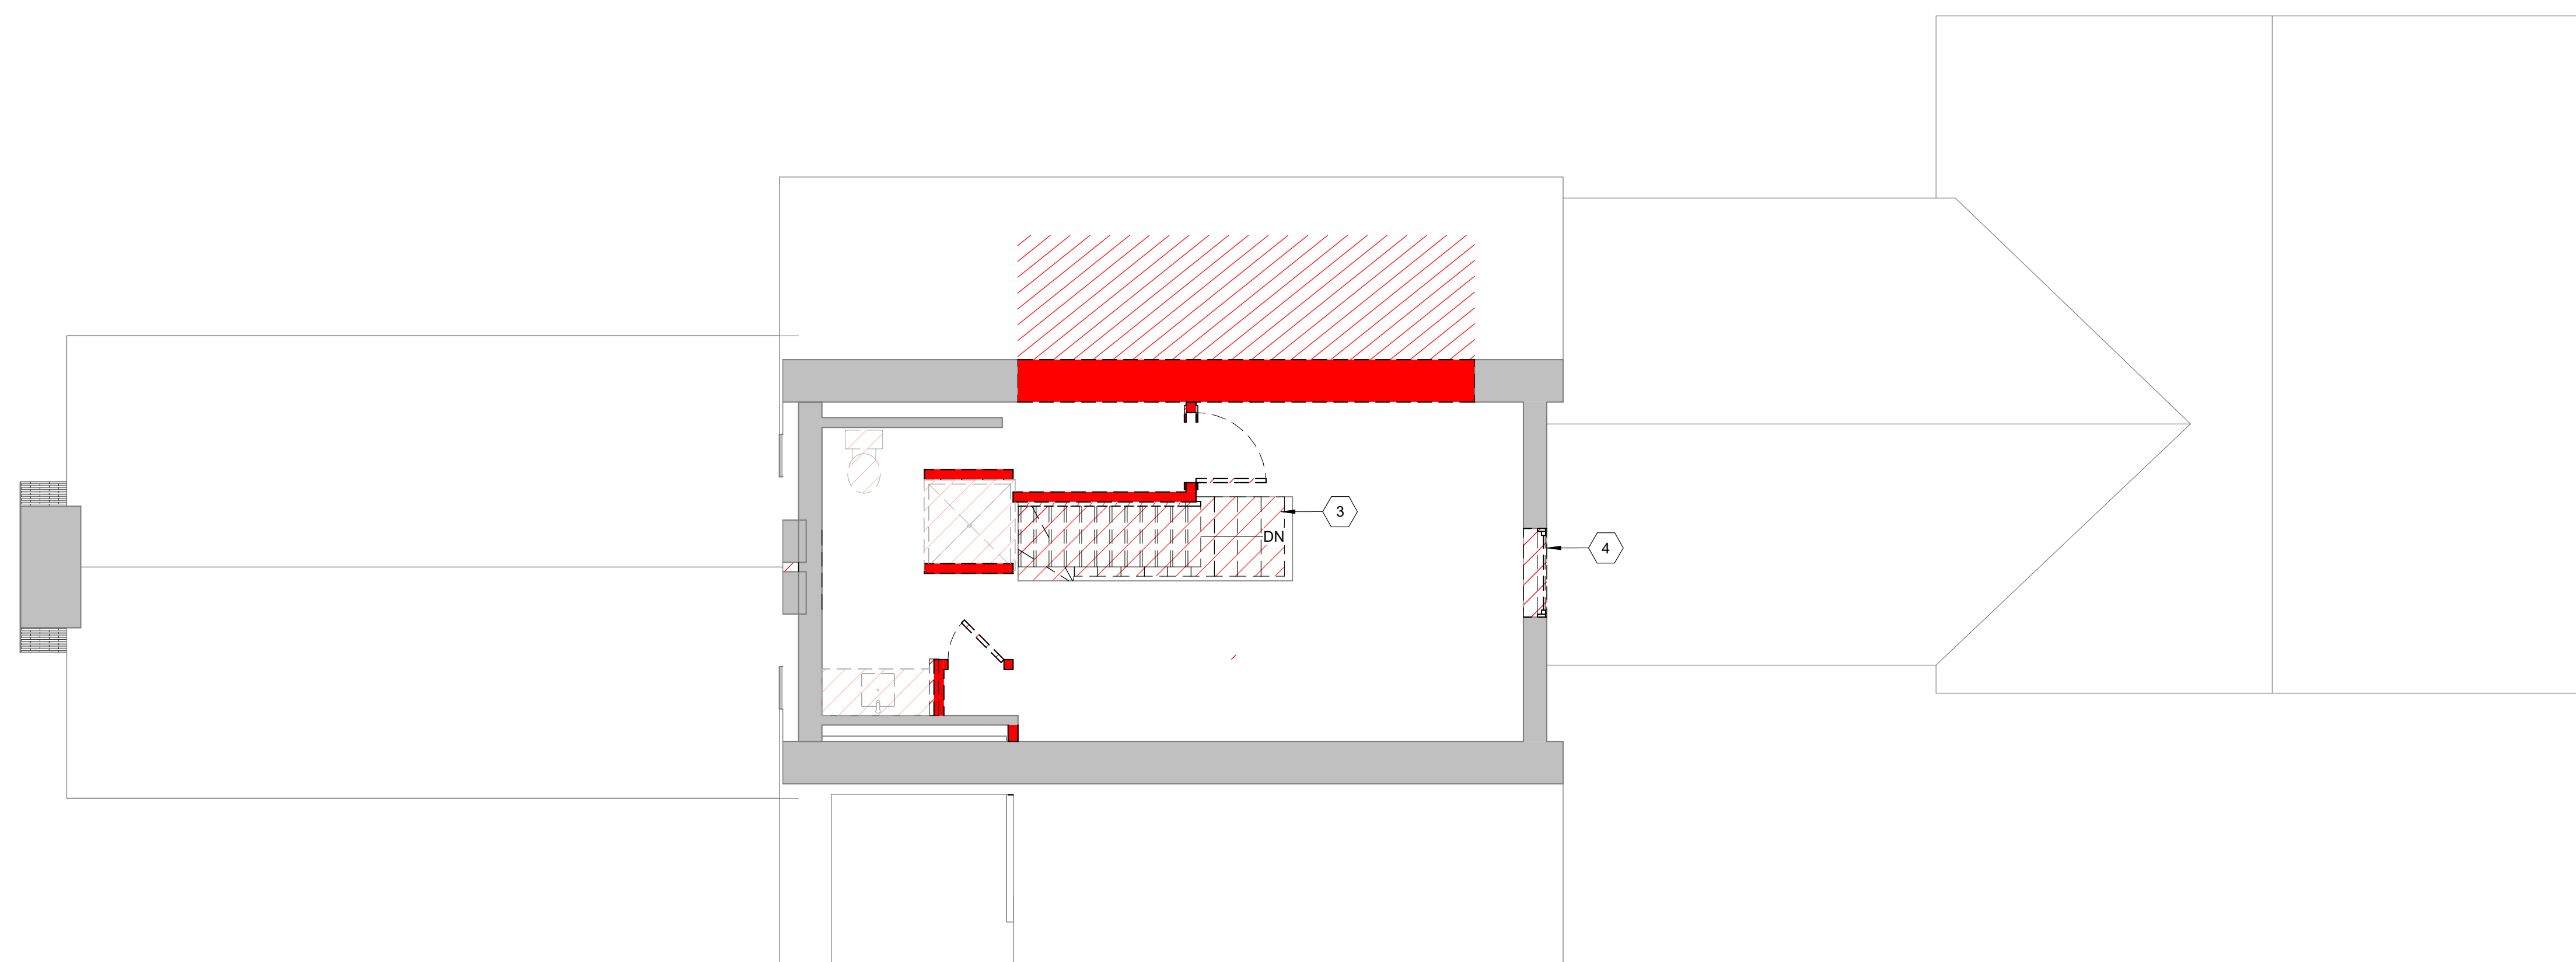

2 THIRD FLOOR DEMO PLAN
1/4" = 1'-0"

DEMOLITION NOTES

1. THE CONTRACTOR IS RESPONSIBLE FOR DAMAGE TO THE EXISTING BUILDING AND GROUNDS ARISING FROM DEMOLITION OPERATIONS.
2. DASHED LINES INDICATE EXISTING CONSTRUCTION TO BE REMOVED. REMOVE ALL CONSTRUCTION THAT CONFLICTS WITH THE INTENT OF THE NEW CONSTRUCTION. NOTIFY ARCHITECT OF ALL M.E.P. ITEMS LOCATED IN PARTITIONS OR CEILINGS NOT NOTED ON M.E.P. DRAWINGS.
3. REMOVAL OF DOORS ALSO INCLUDES REMOVAL OF DOOR FRAMES AND HARDWARE U.N.O.
4. RETURN ALL SALVAGED DOORS, FRAMES, HARDWARE, LIGHT FIXTURES AND EQUIPMENT NOT REUSED IN THIS PROJECT TO OWNER FOR REUSE ELSEWHERE.
5. REMOVE ALL EXISTING DEBRIS, ABANDONED DUCT, WIRING AND CONDUIT FROM ABOVE CEILING AREAS THAT ARE TO REMAIN.
6. LIGHTING TO BE REMOVED AND/OR RELOCATED IS INDICATED ON THE REFLECTED CEILING PLAN, OR A SEPARATE CEILING DEMOLITION PLAN.
7. RELOCATION OF EXISTING DUCTWORK TO REMAIN IN ORDER TO AVOID CONFLICT WITH NEW CONSTRUCTION IS THE RESPONSIBILITY OF THE MECHANICAL CONTRACTOR.
8. RELOCATION OF EXISTING ELECTRICAL WORK TO REMAIN IN ORDER TO AVOID CONFLICT WITH NEW CONSTRUCTION IS THE RESPONSIBILITY OF THE ELECTRICAL CONTRACTOR.
9. RELOCATION OF EXISTING PLUMBING WORK TO REMAIN IN ORDER TO AVOID CONFLICT WITH NEW CONSTRUCTION IS THE RESPONSIBILITY OF THE PLUMBING CONTRACTOR.
10. NOTIFY ARCHITECT OF ALL NOTICEABLE DEFECTS IN EXISTING CONSTRUCTION PRIOR TO BEGINNING DEMOLITION OPERATIONS, AS WELL AS DEFECTS UNCOVERED DURING DEMOLITION OPERATIONS.
11. REMOVE ELECTRICAL BOXES, WIRING AND CONDUIT IN DEMOLISHED PARTITIONS BACK TO THEIR RESPECTIVE PANELS, UNLESS INDICATED TO BE REROUTED.
12. ELECTRICAL BOXES TO BE REMOVED FROM PARTITIONS TO REMAIN ARE INDICATED ON THE PLANS. REMOVE DEVICES AND REPAIR PARTITION, READY TO RECEIVE NEW FINISHES.


DEMOLITION DRAWING LEGEND

- EXISTING WALL TO BE DEMOLISHED
- EXISTING SURFACE/FINISH TO BE DEMOLISHED
- EXISTING WALLS TO REMAIN
- NEW WALLS

DEMOLITION KEYNOTES

- ① REMOVE EXISTING MECHANICAL EQUIPMENT
- ② CUT OPENING IN EXISTING CONCRETE WALL, COORDINATE CLEAR DIM WITH WINDOW SCHEDULE AND STRUC.
- ③ REMOVE EXISTING STAIR, INCL. RAILS, TREADS, STRUCTURE
- ④ CUT OPENING IN EXISTING MASONRY WALL, COORDINATE CLEAR DIM WITH WINDOW SCHEDULE AND STRUC; PROVIDE CLEAN, TRUE AND PLUMB R.G. FOR WINDOW INSTAL.
- ⑤ PROTECT EXISTING COLUMNS TO REMAIN DURING DEMOLITION. CLEAN SURFACE TO SP-3 TO PREP FOR PAINT.
- ⑥ REMOVE EXISTING CONCRETE SLAB; PREP FOR NEW CONCRETE SLAB
- ⑦ REMOVE EXISTING DECK

ORTHOGRAPHIC VIEWS

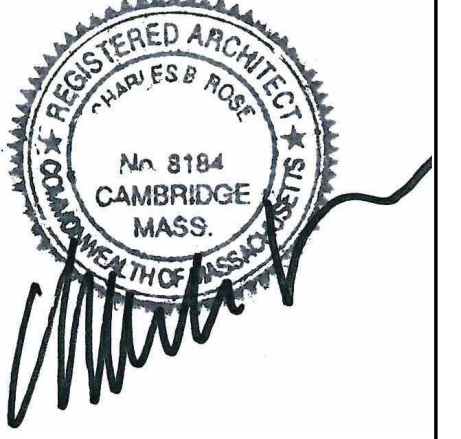

REVISION HISTORY		
NO.	DESCRIPTION	DATE

PERMIT REVISION

DATE:	AUG 18, 2023
SCALE:	1/4" = 1'-0"
DRAWN BY:	CJ
CHECKED BY:	CR

SHEET TITLE	PROJECT #
	40035





PLAN LEGEND

- NEW FULL HEIGHT WALL, REF. A6.00 PARTITION SCHED.
- STRUCTURAL CONCRETE WALL, SEE STRUC.
- EXISTING WALL TO REMAIN
- PARTITION TYPE, REF. A8.00 PARTITION SCHED.
- DOOR TAG, REF. A8.20 DOOR SCHED.
- CASEWORK, REF. A8.10 CASEWORK SCHED.
- LED TV DISPLAY
- WALL FINISH TAG, REF. A8.11 FINISH KEY

PLAN KEY NOTES

- TEXT
- NOTIFY ARCHITECT IF THERE IS A DISCREPANCY GREATER THAN 1/8" AT ALL DIMENSIONS TO BE VERIFIED IN THE FIELD (VIF).
- UNLESS NOTED OTHERWISE, ALL DIMENSIONS ARE TO THE FACE OF GYPSUM BOARD

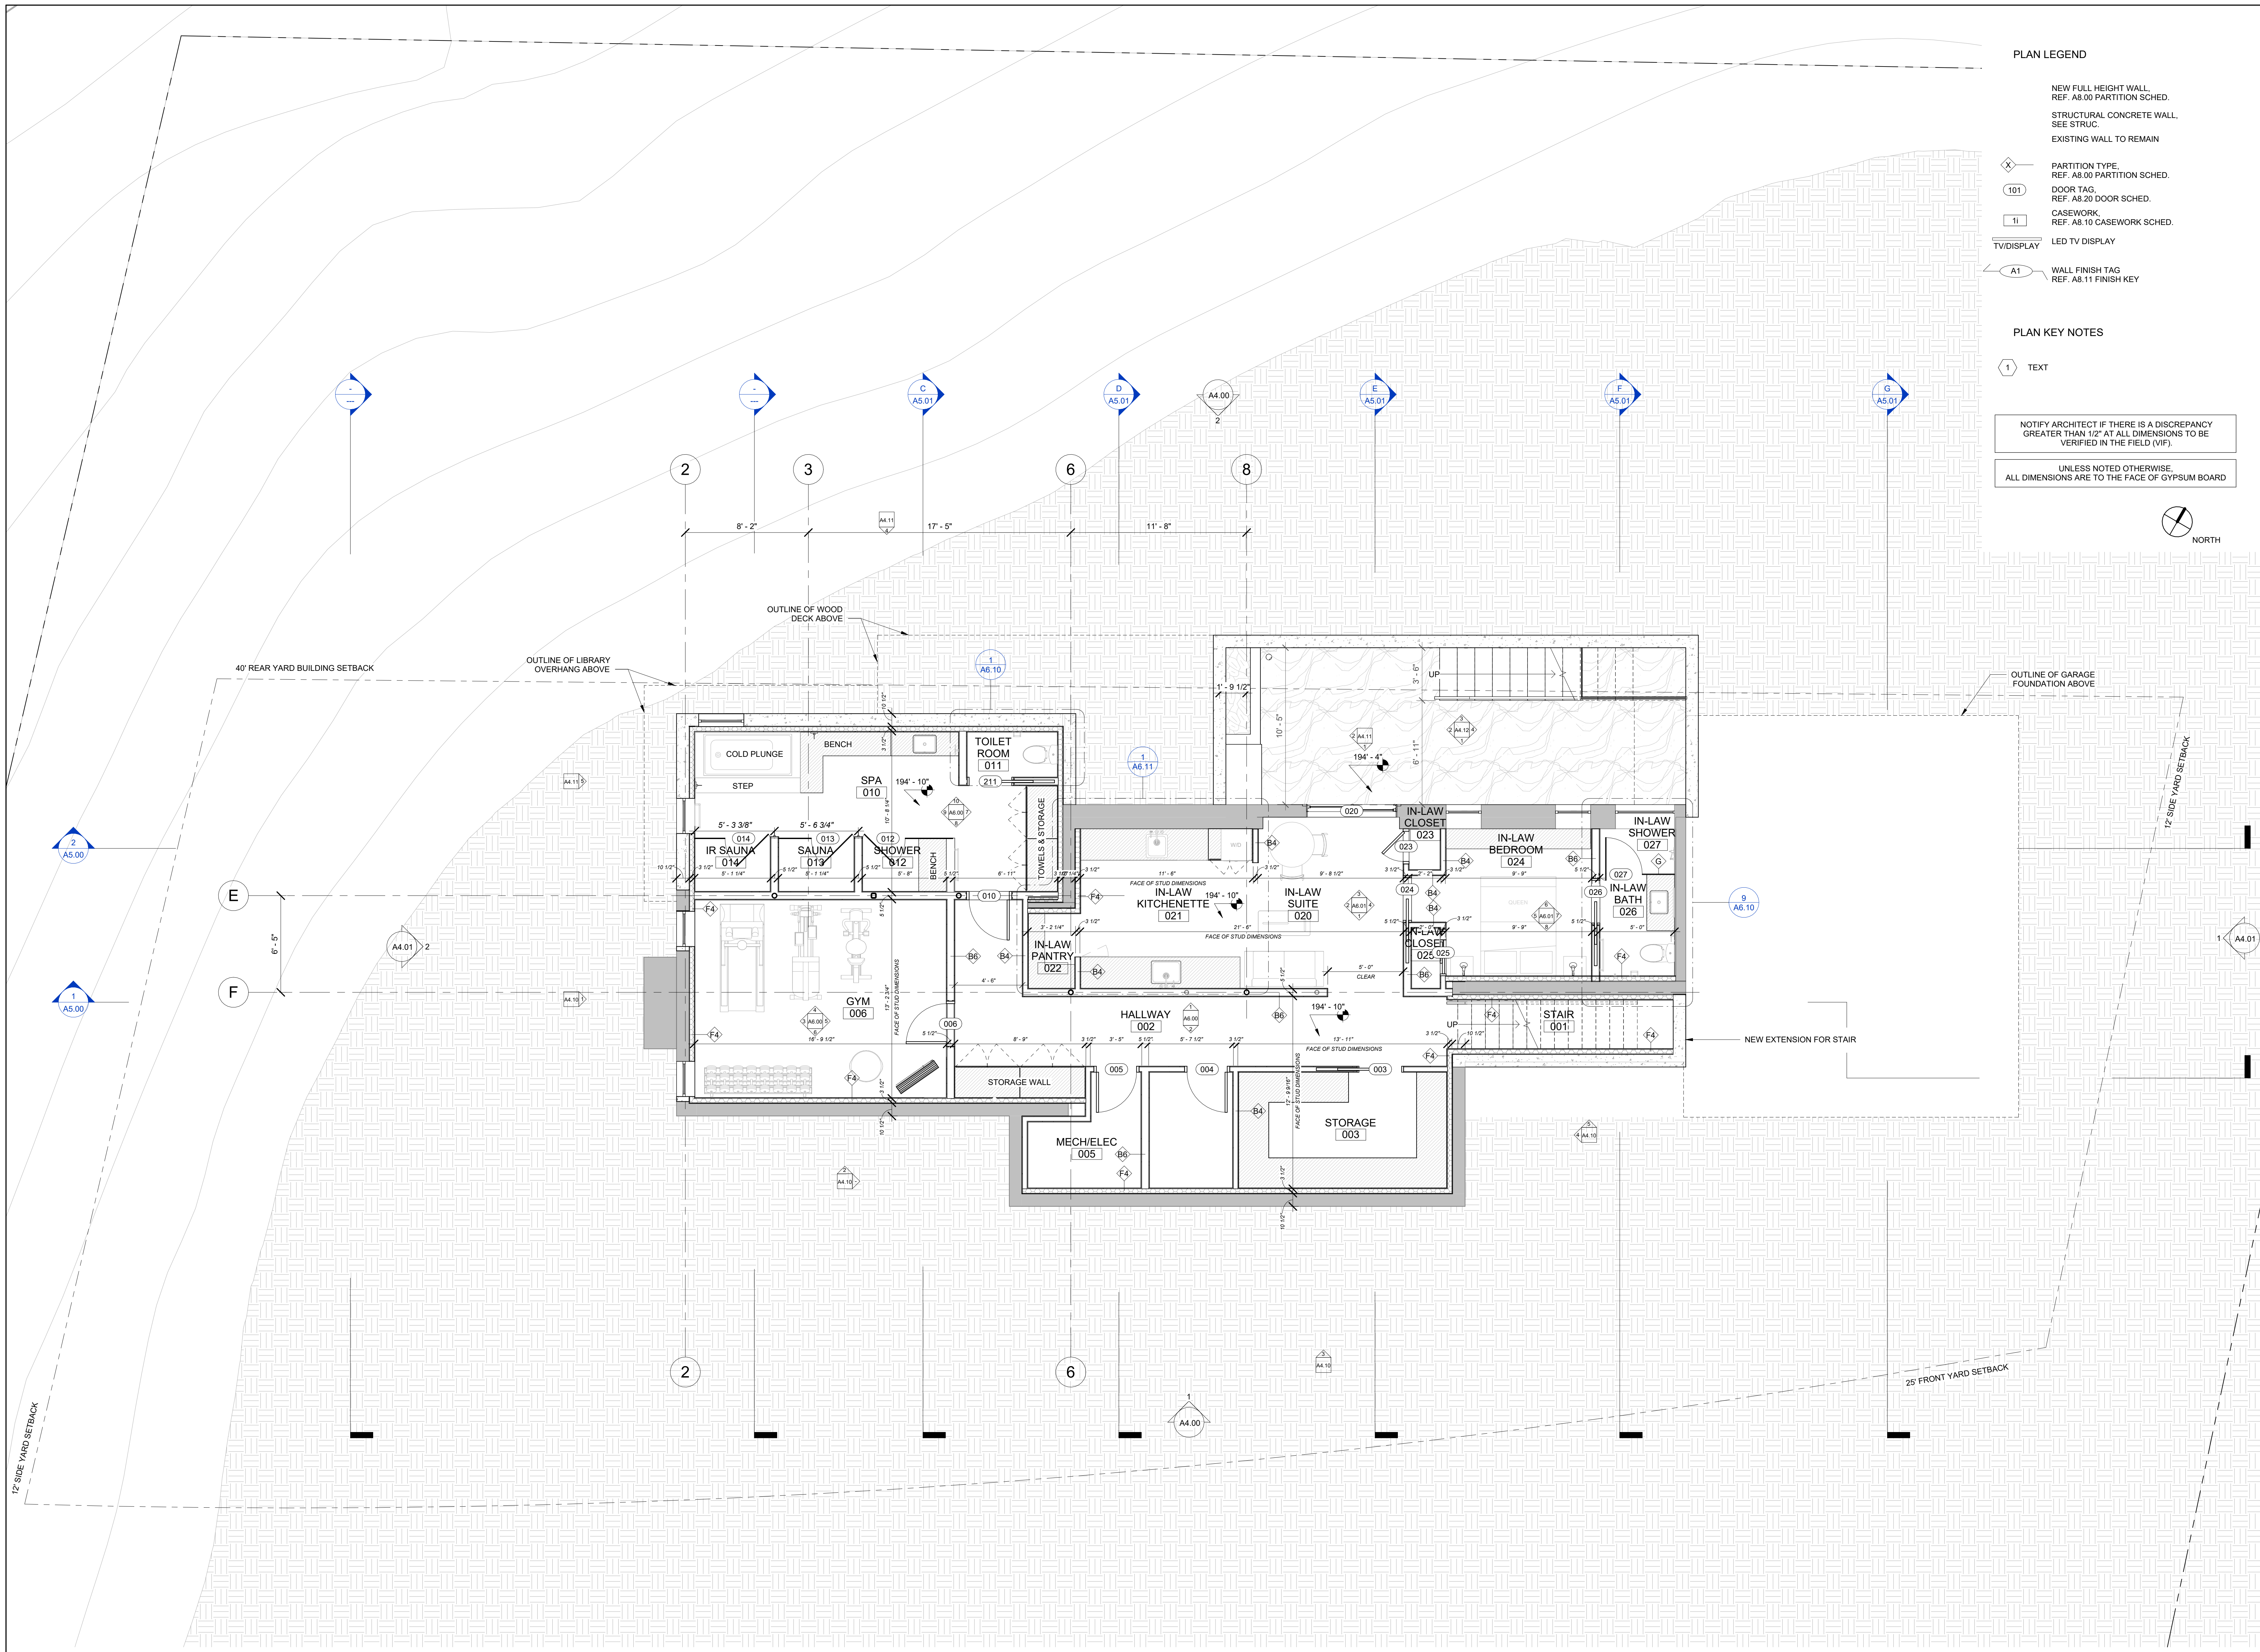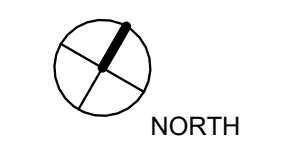


1 BASEMENT FLOOR PLAN
 1/4" = 1'-0"

REVISION HISTORY		
NO.	DESCRIPTION	DATE

PERMIT REVISION	
DATE	DESCRIPTION
SEPT 6, 2023	As indicated
CJ	
CR	

SHEET TITLE: LOWER LEVEL FLOOR PLAN
 PROJECT #: 40035

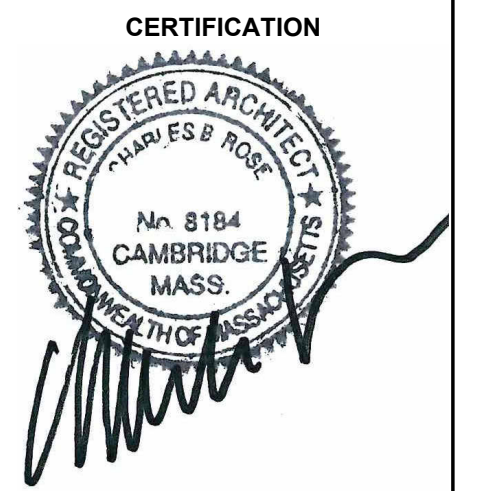


PLAN LEGEND

- NEW FULL HEIGHT WALL, REF. A6.00 PARTITION SCHED.
- STRUCTURAL CONCRETE WALL, SEE STRUC.
- EXISTING WALL TO REMAIN
- PARTITION TYPE, REF. A8.00 PARTITION SCHED.
- DOOR TAG, REF. A8.20 DOOR SCHED.
- CASEWORK, REF. A8.10 CASEWORK SCHED.
- LED TV DISPLAY
- WALL FINISH TAG, REF. A8.11 FINISH KEY

PLAN KEY NOTES

- TEXT
- NOTIFY ARCHITECT IF THERE IS A DISCREPANCY GREATER THAN 1/2" AT ALL DIMENSIONS TO BE VERIFIED IN THE FIELD (VIF).
- UNLESS NOTED OTHERWISE, ALL DIMENSIONS ARE TO THE FACE OF GYPSUM BOARD

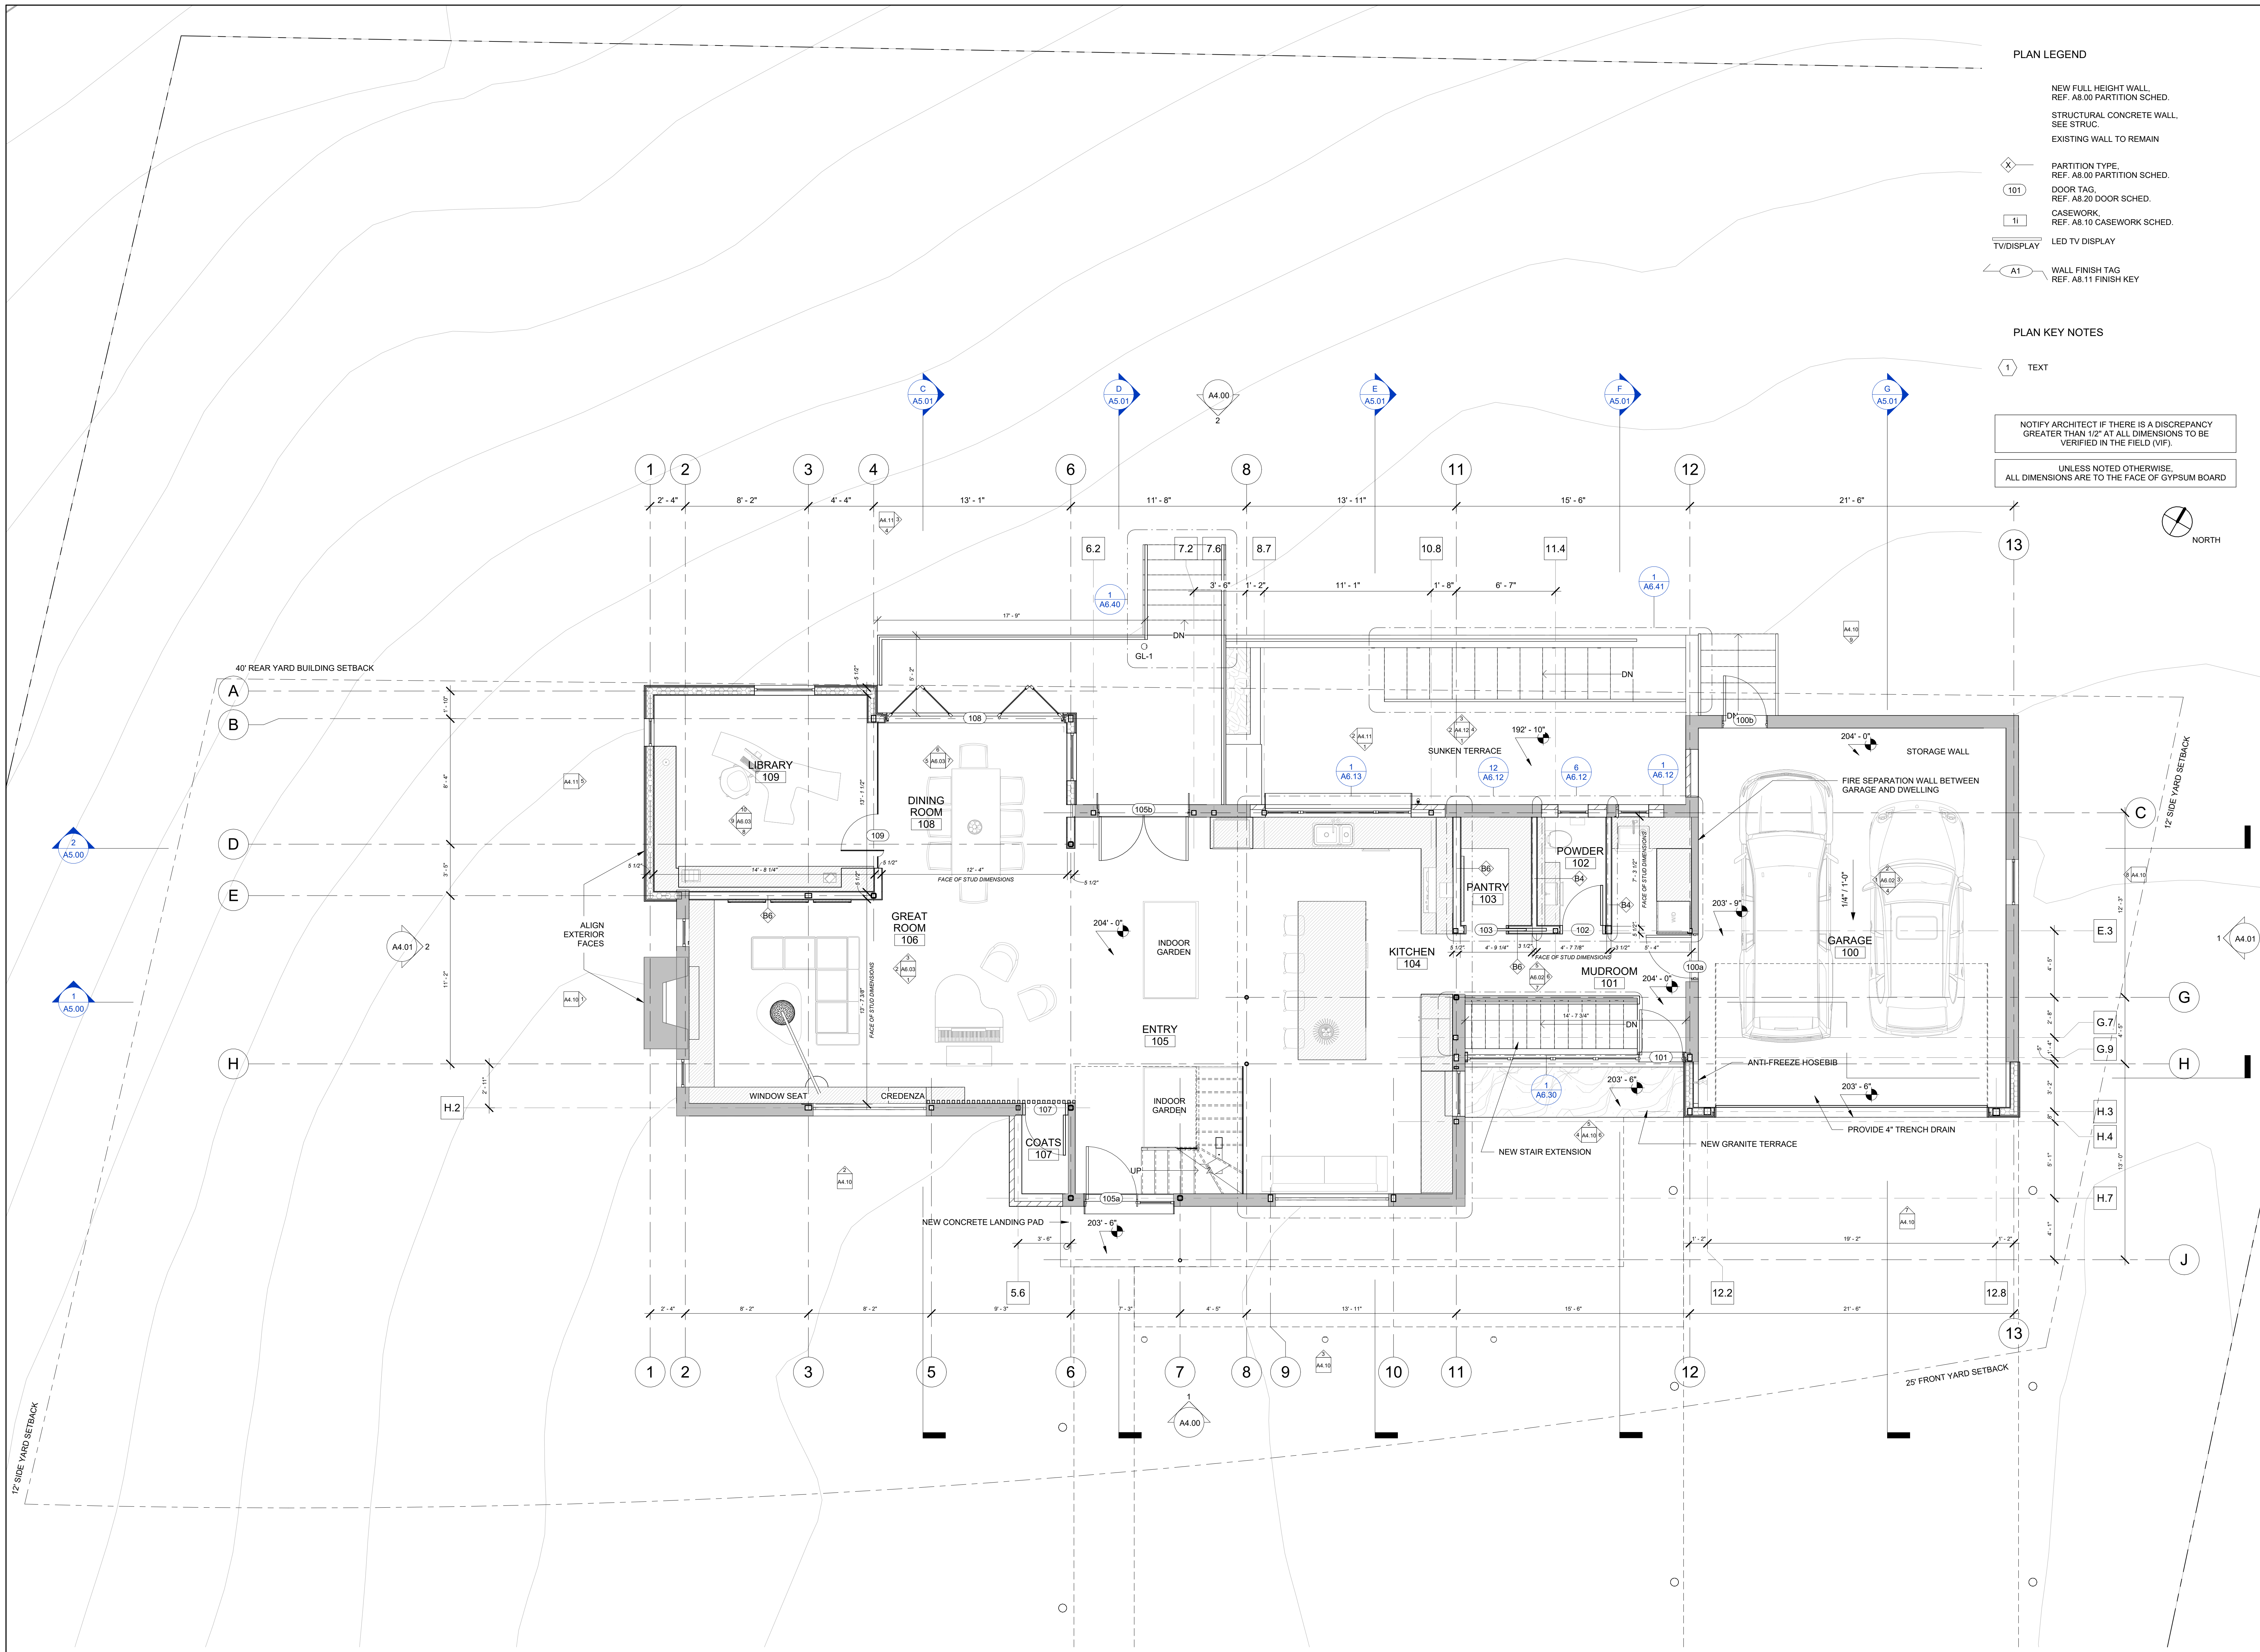

1 FIRST FLOOR PLAN
 1/4" = 1'-0"

REVISION HISTORY		
NO.	DESCRIPTION	DATE

PERMIT REVISION	
DATE:	AUG 18, 2023
SCALE:	As indicated
DRAWN BY:	CJ
CHECKED BY:	CR

SHEET TITLE PROJECT #: 40035





PLAN LEGEND

- NEW FULL HEIGHT WALL, REF. A6.00 PARTITION SCHED.
- STRUCTURAL CONCRETE WALL, SEE STRUC.
- EXISTING WALL TO REMAIN
- PARTITION TYPE, REF. A8.00 PARTITION SCHED.
- DOOR TAG, REF. A8.20 DOOR SCHED.
- CASEWORK, REF. A8.10 CASEWORK SCHED.
- LED TV DISPLAY
- WALL FINISH TAG, REF. A8.11 FINISH KEY

PLAN KEY NOTES

- TEXT
- NOTIFY ARCHITECT IF THERE IS A DISCREPANCY GREATER THAN 1/2" AT ALL DIMENSIONS TO BE VERIFIED IN THE FIELD (VIF).
- UNLESS NOTED OTHERWISE, ALL DIMENSIONS ARE TO THE FACE OF GYPSUM BOARD

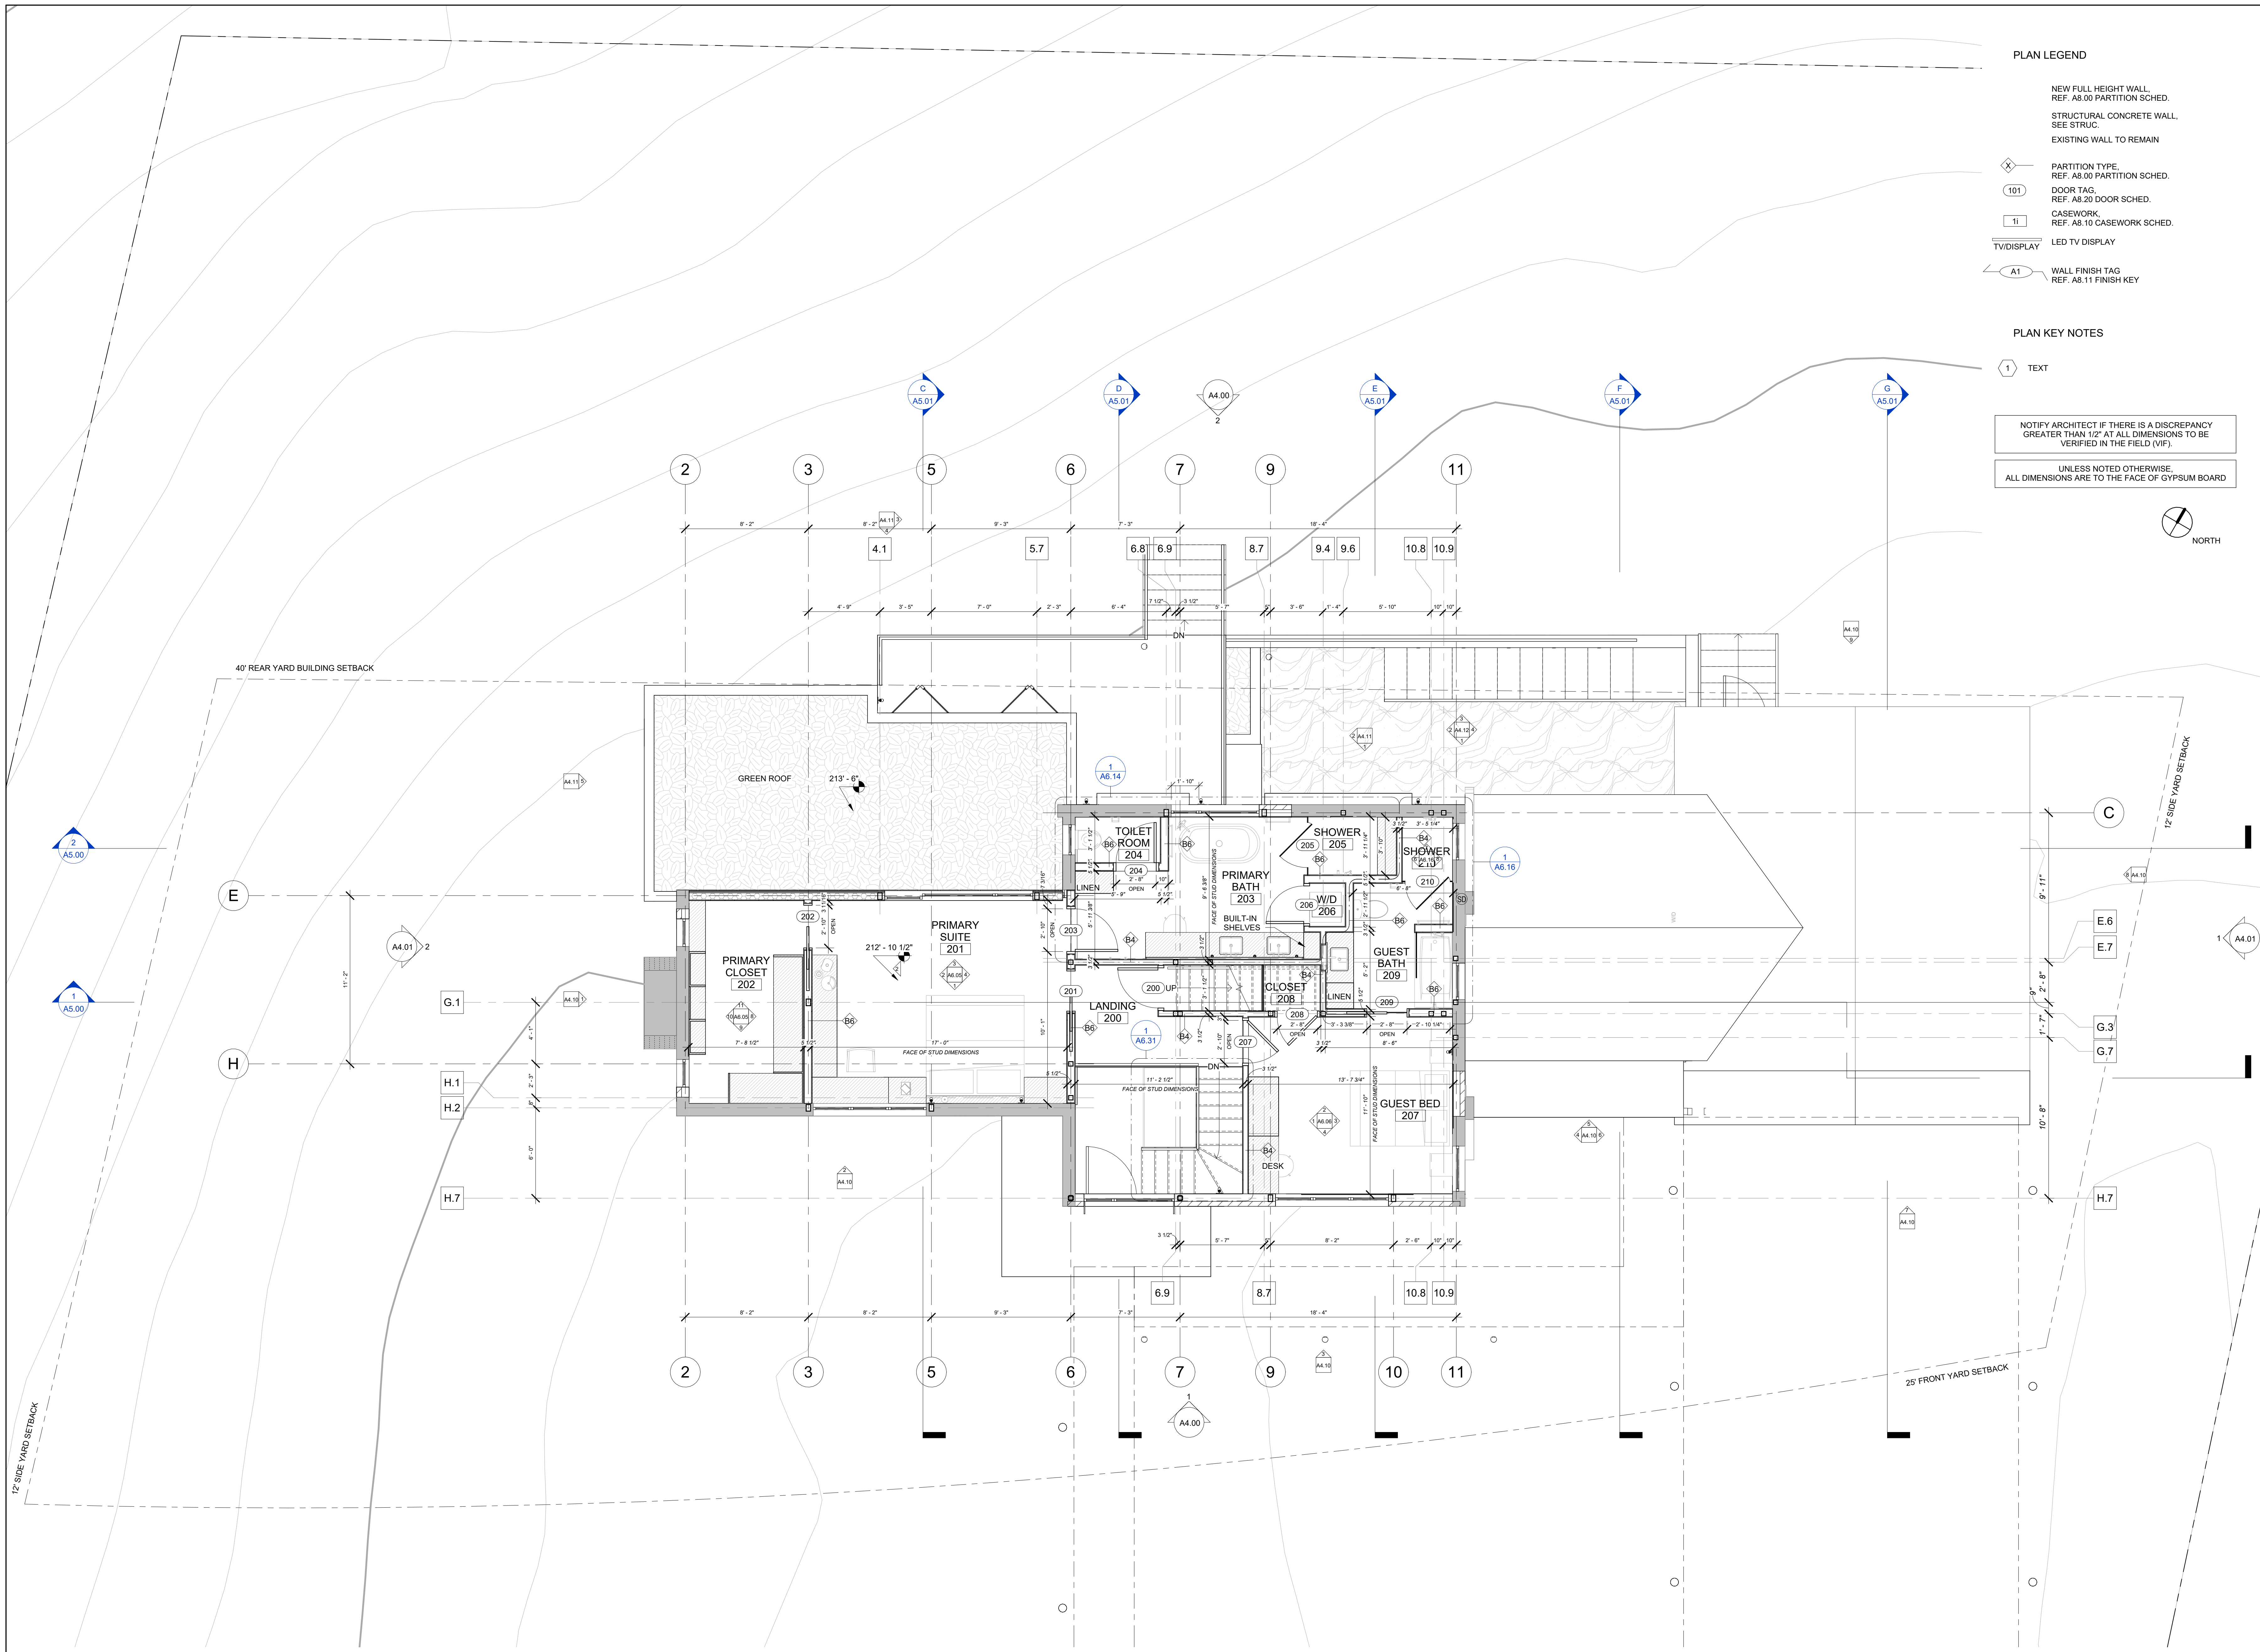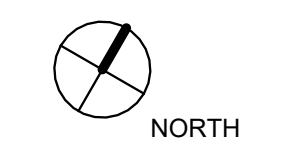

1 SECOND FLOOR PLAN
 1/4" = 1'-0"

REVISION HISTORY		
NO.	DESCRIPTION	DATE

PERMIT REVISION

DATE:	AUG 18, 2023
SCALE:	As indicated
DRAWN BY:	CJ
CHECKED BY:	CR

SHEET TITLE	PROJECT #
SECOND FLOOR PLAN	40035

SECOND FLOOR PLAN




PLAN LEGEND

- NEW FULL HEIGHT WALL, REF. A6.00 PARTITION SCHED.
- STRUCTURAL CONCRETE WALL, SEE STRUC.
- EXISTING WALL TO REMAIN
- PARTITION TYPE, REF. A8.00 PARTITION SCHED.
- DOOR TAG, REF. A8.20 DOOR SCHED.
- CASEWORK, REF. A8.10 CASEWORK SCHED.
- LED TV DISPLAY
- WALL FINISH TAG, REF. A8.11 FINISH KEY

PLAN KEY NOTES


- TEXT
- NOTIFY ARCHITECT IF THERE IS A DISCREPANCY GREATER THAN 1/2" AT ALL DIMENSIONS TO BE VERIFIED IN THE FIELD (VIF).
- UNLESS NOTED OTHERWISE, ALL DIMENSIONS ARE TO THE FACE OF GYPSUM BOARD

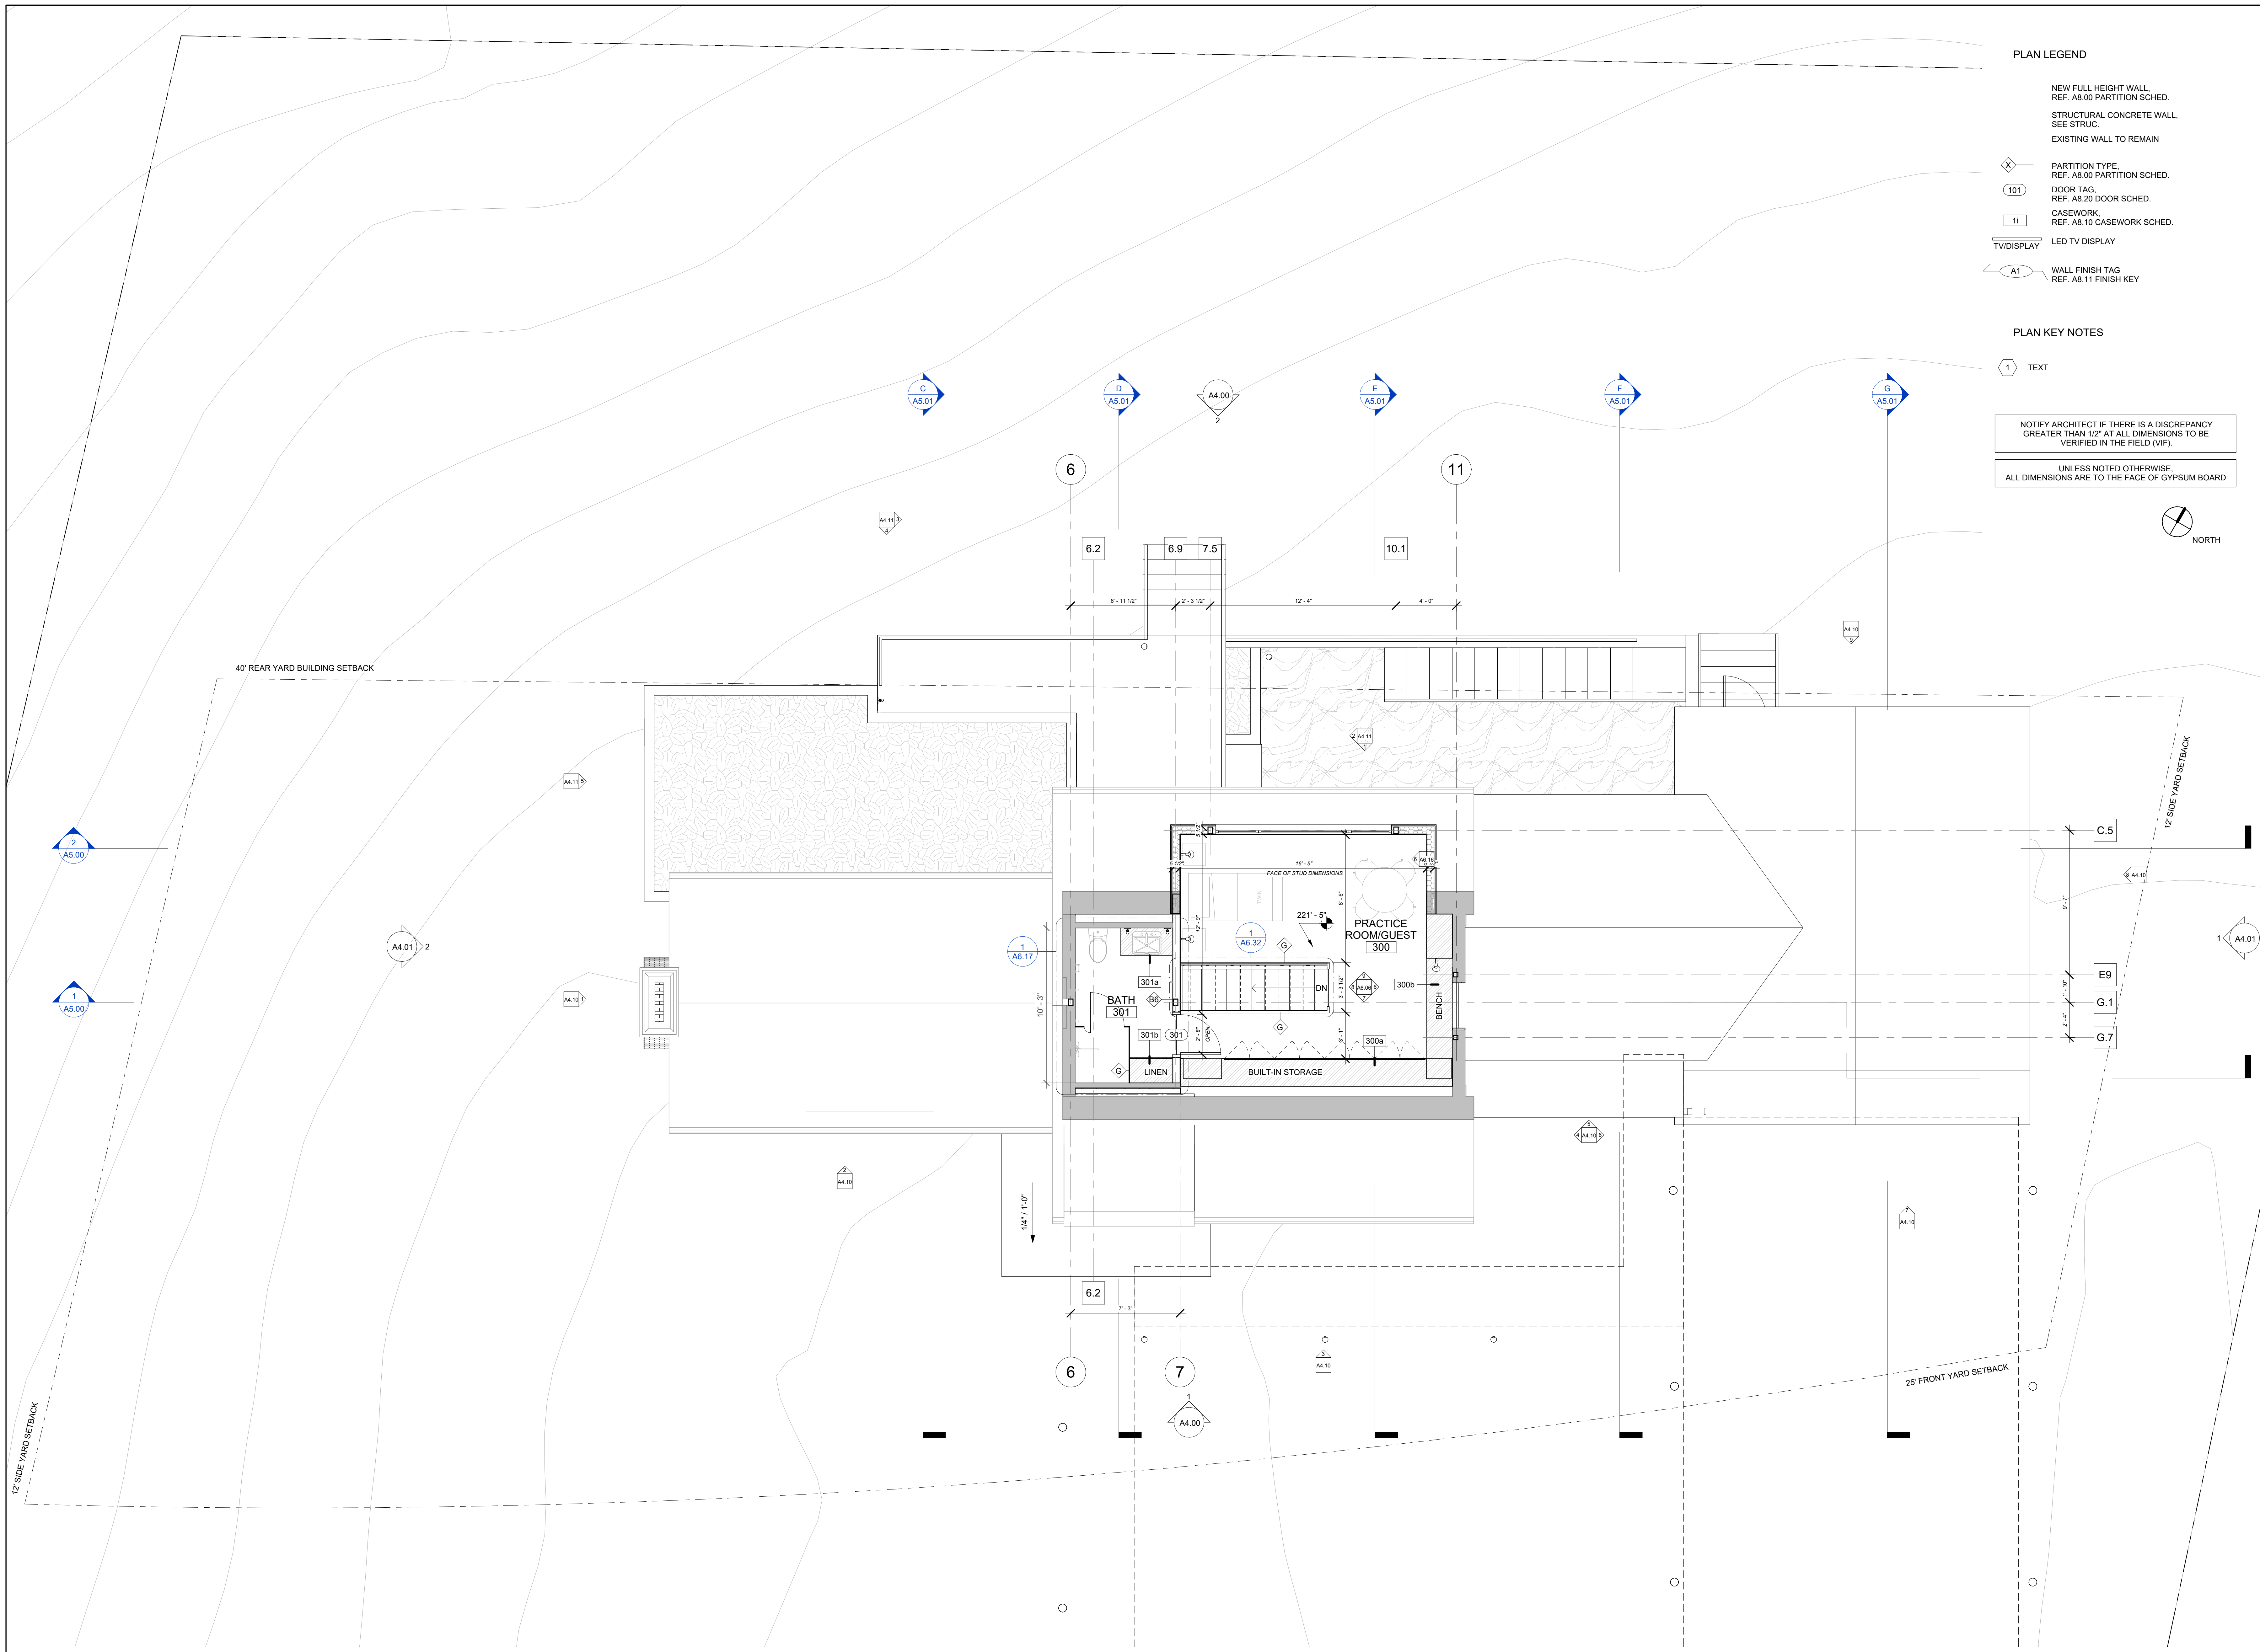

REVISION HISTORY		
NO.	DESCRIPTION	DATE

PERMIT REVISION	
DATE:	AUG 18, 2023
SCALE:	As indicated
DRAWN BY:	CJ
CHECKED BY:	CR

SHEET TITLE	PROJECT #
THIRD FLOOR PLAN	40035

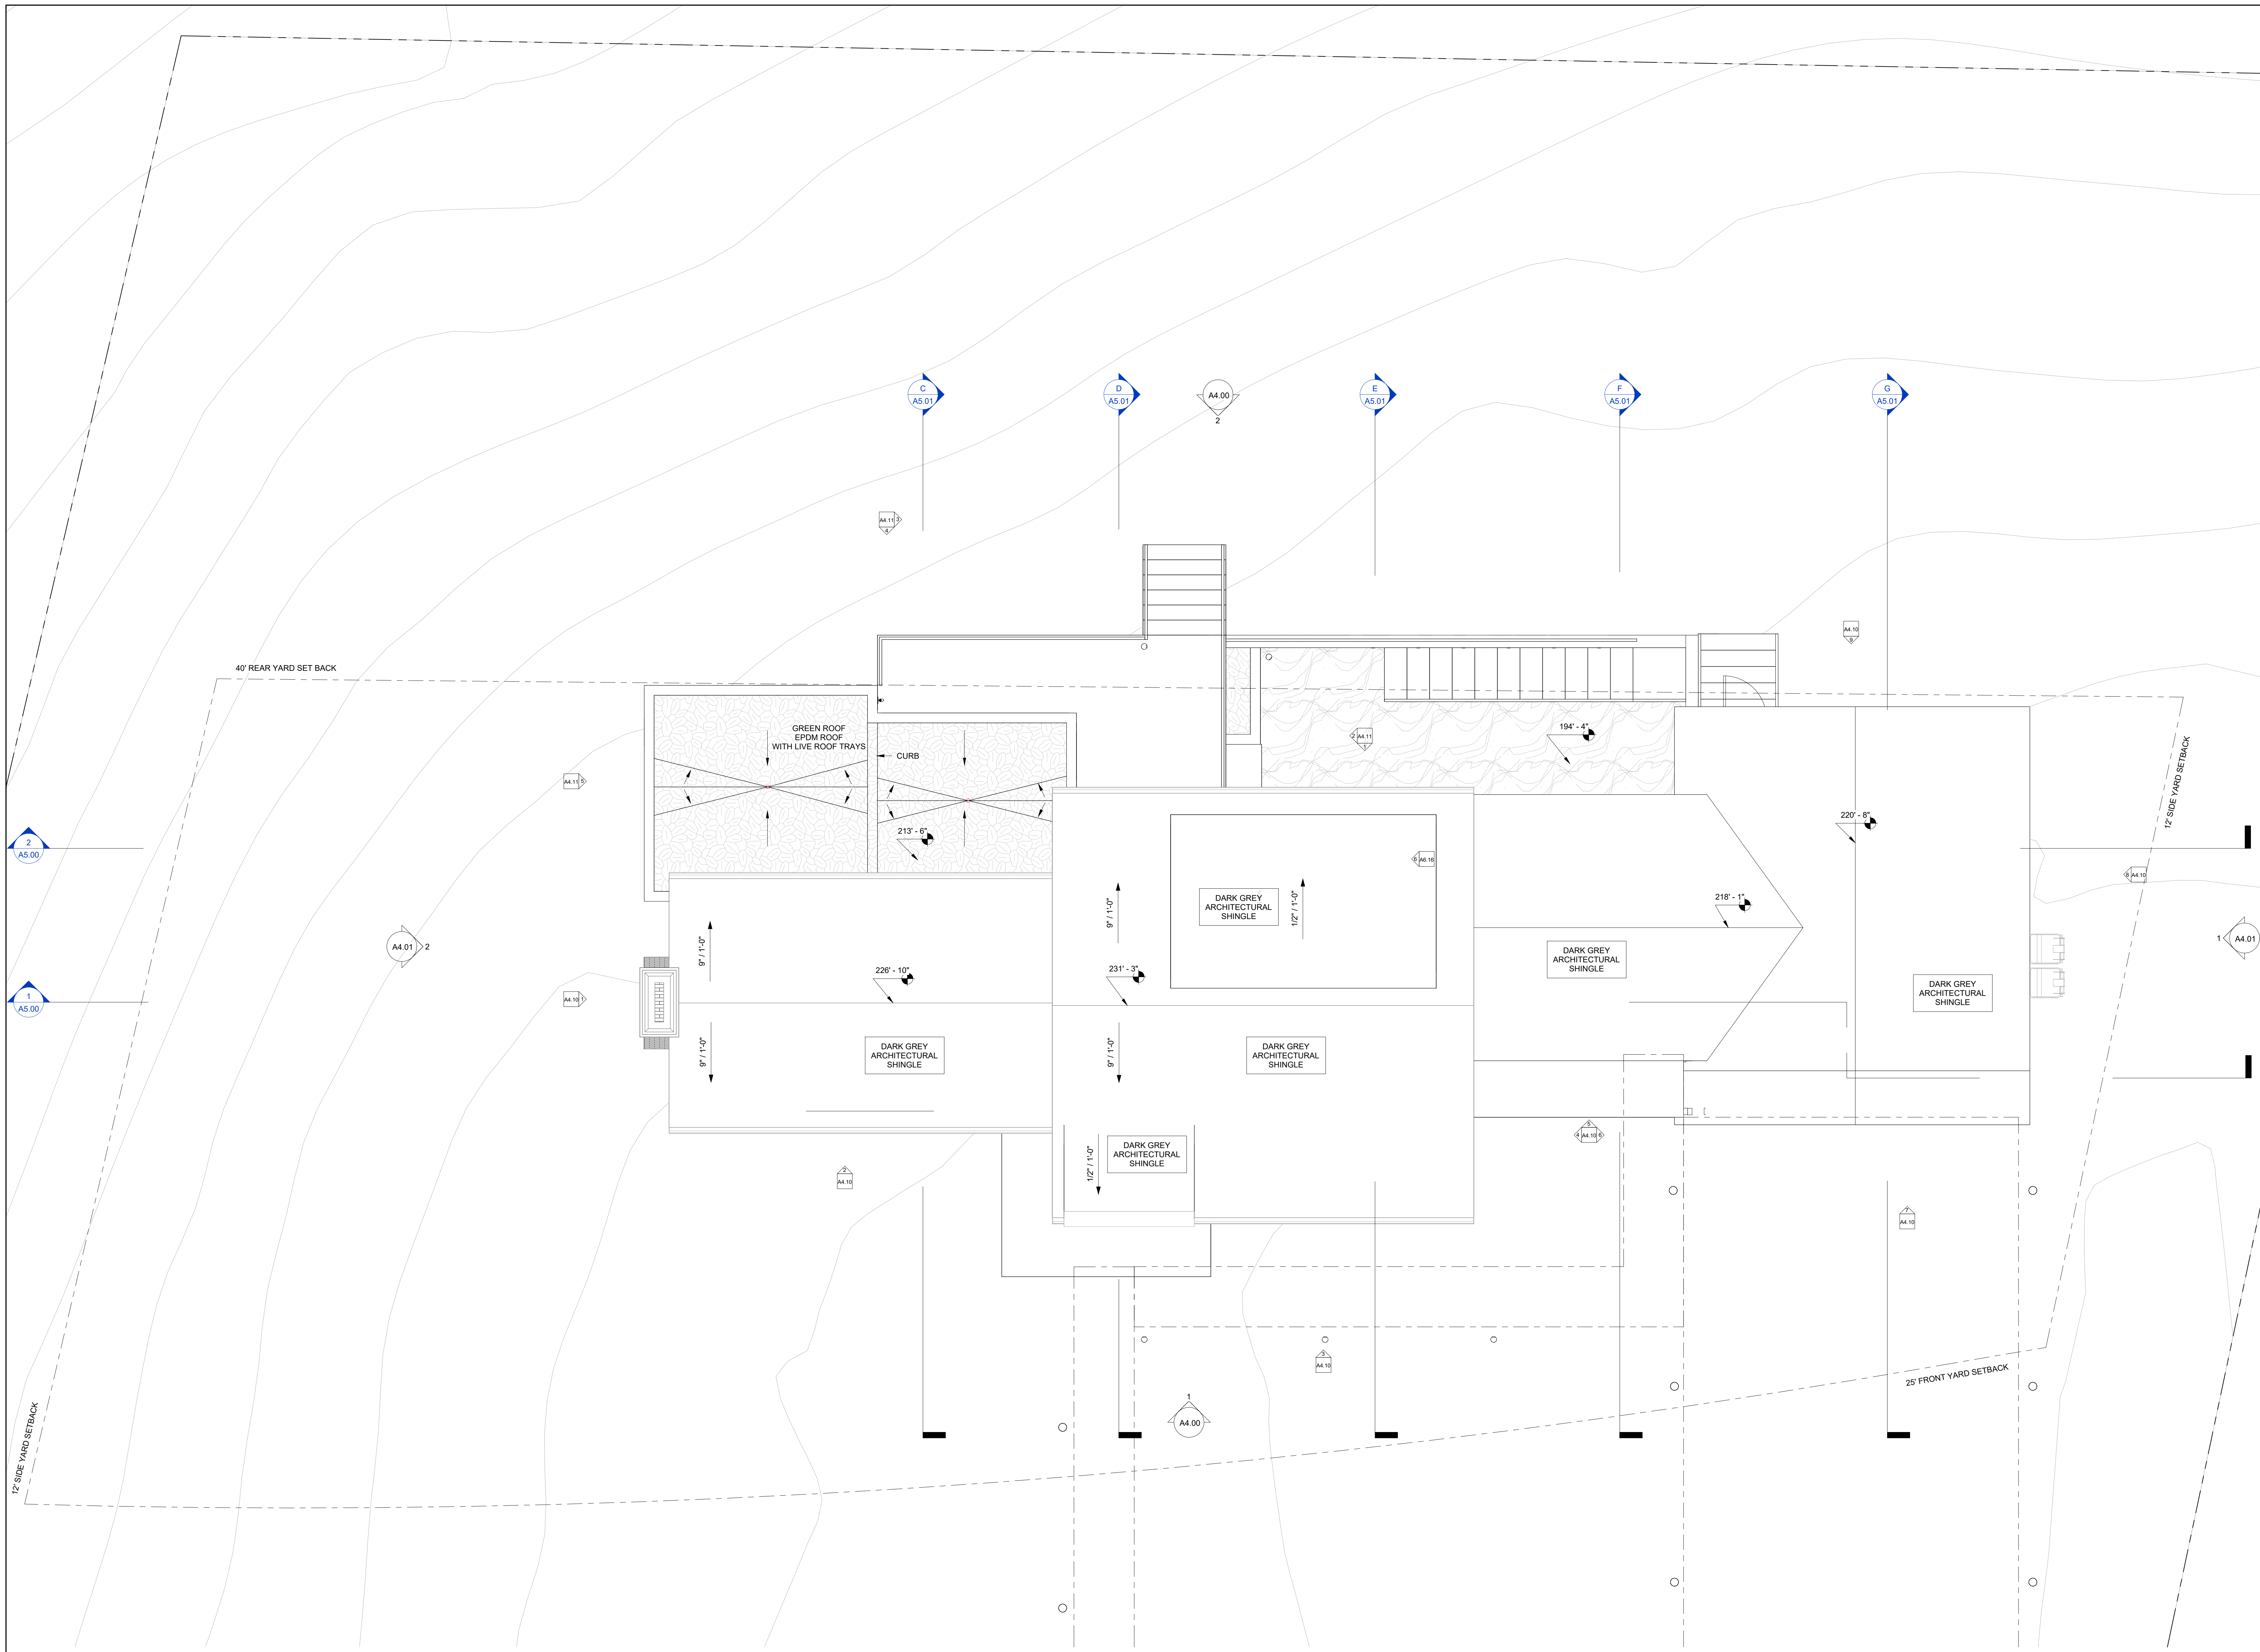

1 ROOF PLAN
 1/4" = 1'-0"


REVISION HISTORY		
NO.	DESCRIPTION	DATE

PERMIT REVISION

DATE:	AUG 18, 2023
SCALE:	1/4" = 1'-0"
DRAWN BY:	CJ
CHECKED BY:	CR

SHEET TITLE	PROJECT #
ROOF PLAN	40035

ROOF PLAN

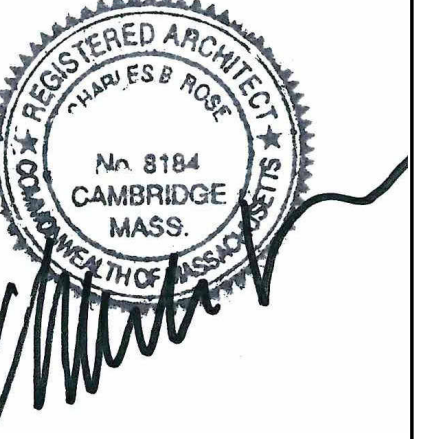


FINISH PLAN LEGEND

Room name	ROOM #
CPT-1	FLOOR TYPE
RB-1	BASE TYPE
PNT-1	WALL FINISH
ACT-1	CEILING TYPE

CHANGE IN FLOORING FINISH, SEE TYPICAL FLOORING TRANSITION DETAILS

FLOORING TRANSITION NOTE:
1. ALIGN TRANSITION WITH INTERIOR FACE OF RECESSED GLASS SHOE, AT FLUSH WOOD DOORS.
2. TRANSITION FLOORING UNDER CLOSED DOOR.

A1 ACCENT FINISH, SEE SCHED. ON A8.30

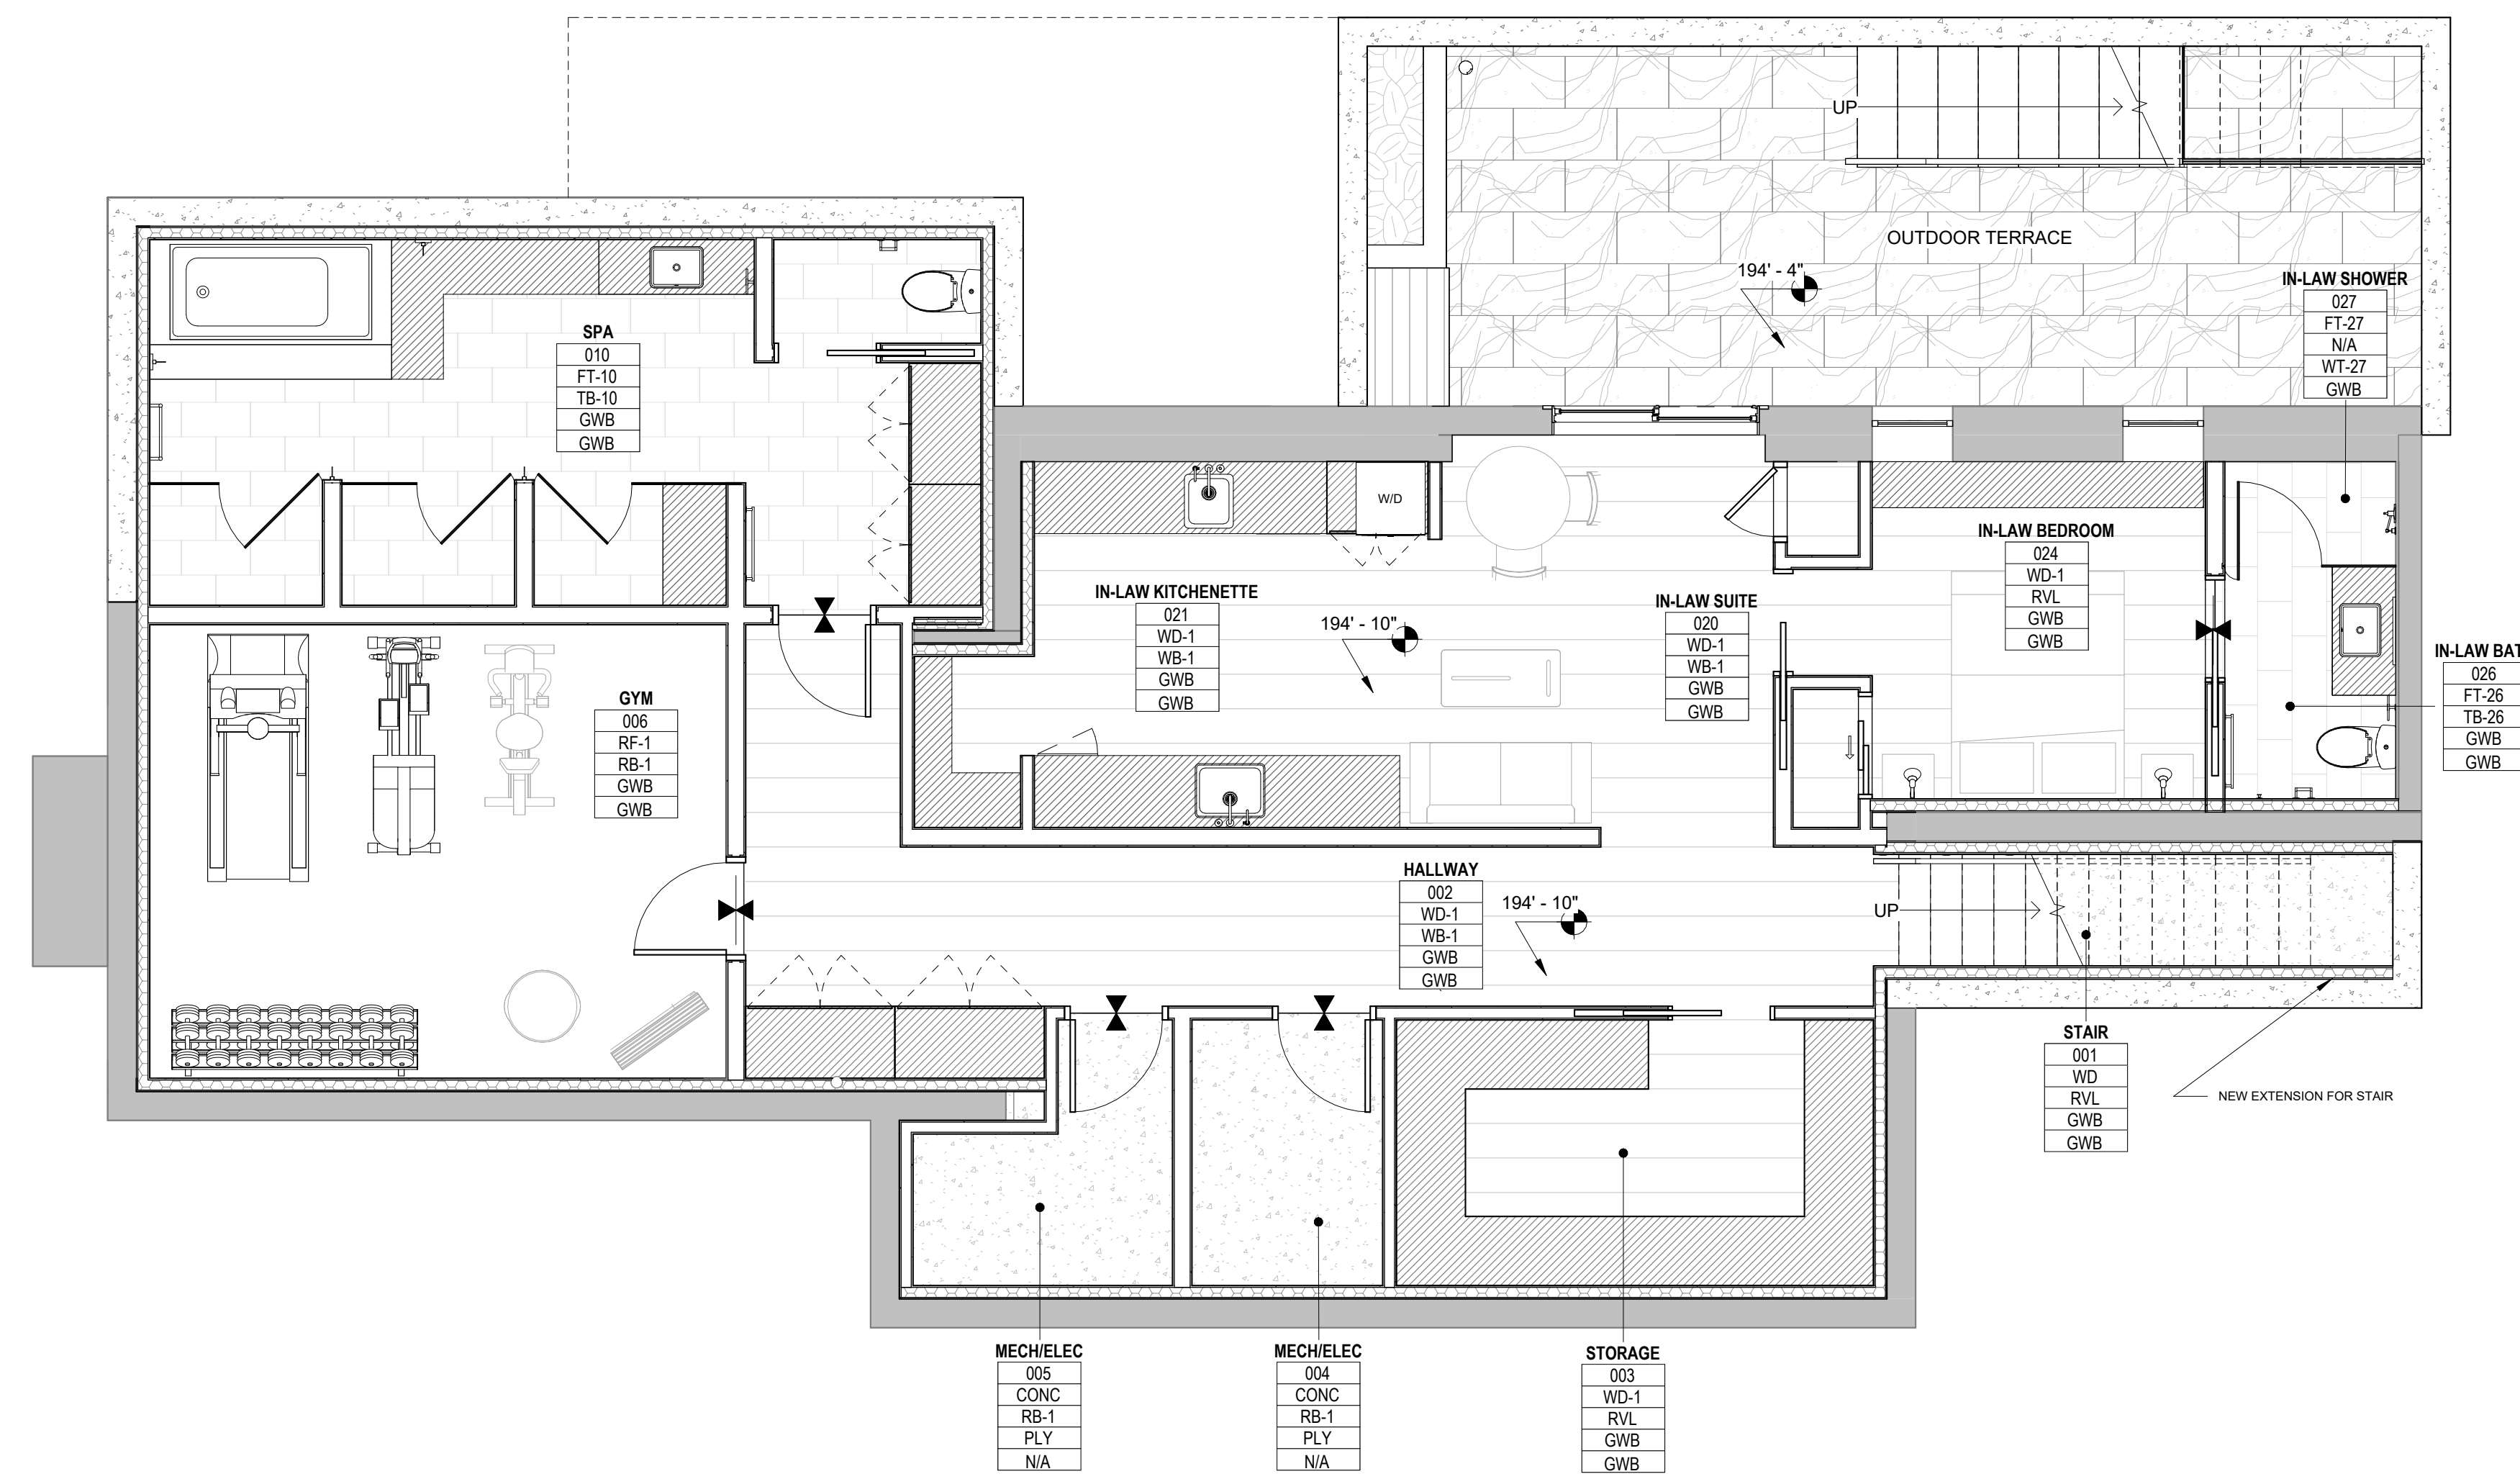

REVISION HISTORY		
NO.	DESCRIPTION	DATE

PERMIT REVISION

DATE:	SEPT 6, 2023
SCALE:	As indicated
DRAWN BY:	CJ
CHECKED BY:	CR

SHEET TITLE PROJECT #: 40035

LOWER LEVEL
FLOOR FINISH PLAN




FINISH PLAN LEGEND

Room name	ROOM #
101	101
CPT-1	FLOOR TYPE
RB-1	BASE TYPE
PNT-1	WALL FINISH
ACT-1	CEILING TYPE

CHANGE IN FLOORING FINISH. SEE TYPICAL FLOORING TRANSITION DETAILS

FLOORING TRANSITION NOTE:
 1. ALIGN TRANSITION WITH INTERIOR FACE OF RECESSED GLASS SHOE. AT FLUSH WOOD DOORS.
 2. TRANSITION FLOORING UNDER CLOSED DOOR.

A1 ACCENT FINISH, SEE SCHED. ON A8.30

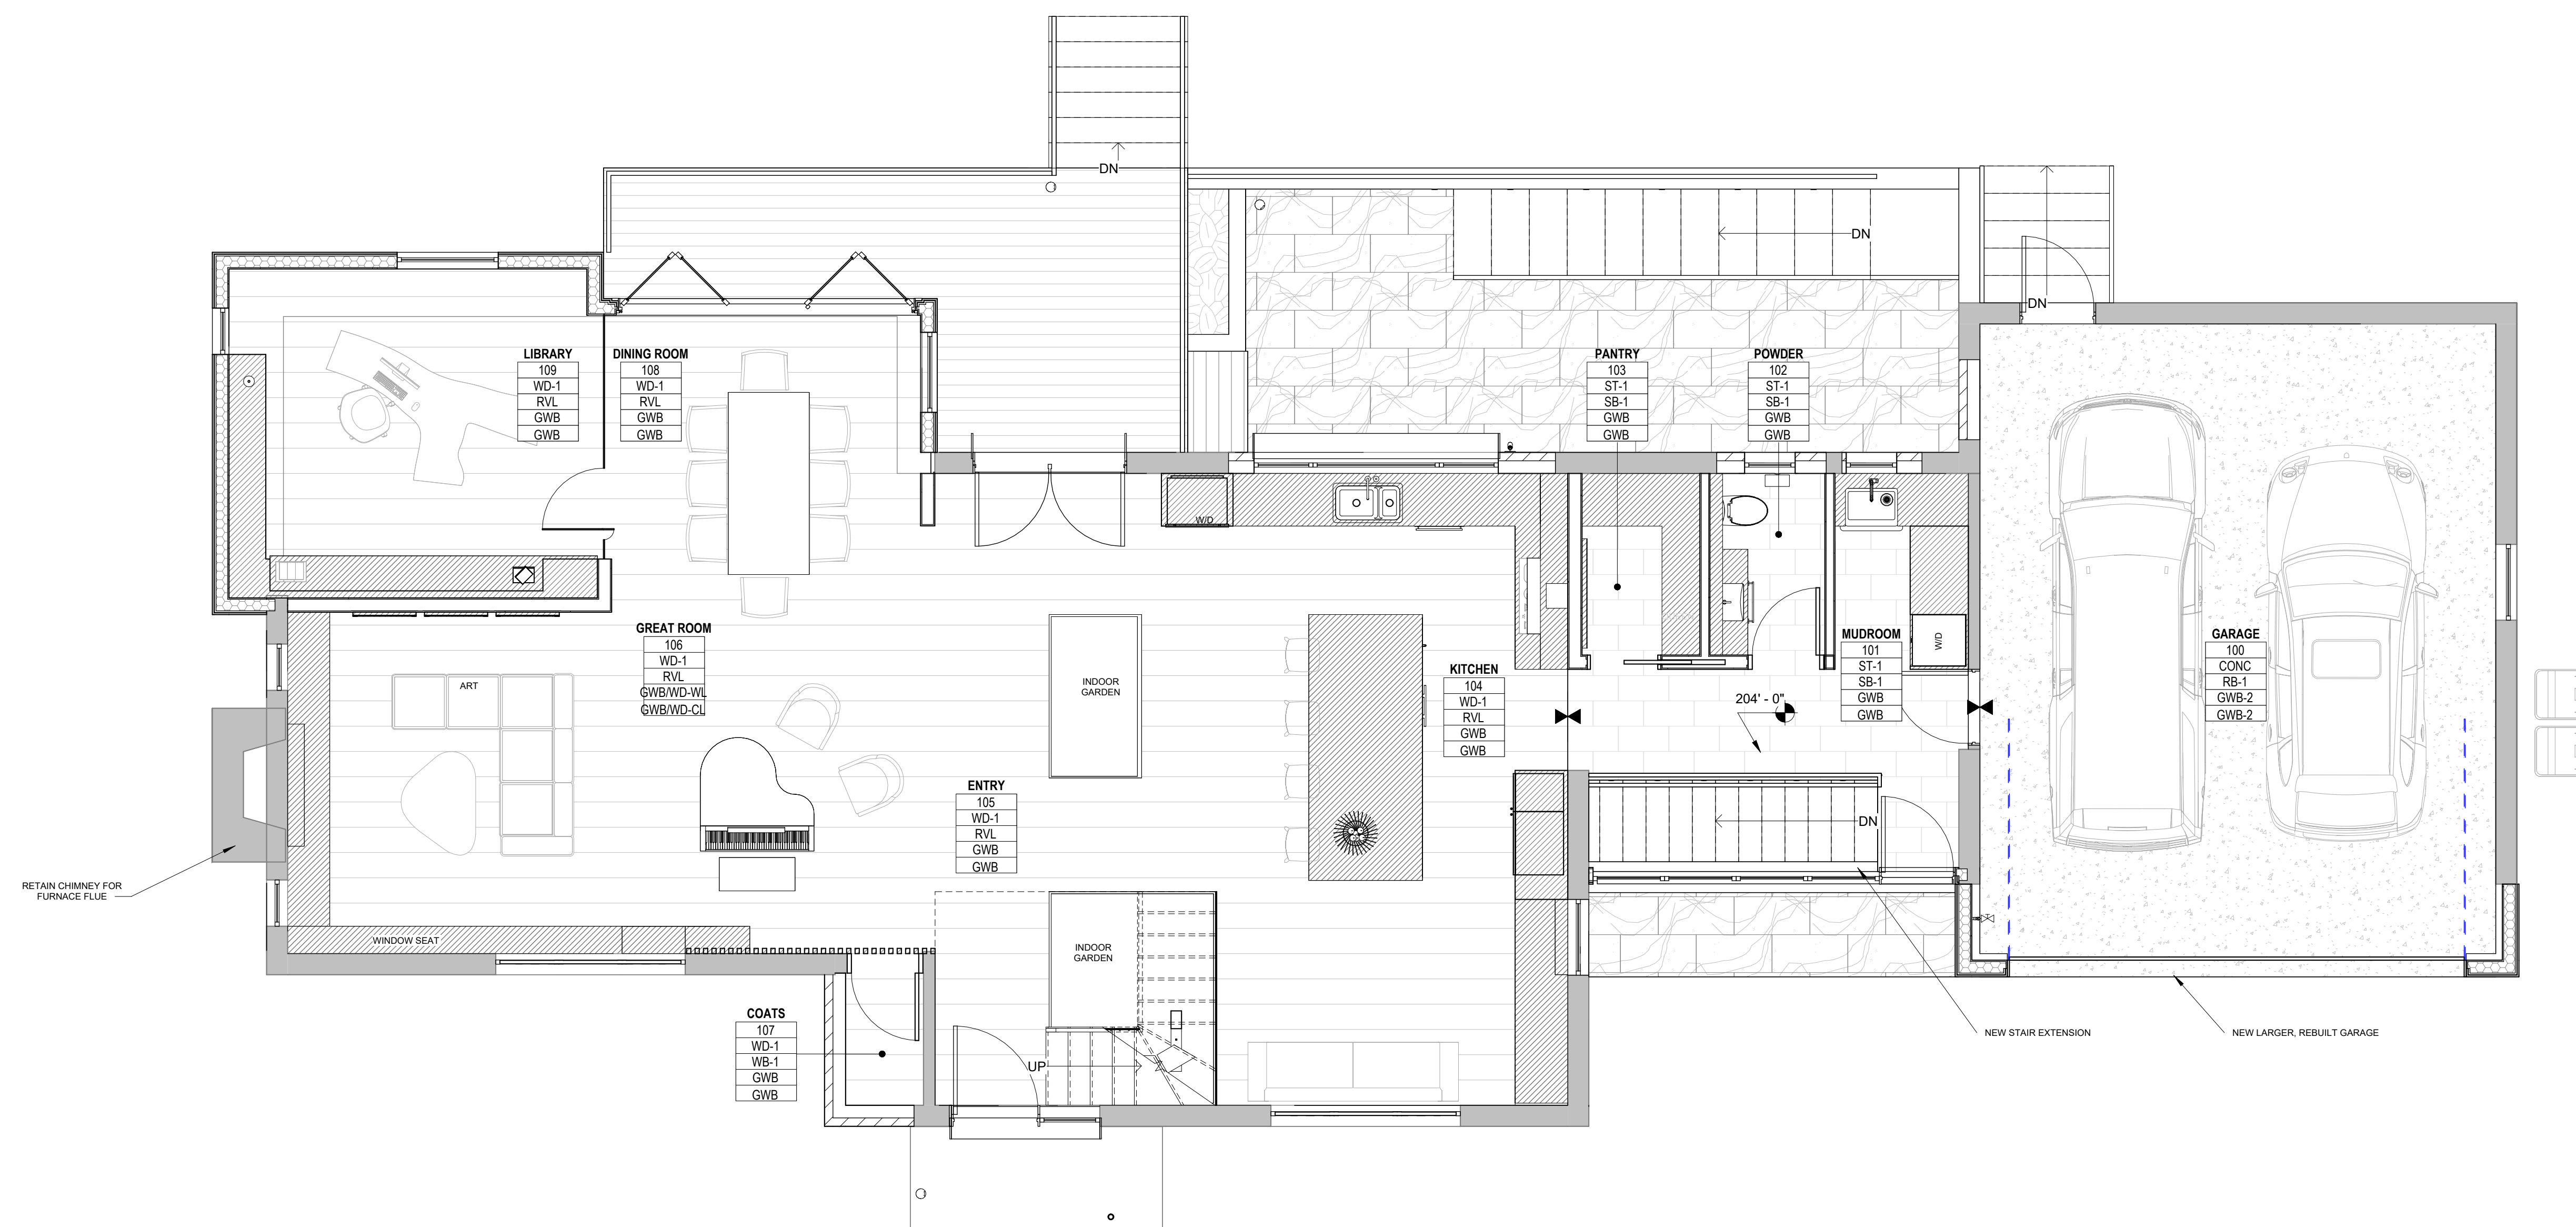

REVISION HISTORY		
NO.	DESCRIPTION	DATE


PERMIT REVISION

DATE: AUG 18, 2023
 SCALE: As indicated
 DRAWN BY: CJ
 CHECKED BY: CR

SHEET TITLE: PROJECT #: 40035

FIRST FLOOR FINISH PLAN

A2.21

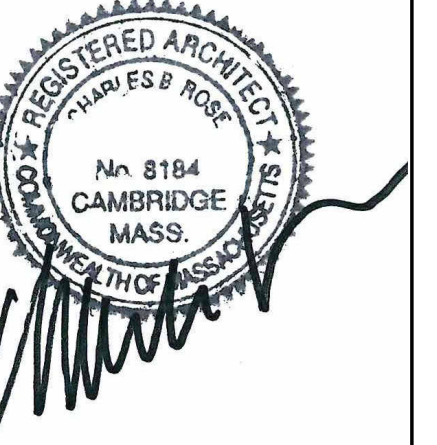


FINISH PLAN LEGEND

Room name	ROOM #
101	
CPT-1	FLOOR TYPE
FB-1	BASE TYPE
PNT-1	WALL FINISH
ACT-1	CEILING TYPE

CHANGE IN FLOORING FINISH, SEE TYPICAL FLOORING TRANSITION DETAILS

FLOORING TRANSITION NOTE:
1. ALIGN TRANSITION WITH INTERIOR FACE OF RECESSED GLASS SHOE, AT FLUSH WOOD DOORS.
2. TRANSITION FLOORING UNDER CLOSED DOOR.

A1 ACCENT FINISH, SEE SCHED. ON A8.30

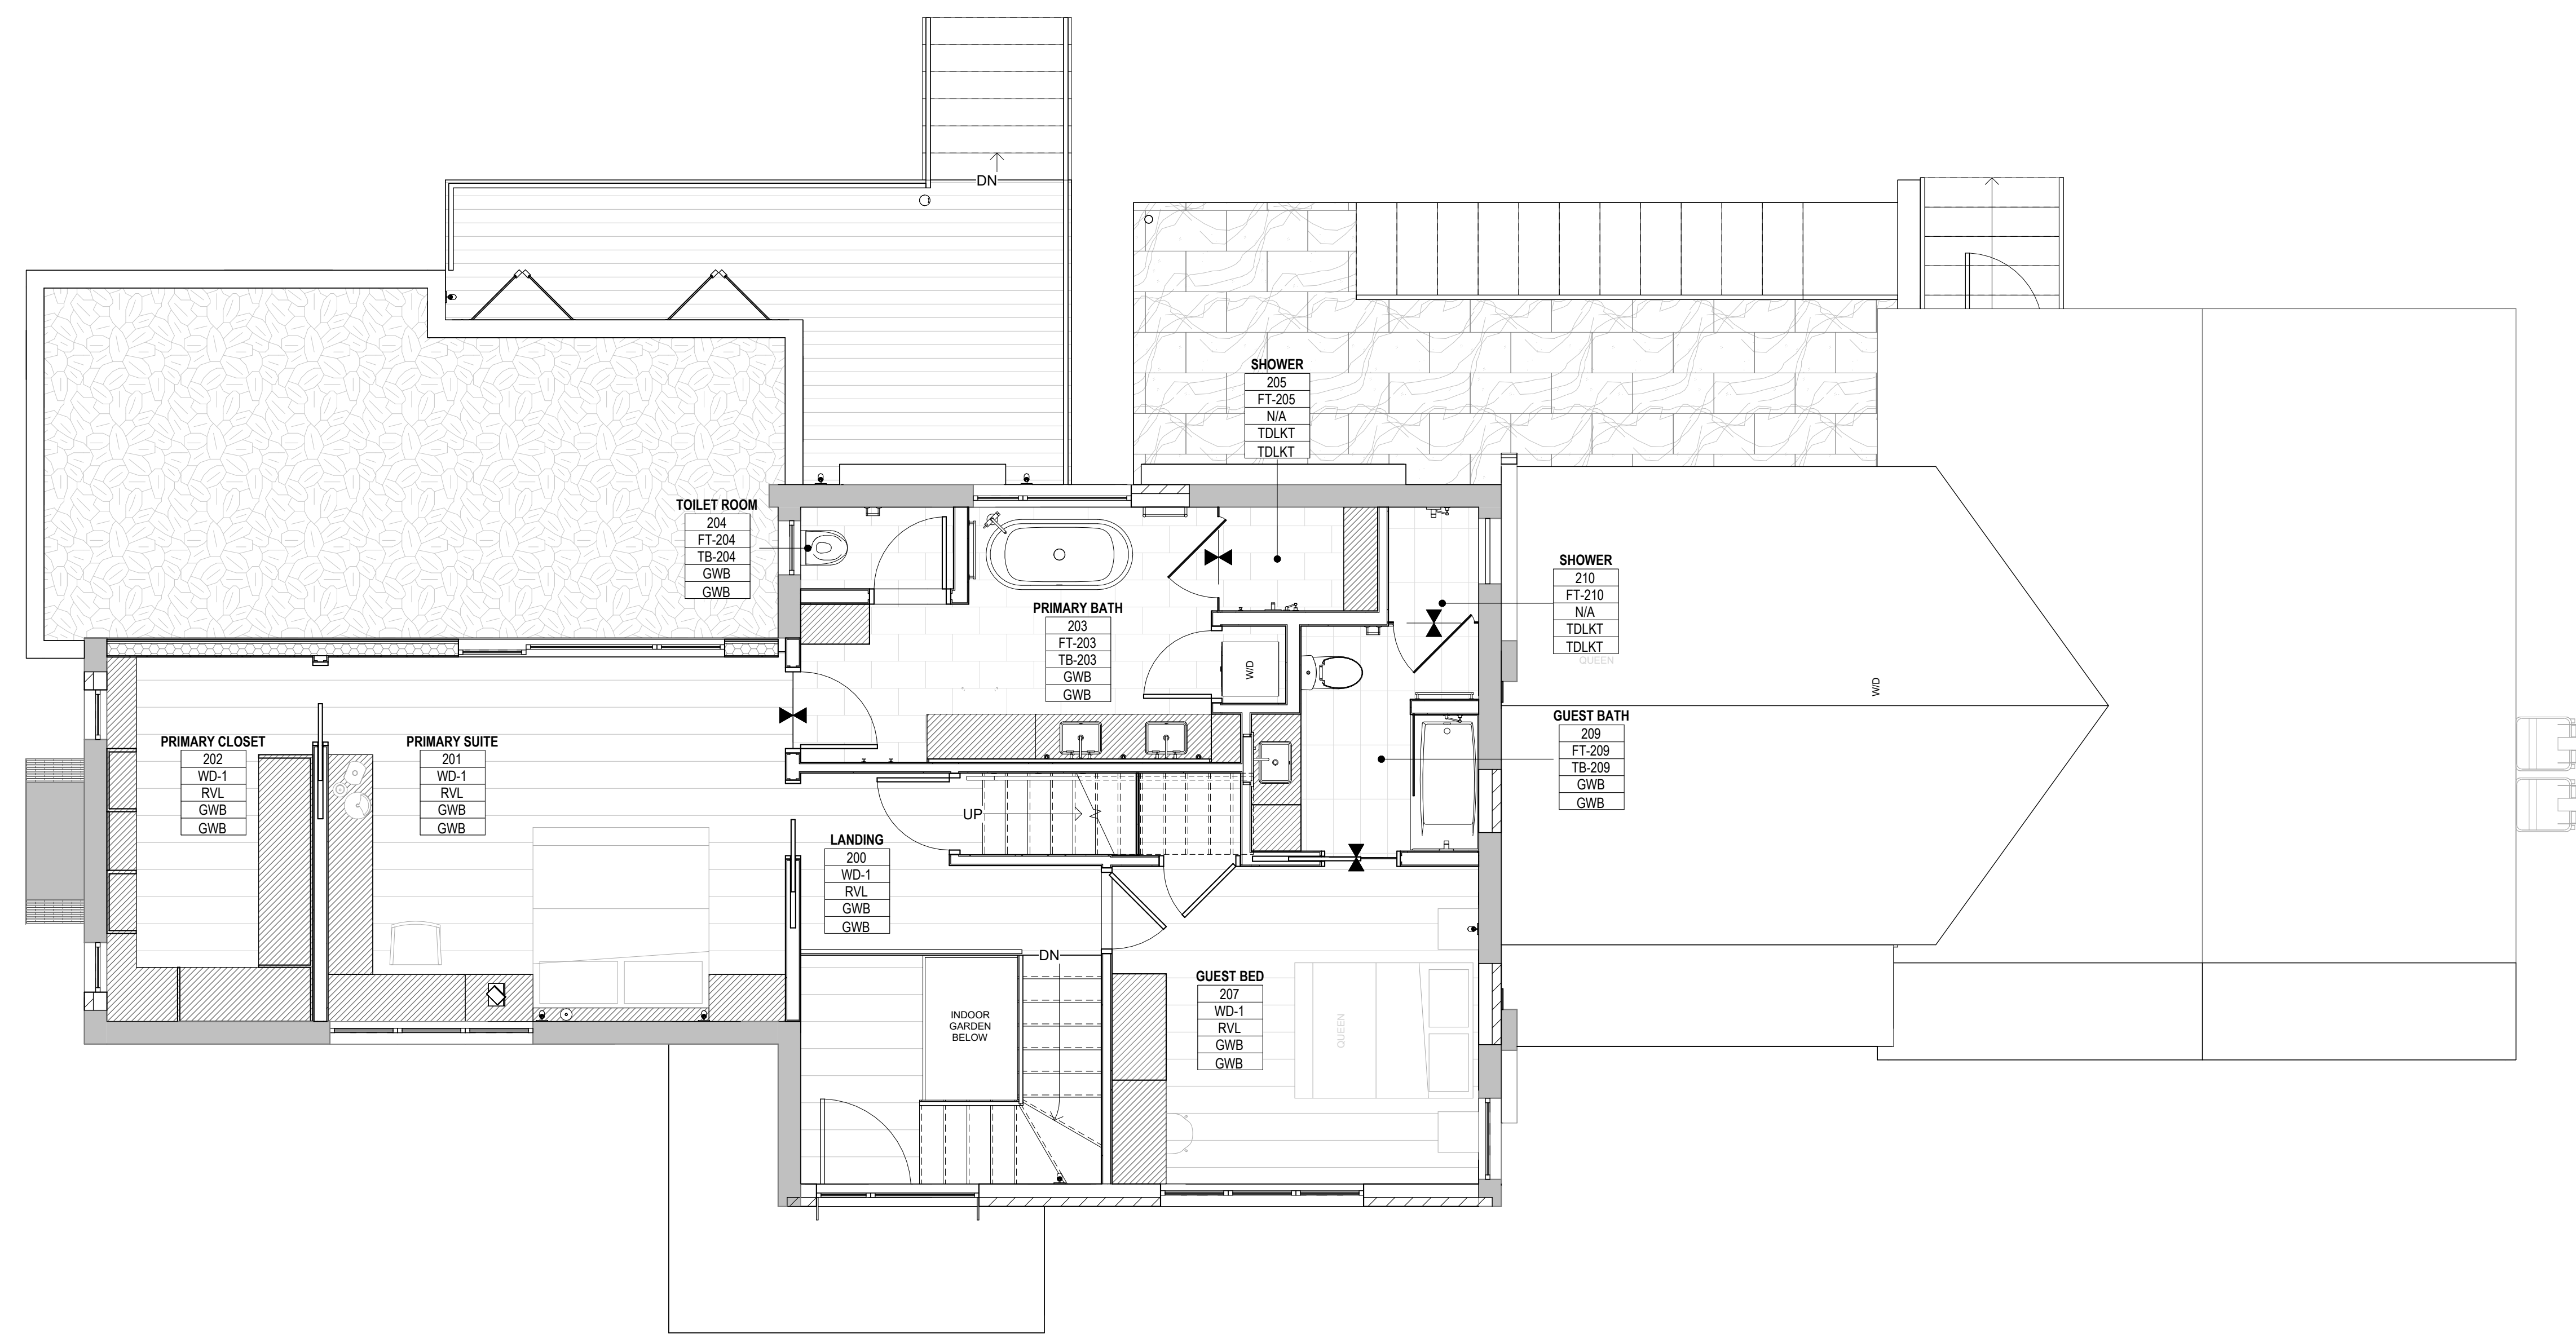

REVISION HISTORY		
NO.	DESCRIPTION	DATE


PERMIT REVISION

DATE:	AUG 18, 2023
SCALE:	As indicated
DRAWN BY:	CJ
CHECKED BY:	CR

SHEET TITLE PROJECT # 40035

SECOND FLOOR FINISH PLAN

A2.22

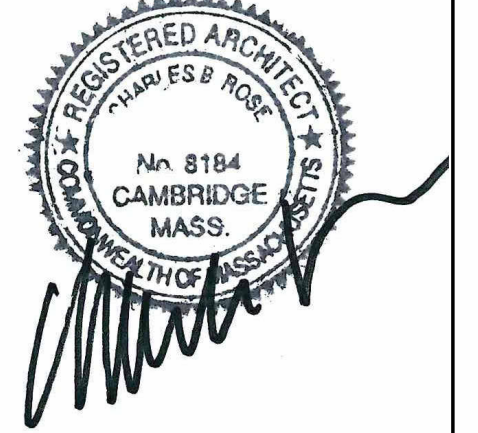


FINISH PLAN LEGEND

Room name	ROOM #
101	
CPT-1	FLOOR TYPE
FB-1	BASE TYPE
PNT-1	WALL FINISH
ACT-1	CEILING TYPE

CHANGE IN FLOORING FINISH, SEE TYPICAL FLOORING TRANSITION DETAILS

FLOORING TRANSITION NOTE:
 1. ALIGN TRANSITION WITH INTERIOR FACE OF RECESSED GLASS SHOE, AT FLUSH WOOD DOORS
 2. TRANSITION FLOORING UNDER CLOSED DOOR.

A1 ACCENT FINISH, SEE SCHED. ON A8.30

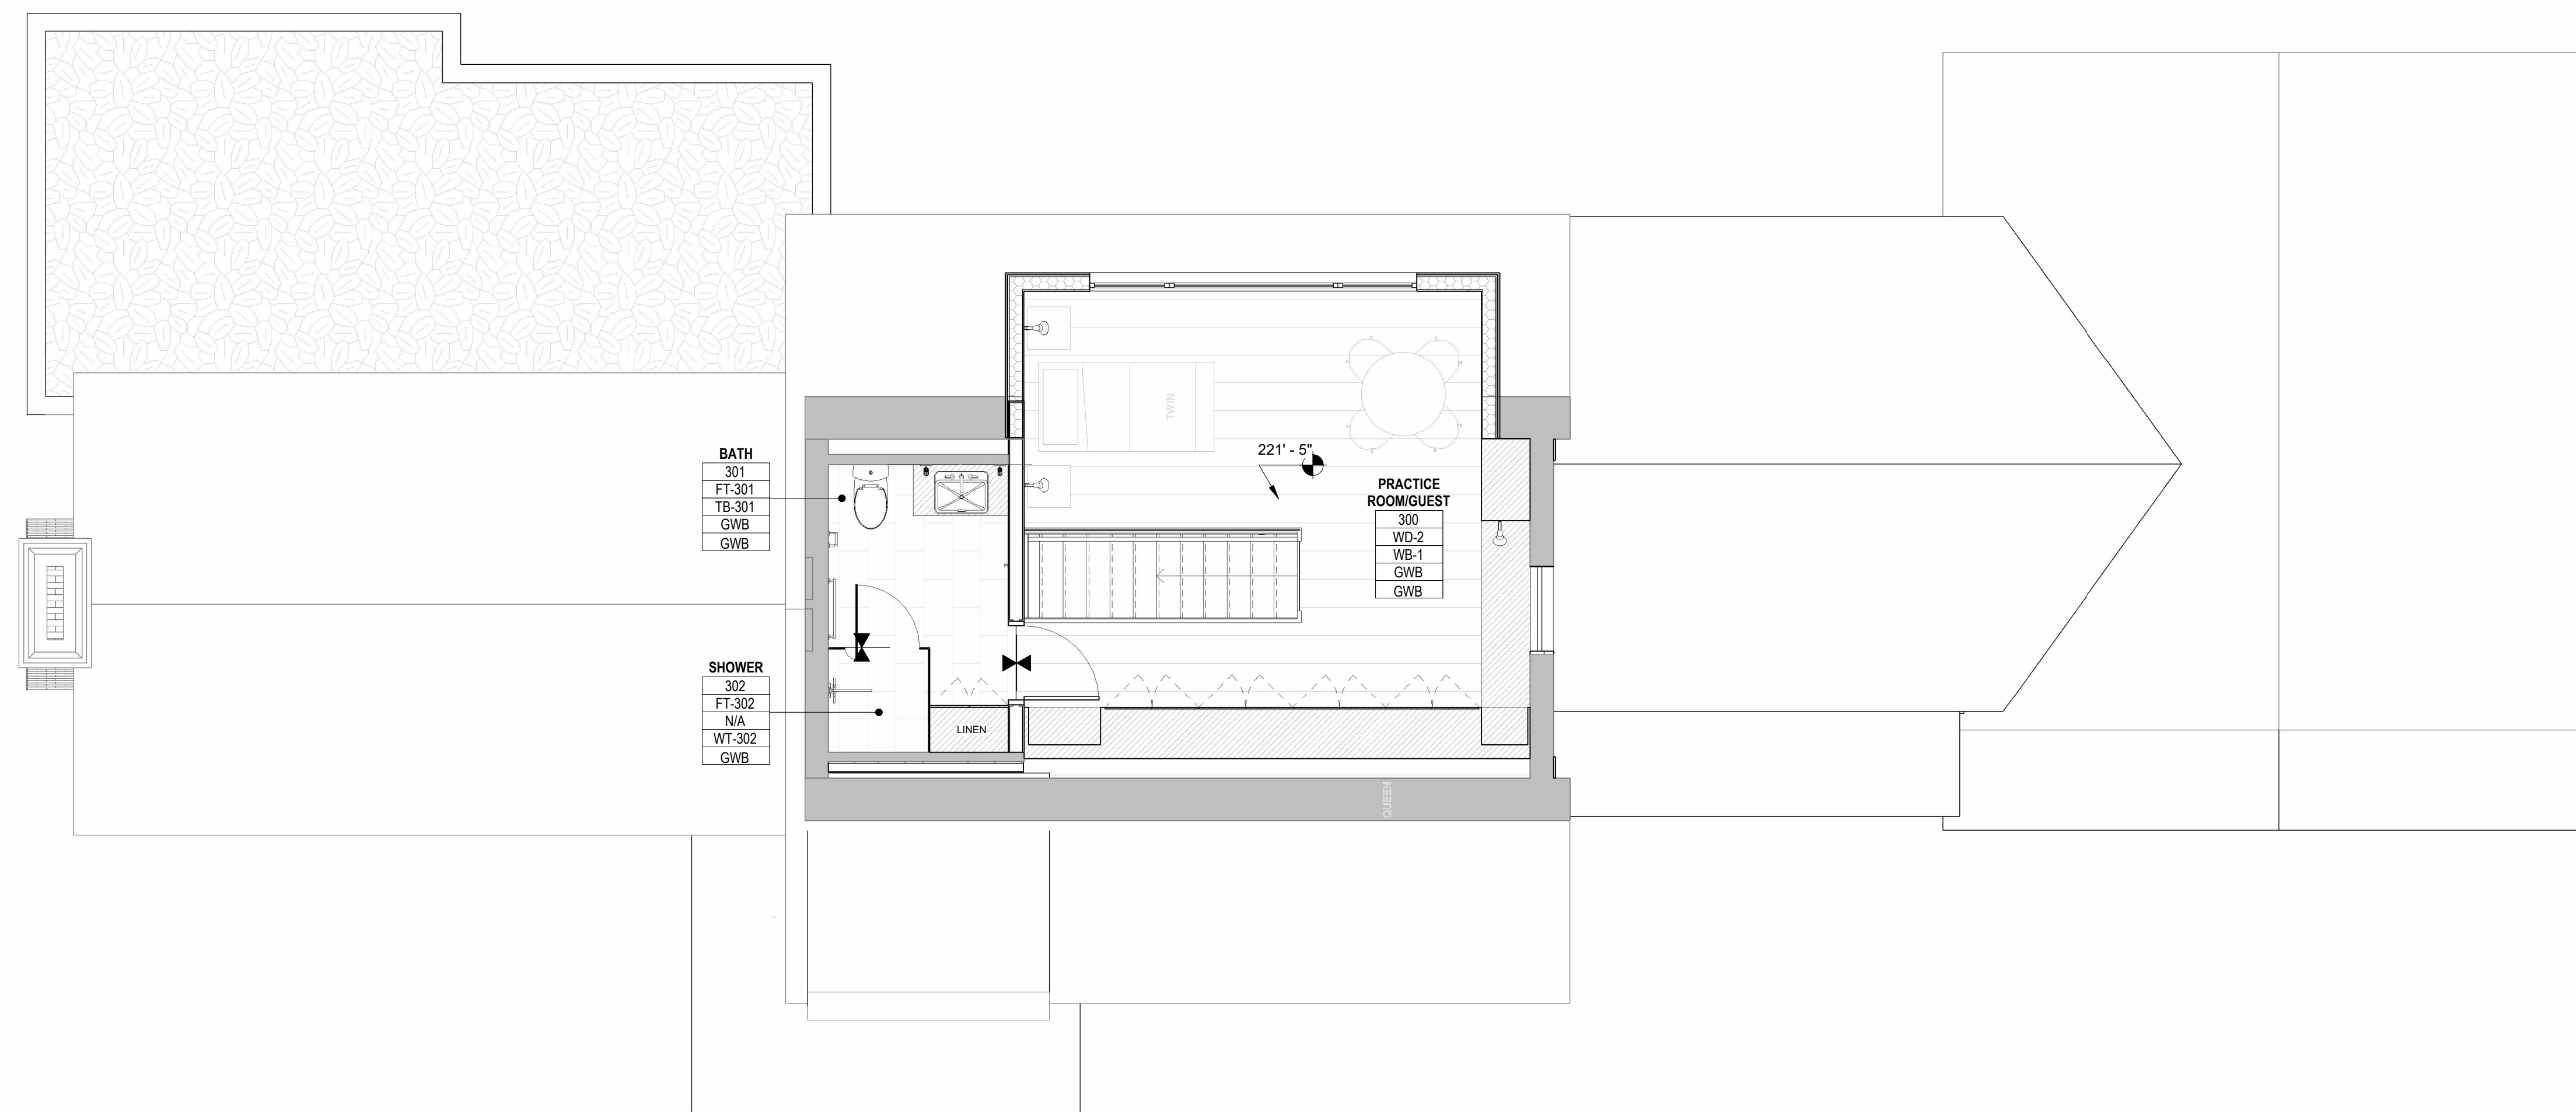

REVISION HISTORY		
NO.	DESCRIPTION	DATE



PERMIT REVISION

DATE: AUG 18, 2023
 SCALE: As indicated
 DRAWN BY: CJ
 CHECKED BY: CR

SHEET TITLE: PROJECT #: 40035

THIRD FLOOR FINISH PLAN

A2.23

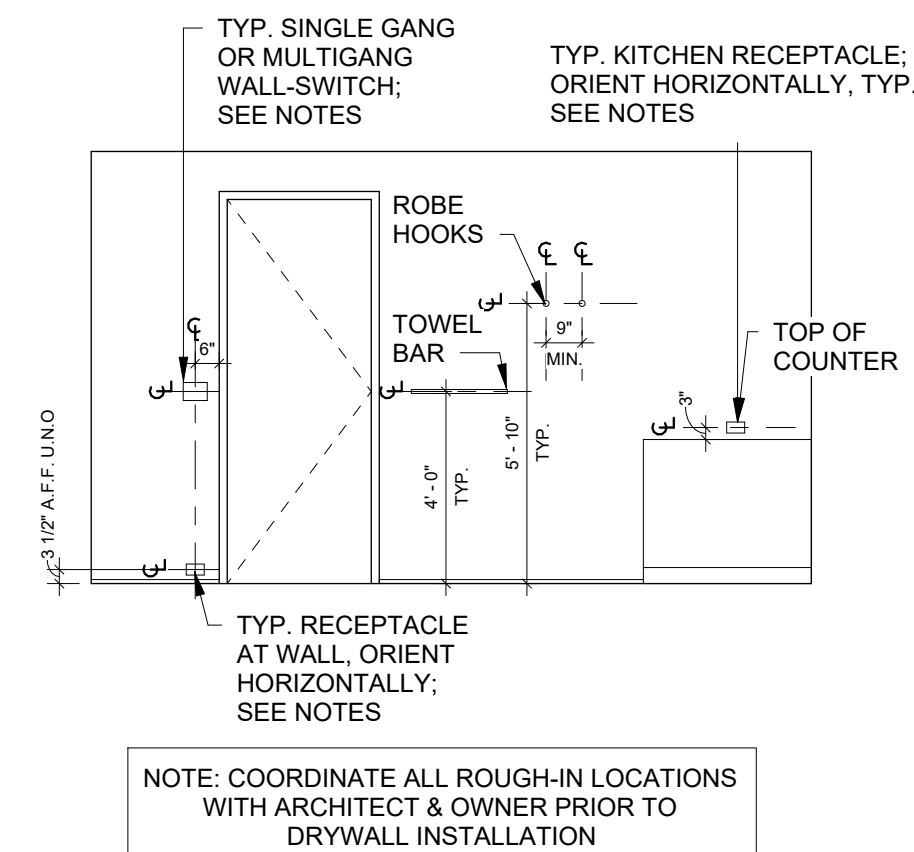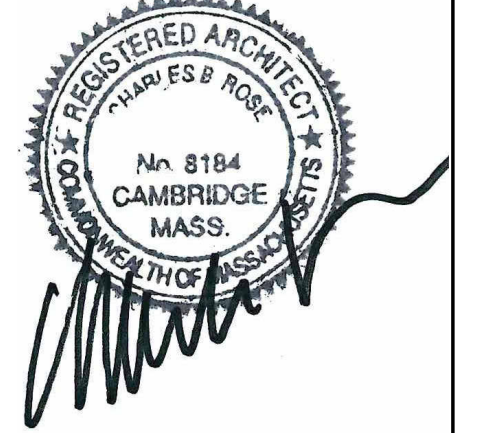

CEILING PLAN KEY NOTES

1. MOTORIZED ROLL DOWN SHADE, RECESSED POCKET TYPE
2. RECESSED CURTAIN TRACK BY SILENT GLISS
3. MOTORIZED ROLL DOWN SHADE, RECESSED POCKET TYPE WITH RECESSED CURTAIN TRACK
4. 1" LINEAR SLOT DIFFUSER, FLOWBAR, GWB INSTALLATION FLANGE, MITER AT CORNERS, FL-10 TYPE 22
5. RETURN GRILLE

ELECTRICAL PLAN GENERAL NOTES

1. ELECTRICAL CONTRACTOR TO COORDINATE THE EXACT RECEPTACLE TYPE AND VOLTAGE FOR ALL EQUIPMENT WITH THE RESPECTIVE EQUIPMENT SUPPLIER PRIOR TO INSTALLATION.
2. STACK DEVICES, OUTLETS, AND SWITCHES WHENEVER POSSIBLE DEVICES, OUTLETS, AND SWITCHES SHALL BE CLEAR OF DOOR SWINGS
3. REFER TO ARCHITECTURAL DRAWINGS FOR EXACT DEVICE LOCATIONS (RECEPTACLES, DETECTORS, DATA OUTLETS, AND TELEPHONE JACKS - TYPICAL) AND ADJUST ACCORDINGLY. THE ARCHITECT IS TO BE NOTIFIED OF ANY CONFLICTS WITH THE DEVICE LOCATIONS AND THE N.E.C. REQUIREMENTS.
4. REFERENCE ARCHITECTURAL RCPs FOR SMOKE DETECTORS, CO DETECTORS, AND SWITCH PLATE SPECIFICATIONS
5. ALL EXTERIOR LIGHTS TO BE "SMART" SWITCHED IN ADDITION TO PHYSICAL.

GENERAL REFLECTED CEILING PLAN NOTES


1. ALL CEILINGS ARE GWB, UNLESS NOTED OTHERWISE
2. ALL DIMENSION TO CENTERLINES OF LIGHTING FIXTURES & FINISH FACE OF WALL, U.N.O.
3. REVIEW LOCATIONS OF SMOKE DETECTORS WITH ARCHITECT PRIOR TO INSTALLING
4. REVIEW LOCATIONS AND MOUNTING HEIGHTS FOR WALL HUNG LIGHTING FIXTURES WITH ARCHITECT PRIOR TO INSTALLING
5. REF E-DWGS FOR SWITCHING INFORMATION
6. ALL LIGHTS TO BE DIMMABLE
7. BUSTER & PUNCH SWITCHES/DIMMERS IN KITCHEN, DINING, AND LIVING
8. ALL OUTLETS IN WHITE GYPSUM WALLS TO BE LUTRON MAESTRO, SATIN WHITE
9. ALL OUTLETS IN OTHER MATERIALS TO BE COORDINATED WITH OWNER AND ARCHITECT
10. ALL BEDSIDE OUTLETS TO BE USB OUTLETS
11. FLOOR OUTLETS IN FRAMED FLOORS TO BE ARLINGTON FLBRS20, FINISH TO BE COORDINATED WITH OWNER/ARCHITECT
12. FLOOR OUTLETS IN CONCRETE SLABS TO BE ARLINGTON FLBRS570, FINISH TO BE COORDINATED WITH OWNER/ARCHITECT
13. RADIANT HEAT, FANS, AND CLOSET LIGHT SWITCHES AND CONTROLS SHALL BE CONCEALED IN CLOSET/MILLWORK WHERE POSSIBLE

REFLECTED CEILING PLAN LEGEND

- GYPSUM CEILING BOARD
- WOOD CEILING
- CEILING HEIGHT

RCP DEVICE LEGEND

- COMBO SMOKE/CO DETECTOR, HARDWIRED WITH 10 YR BATTERY BACKUP (KIDDIE P4010ACSO-W OR APPROVED SIMILAR)
- SECURITY CAMERA
- MOTION SENSOR
- SPRINKLER HEAD

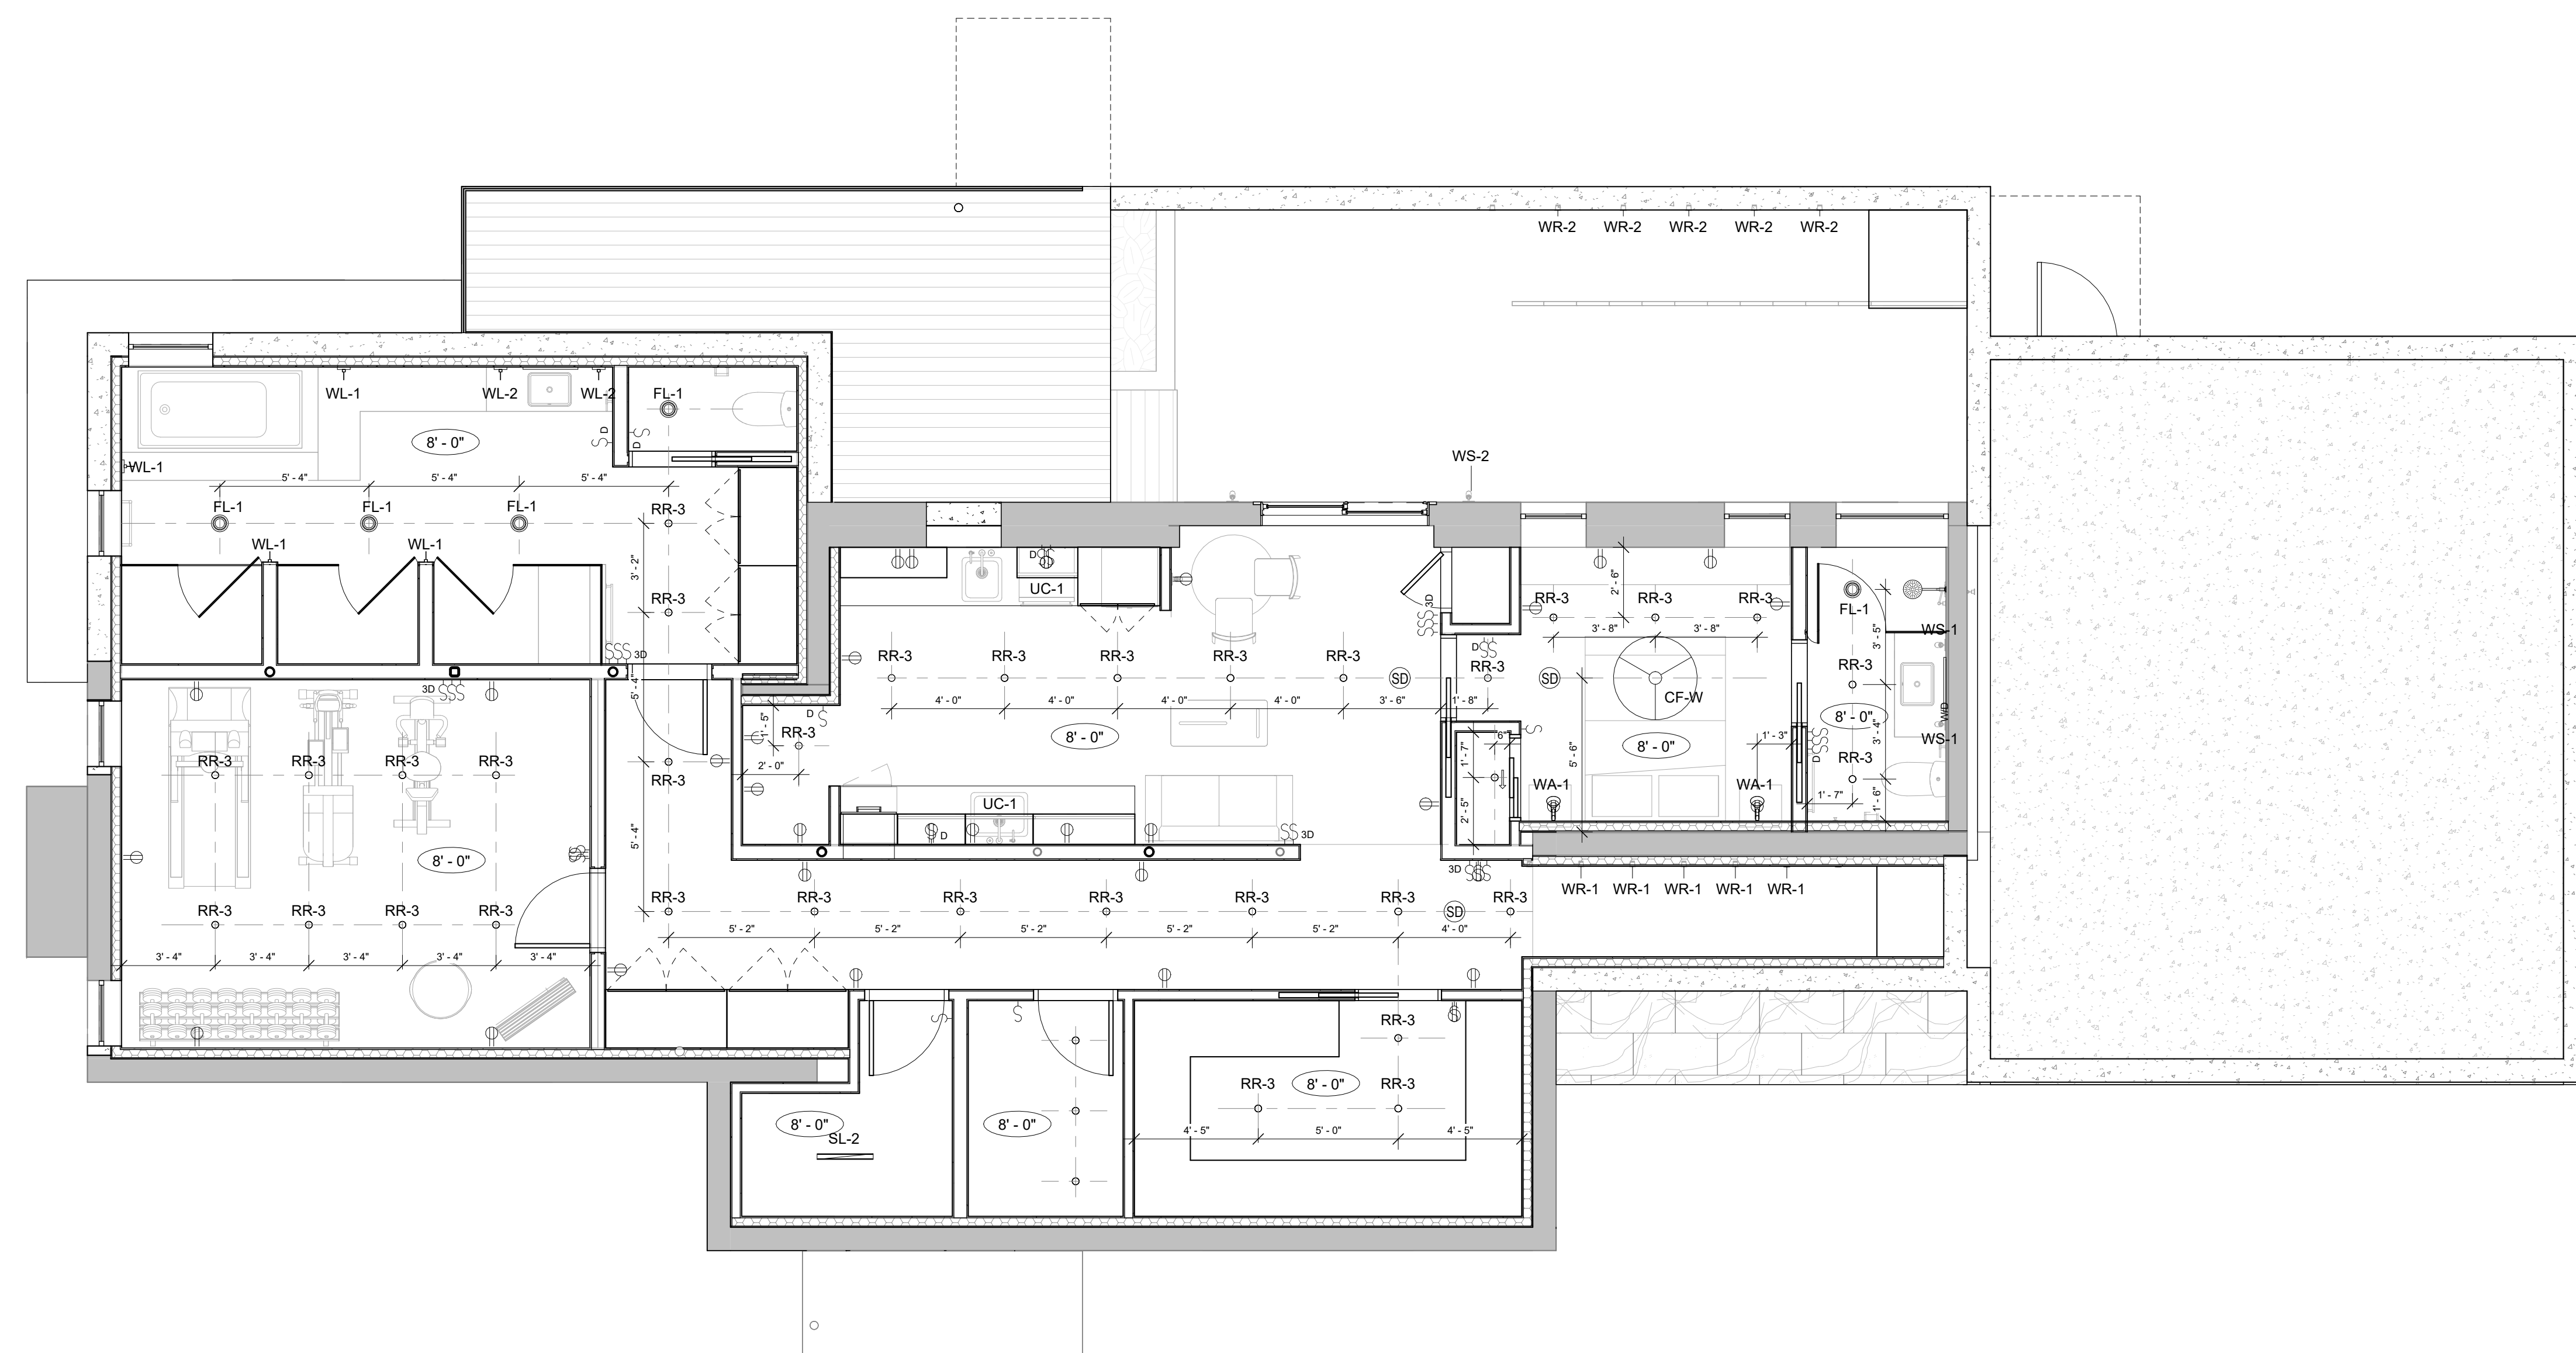

REVISION HISTORY

NO.	DESCRIPTION	DATE



PERMIT REVISION

DATE:	SEPT 6, 2023
SCALE:	As indicated
DRAWN BY:	CJ
CHECKED BY:	CR

SHEET TITLE: PROJECT #: 40035

LOWER LEVEL REFLECTED CEILING PLAN

A3.10

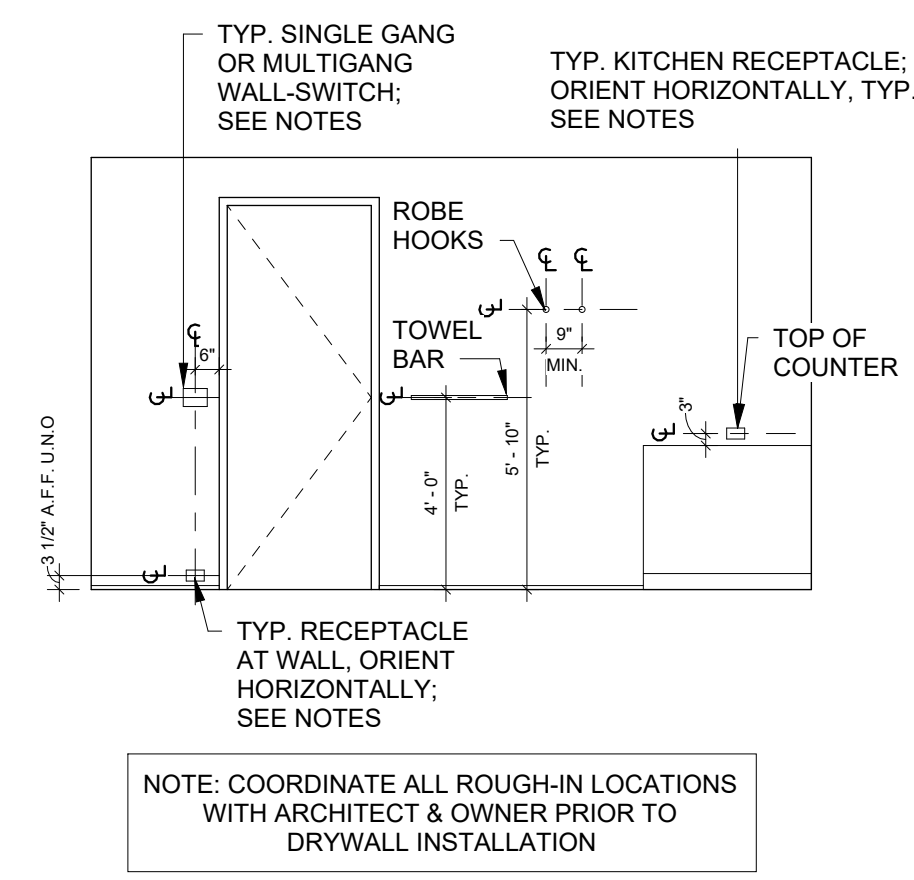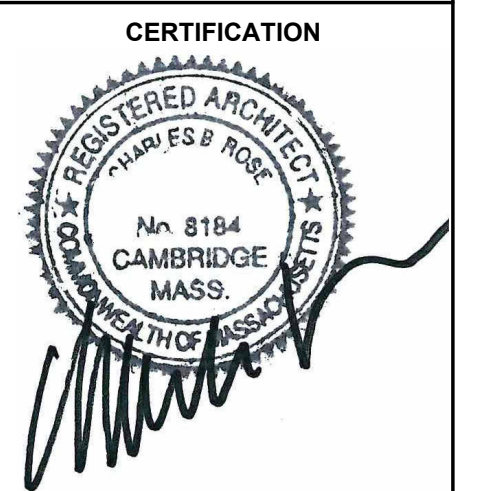

CEILING PLAN KEY NOTES

1. MOTORIZED ROLL DOWN SHADE, RECESSED POCKET TYPE
2. RECESSED CURTAIN TRACK BY SILENT GLISS
3. MOTORIZED ROLL DOWN SHADE, RECESSED POCKET TYPE WITH RECESSED CURTAIN TRACK
4. 1" LINEAR SLOT DIFFUSER, FLOWBAR, GWB INSTALLATION FLANGE, MITER AT CORNERS, FL-10 TYPE 22
5. RETURN GRILLE

ELECTRICAL PLAN GENERAL NOTES

1. ELECTRICAL CONTRACTOR TO COORDINATE THE EXACT RECEPTACLE TYPE AND VOLTAGE FOR ALL EQUIPMENT WITH THE RESPECTIVE EQUIPMENT SUPPLIER PRIOR TO INSTALLATION.
2. STACK DEVICES, OUTLETS, AND SWITCHES WHENEVER POSSIBLE.
3. SWITCHES SHALL BE CLEAR OF DOOR SWINGS.
4. REFER TO ARCHITECTURAL DRAWINGS FOR EXACT DEVICE LOCATIONS (RECEPTACLES, DETECTORS, DATA OUTLETS, AND TELEPHONE JACKS - TYPICAL) AND ADJUST ACCORDINGLY. THE ARCHITECT IS TO BE NOTIFIED OF ANY CONFLICTS WITH THE DEVICE LOCATIONS AND THE N.E.C. REQUIREMENTS. REFERENCE ARCHITECTURAL RCPs FOR SMOKE DETECTORS, CO DETECTORS, AND SWITCH PLATE SPECIFICATIONS.
5. ALL EXTERIOR LIGHTS TO BE "SMART" SWITCHED IN ADDITION TO PHYSICAL.

GENERAL REFLECTED CEILING PLAN NOTES


1. ALL CEILINGS ARE GWB, UNLESS NOTED OTHERWISE.
2. ALL DIMENSION TO CENTERLINES OF LIGHTING FIXTURES & FINISH FACE OF WALL, U.N.O.
3. REVIEW LOCATIONS OF SMOKE DETECTORS WITH ARCHITECT PRIOR TO INSTALLING.
4. REVIEW LOCATIONS AND MOUNTING HEIGHTS FOR WALL HUNG LIGHTING FIXTURES WITH ARCHITECT PRIOR TO INSTALLING.
5. REF E-DWGS FOR SWITCHING INFORMATION.
6. ALL LIGHTS TO BE DIMMABLE.
7. BUSTER & PUNCH SWITCHES/DIMMERS IN KITCHEN, DINING, AND LIVING.
8. ALL OUTLETS IN WHITE GYPSUM WALLS TO BE LUTRON MAESTRO, SATIN WHITE.
9. ALL OUTLETS IN OTHER MATERIALS TO BE COORDINATED WITH OWNER AND ARCHITECT.
10. ALL BEDSIDE OUTLETS TO BE USB OUTLETS.
11. FLOOR OUTLETS IN FRAMED FLOORS TO BE ARLINGTON FLBRS20, FINISH TO BE COORDINATED WITH OWNER/ARCHITECT.
12. FLOOR OUTLETS IN CONCRETE SLABS TO BE ARLINGTON FLBRS570, FINISH TO BE COORDINATED WITH OWNER/ARCHITECT.
13. RADIANT HEAT, FANS, AND CLOSET LIGHT SWITCHES AND CONTROLS SHALL BE CONCEALED IN CLOSETSMILLWORK WHERE POSSIBLE.

REFLECTED CEILING PLAN LEGEND

- GYPSUM CEILING BOARD
- WOOD CEILING
- CEILING HEIGHT

RCP DEVICE LEGEND

- COMBO SMOKE/CO DETECTOR, HARDWIRED WITH 10 YR BATTERY BACKUP (KIDDIE P4010ACSO-W OR APPROVED SIMILAR)
- SECURITY CAMERA
- MOTION SENSOR
- SPRINKLER HEAD

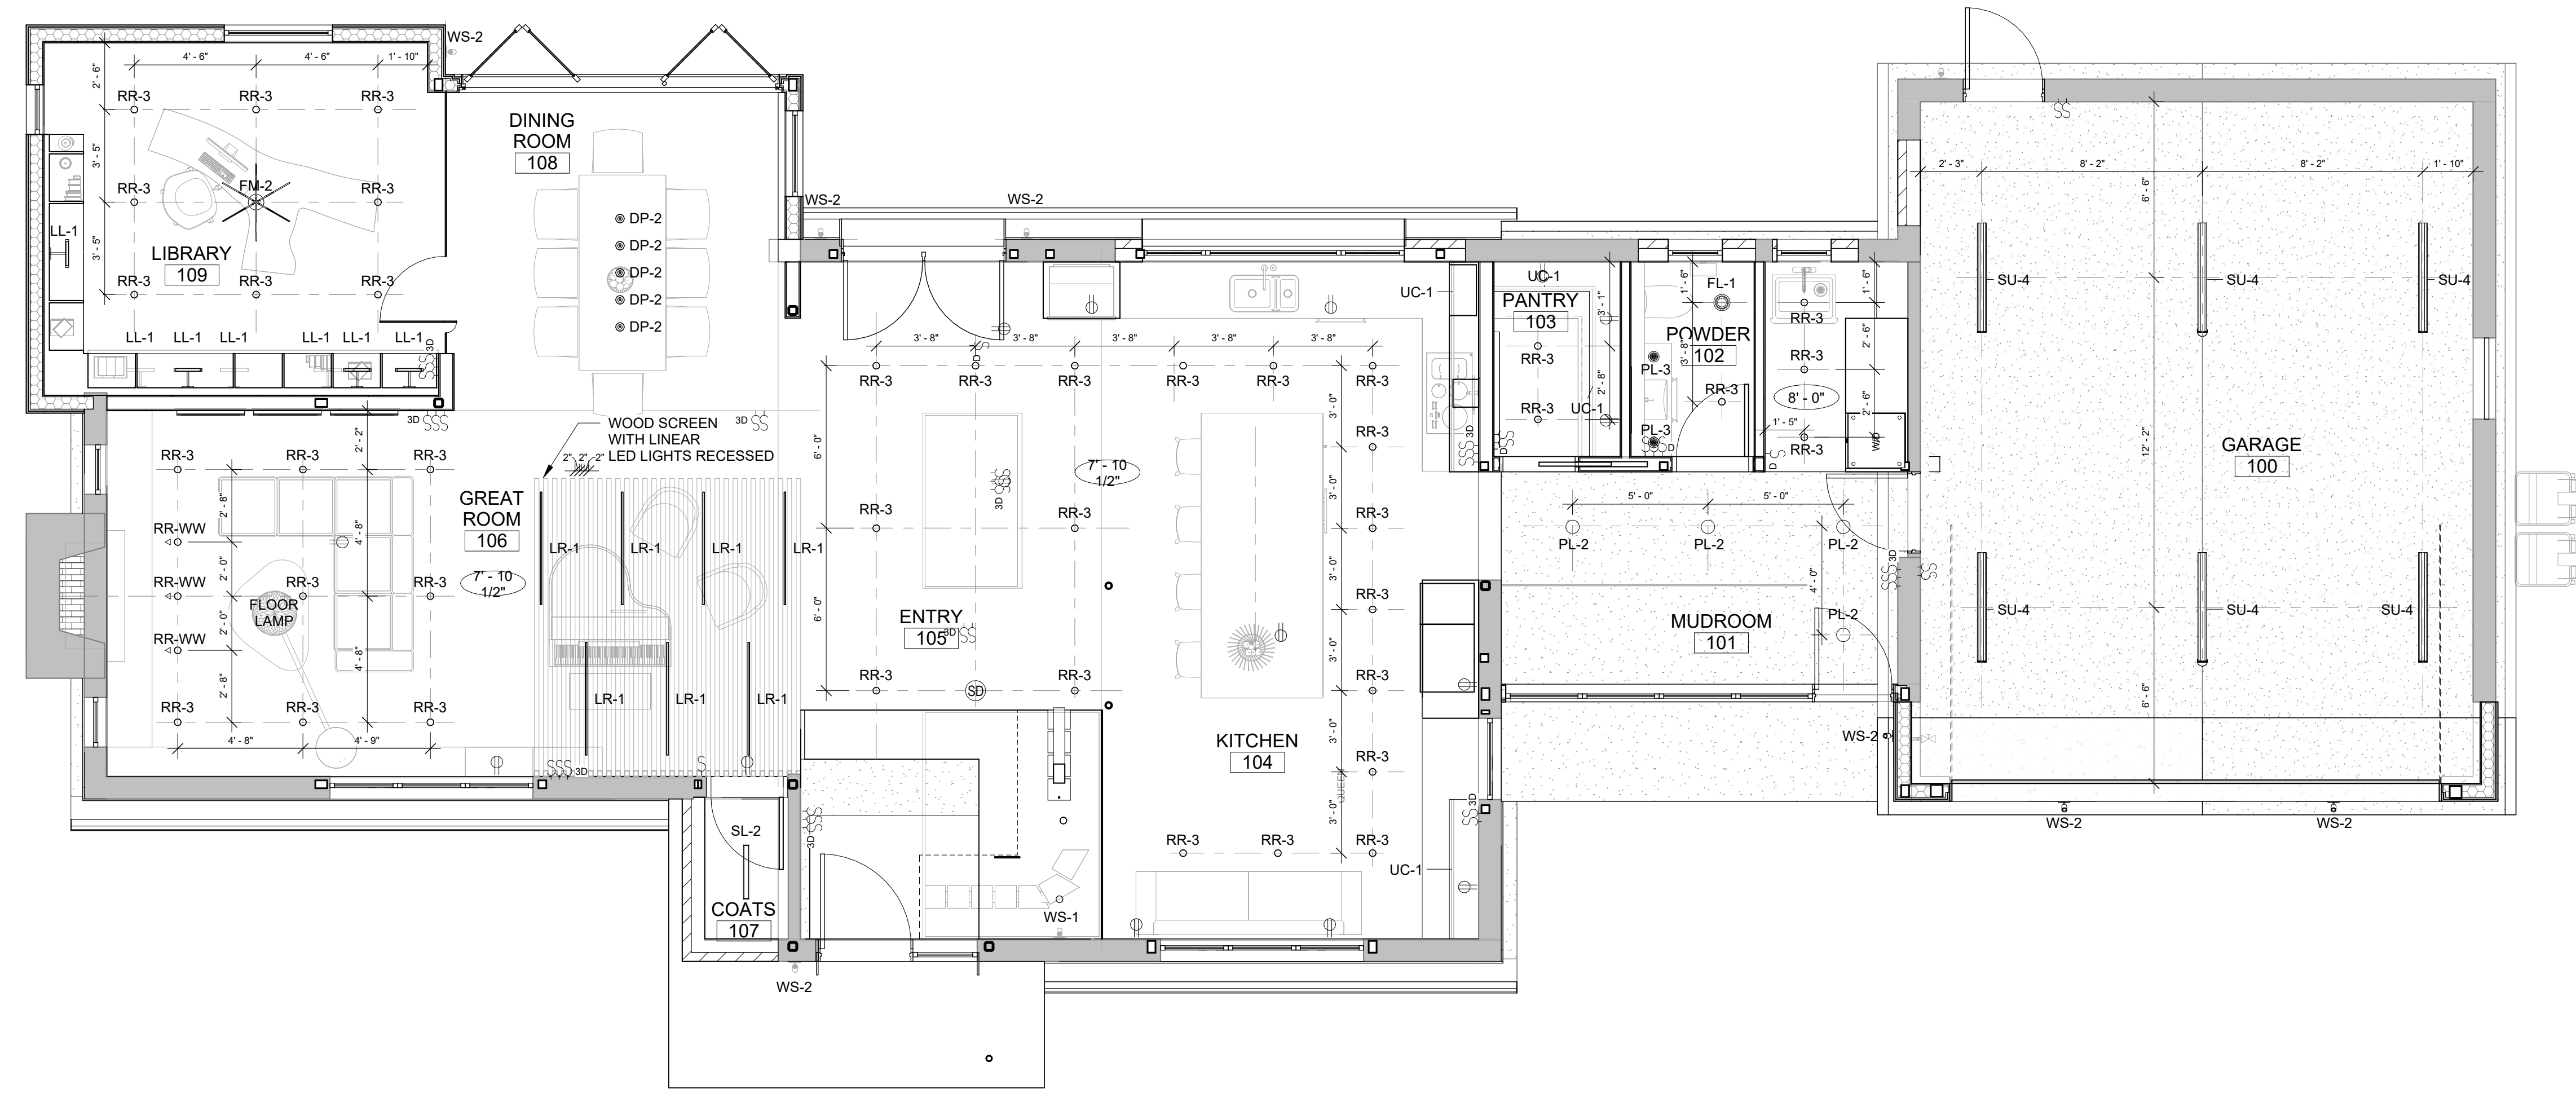

NO.	DESCRIPTION	DATE

PERMIT REVISION

DATE:	AUG 18, 2023
SCALE:	As indicated
DRAWN BY:	CJ
CHECKED BY:	CR


SHEET TITLE PROJECT #: 40035

FIRST FLOOR REFLECTED CEILING PLAN

A3.11



BAIRD RESIDENCE
16 WOODLAND ROAD
JAMAICA PLAIN, BOSTON, MA 02130

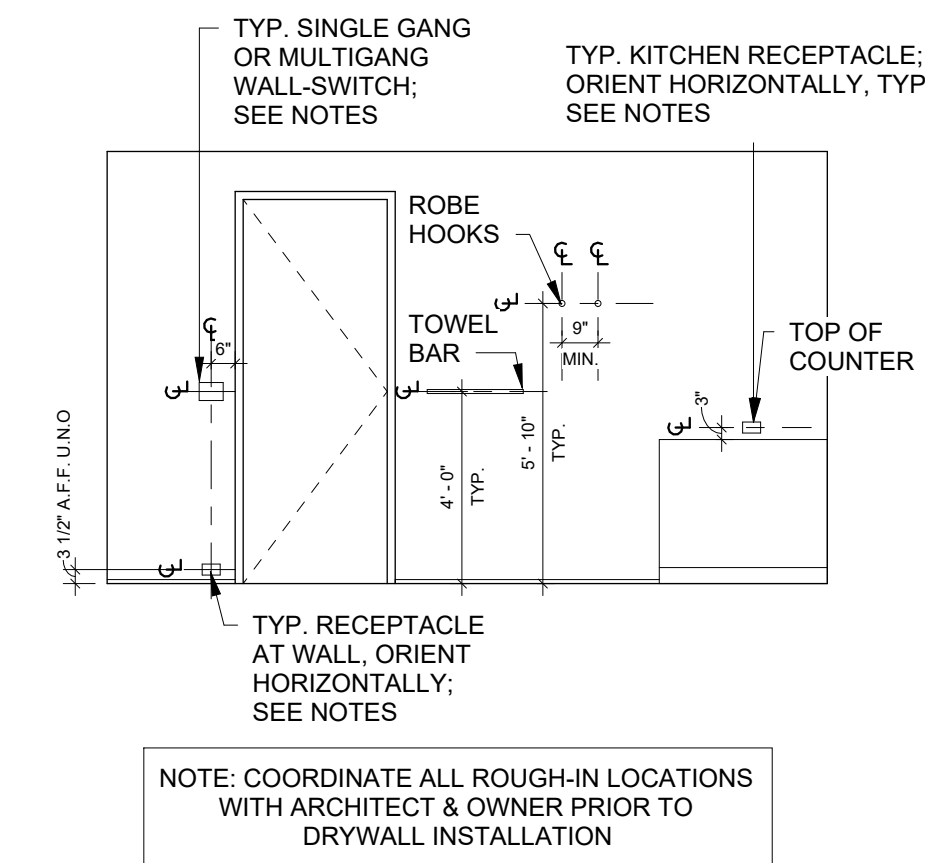

CEILING PLAN KEY NOTES

1. MOTORIZED ROLL DOWN SHADE, RECESSED POCKET TYPE
2. RECESSED CURTAIN TRACK BY SILENT GLISS
3. MOTORIZED ROLL DOWN SHADE, RECESSED POCKET TYPE WITH RECESSED CURTAIN TRACK
4. 1" LINEAR SLOT DIFFUSER, FLOWBAR, GWB INSTALLATION FLANGE, MITER AT CORNERS, FL-10 TYPE 22
5. RETURN GRILLE

ELECTRICAL PLAN GENERAL NOTES

1. ELECTRICAL CONTRACTOR TO COORDINATE THE EXACT RECEPTACLE TYPE AND VOLTAGE FOR ALL EQUIPMENT WITH THE RESPECTIVE EQUIPMENT SUPPLIER PRIOR TO INSTALLATION.
2. STACK DEVICES, OUTLETS, AND SWITCHES WHENEVER POSSIBLE.
3. DEVICES, OUTLETS, AND SWITCHES SHALL BE CLEAR OF DOOR SWINGS.
4. REFER TO ARCHITECTURAL DRAWINGS FOR EXACT DEVICE LOCATIONS (RECEPTACLES, DETECTORS, DATA OUTLETS, AND TELEPHONE JACKS - TYPICAL) AND ADJUST ACCORDINGLY. THE ARCHITECT IS TO BE NOTIFIED OF ANY CONFLICTS WITH THE DEVICE LOCATIONS AND THE N.E.C. REQUIREMENTS. REFERENCE ARCHITECTURAL RCPs FOR SMOKE DETECTORS, CO DETECTORS, AND SWITCH PLATE SPECIFICATIONS.
5. ALL EXTERIOR LIGHTS TO BE 'SMART' SWITCHED IN ADDITION TO PHYSICAL.

GENERAL REFLECTED CEILING PLAN NOTES


1. ALL CEILING ARE GWB, UNLESS NOTED OTHERWISE.
2. ALL DIMENSION TO CENTERLINES OF LIGHTING FIXTURES & FINISH FACE OF WALL, U.N.O.
3. REVIEW LOCATIONS OF SMOKE DETECTORS WITH ARCHITECT PRIOR TO INSTALLING.
4. REVIEW LOCATIONS AND MOUNTING HEIGHTS FOR WALL HUNG LIGHTING FIXTURES WITH ARCHITECT PRIOR TO INSTALLING.
5. REF E-DWGS FOR SWITCHING INFORMATION.
6. ALL LIGHTS TO BE DIMMABLE.
7. BUSTER & PUNCH SWITCHES/DIMMERS IN KITCHEN, DINING, AND LIVING.
8. ALL OUTLETS IN WHITE GYPSUM WALLS TO BE LUTRON MAESTRO, SATIN WHITE.
9. ALL OUTLETS IN OTHER MATERIALS TO BE COORDINATED WITH OWNER AND ARCHITECT.
10. ALL OUTLETS IN WHITE GYPSUM WALLS TO BE LUTRON MAESTRO, SATIN WHITE.
11. FLOOR OUTLETS IN FRAMED FLOORS TO BE ARLINGTON FLBRS20, FINISH TO BE COORDINATED WITH OWNER/ARCHITECT.
12. FLOOR OUTLETS IN CONCRETE SLABS TO BE ARLINGTON FLBRS570, FINISH TO BE COORDINATED WITH OWNER/ARCHITECT.
13. RADIANT HEAT, FANS, AND CLOSET LIGHT SWITCHES AND CONTROLS SHALL BE CONCEALED IN CLOSETSMILLWORK WHERE POSSIBLE.

REFLECTED CEILING PLAN LEGEND

- GYPSUM CEILING BOARD
- WOOD CEILING
- CEILING HEIGHT

RCP DEVICE LEGEND

- COMBO SMOKE/CO DETECTOR, HARDWIRED WITH 10 YR BATTERY BACKUP (KIDDIE P4010ACSO-W OR APPROVED SIMILAR)
- SECURITY CAMERA
- MOTION SENSOR
- SPRINKLER HEAD

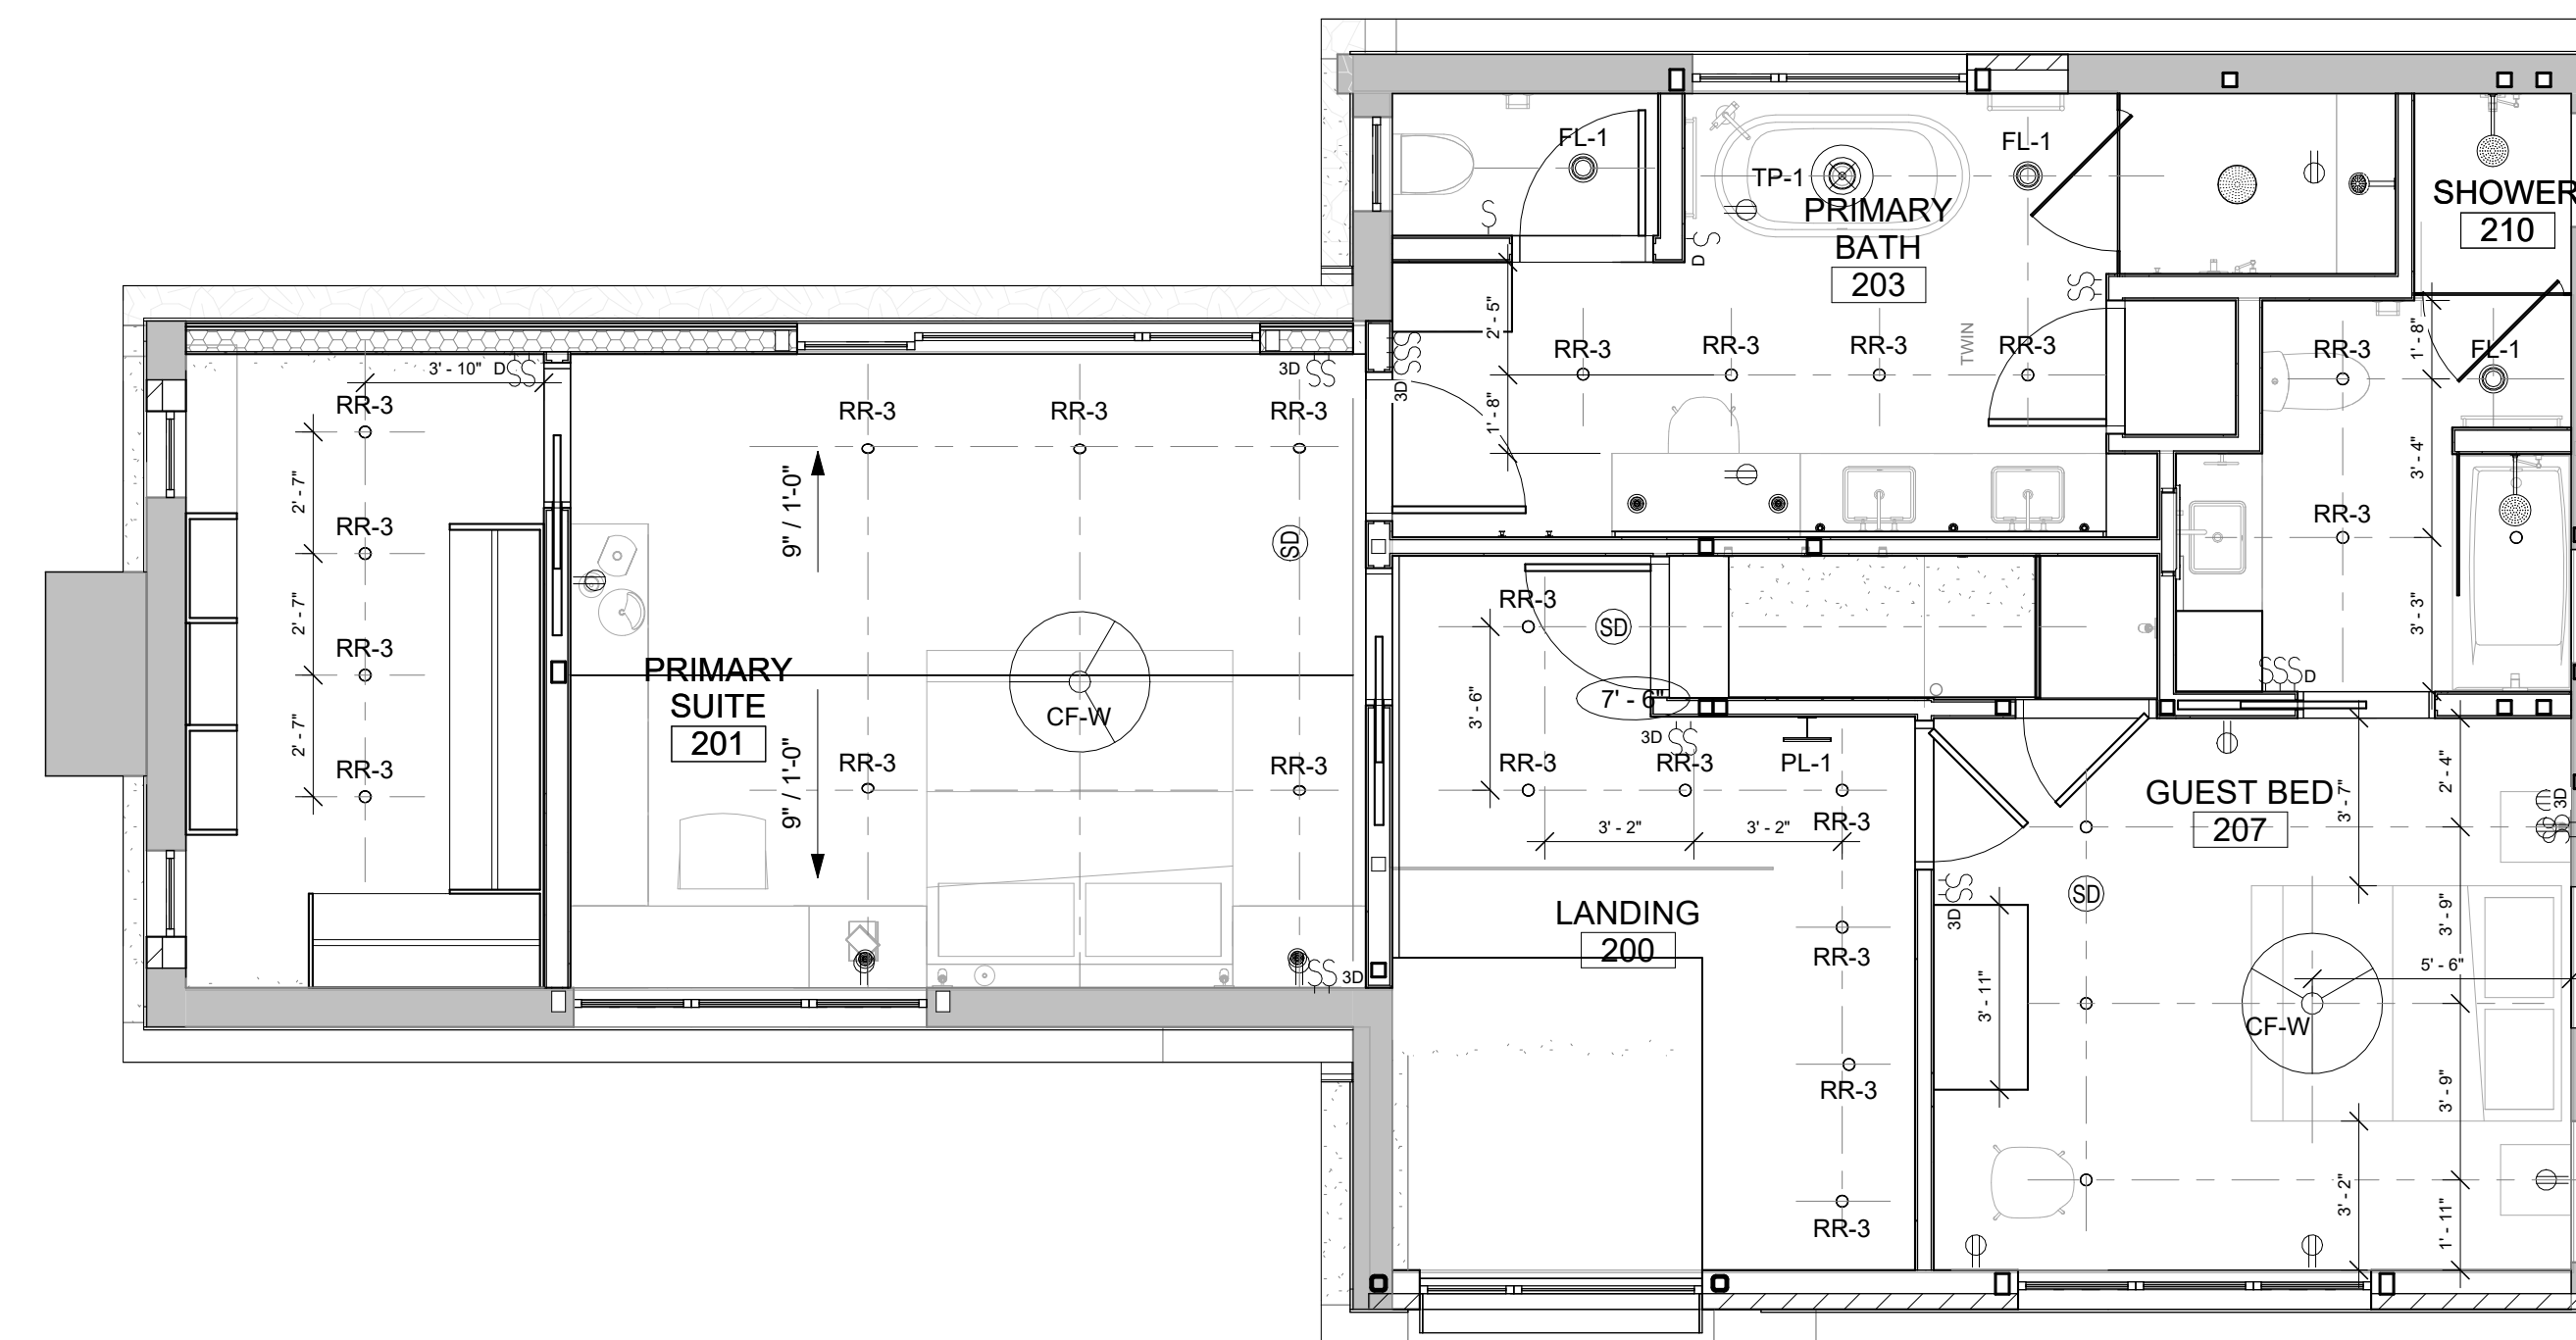

REVISION HISTORY		
NO.	DESCRIPTION	DATE



PERMIT REVISION

DATE:	AUG 18, 2023
SCALE:	As indicated
DRAWN BY:	CJ
CHECKED BY:	CR

SHEET TITLE	PROJECT #
	40035

SECOND FLOOR
REFLECTED CEILING
PLAN

A3.12

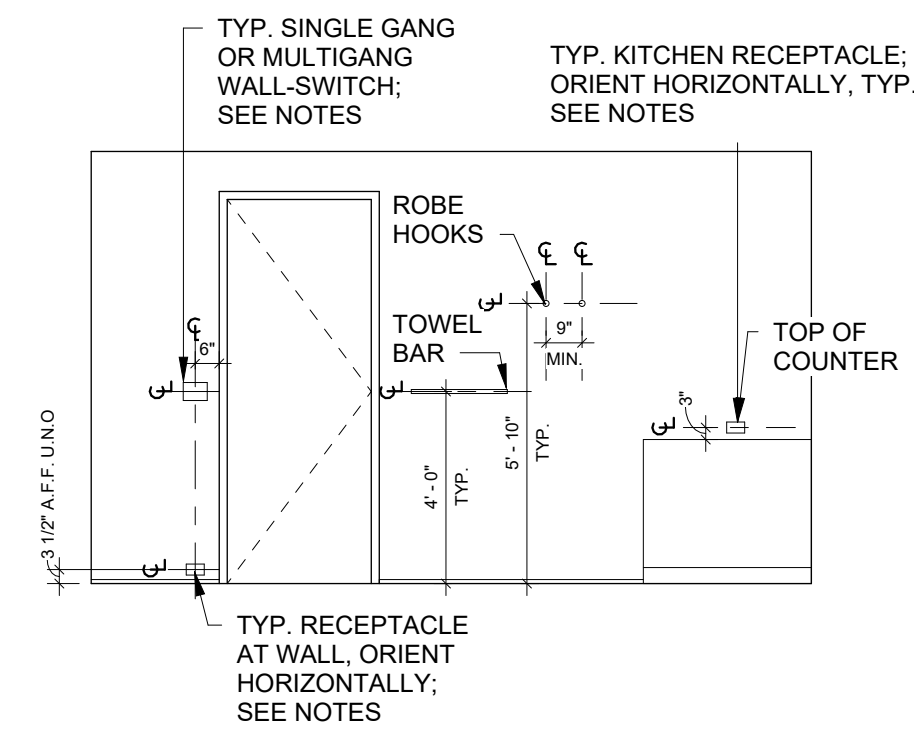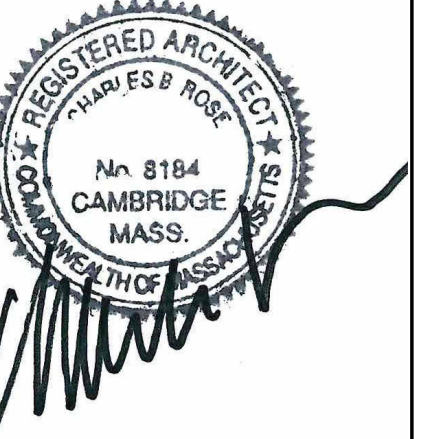

NOTE: COORDINATE ALL ROUGH-IN LOCATIONS WITH ARCHITECT & OWNER PRIOR TO DRYWALL INSTALLATION

CEILING PLAN KEY NOTES

1. MOTORIZED ROLL DOWN SHADE, RECESSED POCKET TYPE
2. RECESSED CURTAIN TRACK BY SILENT GLISS
3. MOTORIZED ROLL DOWN SHADE, RECESSED POCKET TYPE WITH RECESSED CURTAIN TRACK
4. 1" LINEAR SLOT DIFFUSER, FLOWBAR, GWB INSTALLATION FLANGE, MITER AT CORNERS, FL-10 TYPE 22
5. RETURN GRILLE

ELECTRICAL PLAN GENERAL NOTES

1. ELECTRICAL CONTRACTOR TO COORDINATE THE EXACT RECEPTACLE TYPE AND VOLTAGE FOR ALL EQUIPMENT WITH THE RESPECTIVE EQUIPMENT SUPPLIER PRIOR TO INSTALLATION.
2. STACK DEVICES, OUTLETS, AND SWITCHES WHENEVER POSSIBLE.
3. DEVICES, OUTLETS, AND SWITCHES SHALL BE CLEAR OF DOOR SWINGS.
4. REFER TO ARCHITECTURAL DRAWINGS FOR EXACT DEVICE LOCATIONS (RECEPTACLES, DETECTORS, DATA OUTLETS, AND TELEPHONE JACKS - TYPICAL) AND ADJUST ACCORDINGLY. THE ARCHITECT IS TO BE NOTIFIED OF ANY CONFLICTS WITH THE DEVICE LOCATIONS AND THE N.E.C. REQUIREMENTS.
5. REFERENCE ARCHITECTURAL ROPS FOR SMOKE DETECTORS, CO DETECTORS, AND SWITCH PLATE SPECIFICATIONS.
6. ALL EXTERIOR LIGHTS TO BE 'SMART' SWITCHED IN ADDITION TO PHYSICAL.

GENERAL REFLECTED CEILING PLAN NOTES


1. ALL CEILINGS ARE GWB, UNLESS NOTED OTHERWISE.
2. ALL DIMENSION TO CENTERLINES OF LIGHTING FIXTURES & FINISH FACE OF WALL, U.N.O.
3. REVIEW LOCATIONS OF SMOKE DETECTORS WITH ARCHITECT PRIOR TO INSTALLING.
4. REVIEW LOCATIONS AND MOUNTING HEIGHTS FOR WALL HUNG LIGHTING FIXTURES WITH ARCHITECT PRIOR TO INSTALLING.
5. REF E-DWGS FOR SWITCHING INFORMATION.
6. ALL LIGHTS TO BE DIMMABLE.
7. BUSTER & PUNCH SWITCHES/DIMMERS IN KITCHEN, DINING, AND LIVING.
8. ALL OUTLETS IN WHITE GYPSUM WALLS TO BE LUTRON MAESTRO, SATIN WHITE.
9. ALL OUTLETS IN OTHER MATERIALS TO BE COORDINATED WITH OWNER AND ARCHITECT.
10. ALL OUTLETS IN WHITE GYPSUM WALLS TO BE LUTRON MAESTRO, SATIN WHITE.
11. ALL OUTLETS IN FRAMED FLOORS TO BE ARLINGTON FLBRS20, FINISH TO BE COORDINATED WITH OWNER/ARCHITECT.
12. FLOOR OUTLETS IN CONCRETE SLABS TO BE ARLINGTON FLBRS570, FINISH TO BE COORDINATED WITH OWNER/ARCHITECT.
13. RADIANT HEAT, FANS, AND CLOSET LIGHT SWITCHES AND CONTROLS SHALL BE CONCEALED IN CLOSETSMILLWORK WHERE POSSIBLE.

REFLECTED CEILING PLAN LEGEND

- GYPSUM CEILING BOARD
- WOOD CEILING
- CEILING HEIGHT

RCP DEVICE LEGEND

- COMBO SMOKE/CO DETECTOR, HARDWIRED WITH 10 YR BATTERY BACKUP (KIDDIE P4010ACSO-W OR APPROVED SIMILAR)
- SECURITY CAMERA
- MOTION SENSOR
- SPRINKLER HEAD

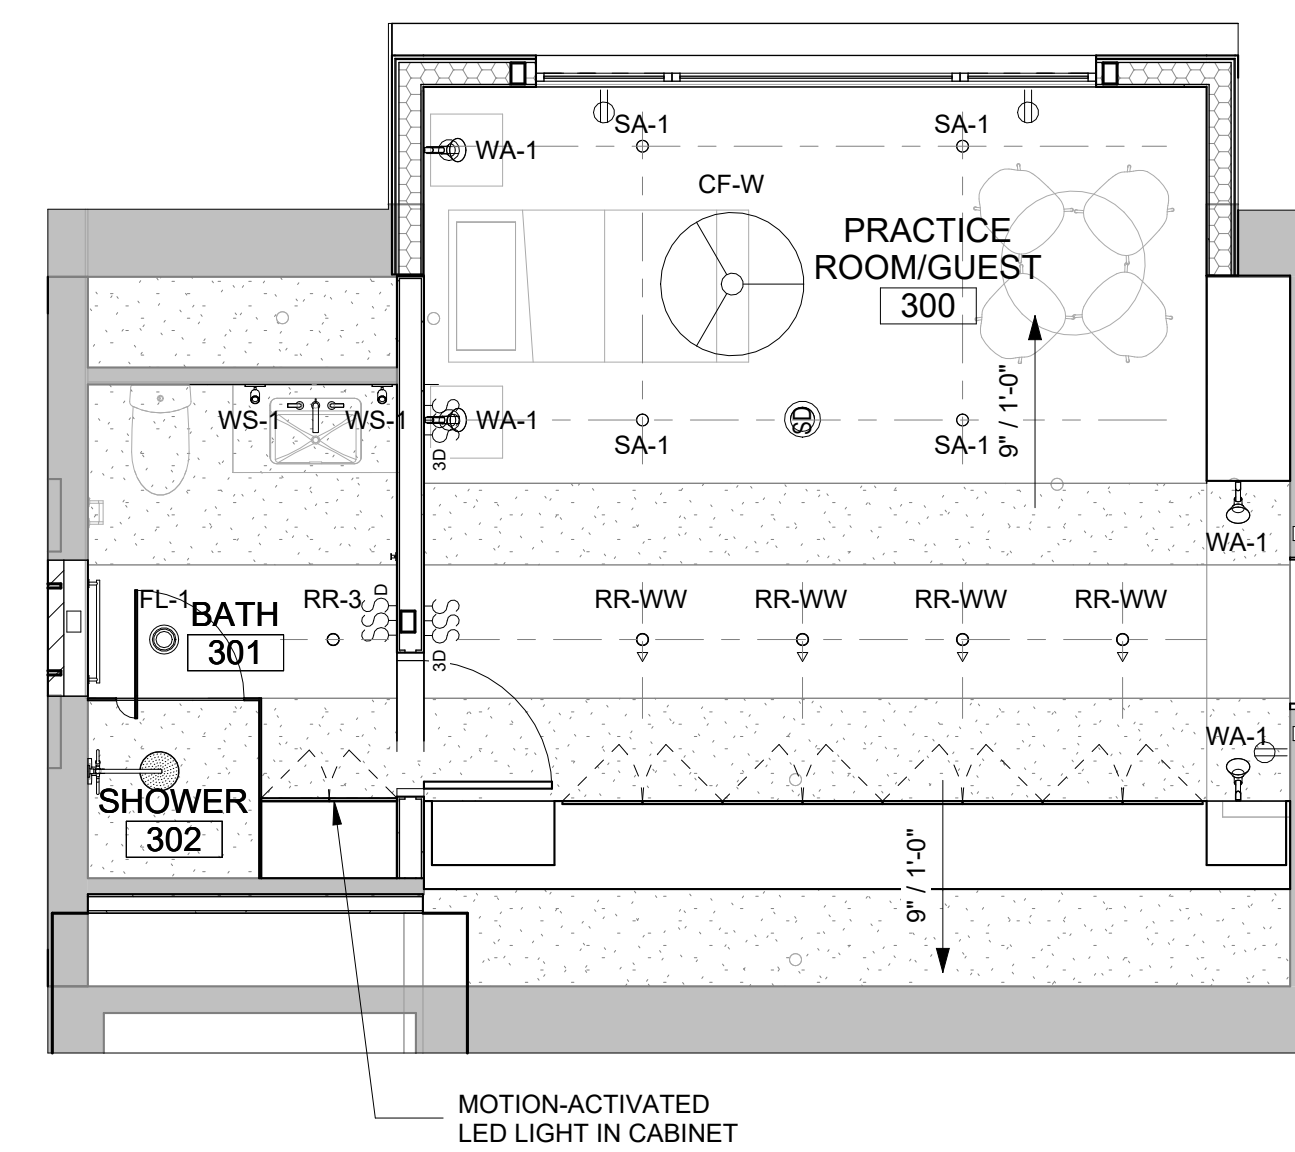


NO.	DESCRIPTION	DATE

PERMIT REVISION

DATE:	AUG 18, 2023
SCALE:	As indicated
DRAWN BY:	CJ
CHECKED BY:	CR

SHEET TITLE	PROJECT #
-------------	-----------

THIRD FLOOR REFLECTED CEILING PLAN

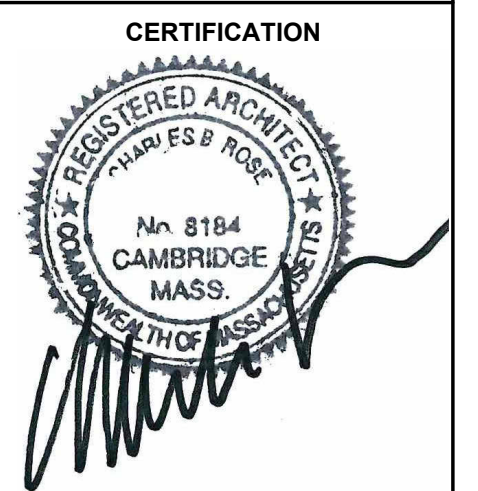

GENERAL SITE LIGHTING PLAN NOTES


- EXISTING 1' CONTOURS
- EXISTING 10' CONTOURS
- - - DRIVEWAY AND HARDSCAPE BOUNDARIES

GENERAL NOTES

1. DRIVEWAY LAYOUT AND TREE REMOVAL TO ISSUED AFTER SURVEY RETURNED. TO BE VERIFIED IN FIELD WITH ARCHITECT AND OWNER.
2. EXISTING MAJOR UTILITIES TO BE LOCATED AFTER SURVEY RETURNED.
3. PROPOSED GRADING TO BE ISSUED WITH CONSTRUCTION DOCUMENT SET.

GENERAL ELECTRICAL NOTES

1. ELECTRICAL CONTRACTOR TO COORDINATE THE EXACT RECEPTACLE TYPE AND VOLTAGE FOR ALL EQUIPMENT WITH THE RESPECTIVE EQUIPMENT SUPPLIER PRIOR TO INSTALLATION.
2. STACK DEVICES, OUTLETS, AND SWITCHES WHENEVER POSSIBLE.
3. DEVICES, OUTLETS, AND SWITCHES SHALL BE CLEAR OF DOOR SWINGS.
4. REFER TO ARCHITECTURAL DRAWINGS FOR EXACT DEVICE LOCATIONS (RECEPTACLES, DETECTORS, DATA OUTLETS, AND TELEPHONE JACKS - TYPICAL) AND ADJUST ACCORDINGLY. THE ARCHITECT IS TO BE NOTIFIED OF ANY CONFLICTS WITH THE DEVICE LOCATIONS AND THE N.E.C. REQUIREMENTS.
5. REFERENCE ARCHITECTURAL RCPS FOR SMOKE DETECTORS, CO DETECTORS, AND SWITCH PLATE SPECIFICATIONS.
6. ALL DIMENSION TO CENTERLINES OF LIGHTING FIXTURES & FINISH FACE OF WALL, U.N.O.
7. REVIEW LOCATIONS AND MOUNTING HEIGHTS FOR WALL HUNG LIGHTING FIXTURES WITH ARCHITECT PRIOR TO INSTALLING.
8. REF AS EX DRAWINGS FOR SWITCHING INFORMATION.
9. ALL LIGHTS TO BE DIMMABLE.
10. ALL EXTERIOR LIGHTS TO BE 'SMART' SWITCHED IN ADDITION TO PHYSICAL.
11. ALL OUTLETS IN WHITE GYPSUM WALLS TO BE LUTRON MAESTRO, SATIN WHITE.
12. ALL OUTLETS IN OTHER MATERIALS TO BE COORDINATED WITH OWNER AND ARCHITECT.

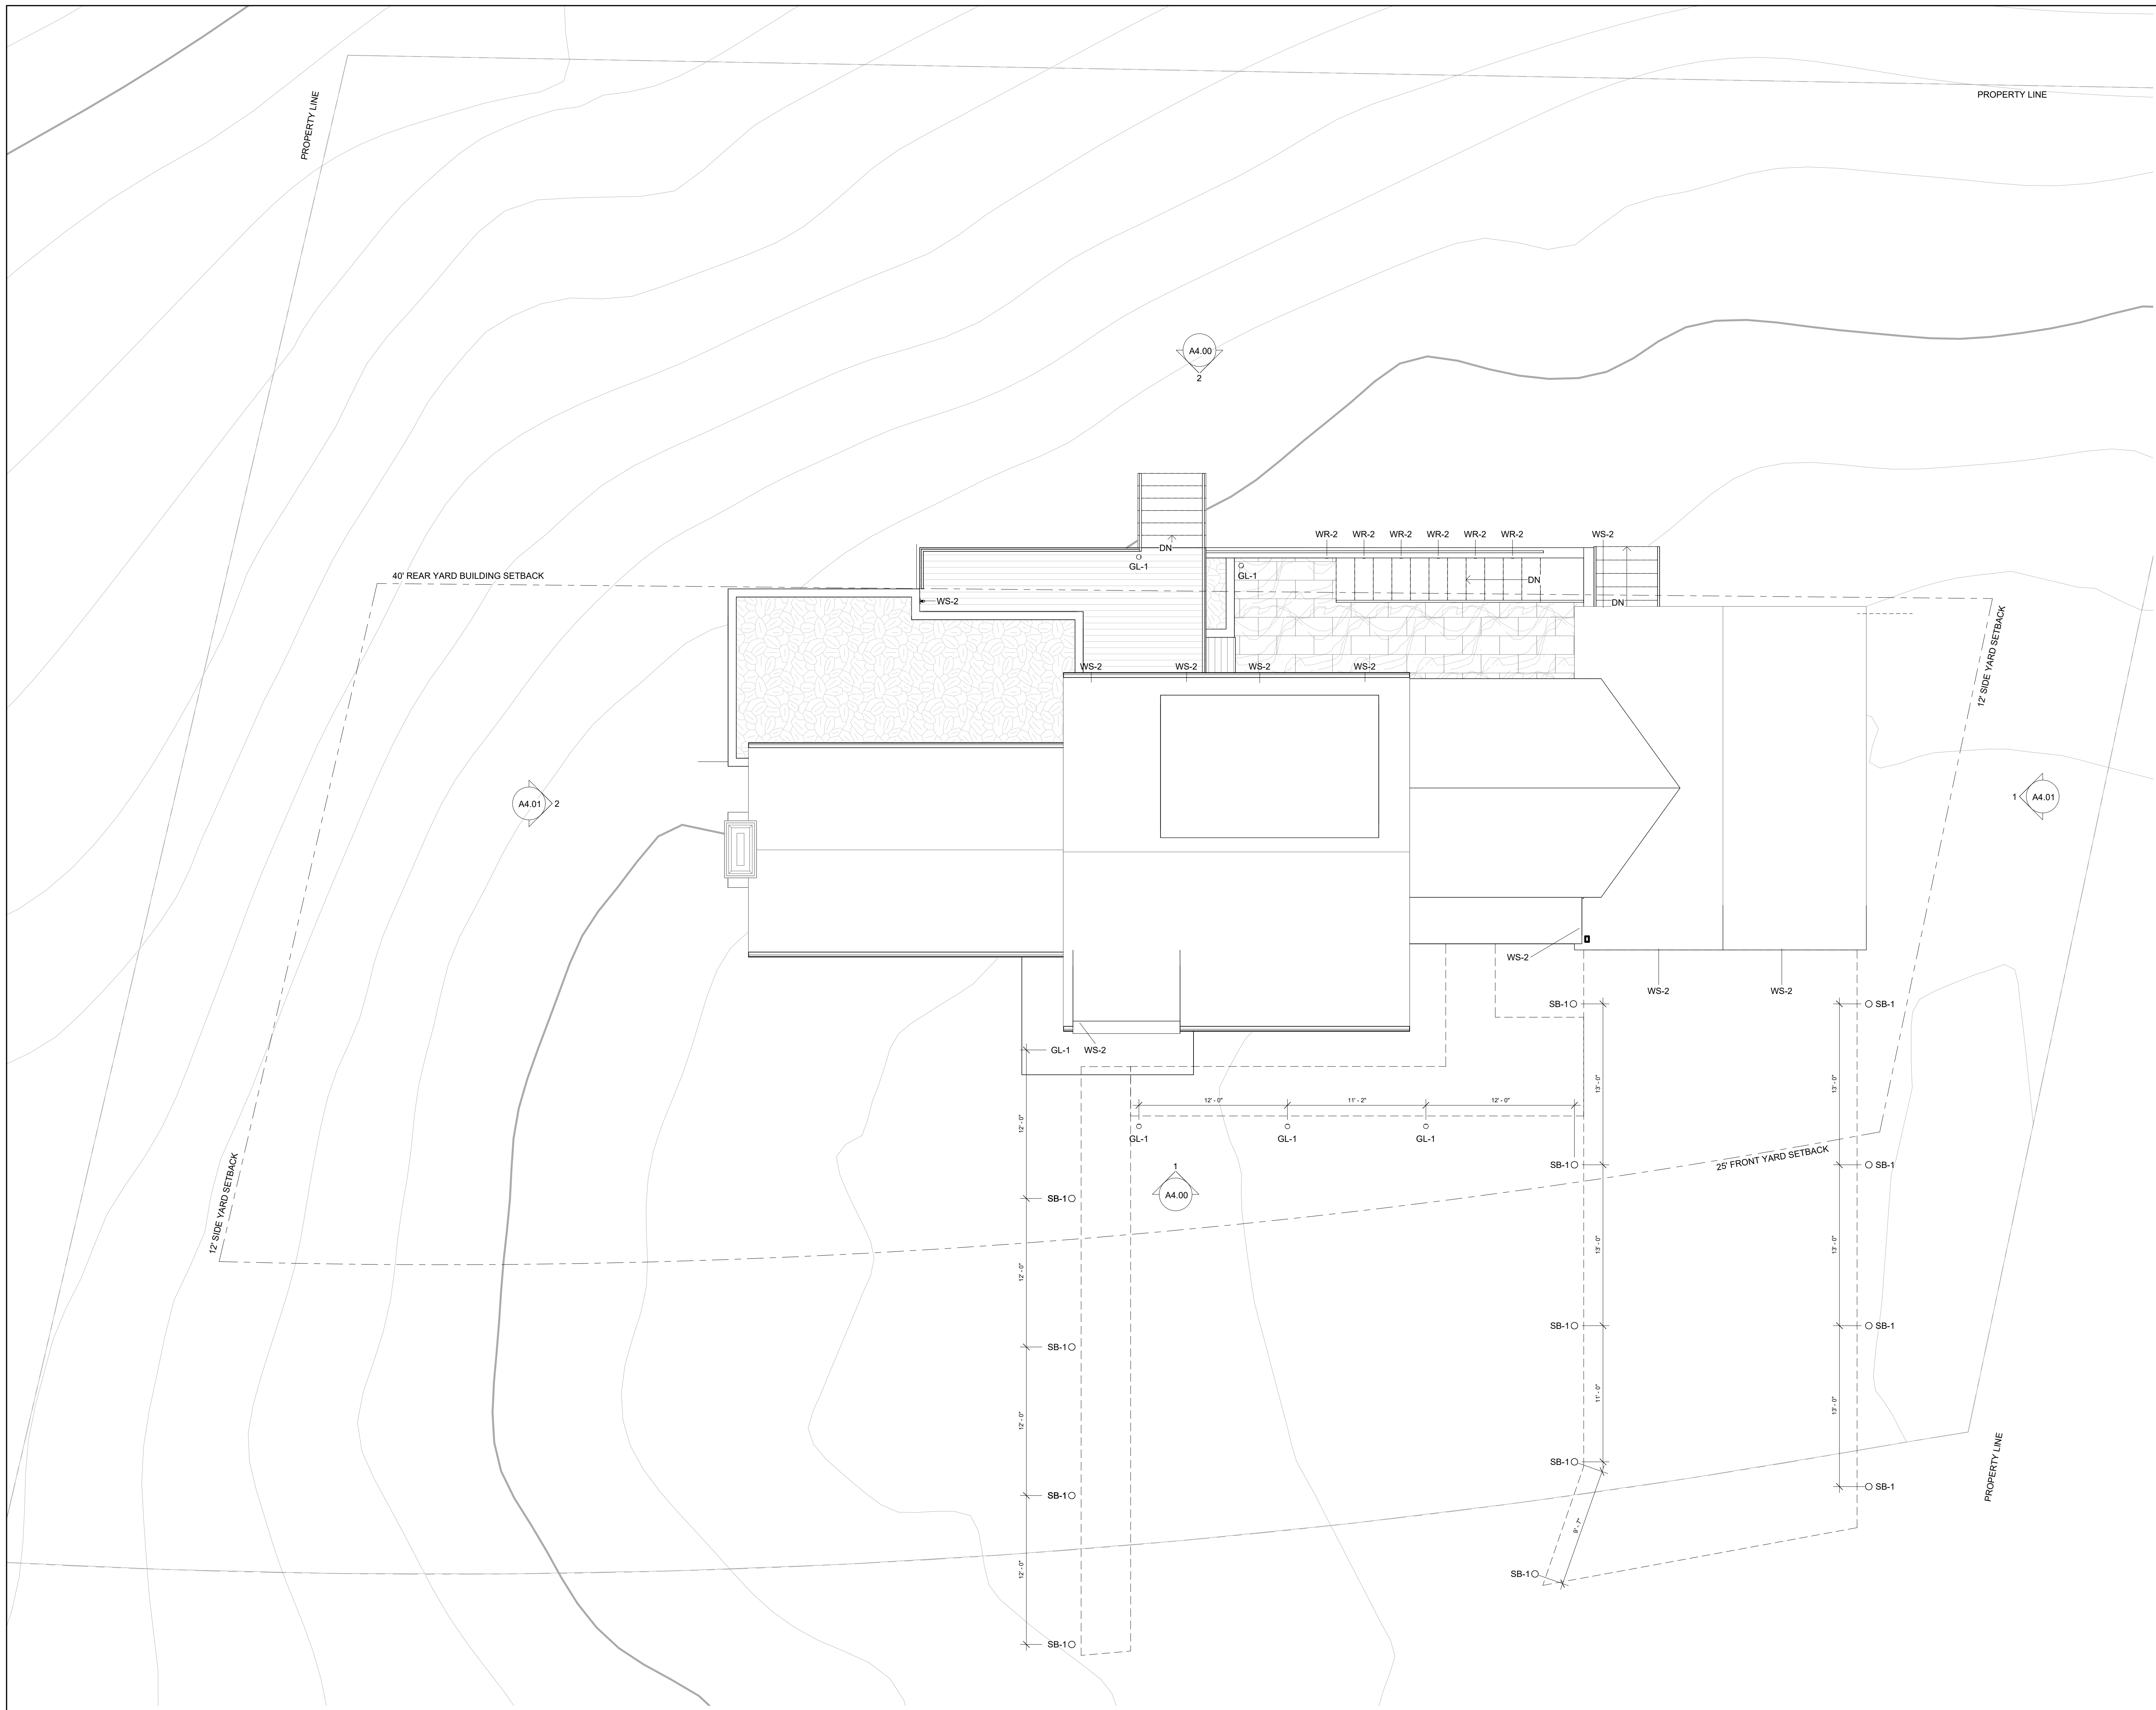



LIGHTING SCHEDULE - OUTDOOR											
TYPE MARK	DESCRIPTION	MANUFACTURER	PRODUCT NAME	MODEL	FINISH	COUNT	ALLOWANCE	LAMP	COLOR TEMPERATURE	MOUNTING LOCATION	NOTES
GL-1	OUTDOOR GROUND LIGHT	BEGA	IN GROUND LUMINAIRE	88 671	BLK	4		LED	3000 K	IN GROUND	WET LOCATION RATED
SB-1	OUTDOOR SHIELDED BOLLARD	BEGA	BOLLARD	99 577	BLK	13		LED	3000 K	AT GRADE	WET LOCATION RATED
WR-2	OUTDOOR WALL RECESSED LIGHT	BEGA	RECESSED WALL LUMINAIRE	22 230	BLK	6		LED	3000 K	WALL RECESSED, STEP LIGHTS	WET LOCATION RATED
WS-2	OUTDOOR WALL SCONCE	BEGA	WALL LUMINAIRE	66 655	BLK	6		LED	3000 K	WALL SCONCE	WET LOCATION RATED

1 SITE LIGHTING PLAN
 3/16" = 1'-0"

REVISION HISTORY		
NO.	DESCRIPTION	DATE

PERMIT REVISION	
DATE	DESCRIPTION
AUG 18, 2023	As indicated
CJ	DRAWN BY
CR	CHECKED BY

SHEET TITLE: **SITE LIGHTING PLAN**
 PROJECT #: 40035

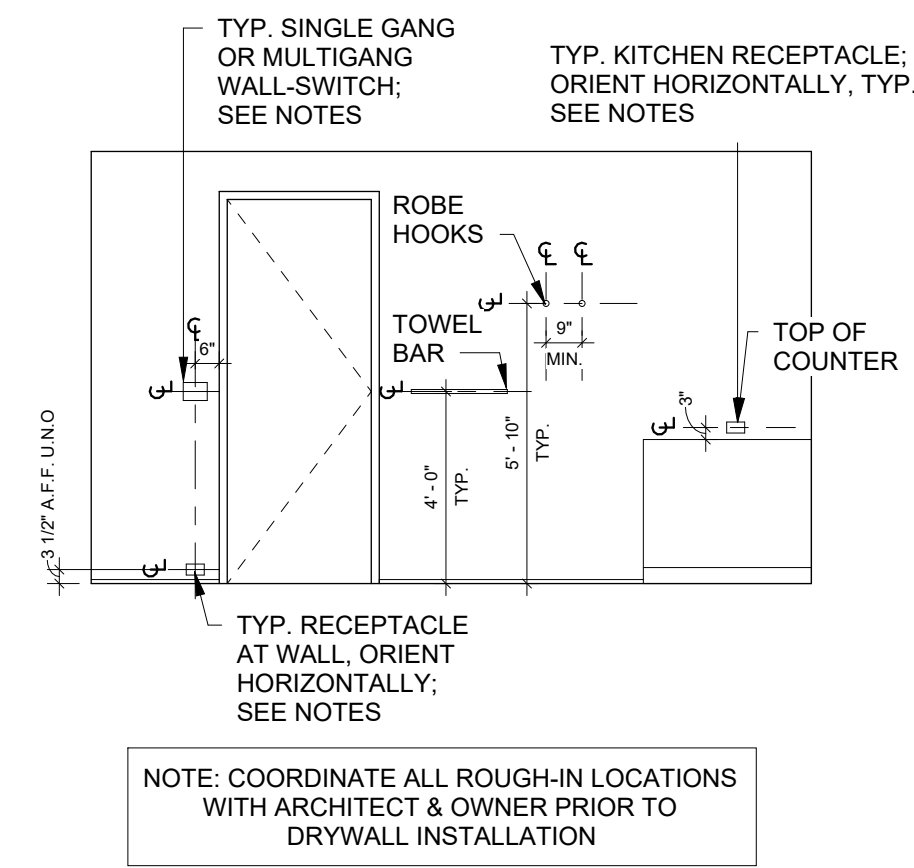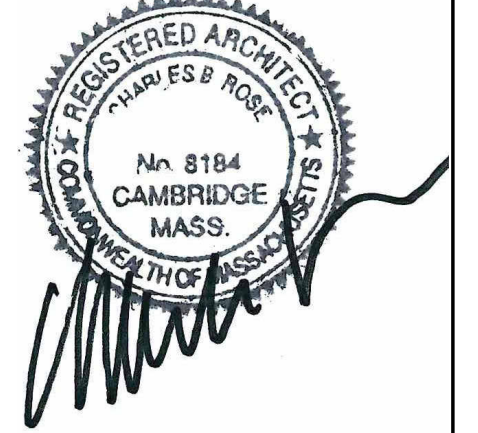

CEILING PLAN KEY NOTES

1. MOTORIZED ROLL DOWN SHADE, RECESSED POCKET TYPE
2. RECESSED CURTAIN TRACK BY SILENT GLISS
3. MOTORIZED ROLL DOWN SHADE, RECESSED POCKET TYPE WITH RECESSED CURTAIN TRACK
4. 1" LINEAR SLOT DIFFUSER, FLOWBAR, GWB INSTALLATION FLANGE, MITER AT CORNERS, FL-10 TYPE 22
5. RETURN GRILLE

ELECTRICAL PLAN GENERAL NOTES

1. ELECTRICAL CONTRACTOR TO COORDINATE THE EXACT RECEPTACLE TYPE AND VOLTAGE FOR ALL EQUIPMENT WITH THE RESPECTIVE EQUIPMENT SUPPLIER PRIOR TO INSTALLATION.
2. STACK DEVICES, OUTLETS, AND SWITCHES WHENEVER POSSIBLE.
3. DEVICES, OUTLETS, AND SWITCHES SHALL BE CLEAR OF DOOR SWINGS.
4. REFER TO ARCHITECTURAL DRAWINGS FOR EXACT DEVICE LOCATIONS (RECEPTACLES, DETECTORS, DATA OUTLETS, AND TELEPHONE JACKS - TYPICAL) AND ADJUST ACCORDINGLY. THE ARCHITECT IS TO BE NOTIFIED OF ANY CONFLICTS WITH THE DEVICE LOCATIONS AND THE N.E.C. REQUIREMENTS. REFERENCE ARCHITECTURAL RCPs FOR SMOKE DETECTORS, CO DETECTORS, AND SWITCH PLATE SPECIFICATIONS.
5. ALL EXTERIOR LIGHTS TO BE "SMART" SWITCHED IN ADDITION TO PHYSICAL.

GENERAL REFLECTED CEILING PLAN NOTES


1. ALL CEILING ARE GWB, UNLESS NOTED OTHERWISE.
2. ALL DIMENSION TO CENTERLINES OF LIGHTING FIXTURES & FINISH FACE OF WALL, U.N.O.
3. REVIEW LOCATIONS OF SMOKE DETECTORS WITH ARCHITECT PRIOR TO INSTALLING.
4. REVIEW LOCATIONS AND MOUNTING HEIGHTS FOR WALL HUNG LIGHTING FIXTURES WITH ARCHITECT PRIOR TO INSTALLING.
5. REF E-DWGS FOR SWITCHING INFORMATION.
6. ALL LIGHTS TO BE DIMMABLE.
7. BUSTER & PUNCH SWITCHES/DIMMERS IN KITCHEN, DINING, AND LIVING.
8. ALL OUTLETS IN WHITE GYPSUM WALLS TO BE LUTRON MAESTRO, SATIN WHITE.
9. ALL OUTLETS IN OTHER MATERIALS TO BE COORDINATED WITH OWNER AND ARCHITECT.
10. ALL OUTLETS IN WHITE GYPSUM WALLS TO BE LUTRON MAESTRO, SATIN WHITE.
11. FLOOR OUTLETS IN FRAMED FLOORS TO BE ARLINGTON FLBRS20, FINISH TO BE COORDINATED WITH OWNER/ARCHITECT.
12. FLOOR OUTLETS IN CONCRETE SLABS TO BE ARLINGTON FLBRS570, FINISH TO BE COORDINATED WITH OWNER/ARCHITECT.
13. RADIANT HEAT, FANS, AND CLOSET LIGHT SWITCHES AND CONTROLS SHALL BE CONCEALED IN CLOSET/MILLWORK WHERE POSSIBLE.

REFLECTED CEILING PLAN LEGEND

- GYPSUM CEILING BOARD
- WOOD CEILING
- CEILING HEIGHT



RCP DEVICE LEGEND

- COMBO SMOKE/CO DETECTOR, HARDWIRED WITH 10 YR BATTERY BACKUP (KIDDIE P4010ACSO-W OR APPROVED SIMILAR)
- SECURITY CAMERA
- MOTION SENSOR
- SPRINKLER HEAD

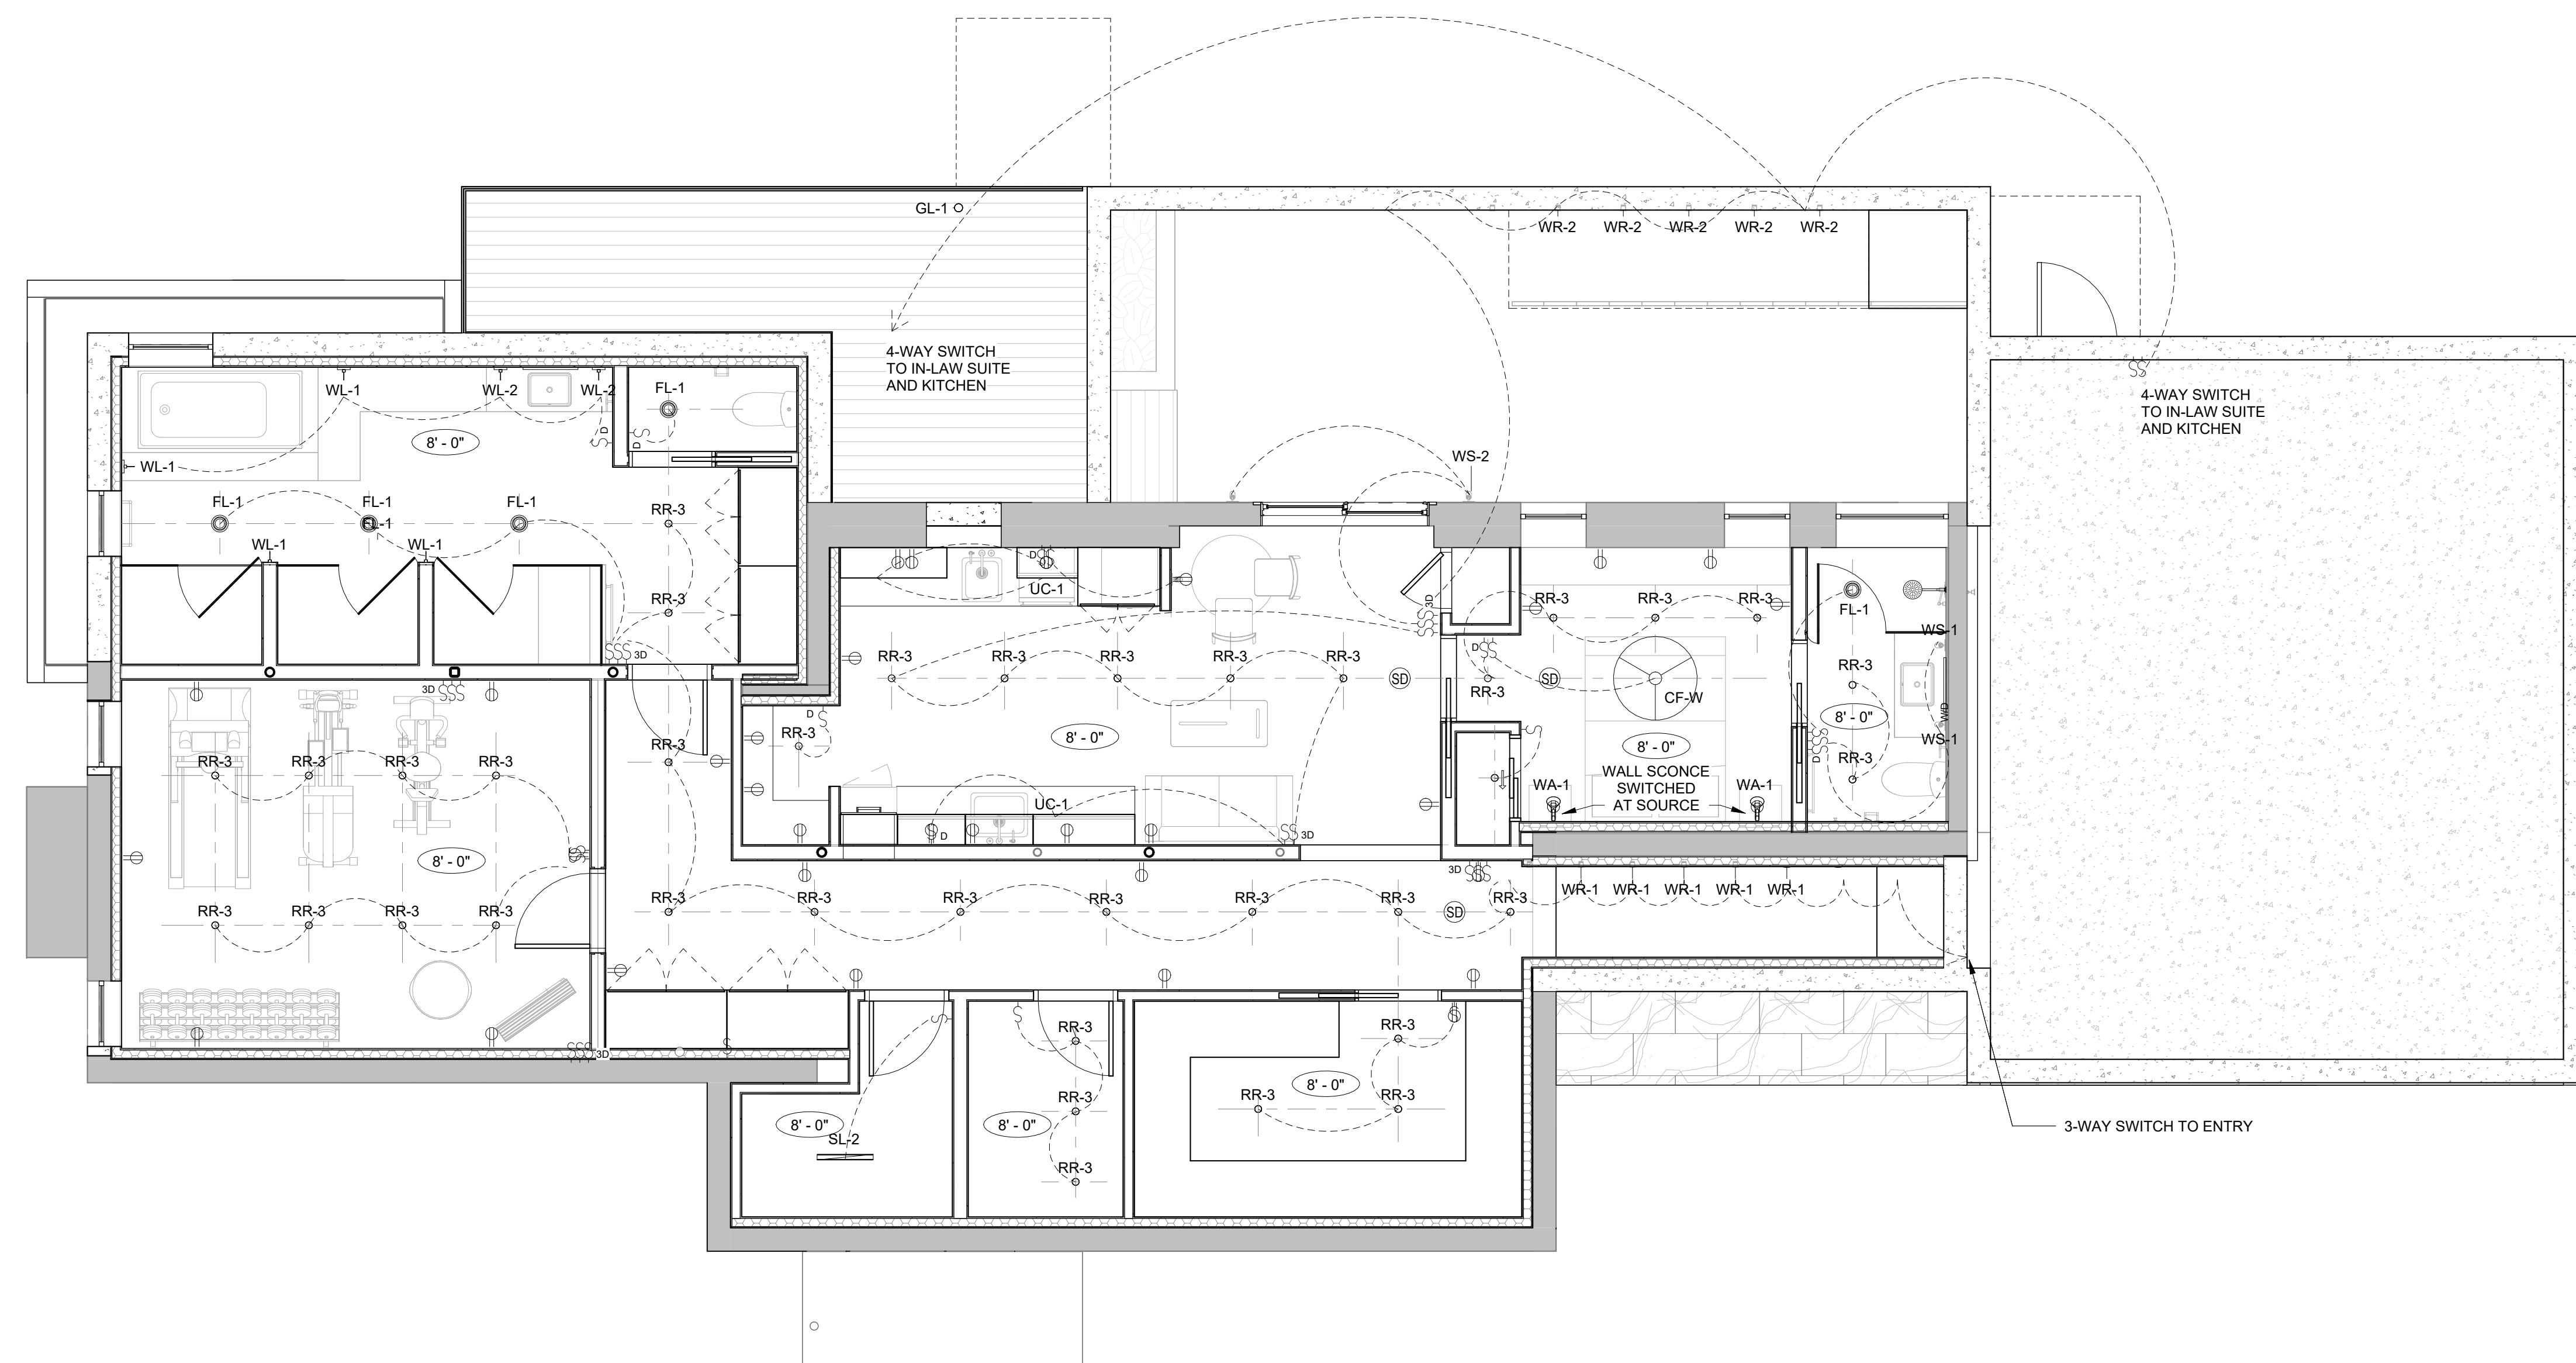

REVISION HISTORY		
NO.	DESCRIPTION	DATE

PERMIT REVISION	
DATE	DESCRIPTION
SEPT 6, 2023	As indicated

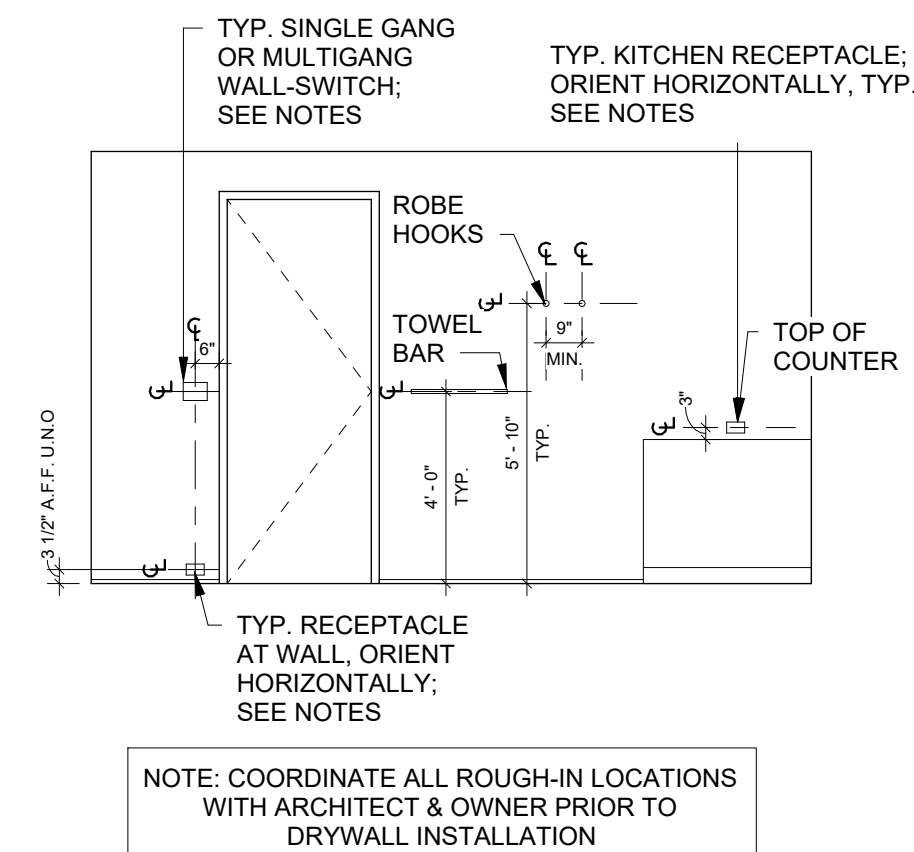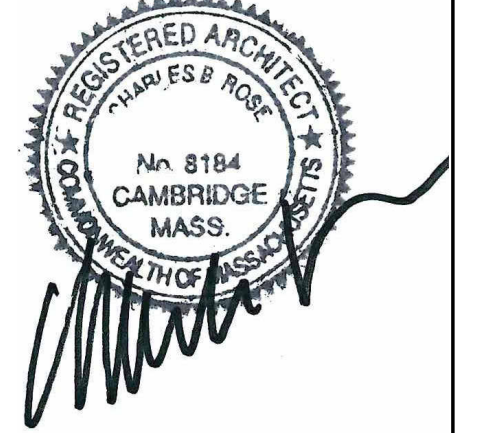

CEILING PLAN KEY NOTES

1. MOTORIZED ROLL DOWN SHADE, RECESSED POCKET TYPE
2. RECESSED CURTAIN TRACK BY SILENT GLISS
3. MOTORIZED ROLL DOWN SHADE, RECESSED POCKET TYPE WITH RECESSED CURTAIN TRACK
4. 1" LINEAR SLOT DIFFUSER, FLOWBAR, GWB INSTALLATION FLANGE, MITER AT CORNERS, FL-10 TYPE 22
5. RETURN GRILLE

ELECTRICAL PLAN GENERAL NOTES

1. ELECTRICAL CONTRACTOR TO COORDINATE THE EXACT RECEPTACLE TYPE AND VOLTAGE FOR ALL EQUIPMENT WITH THE RESPECTIVE EQUIPMENT SUPPLIER PRIOR TO INSTALLATION.
2. STACK DEVICES, OUTLETS, AND SWITCHES WHENEVER POSSIBLE.
3. DEVICES, OUTLETS, AND SWITCHES SHALL BE CLEAR OF DOOR SWINGS.
4. REFER TO ARCHITECTURAL DRAWINGS FOR EXACT DEVICE LOCATIONS (RECEPTACLES, DETECTORS, DATA OUTLETS, AND TELEPHONE JACKS - TYPICAL) AND ADJUST ACCORDINGLY. THE ARCHITECT IS TO BE NOTIFIED OF ANY CONFLICTS WITH THE DEVICE LOCATIONS AND THE N.E.C. REQUIREMENTS. REFERENCE ARCHITECTURAL RCPs FOR SMOKE DETECTORS, CO DETECTORS, AND SWITCH PLATE SPECIFICATIONS.
5. ALL EXTERIOR LIGHTS TO BE "SMART" SWITCHED IN ADDITION TO PHYSICAL.

GENERAL REFLECTED CEILING PLAN NOTES


1. ALL CEILINGS ARE GWB, UNLESS NOTED OTHERWISE.
2. ALL DIMENSION TO CENTERLINES OF LIGHTING FIXTURES & FINISH FACE OF WALL, U.N.O.
3. REVIEW LOCATIONS OF SMOKE DETECTORS WITH ARCHITECT PRIOR TO INSTALLING.
4. REVIEW LOCATIONS AND MOUNTING HEIGHTS FOR WALL HUNG LIGHTING FIXTURES WITH ARCHITECT PRIOR TO INSTALLING.
5. REF E-DWGS FOR SWITCHING INFORMATION.
6. ALL LIGHTS TO BE DIMMABLE.
7. BUSTER & PUNCH SWITCHES/DIMMERS IN KITCHEN, DINING, AND LIVING.
8. ALL OUTLETS IN WHITE GYPSUM WALLS TO BE LUTRON MAESTRO, SATIN WHITE.
9. ALL OUTLETS IN OTHER MATERIALS TO BE COORDINATED WITH OWNER AND ARCHITECT.
10. ALL OUTLETS IN WHITE GYPSUM WALLS TO BE LUTRON MAESTRO, SATIN WHITE.
11. ALL OUTLETS IN OTHER MATERIALS TO BE COORDINATED WITH OWNER AND ARCHITECT.
12. FLOOR OUTLETS IN CONCRETE SLABS TO BE ARLINGTON FLBRS20. FINISH TO BE COORDINATED WITH OWNER/ARCHITECT.
13. RADIANT HEAT, FANS, AND CLOSET LIGHT SWITCHES AND CONTROLS SHALL BE CONCEALED IN CLOSET/MILLWORK WHERE POSSIBLE.



REFLECTED CEILING PLAN LEGEND

- GYPSUM CEILING BOARD
- WOOD CEILING
- CEILING HEIGHT

RCP DEVICE LEGEND

- COMBO SMOKE/CO DETECTOR, HARDWIRED WITH 10 YR BATTERY BACKUP (KIDDIE P4010ACSO-W OR APPROVED SIMILAR)
- SECURITY CAMERA
- MOTION SENSOR
- SPRINKLER HEAD

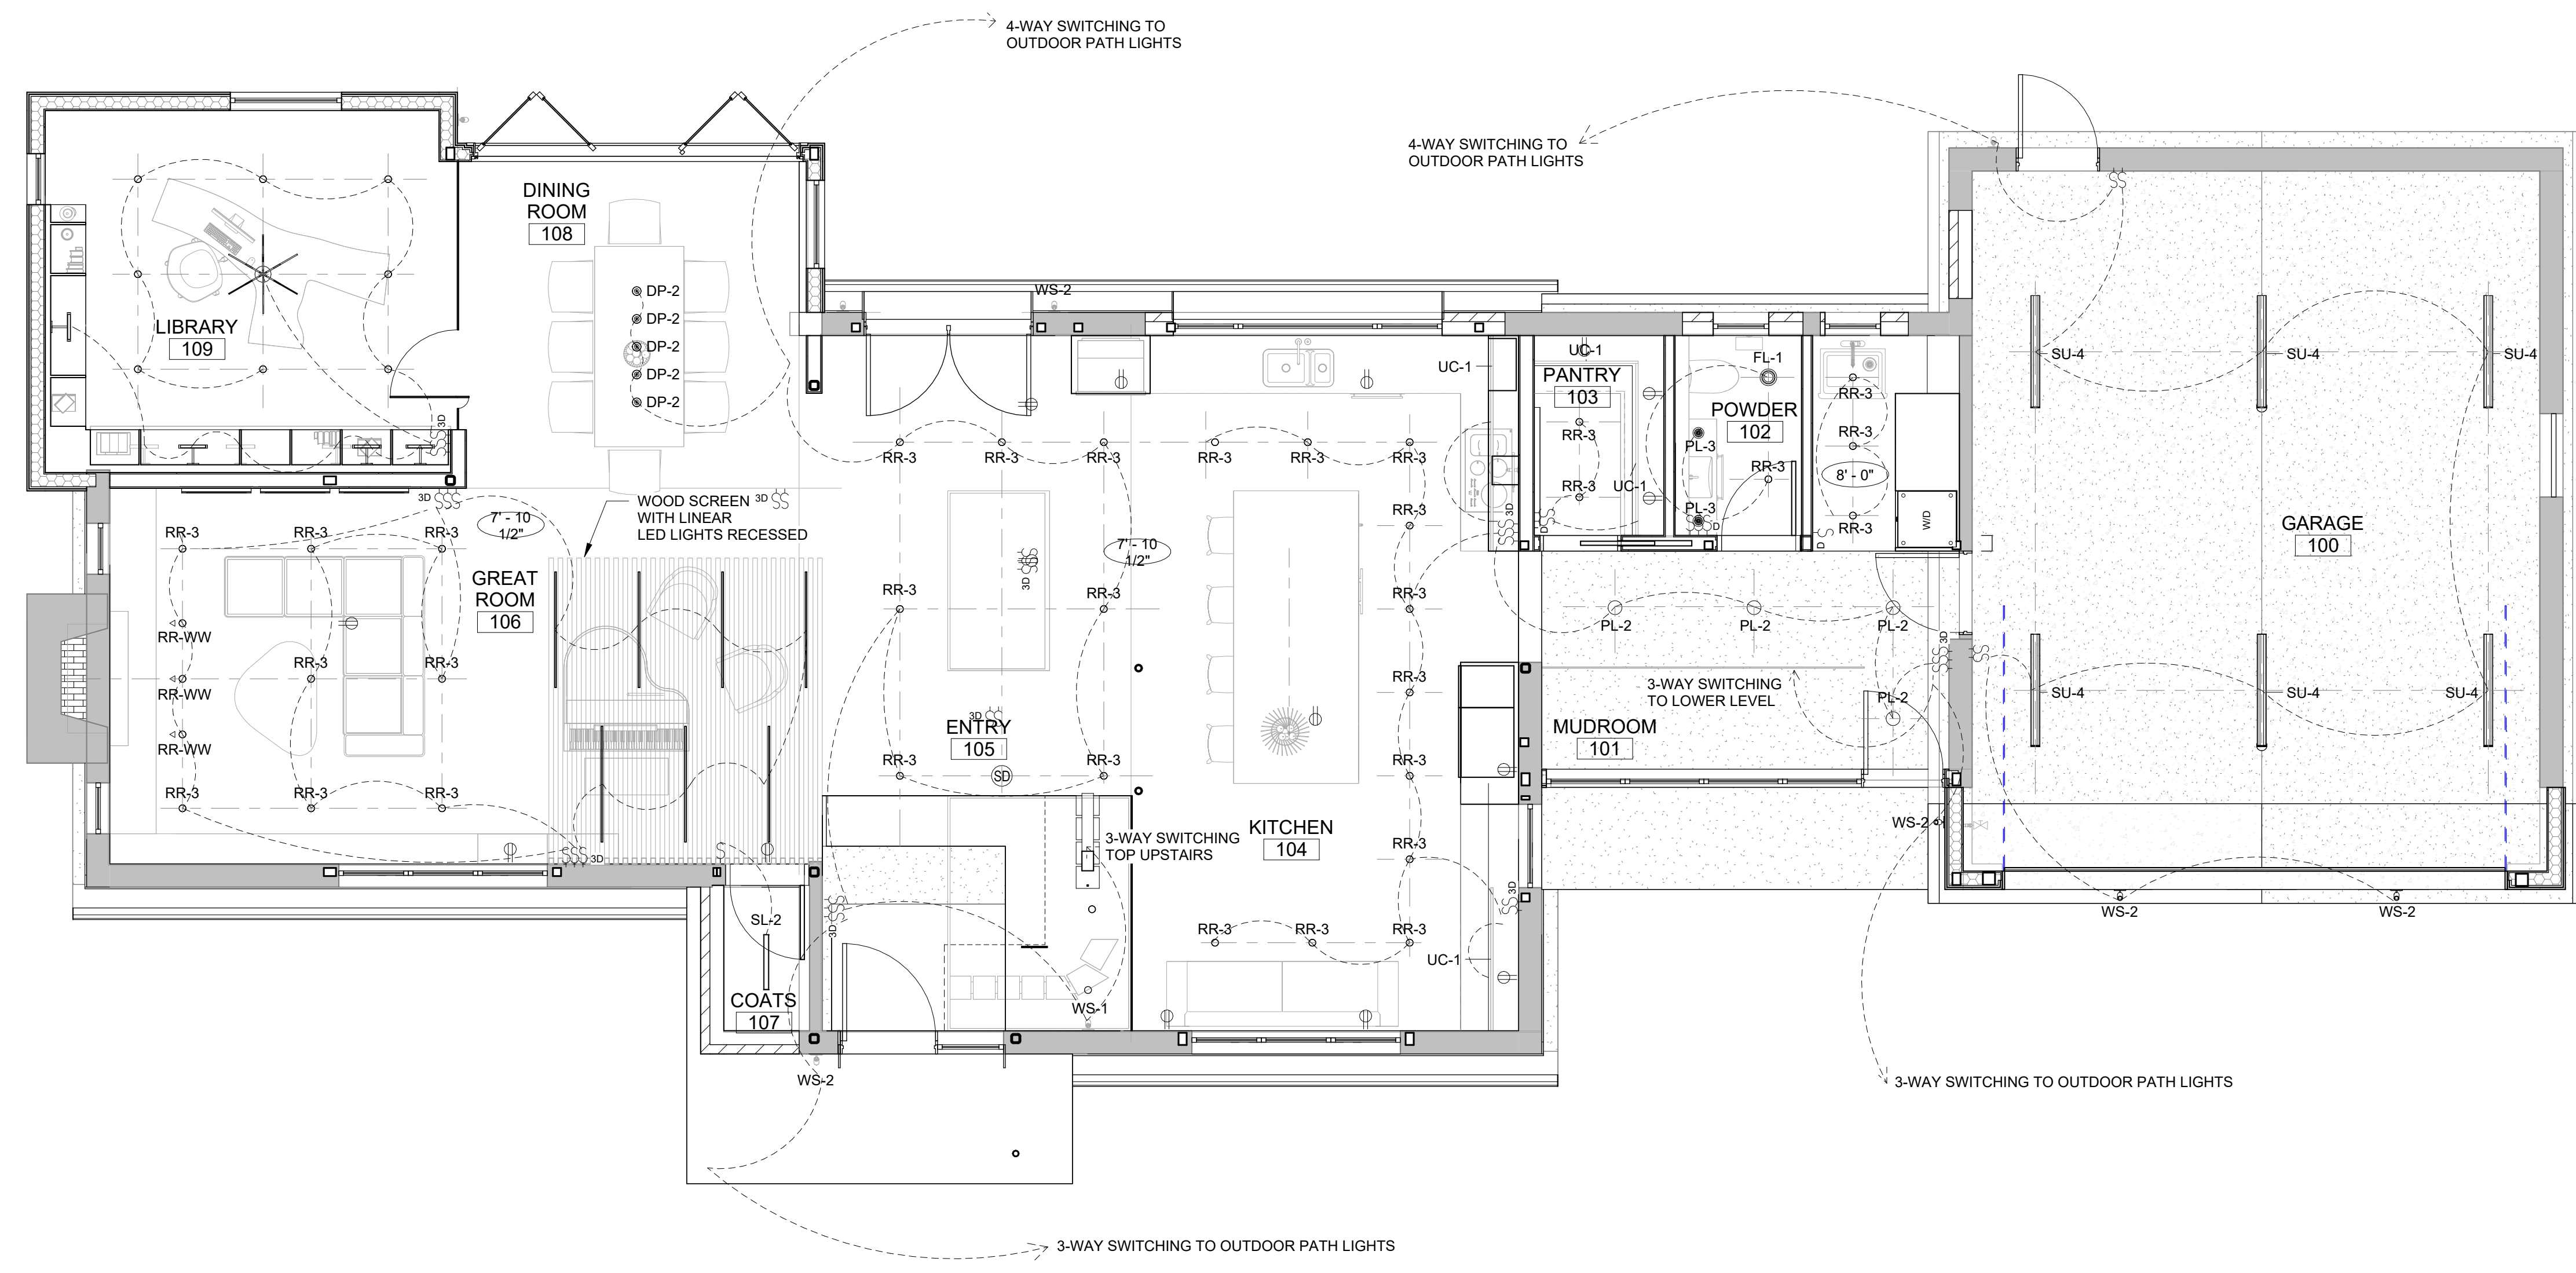

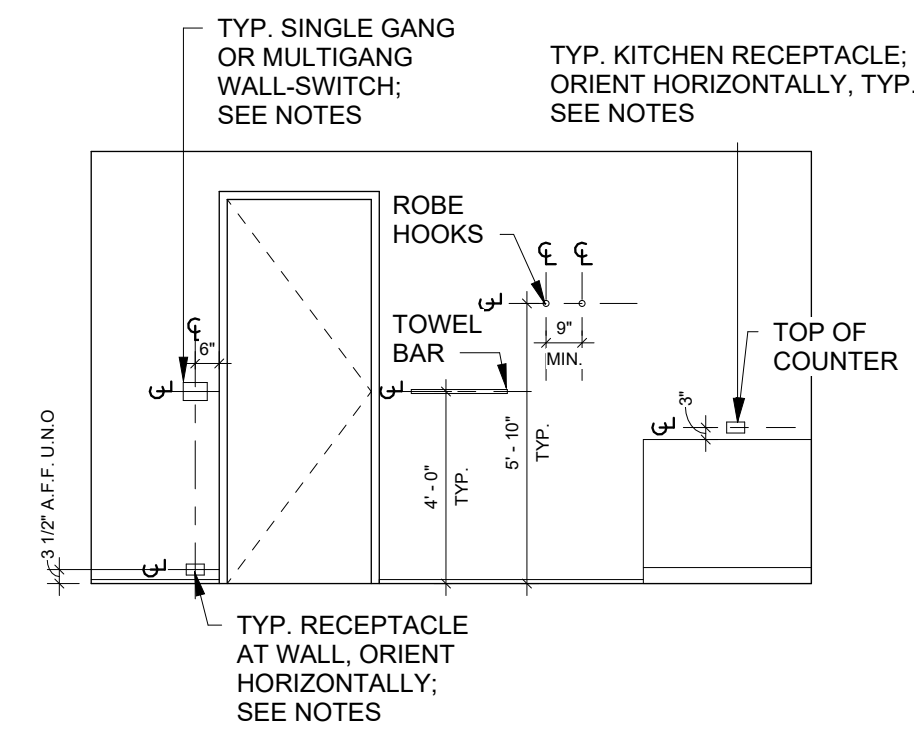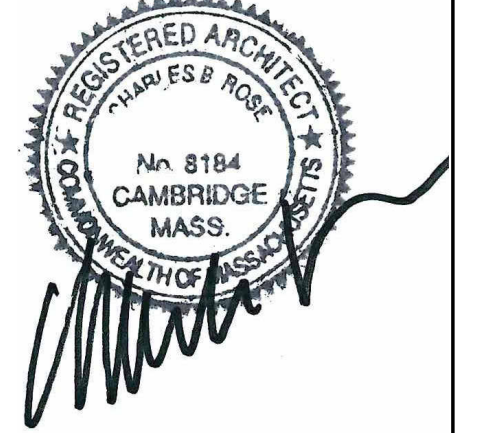

NOTE: COORDINATE ALL ROUGH-IN LOCATIONS WITH ARCHITECT & OWNER PRIOR TO DRYWALL INSTALLATION

CEILING PLAN KEY NOTES

1. MOTORIZED ROLL DOWN SHADE, RECESSED POCKET TYPE
2. RECESSED CURTAIN TRACK BY SILENT GLISS
3. MOTORIZED ROLL DOWN SHADE, RECESSED POCKET TYPE WITH RECESSED CURTAIN TRACK
4. 1" LINEAR SLOT DIFFUSER, FLOWBAR, GWB INSTALLATION FLANGE, MITER AT CORNERS, FL-10 TYPE 22
5. RETURN GRILLE

ELECTRICAL PLAN GENERAL NOTES

1. ELECTRICAL CONTRACTOR TO COORDINATE THE EXACT RECEPTACLE TYPE AND VOLTAGE FOR ALL EQUIPMENT WITH THE RESPECTIVE EQUIPMENT SUPPLIER PRIOR TO INSTALLATION.
2. STACK DEVICES, OUTLETS, AND SWITCHES WHENEVER POSSIBLE.
3. DEVICES, OUTLETS, AND SWITCHES SHALL BE CLEAR OF DOOR SWINGS.
4. REFER TO ARCHITECTURAL DRAWINGS FOR EXACT DEVICE LOCATIONS (RECEPTACLES, DETECTORS, DATA OUTLETS, AND TELEPHONE JACKS - TYPICAL) AND ADJUST ACCORDINGLY. THE ARCHITECT IS TO BE NOTIFIED OF ANY CONFLICTS WITH THE DEVICE LOCATIONS AND THE N.E.C. REQUIREMENTS. REFERENCE ARCHITECTURAL RCPs FOR SMOKE DETECTORS, CO DETECTORS, AND SWITCH PLATE SPECIFICATIONS.
5. ALL EXTERIOR LIGHTS TO BE 'SMART' SWITCHED IN ADDITION TO PHYSICAL.

GENERAL REFLECTED CEILING PLAN NOTES


1. ALL CEILING ARE GWB, UNLESS NOTED OTHERWISE.
2. ALL DIMENSION TO CENTERLINES OF LIGHTING FIXTURES & FINISH FACE OF WALL, U.N.O.
3. REVIEW LOCATIONS OF SMOKE DETECTORS WITH ARCHITECT PRIOR TO INSTALLING.
4. REVIEW LOCATIONS AND MOUNTING HEIGHTS FOR WALL HUNG LIGHTING FIXTURES WITH ARCHITECT PRIOR TO INSTALLING.
5. REF E-DWGS FOR SWITCHING INFORMATION.
6. ALL LIGHTS TO BE DIMMABLE.
7. BUSTER & PUNCH SWITCHES/DIMMERS IN KITCHEN, DINING, AND LIVING.
8. ALL OUTLETS IN WHITE GYPSUM WALLS TO BE LUTRON MAESTRO, SATIN WHITE.
9. ALL OUTLETS IN OTHER MATERIALS TO BE COORDINATED WITH OWNER AND ARCHITECT.
10. ALL OUTLETS IN WHITE GYPSUM WALLS TO BE LUTRON MAESTRO, SATIN WHITE.
11. FLOOR OUTLETS IN FRAMED FLOORS TO BE ARLINGTON FLBRS20, FINISH TO BE COORDINATED WITH OWNER/ARCHITECT.
12. FLOOR OUTLETS IN CONCRETE SLABS TO BE ARLINGTON FLBRS570, FINISH TO BE COORDINATED WITH OWNER/ARCHITECT.
13. RADIANT HEAT, FANS, AND CLOSET LIGHT SWITCHES AND CONTROLS SHALL BE CONCEALED IN CLOSETMILLWORK WHERE POSSIBLE.


REFLECTED CEILING PLAN LEGEND

- GYPSUM CEILING BOARD
- WOOD CEILING
- CEILING HEIGHT

RCP DEVICE LEGEND

- COMBO SMOKE/CO DETECTOR, HARDWIRED WITH 10 YR BATTERY BACKUP (KIDDIE P4010ACSO-W OR APPROVED SIMILAR)
- SECURITY CAMERA
- MOTION SENSOR
- SPRINKLER HEAD

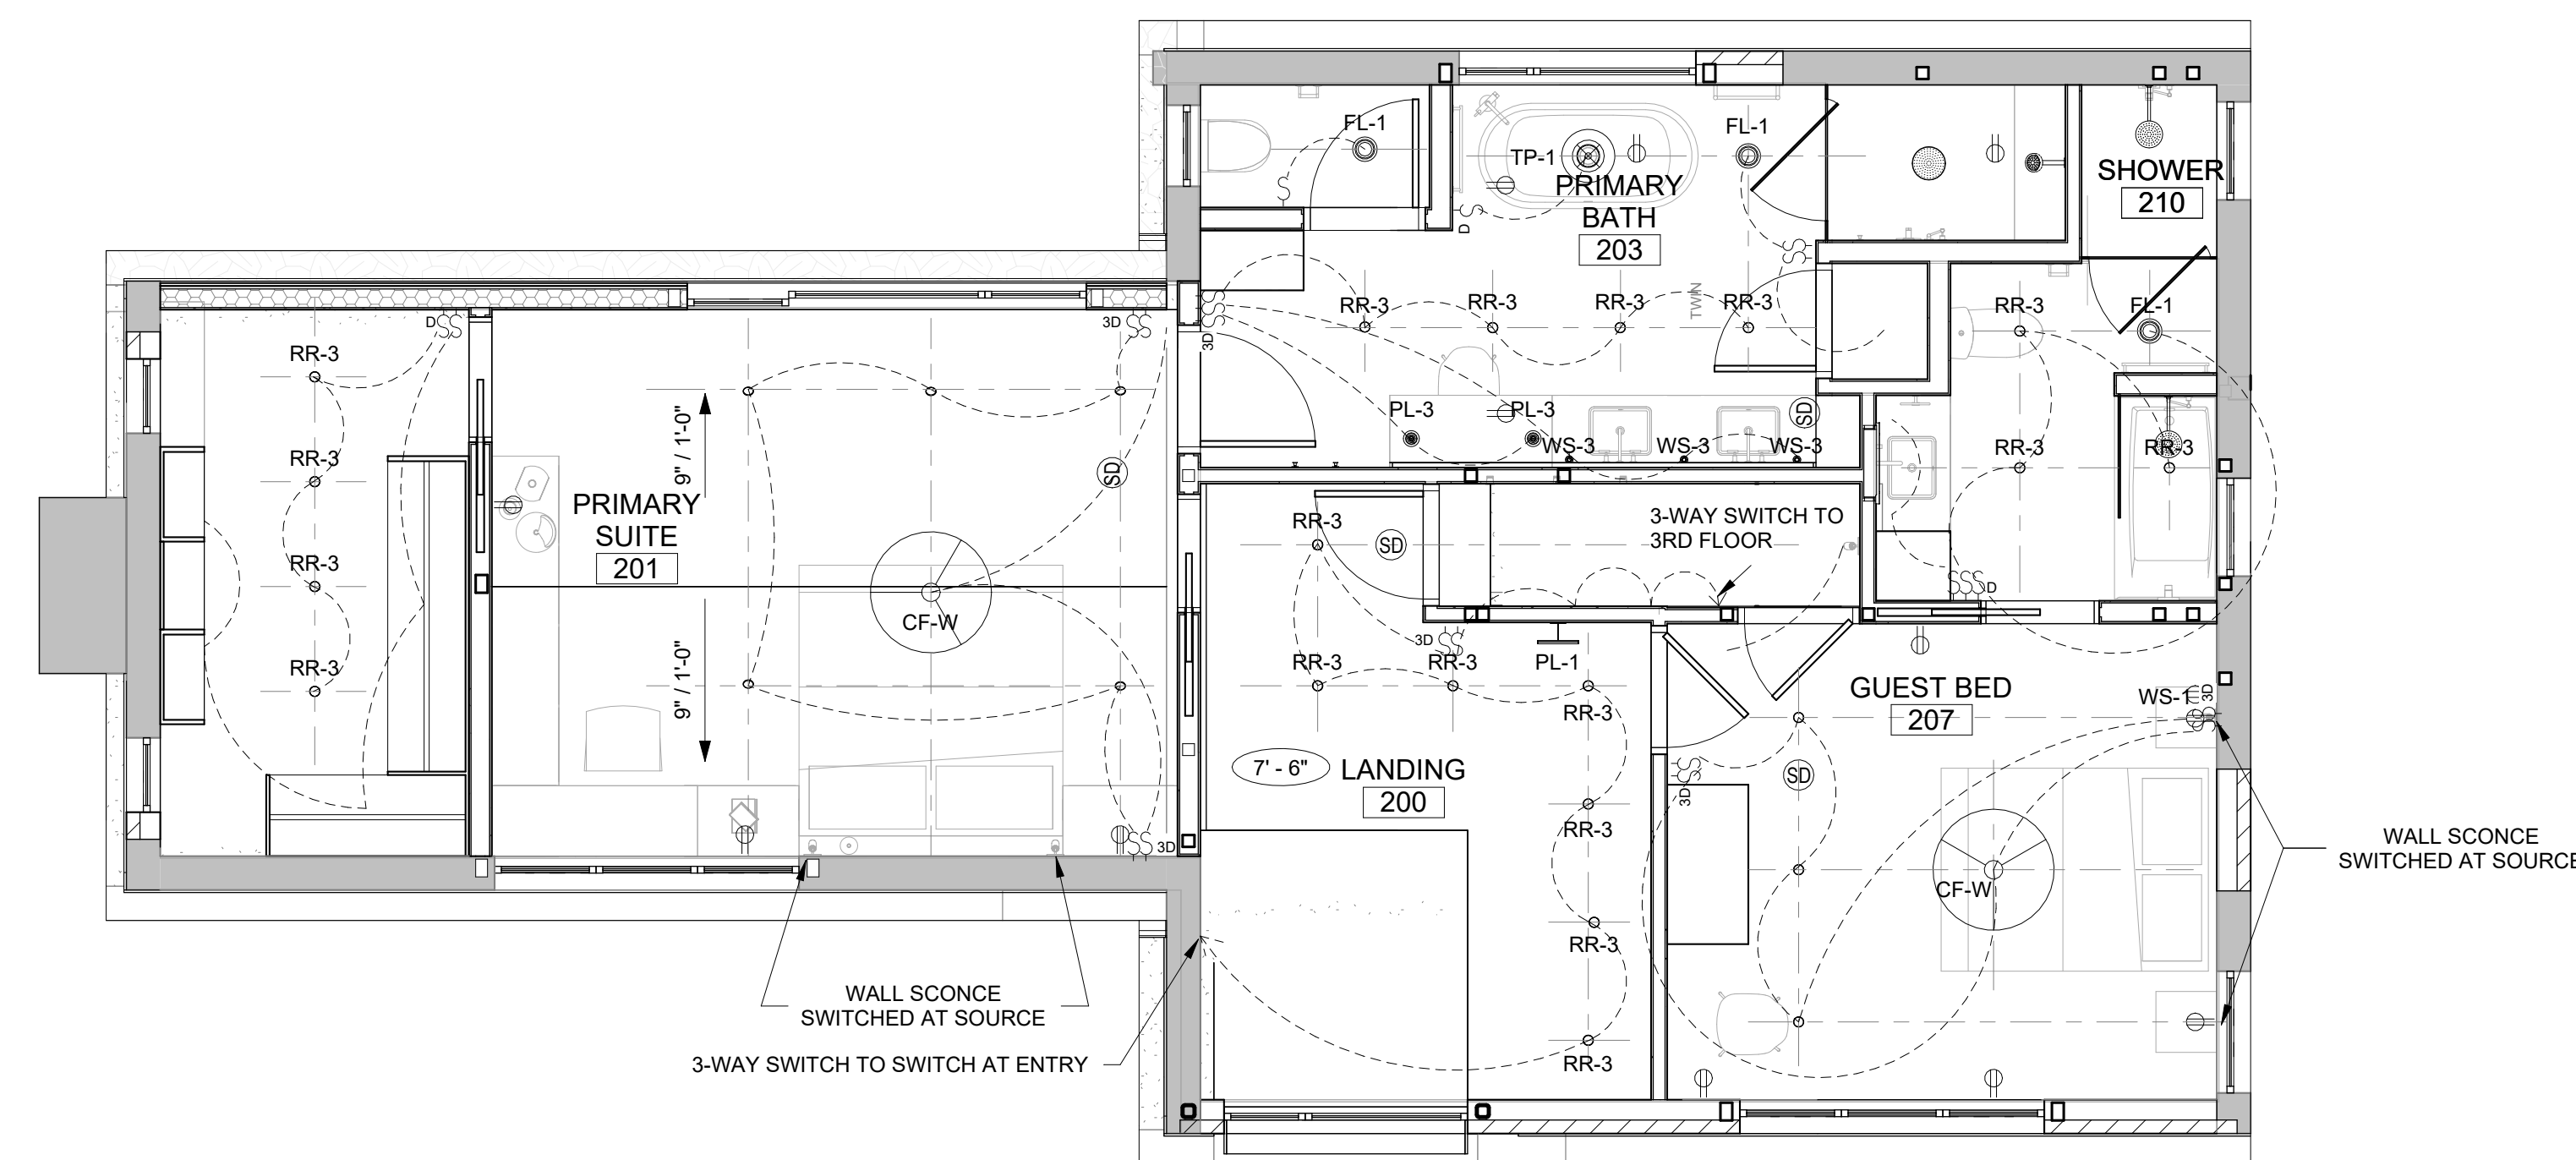

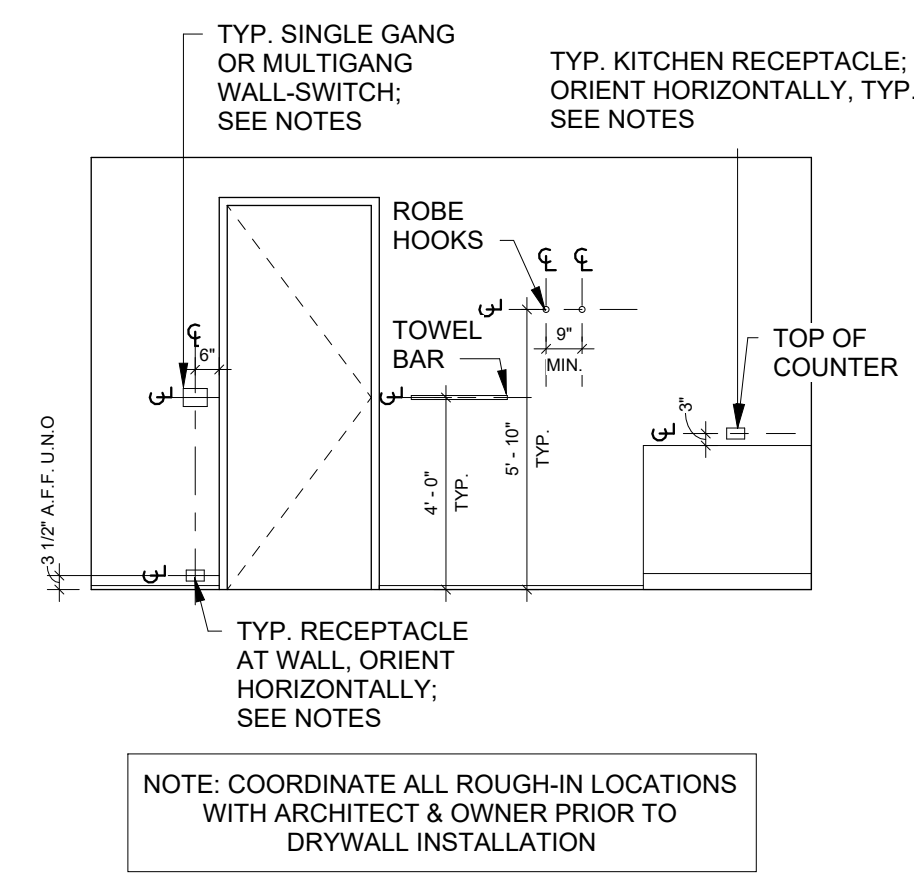

NOTE: COORDINATE ALL ROUGH-IN LOCATIONS WITH ARCHITECT & OWNER PRIOR TO DRYWALL INSTALLATION

CEILING PLAN KEY NOTES

1. MOTORIZED ROLL DOWN SHADE, RECESSED POCKET TYPE
2. RECESSED CURTAIN TRACK BY SILENT GLISS
3. MOTORIZED ROLL DOWN SHADE, RECESSED POCKET TYPE WITH RECESSED CURTAIN TRACK
4. 1" LINEAR SLOT DIFFUSER, FLOWBAR, GWB INSTALLATION FLANGE, MITER AT CORNERS, FL-10 TYPE 22
5. RETURN GRILLE

ELECTRICAL PLAN GENERAL NOTES

1. ELECTRICAL CONTRACTOR TO COORDINATE THE EXACT RECEPTACLE TYPE AND VOLTAGE FOR ALL EQUIPMENT WITH THE RESPECTIVE EQUIPMENT SUPPLIER PRIOR TO INSTALLATION.
2. STACK DEVICES, OUTLETS, AND SWITCHES WHENEVER POSSIBLE.
3. DEVICES, OUTLETS, AND SWITCHES SHALL BE CLEAR OF DOOR SWINGS.
4. REFER TO ARCHITECTURAL DRAWINGS FOR EXACT DEVICE LOCATIONS (RECEPTACLES, DETECTORS, DATA OUTLETS, AND TELEPHONE JACKS - TYPICAL) AND ADJUST ACCORDINGLY. THE ARCHITECT IS TO BE NOTIFIED OF ANY CONFLICTS WITH THE DEVICE LOCATIONS AND THE N.E.C. REQUIREMENTS.
5. REFERENCE ARCHITECTURAL ROPS FOR SMOKE DETECTORS, CO DETECTORS, AND SWITCH PLATE SPECIFICATIONS.
6. ALL EXTERIOR LIGHTS TO BE 'SMART' SWITCHED IN ADDITION TO PHYSICAL.

GENERAL REFLECTED CEILING PLAN NOTES


1. ALL CEILINGS ARE GWB, UNLESS NOTED OTHERWISE.
2. ALL DIMENSION TO CENTERLINES OF LIGHTING FIXTURES & FINISH FACE OF WALL, U.N.O.
3. REVIEW LOCATIONS OF SMOKE DETECTORS WITH ARCHITECT PRIOR TO INSTALLING.
4. REVIEW LOCATIONS AND MOUNTING HEIGHTS FOR WALL HUNG LIGHTING FIXTURES WITH ARCHITECT PRIOR TO INSTALLING.
5. REF E-DWGS FOR SWITCHING INFORMATION.
6. ALL LIGHTS TO BE DIMMABLE.
7. BUSTER & PUNCH SWITCHES/DIMMERS IN KITCHEN, DINING, AND LIVING.
8. ALL OUTLETS IN WHITE GYPSUM WALLS TO BE LUTRON MAESTRO, SATIN WHITE.
9. ALL OUTLETS IN OTHER MATERIALS TO BE COORDINATED WITH OWNER AND ARCHITECT.
10. ALL OUTLETS IN WHITE GYPSUM WALLS TO BE LUTRON MAESTRO, SATIN WHITE.
11. ALL OUTLETS IN FRAMED FLOORS TO BE ARLINGTON FLBRS20, FINISH TO BE COORDINATED WITH OWNER/ARCHITECT.
12. FLOOR OUTLETS IN CONCRETE SLABS TO BE ARLINGTON FLBRS570, FINISH TO BE COORDINATED WITH OWNER/ARCHITECT.
13. RADIANT HEAT, FANS, AND CLOSET LIGHT SWITCHES AND CONTROLS SHALL BE CONCEALED IN CLOSETSMILLWORK WHERE POSSIBLE.

REFLECTED CEILING PLAN LEGEND

- [Symbol] GYPSUM CEILING BOARD
- [Symbol] WOOD CEILING
- [Symbol] 0'-0" CEILING HEIGHT

RCP DEVICE LEGEND


- [Symbol] COMBO SMOKE/CO DETECTOR, HARDWIRED WITH 10 YR BATTERY BACKUP (KIDDIE P4010ACSO-W OR APPROVED SIMILAR)
- [Symbol] SECURITY CAMERA
- [Symbol] MOTION SENSOR
- [Symbol] SPRINKLER HEAD

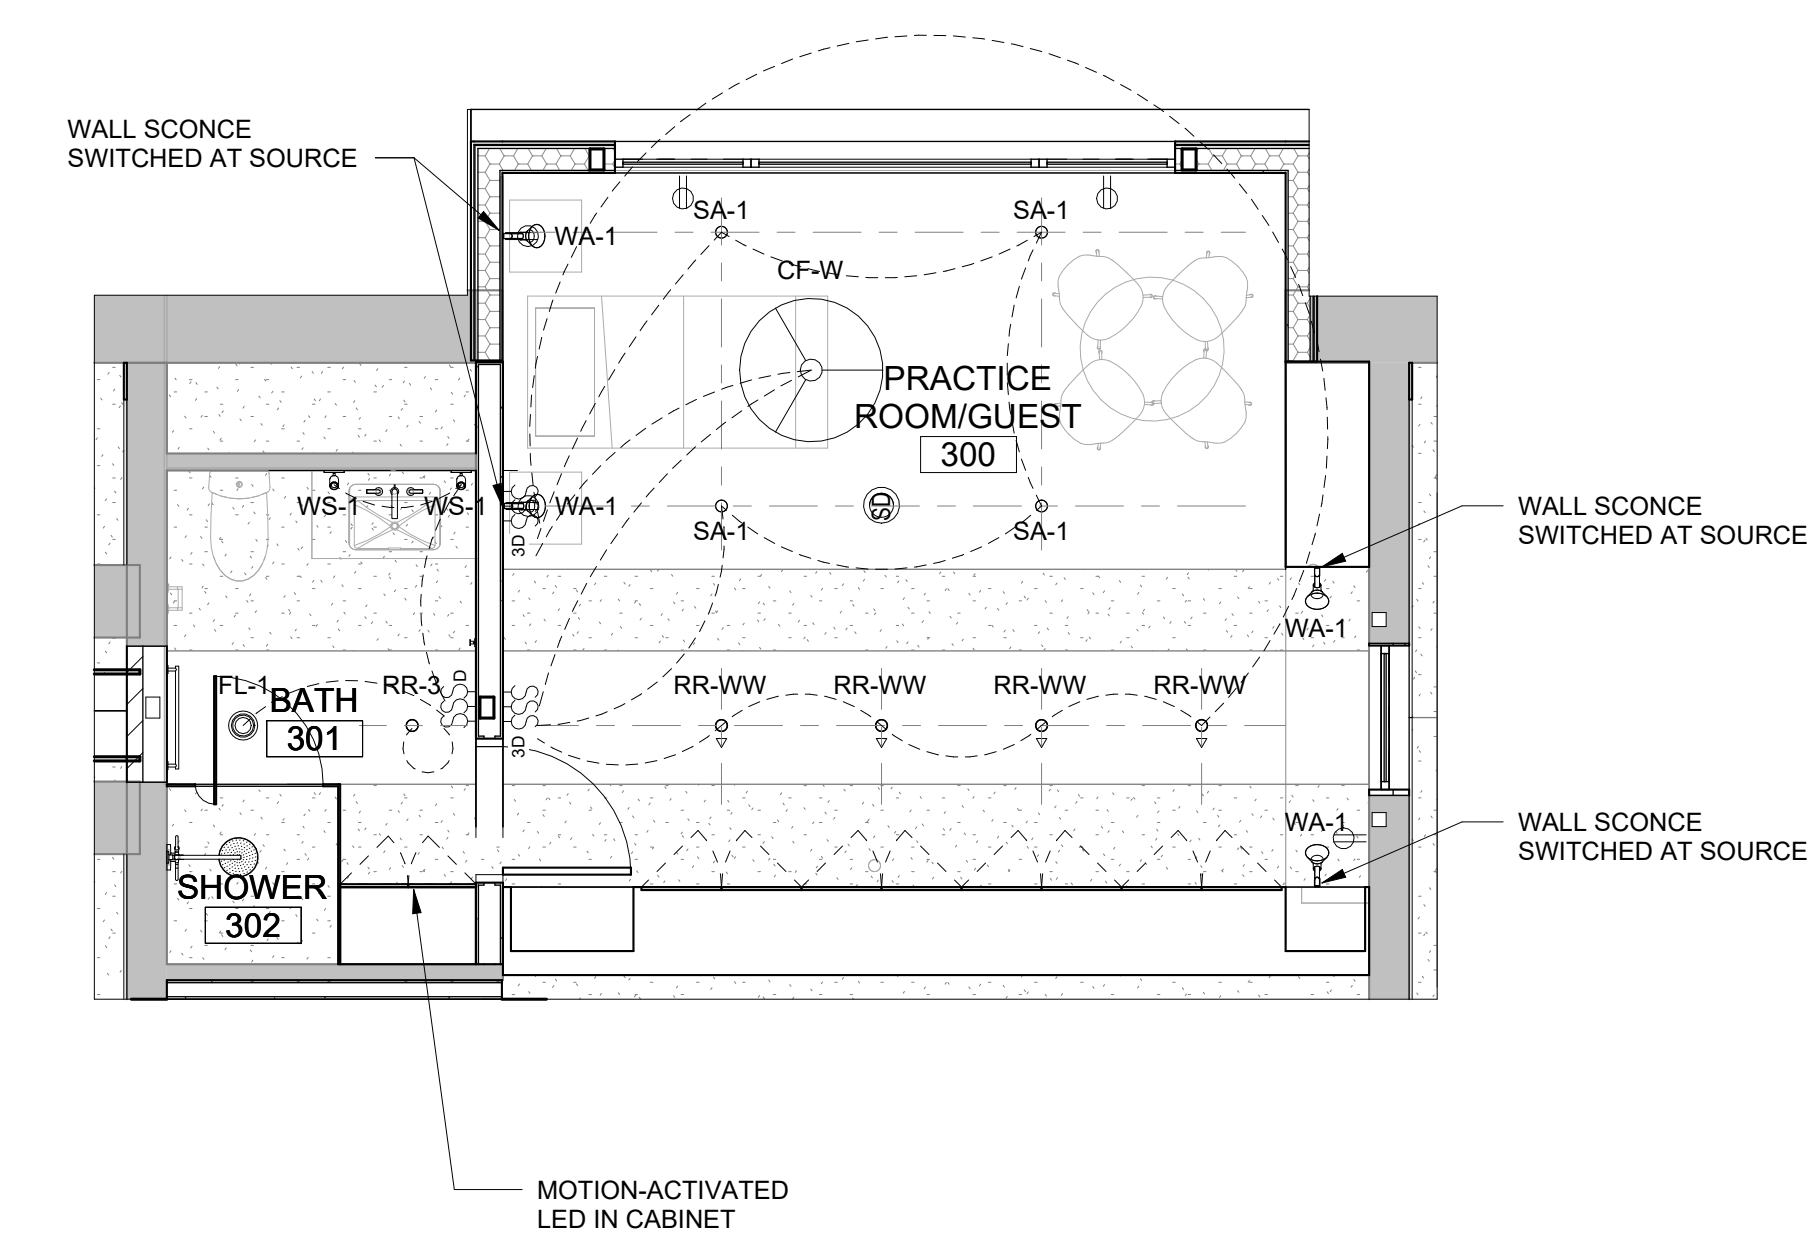

REVISION HISTORY		
NO.	DESCRIPTION	DATE

PERMIT REVISION	
DATE	DESCRIPTION
AUG 18, 2023	As indicated

DRAWN BY:	CHECKED BY:
CJ	CR

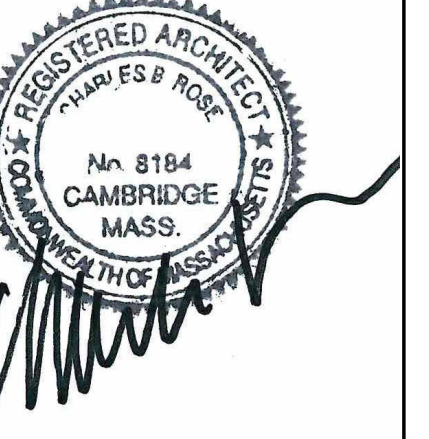

GENERAL SITE LIGHTING PLAN NOTES


- EXISTING 1' CONTOURS
- EXISTING 10' CONTOURS
- - - DRIVEWAY AND HARDSCAPE BOUNDARIES

GENERAL NOTES

1. DRIVEWAY LAYOUT AND TREE REMOVAL TO ISSUED AFTER SURVEY RETURNED. TO BE VERIFIED IN FIELD WITH ARCHITECT AND OWNER.
2. EXISTING MAJOR UTILITIES TO BE LOCATED AFTER SURVEY RETURNED.
3. PROPOSED GRADING TO BE ISSUED WITH CONSTRUCTION DOCUMENT SET.

GENERAL ELECTRICAL NOTES

1. ELECTRICAL CONTRACTOR TO COORDINATE THE EXACT RECEPTACLE TYPE AND VOLTAGE FOR ALL EQUIPMENT WITH THE RESPECTIVE EQUIPMENT SUPPLIER PRIOR TO INSTALLATION.
2. STACK DEVICES, OUTLETS, AND SWITCHES WHENEVER POSSIBLE.
3. DEVICES, OUTLETS, AND SWITCHES SHALL BE CLEAR OF DOOR SWINGS.
4. REFER TO ARCHITECTURAL DRAWINGS FOR EXACT DEVICE LOCATIONS (RECEPTACLES, DETECTORS, DATA OUTLETS, AND TELEPHONE JACKS - TYPICAL) AND ADJUST ACCORDINGLY. THE ARCHITECT IS TO BE NOTIFIED OF ANY CONFLICTS WITH THE DEVICE LOCATIONS AND THE N.E.C. REQUIREMENTS. REFERENCE ARCHITECTURAL RCPS FOR SMOKE DETECTORS, CO DETECTORS, AND SWITCH PLATE SPECIFICATIONS.
5. ALL DIMENSION TO CENTERLINES OF LIGHTING FIXTURES & FINISH FACE OF WALL, U.N.O.
6. REVIEW LOCATIONS AND MOUNTING HEIGHTS FOR WALL HUNG LIGHTING FIXTURES WITH ARCHITECT PRIOR TO INSTALLING.
7. REF AS EX DRAWINGS FOR SWITCHING INFORMATION.
8. ALL LIGHTS TO BE DIMMABLE.
9. ALL EXTERIOR LIGHTS TO BE 'SMART' SWITCHED IN ADDITION TO PHYSICAL.
10. ALL OUTLETS IN WHITE GYPSUM WALLS TO BE LUTRON MAESTRO, SATIN WHITE.
11. ALL OUTLETS IN OTHER MATERIALS TO BE COORDINATED WITH OWNER AND ARCHITECT.
- 12.

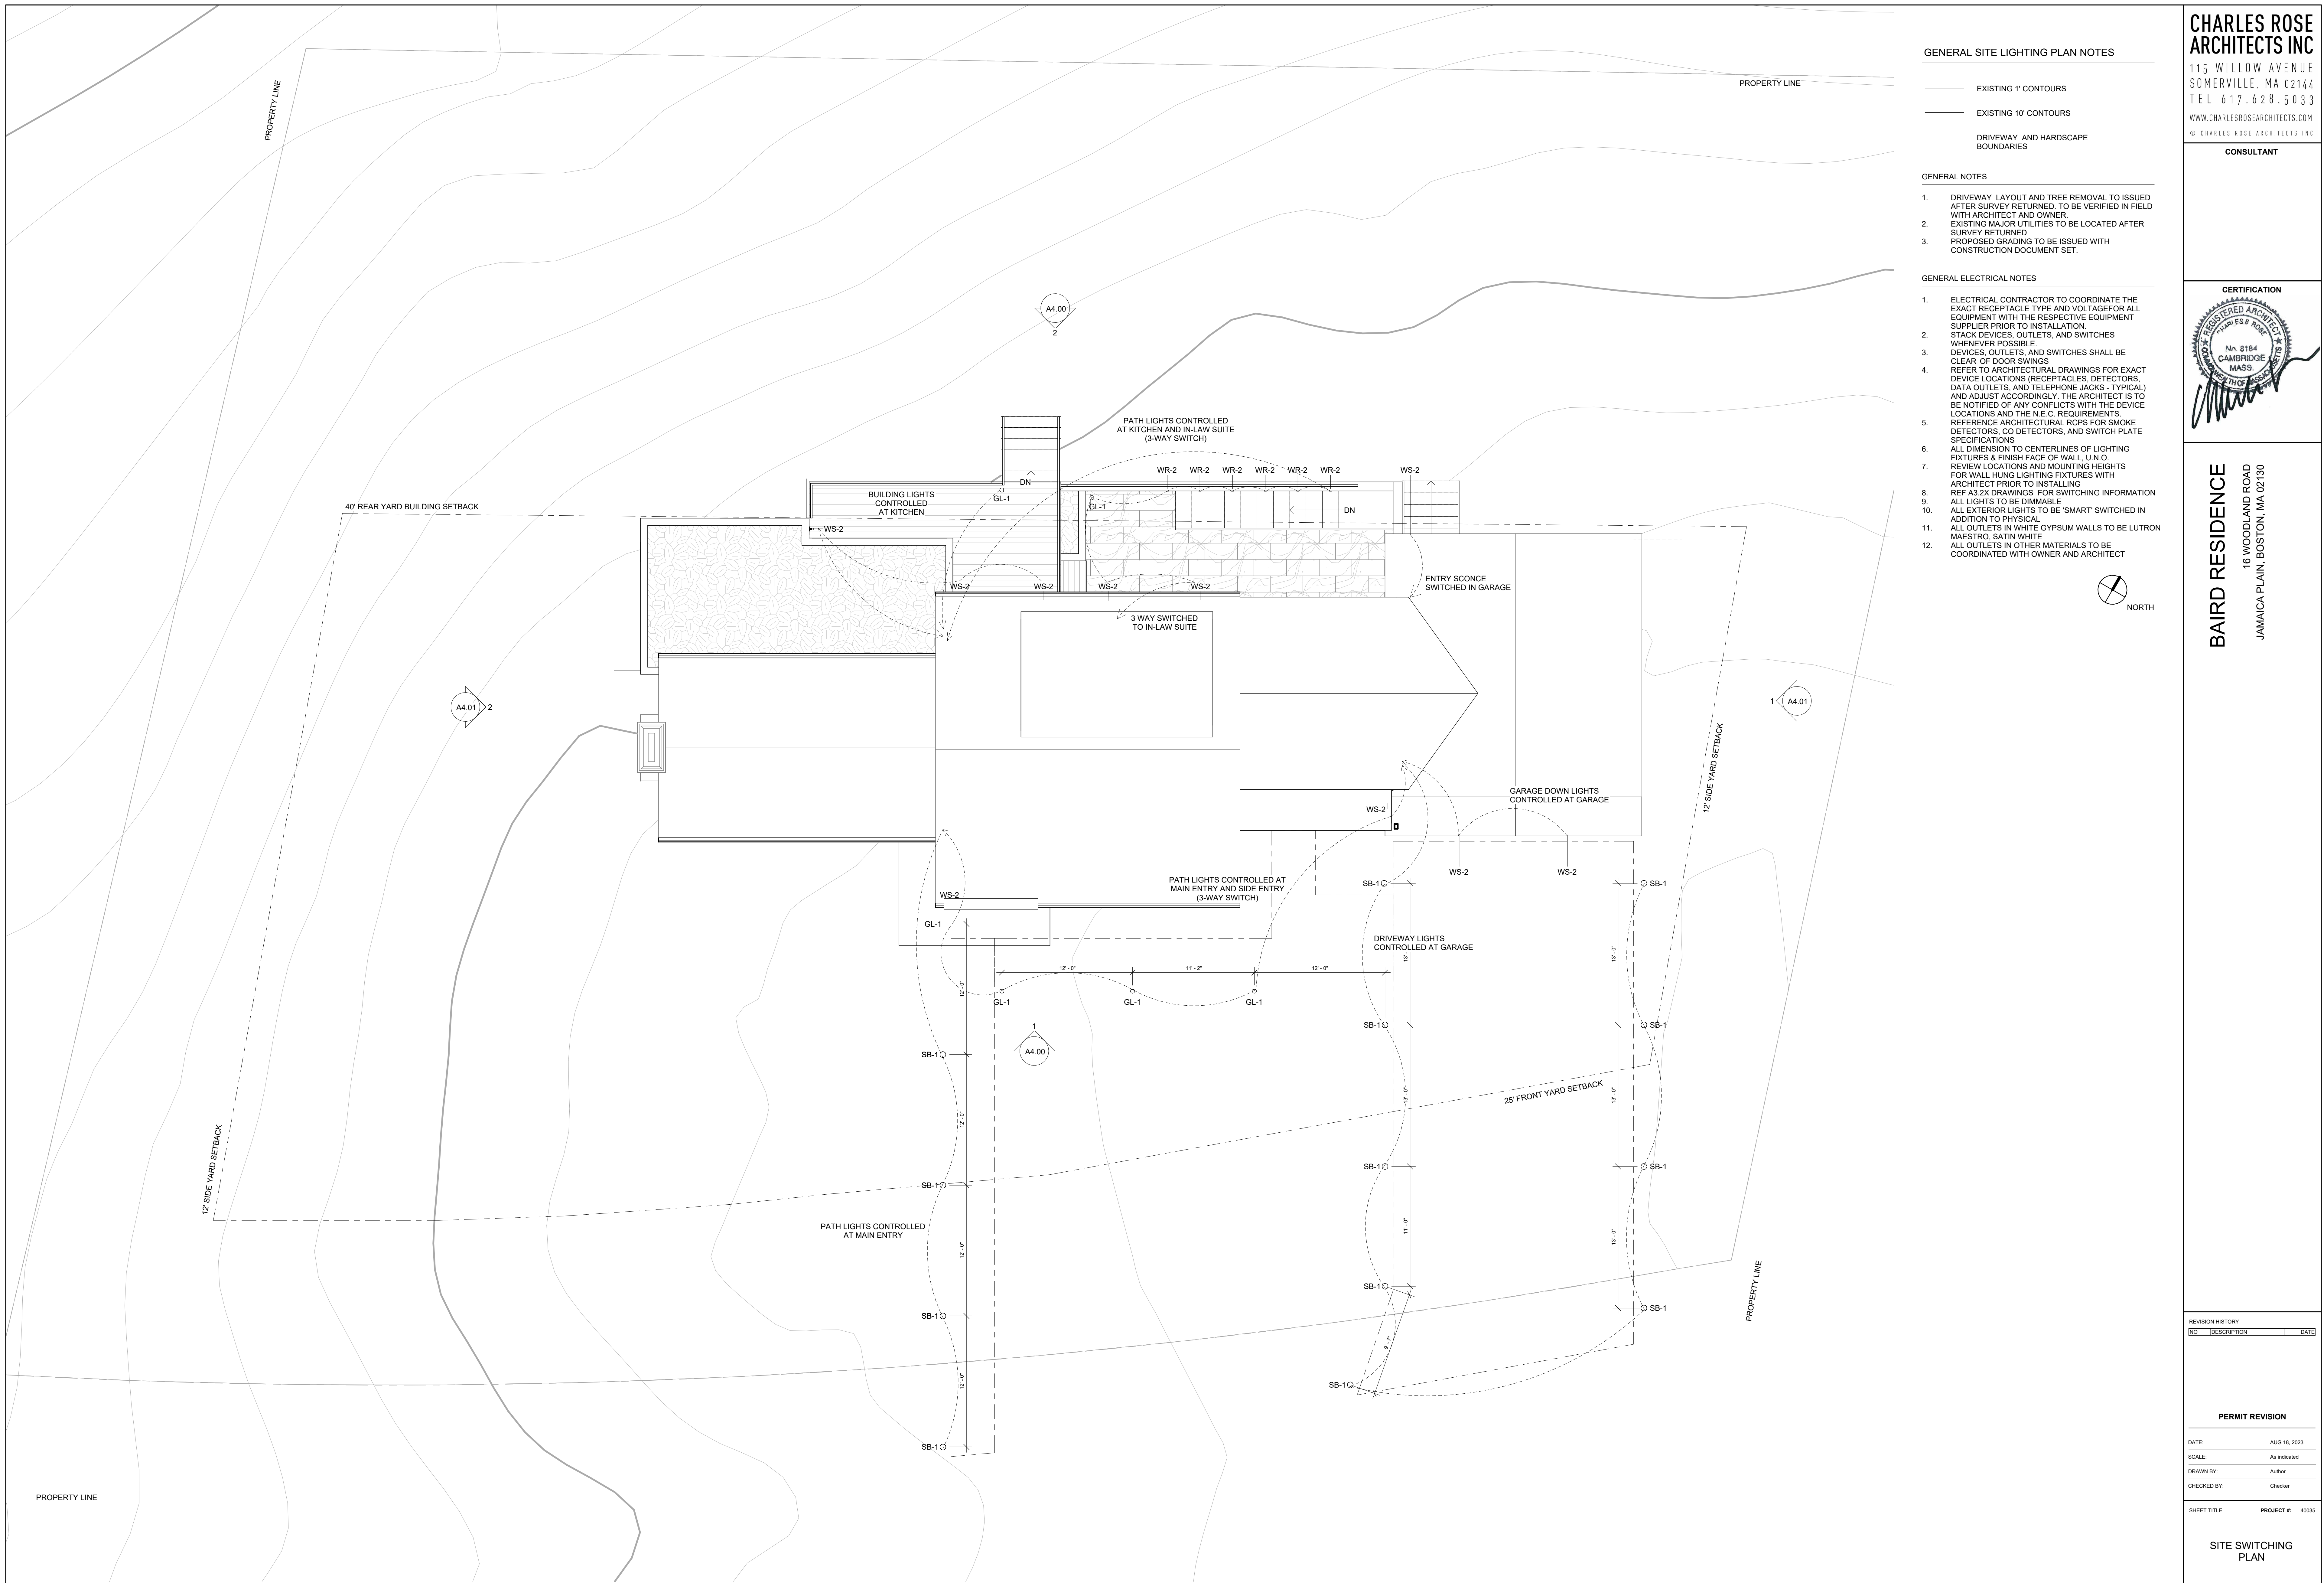



REVISION HISTORY		
NO.	DESCRIPTION	DATE

PERMIT REVISION


DATE:	AUG 18, 2023
SCALE:	As indicated
DRAWN BY:	Author
CHECKED BY:	Checker

SHEET TITLE	PROJECT #
	40035

SITE SWITCHING PLAN

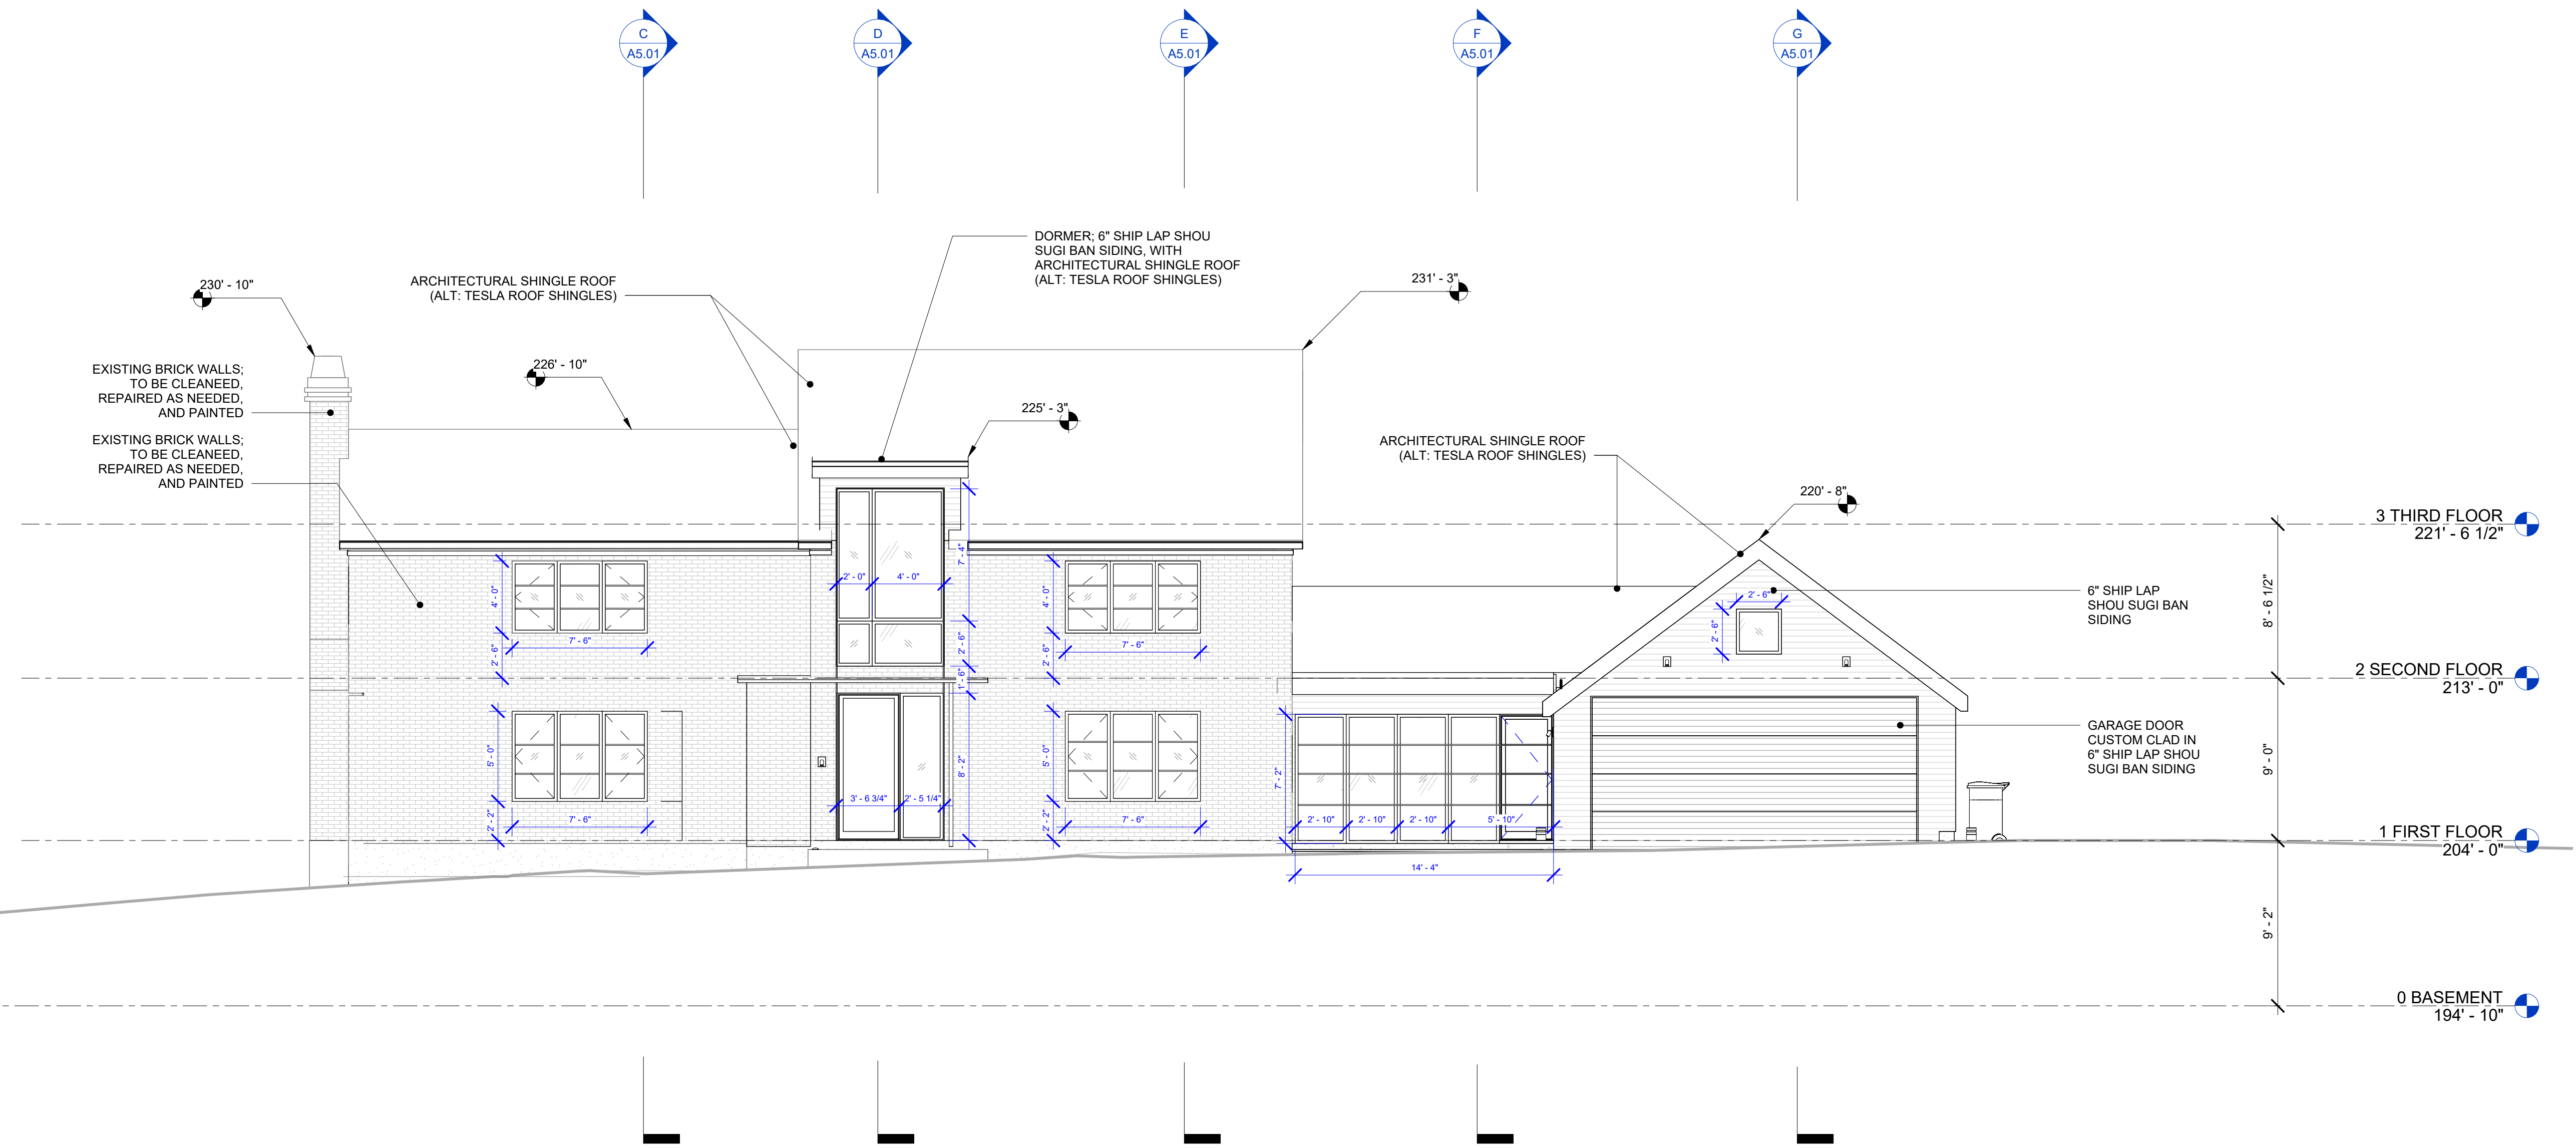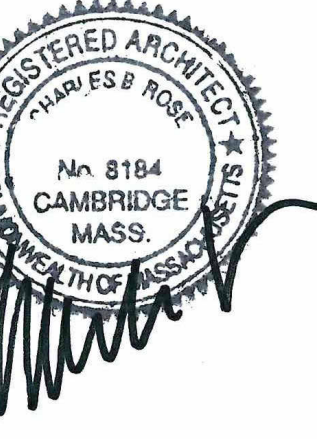

1 SOUTH ELEVATION
 3/16" = 1'-0"

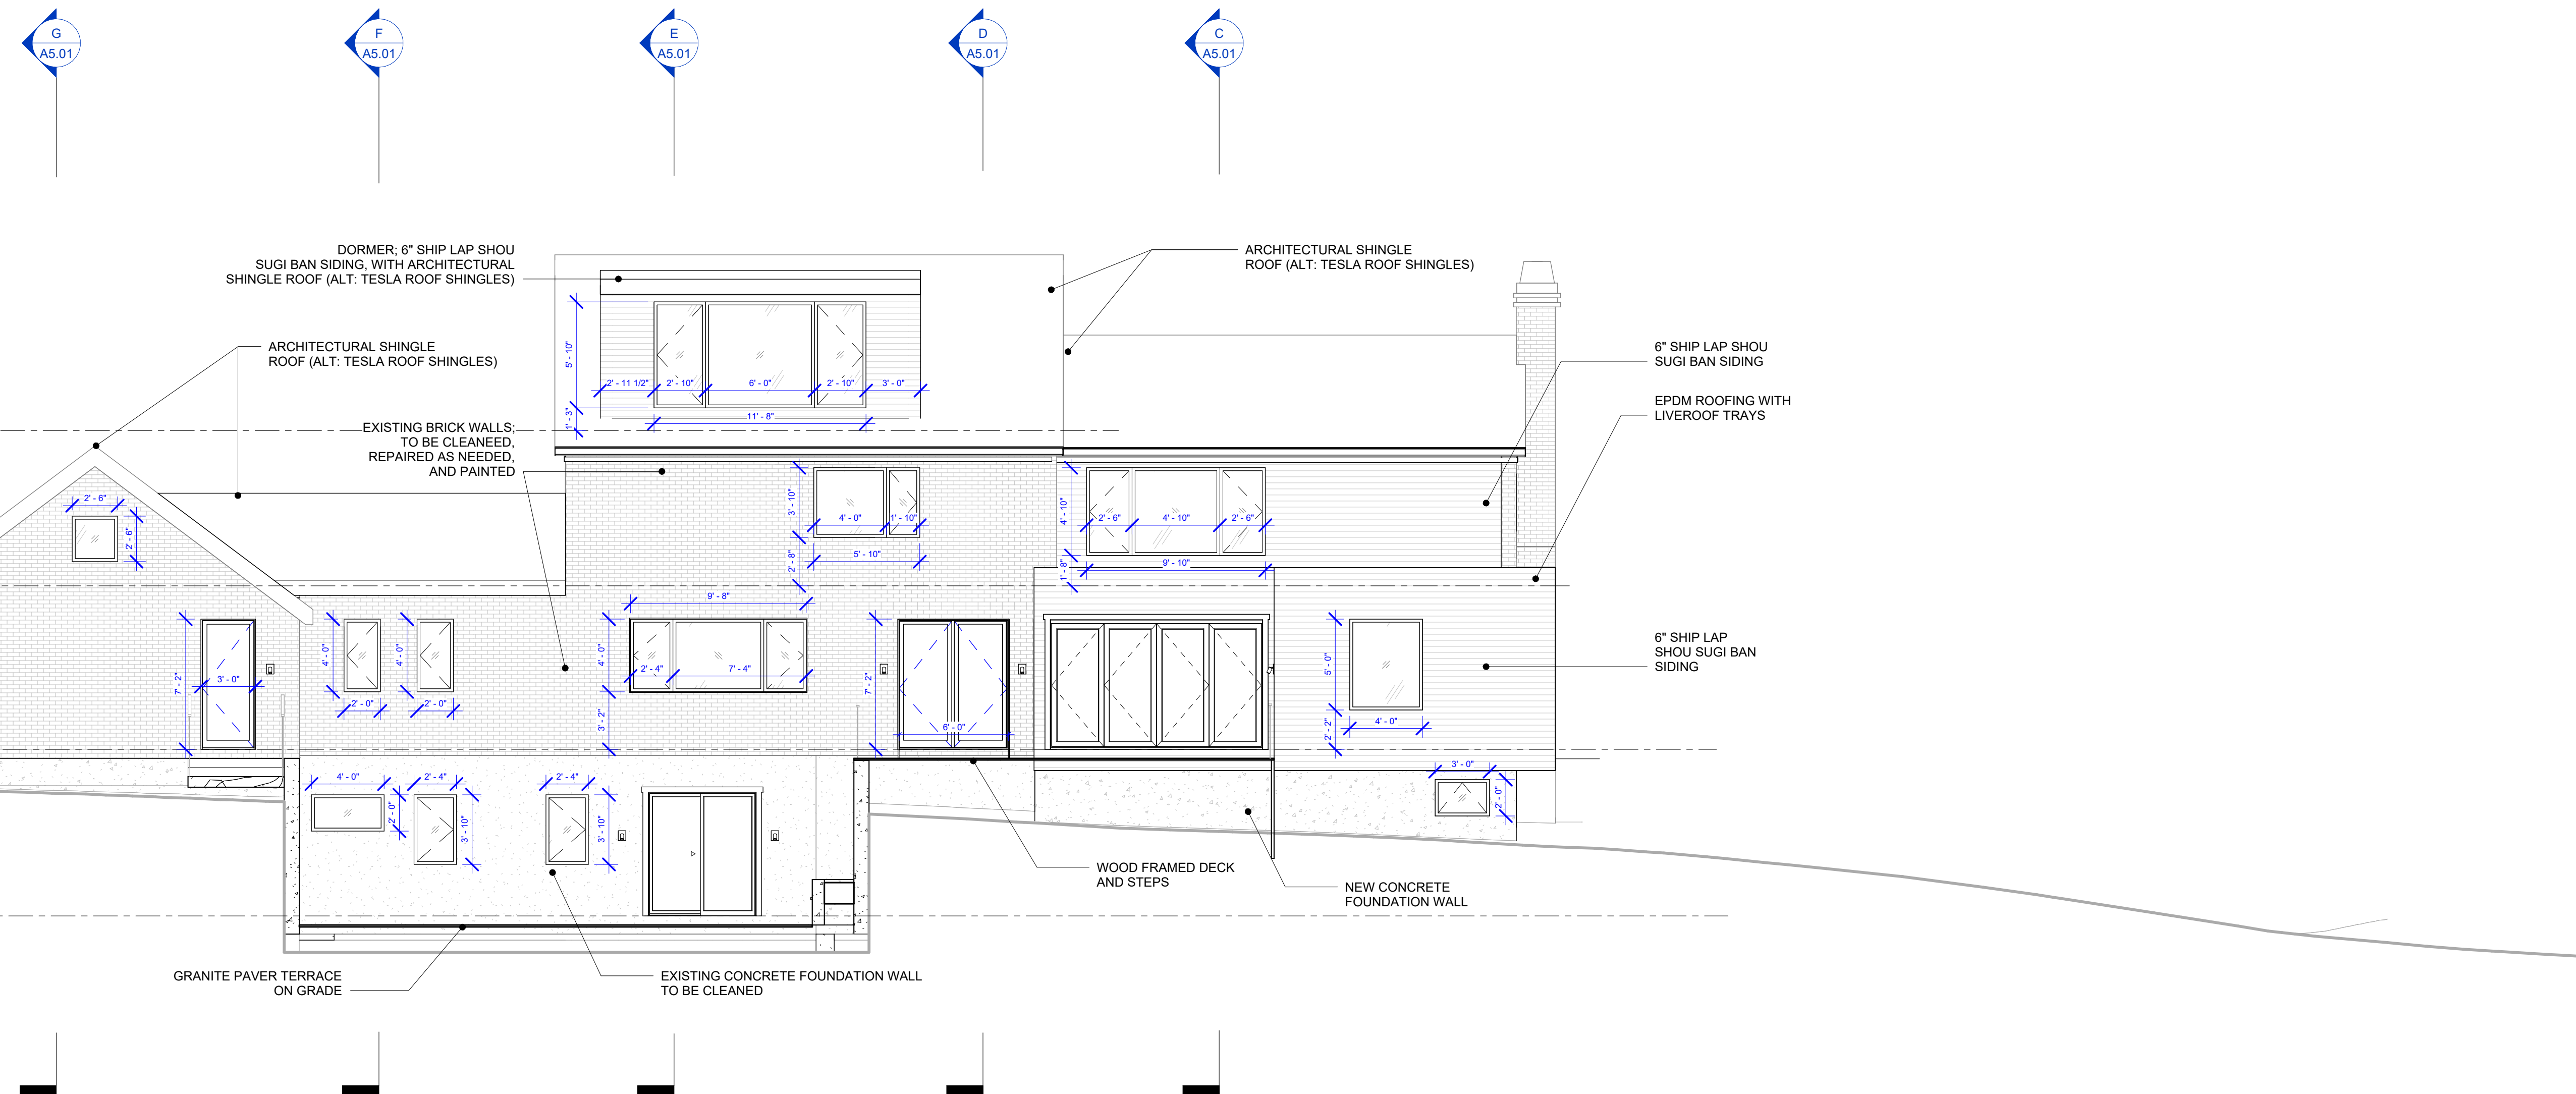

2 NORTH ELEVATION
 3/16" = 1'-0"

REVISION HISTORY		
NO.	DESCRIPTION	DATE

PERMIT REVISION

DATE:	AUG 18, 2023
SCALE:	3/16" = 1'-0"
DRAWN BY:	CJ
CHECKED BY:	CR


SHEET TITLE	PROJECT #
EXTERIOR ELEVATIONS	40035

EXTERIOR ELEVATIONS


A4.00

CONSULTANT


CERTIFICATION

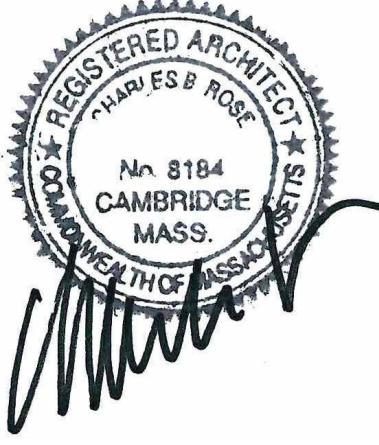

BAIRD RESIDENCE
 16 WOODLAND ROAD
 JAMAICA PLAIN, BOSTON, MA 02130

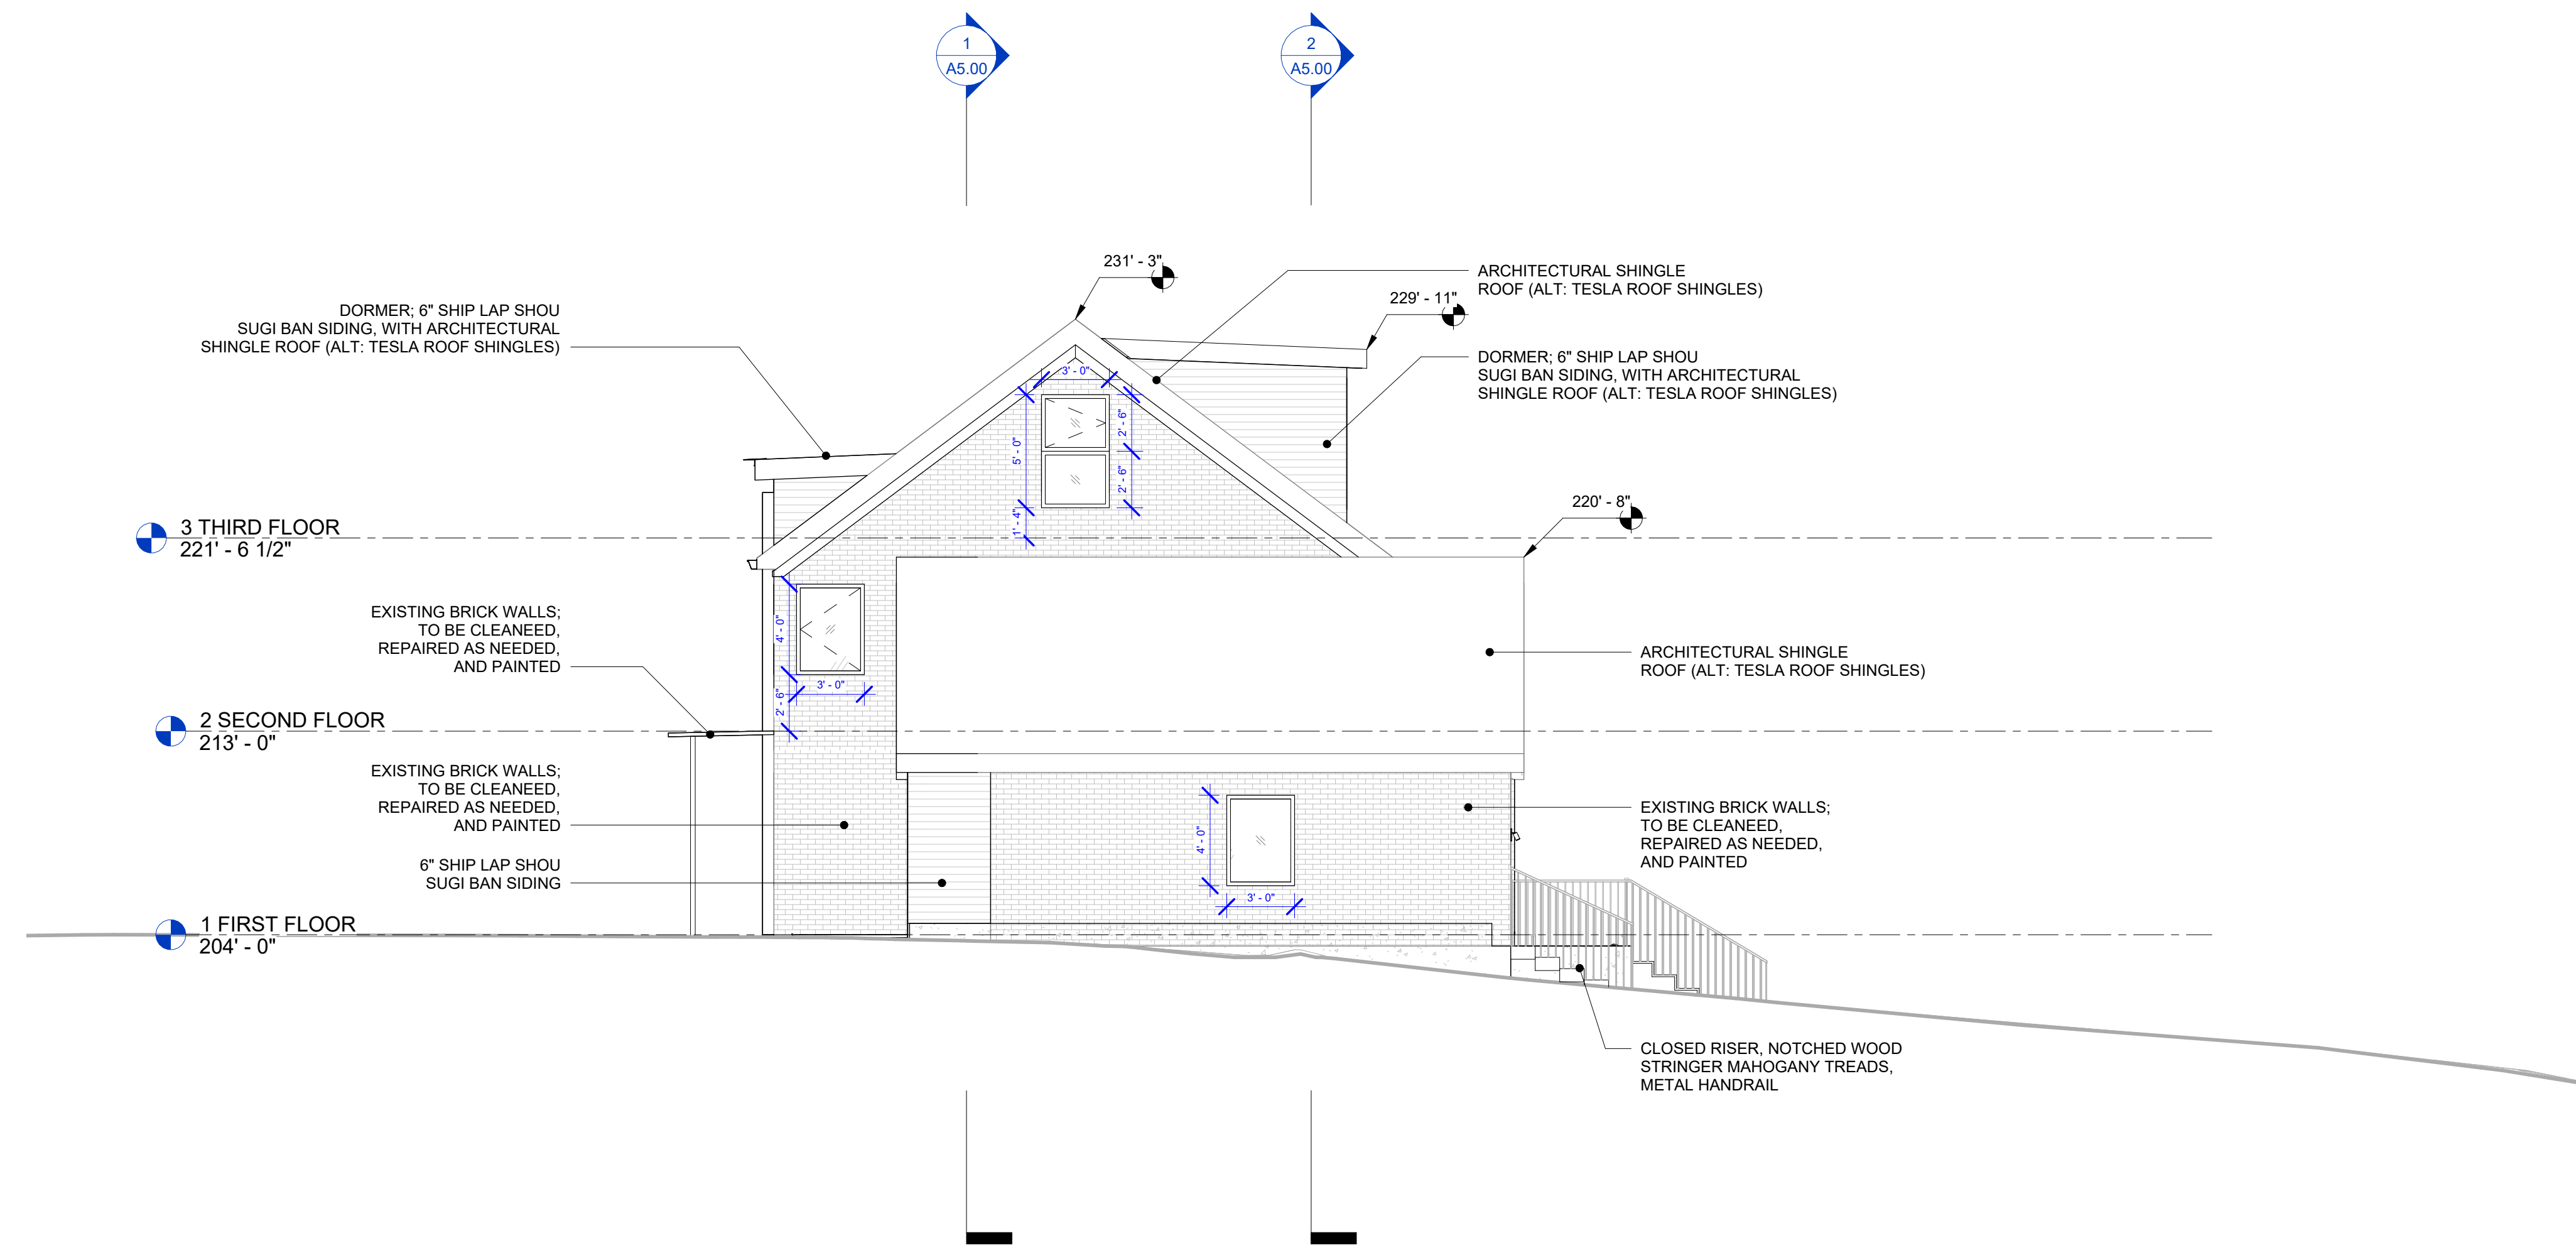

1 EAST ELEVATION
 3/16" = 1'-0"

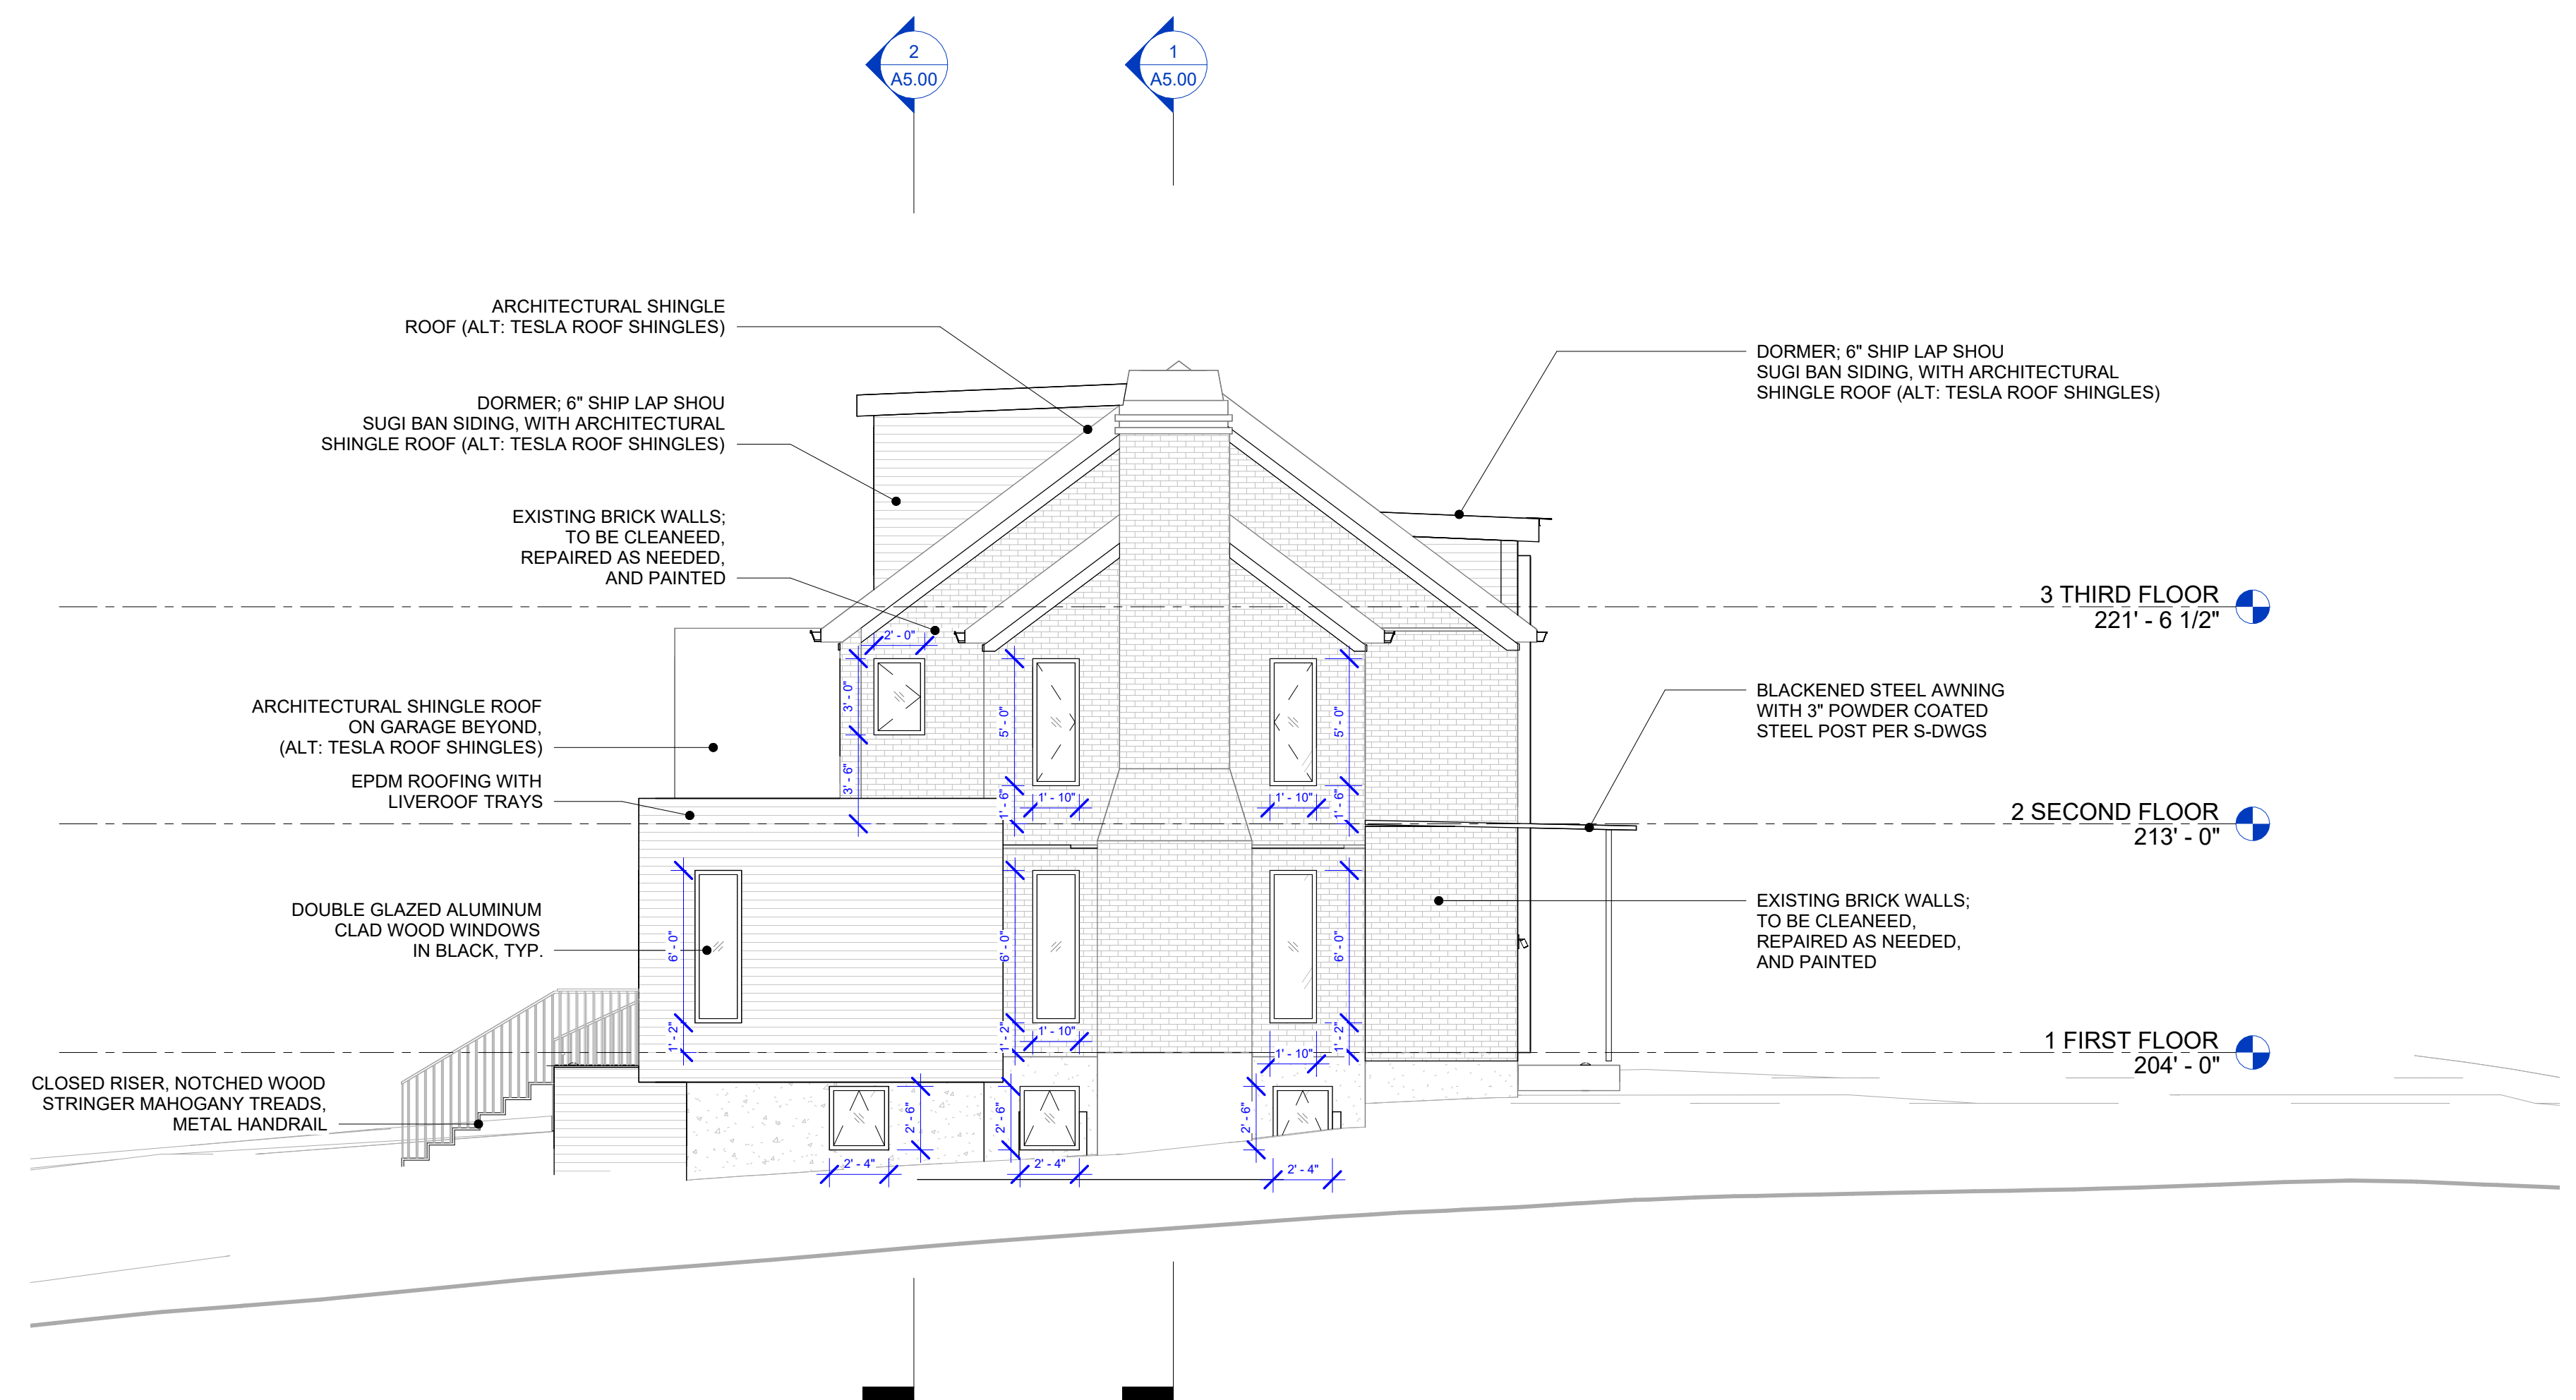

2 WEST ELEVATION
 3/16" = 1'-0"



REVISION HISTORY		
NO.	DESCRIPTION	DATE

PERMIT REVISION

DATE:	AUG 18, 2023
SCALE:	3/16" = 1'-0"
DRAWN BY:	CJ
CHECKED BY:	Checker

SHEET TITLE PROJECT # 40035

EXTERIOR ELEVATIONS

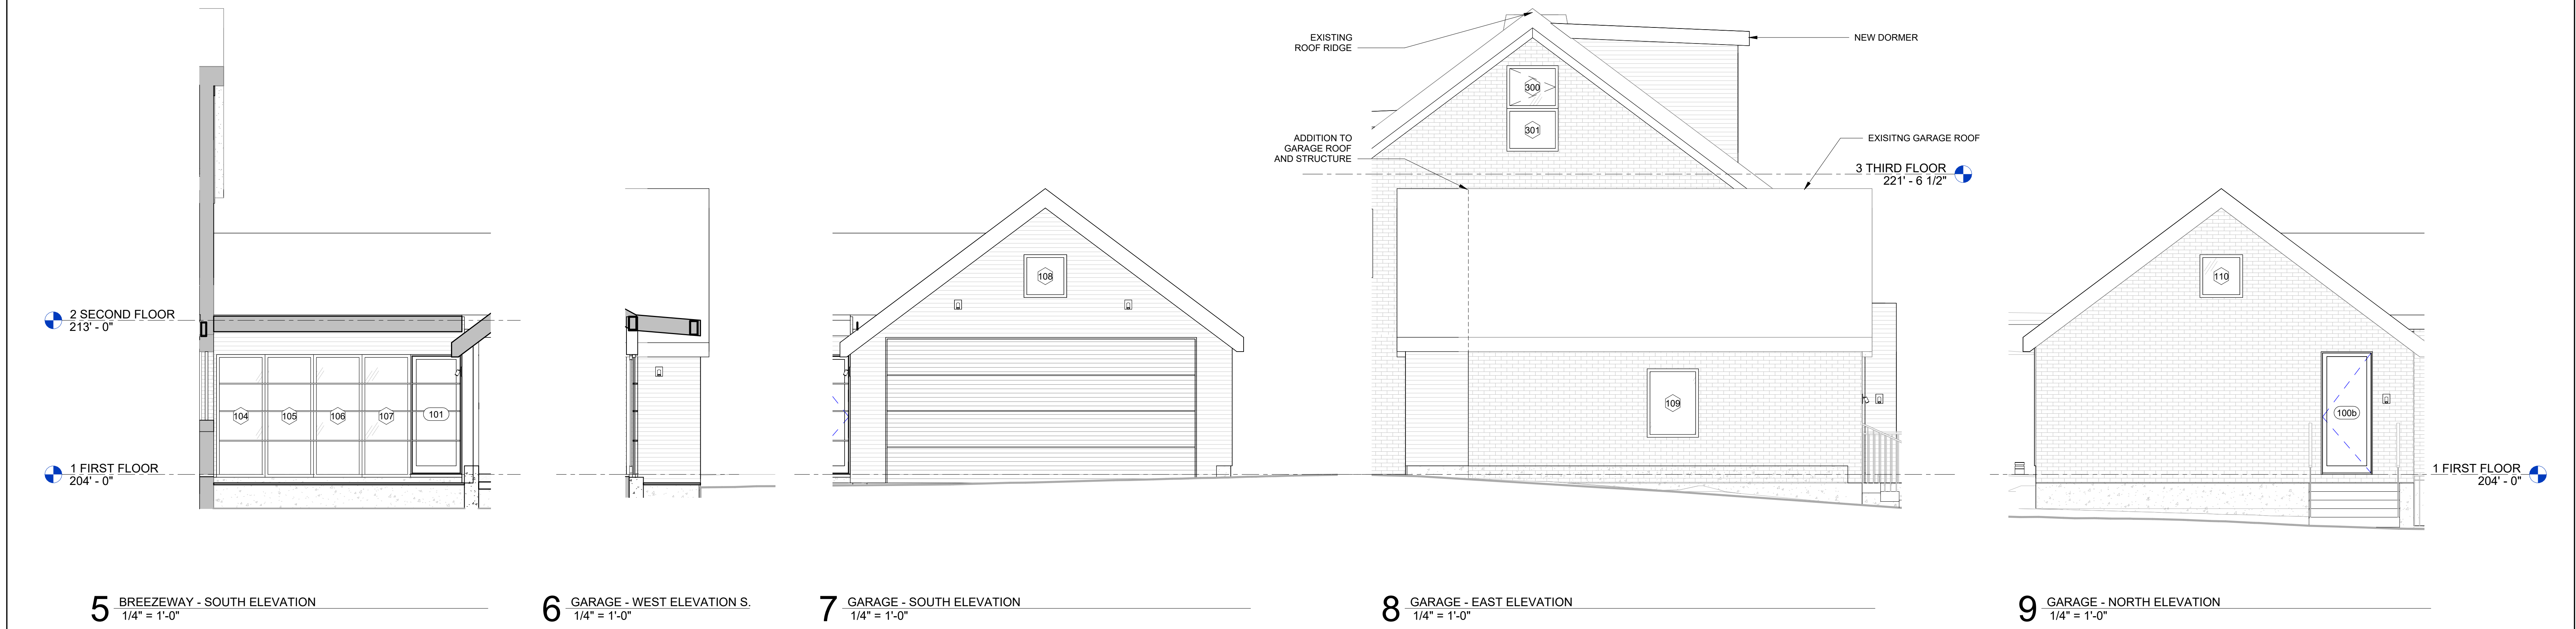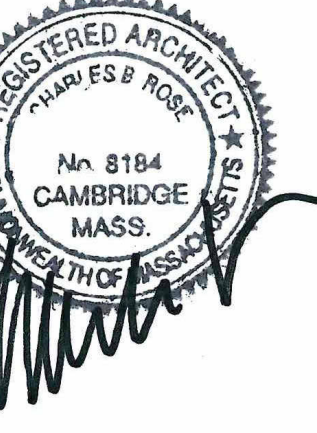

REVISION HISTORY		
NO.	DESCRIPTION	DATE


PERMIT REVISION	
DATE:	AUG 18, 2023
SCALE:	1/4" = 1'-0"
DRAWN BY:	CJ
CHECKED BY:	CR

SHEET TITLE PROJECT #: 40035


ENLARGED ELEVATIONS

CONSULTANT

CERTIFICATION

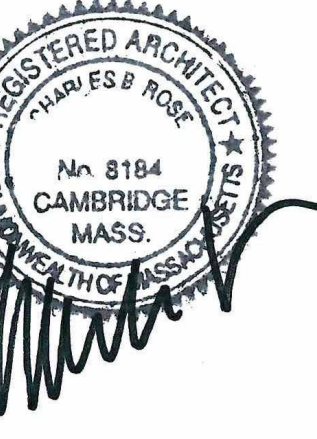

BAIRD RESIDENCE
 16 WOODLAND ROAD
 JAMAICA PLAIN, BOSTON, MA 02130

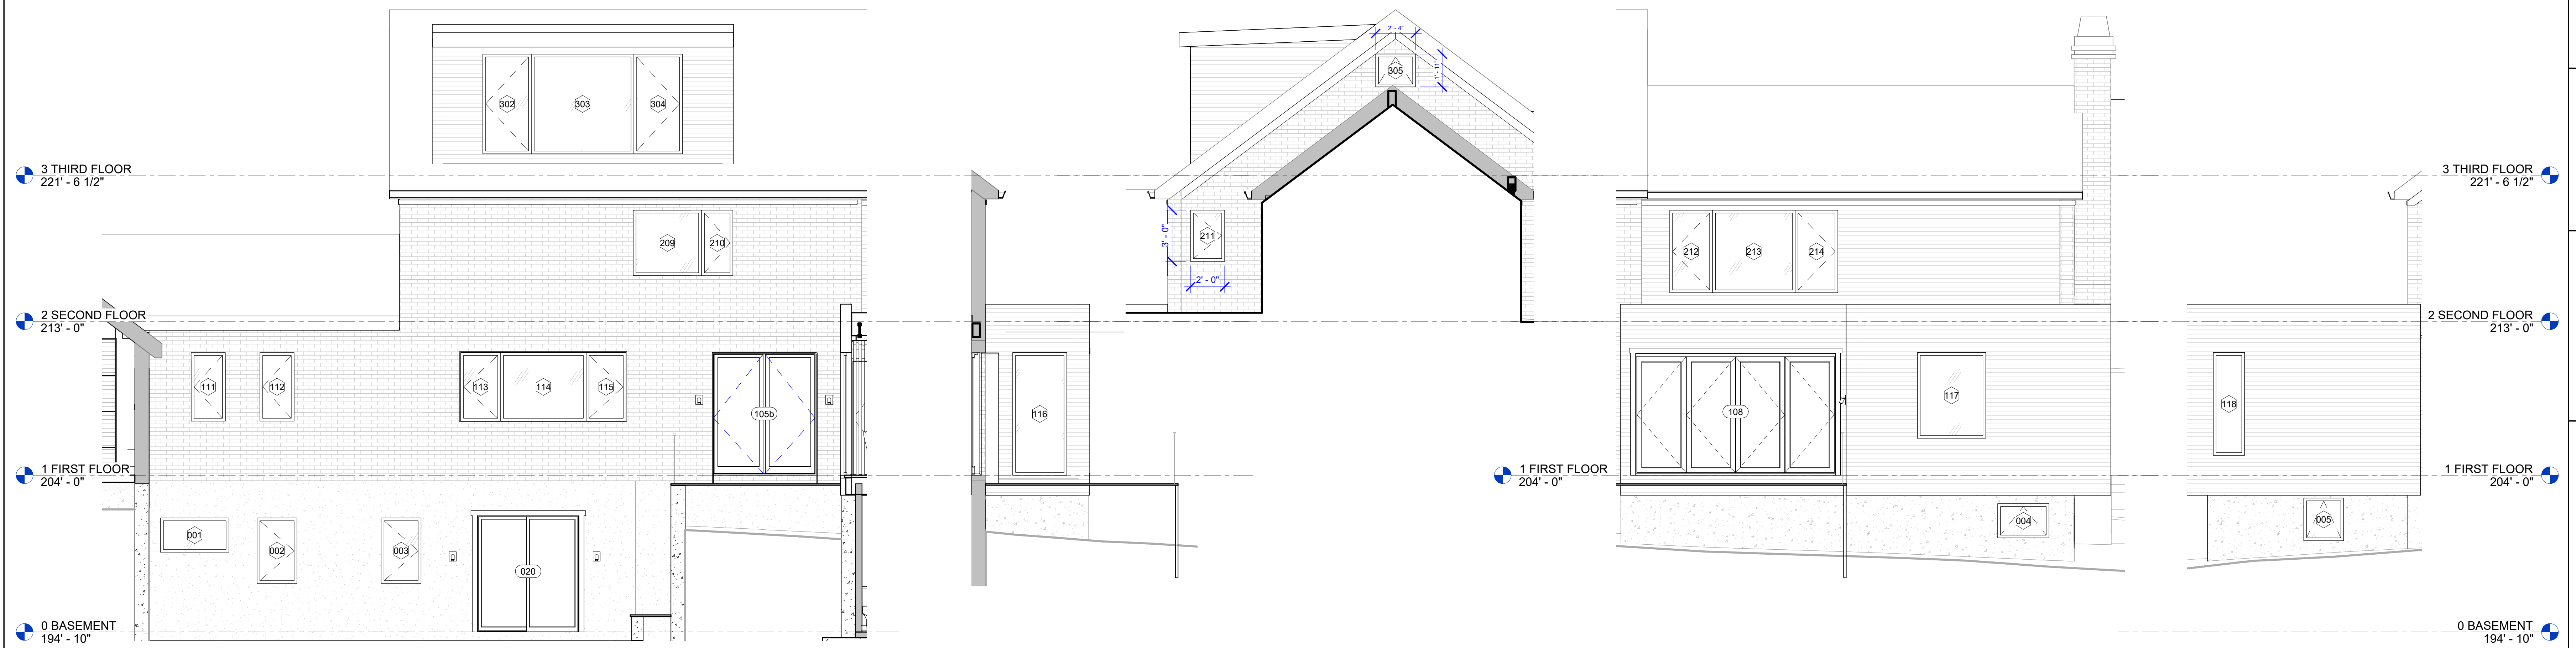

1 MAIN BUILDING - NORTH ELEVATION
 1/4" = 1'-0"

2 MAIN BUILDING - EAST ELEVATION (LIVING)
 1/4" = 1'-0"

3 MAIN BUILDING - WEST ELEVATION (BATH)
 1/4" = 1'-0"

4 MAIN BUILDING - NORTH ELEVATION - WEST
 1/4" = 1'-0"

5 MAIN BUILDING - WEST ELEVATION NORTH
 1/4" = 1'-0"

REVISION HISTORY		
NO.	DESCRIPTION	DATE

PERMIT REVISION

DATE:	AUG 18, 2023
SCALE:	1/4" = 1'-0"
DRAWN BY:	CJ
CHECKED BY:	CR

SHEET TITLE	PROJECT #
ENLARGED ELEVATIONS	40035

ENLARGED ELEVATIONS



WINDOW SCHEDULE ON SHEET							
LEVEL	MARK	OPERATION	DIMENSIONS			W. SCREEN	
			WIDTH	HEIGHT	AREA		
0							
0	001	FIXED	4'-0"	2'-0"	8 SF	No	
0	002	CASEMENT	2'-4"	3'-10"	9 SF	Yes	
0	003	CASEMENT	2'-4"	3'-10"	9 SF	Yes	
0	004	AWNING	3'-0"	2'-0"	6 SF	Yes	
0	005	AWNING	2'-4"	2'-6"	6 SF	Yes	
0	006	AWNING	2'-4"	2'-6"	6 SF	Yes	
0	007	AWNING	2'-4"	2'-6"	6 SF	Yes	
1							
1	100a	CASEMENT	2'-6"	5'-0"	13 SF	Yes	
1	100b	FIXED	2'-6"	5'-0"	13 SF	No	
1	100c	CASEMENT	2'-6"	5'-0"	13 SF	Yes	
1	101	FIXED	2'-4 1/2"	8'-2"	19 SF	No	
1	102a	CASEMENT	2'-6"	5'-0"	13 SF	Yes	
1	102b	FIXED	2'-6"	5'-0"	13 SF	No	
1	102c	CASEMENT	2'-6"	5'-0"	13 SF	Yes	
1	103	CASEMENT	3'-0"	4'-0"	12 SF	Yes	
1	104	FIXED	2'-10"	7'-2"	20 SF	No	
1	105	FIXED	2'-10"	7'-2"	20 SF	No	
1	106	FIXED	2'-10"	7'-2"	20 SF	No	
1	107	FIXED	2'-10"	7'-2"	20 SF	No	
1	108	FIXED	2'-6"	2'-6"	6 SF	No	
1	109	FIXED	3'-0"	4'-0"	12 SF	No	
1	110	FIXED	2'-6"	2'-6"	6 SF	No	
1	111	CASEMENT	2'-0"	4'-0"	8 SF	Yes	
1	112	CASEMENT	2'-0"	4'-0"	8 SF	Yes	
1	113	CASEMENT	2'-4"	4'-0"	9 SF	Yes	
1	114	FIXED	5'-0"	4'-0"	20 SF	No	
1	115	CASEMENT	2'-4"	4'-0"	9 SF	Yes	
1	116	FIXED	3'-2"	7'-2"	23 SF	No	
1	117	FIXED	4'-0"	5'-0"	20 SF	No	
1	118	FIXED	1'-10"	6'-0"	11 SF	No	
1	119	FIXED	1'-10"	6'-0"	11 SF	No	
1	120	FIXED	1'-10"	6'-0"	11 SF	No	

- NOTES:**
1. WINDOW WIDTH AND HEIGHT GIVEN ARE APPROXIMATE SASH SIZES FOR PRICING
2. WINDOW MANUFACTURER TO PROVIDE THIRD PARTY ENGINEERING
3. EGRESS WINDOWS TO HAVE OPENING CONTROL DEVICE IN COMPLIANCE WITH ASTM F 2090

SPEC: BASIS OF DESIGN:
MANUFACTURER: MARVIN
PRODUCT LINE: ELEVATE
GLAZING: DOUBLE GLAZED, LOW IRON GLASS
FINISH: TO BE DETERMINED
EXTERIOR COLOR: BLACK (PROVIDE SUBMITTAL)
INTERIOR COLOR: PRIMED FOR PAINT

DOOR SCHEDULE - EXTERIOR							
Level	MARK	LOCATION		DOOR		PANEL TYPE	COMMENTS
		FROM ROOM	TO ROOM	WIDTH	HEIGHT		
		ROOM NO.	ROOM NAME				
0 BASEMENT							
0 BASEMENT	020	020	IN-LAW SUITE	6'-0"	6'-10"	FG	DOUBLE SLIDING DOOR
1 FIRST FLOOR							
1 FIRST FLOOR	100a	101	MUDROOM	3'-0"	7'-0"	FG	
1 FIRST FLOOR	100b	100	GARAGE	3'-0"	7'-2"	FG	
1 FIRST FLOOR	101	101	MUDROOM	3'-0"	7'-0"	FG	
1 FIRST FLOOR	105a	105	ENTRY	3'-6"	8'-2"	FG	MAIN FRONT DOOR
1 FIRST FLOOR	105b	105	ENTRY	6'-1"	7'-2"	FG	
1 FIRST FLOOR	108	108	DINING ROOM	11'-9"	7'-2"	FG	BIFOLD DOOR

- NOTES:**
1. DOOR WIDTH AND HEIGHT GIVEN ARE APPROXIMATE SASH SIZES FOR PRICING
2. WINDOW MANUFACTURER TO PROVIDE THIRD PARTY ENGINEERING
3. EGRESS WINDOWS TO HAVE OPENING CONTROL DEVICE IN COMPLIANCE WITH ASTM F 2090

SPEC: BASIS OF DESIGN:
MANUFACTURER: MARVIN
PRODUCT LINE: ULTIMATE
GLAZING: DOUBLE GLAZED, LOW IRON GLASS
FINISH: TO BE DETERMINED
EXTERIOR COLOR: BLACK (PROVIDE SUBMITTAL)
INTERIOR COLOR: PRIMED FOR PAINT
HARDWARE: TO BE DETERMINED

WINDOW SCHEDULE ON SHEET							
LEVEL	MARK	OPERATION	DIMENSIONS			W. SCREEN	
			WIDTH	HEIGHT	AREA		
2							
2	200a	CASEMENT	2'-6"	4'-0"	10 SF	Yes	
2	200b	FIXED	2'-6"	4'-0"	10 SF	No	
2	200c	CASEMENT	2'-6"	4'-0"	10 SF	Yes	
2	201	FIXED	2'-0"	7'-4"	15 SF	No	
2	202	FIXED	4'-0"	7'-4"	29 SF	No	
2	203	FIXED	2'-0"	2'-6"	5 SF	No	
2	204	FIXED	4'-0"	2'-6"	10 SF	No	
2	205a	CASEMENT	2'-6"	4'-0"	10 SF	Yes	
2	205b	FIXED	2'-6"	4'-0"	10 SF	No	
2	205c	CASEMENT	2'-6"	4'-0"	10 SF	Yes	
2	206	CASEMENT	3'-0"	4'-0"	12 SF	Yes	
2	207	AWNING	2'-5"	1'-6"	4 SF	No	
2	208	CASEMENT	2'-5"	2'-7"	6 SF	Yes	
2	209	FIXED	4'-0"	3'-10"	15 SF	No	
2	210	CASEMENT	1'-10"	3'-10"	7 SF	Yes	
2	211	CASEMENT	2'-0"	3'-0"	6 SF	Yes	
2	212	CASEMENT	2'-6"	4'-10"	12 SF	Yes	
2	213	FIXED	4'-10"	4'-10"	23 SF	No	
2	214	CASEMENT	2'-6"	4'-10"	12 SF	Yes	
2	215	CASEMENT	1'-10"	5'-0"	9 SF	Yes	
2	216	CASEMENT	1'-10"	5'-0"	9 SF	Yes	
3							
3	300	CASEMENT	3'-0"	2'-6"	8 SF	Yes	
3	301	FIXED	3'-0"	2'-6"	8 SF	No	
3	302	CASEMENT	2'-10"	5'-10"	17 SF	Yes	
3	303	FIXED	6'-0"	5'-10"	35 SF	No	
3	304	CASEMENT	2'-10"	5'-10"	17 SF	Yes	
3	305	AWNING	2'-4"	1'-11"	4 SF	Yes	



REVISION HISTORY		
NO.	DESCRIPTION	DATE

PERMIT REVISION


DATE: AUG 18, 2023
SCALE:
DRAWN BY: CJ
CHECKED BY: CR

SHEET TITLE: PROJECT #: 40035

EXTERIOR WINDOW & DOOR SCHEDULE

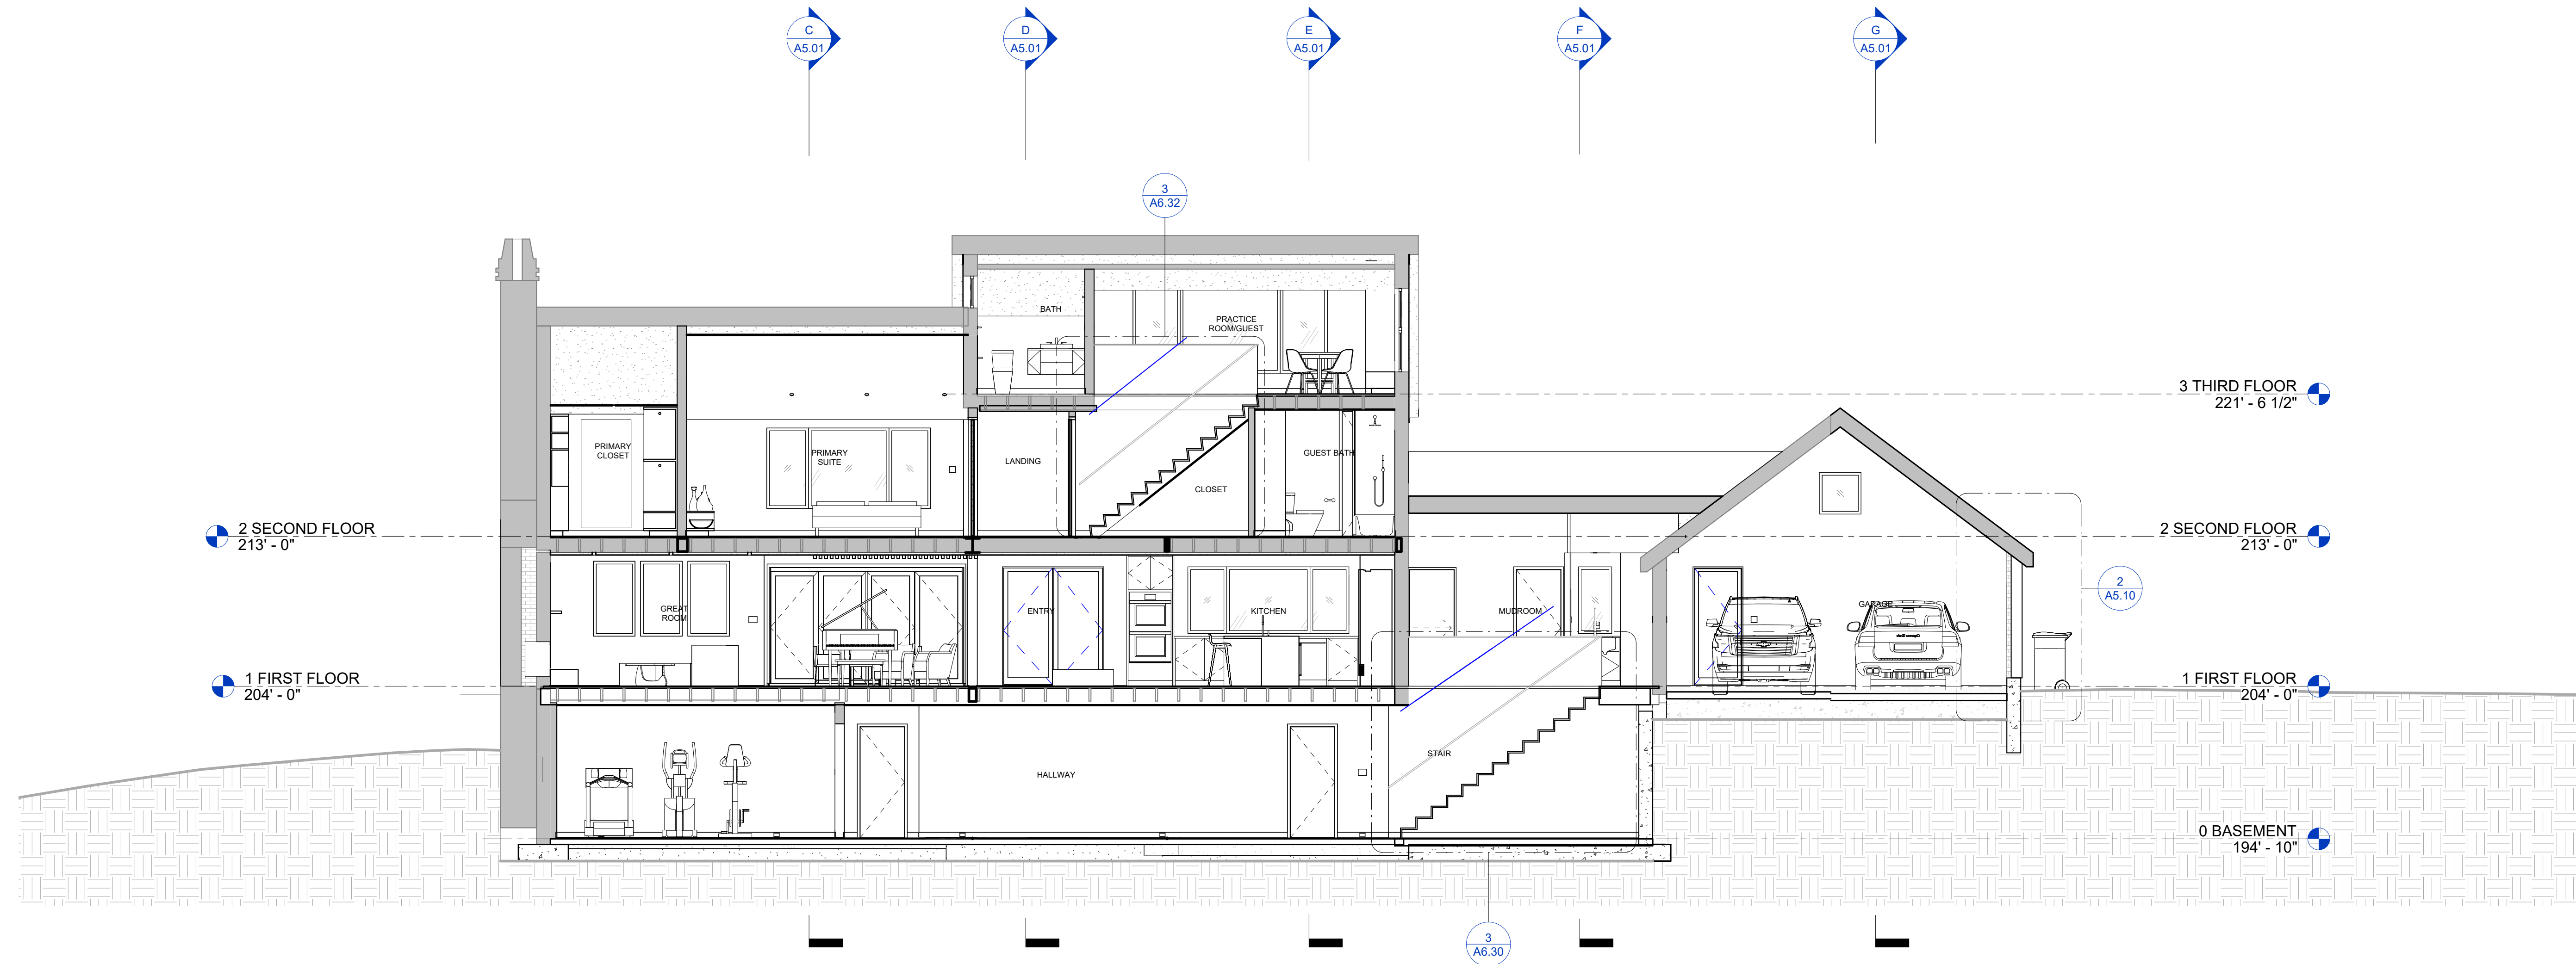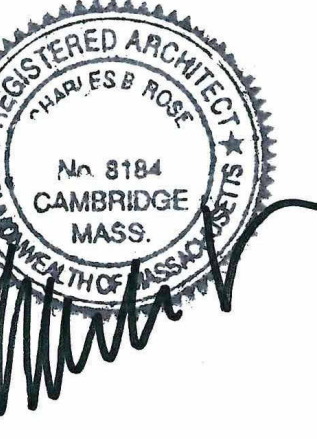

1 LONGITUDINAL SECTION 1
 3/16" = 1'-0"

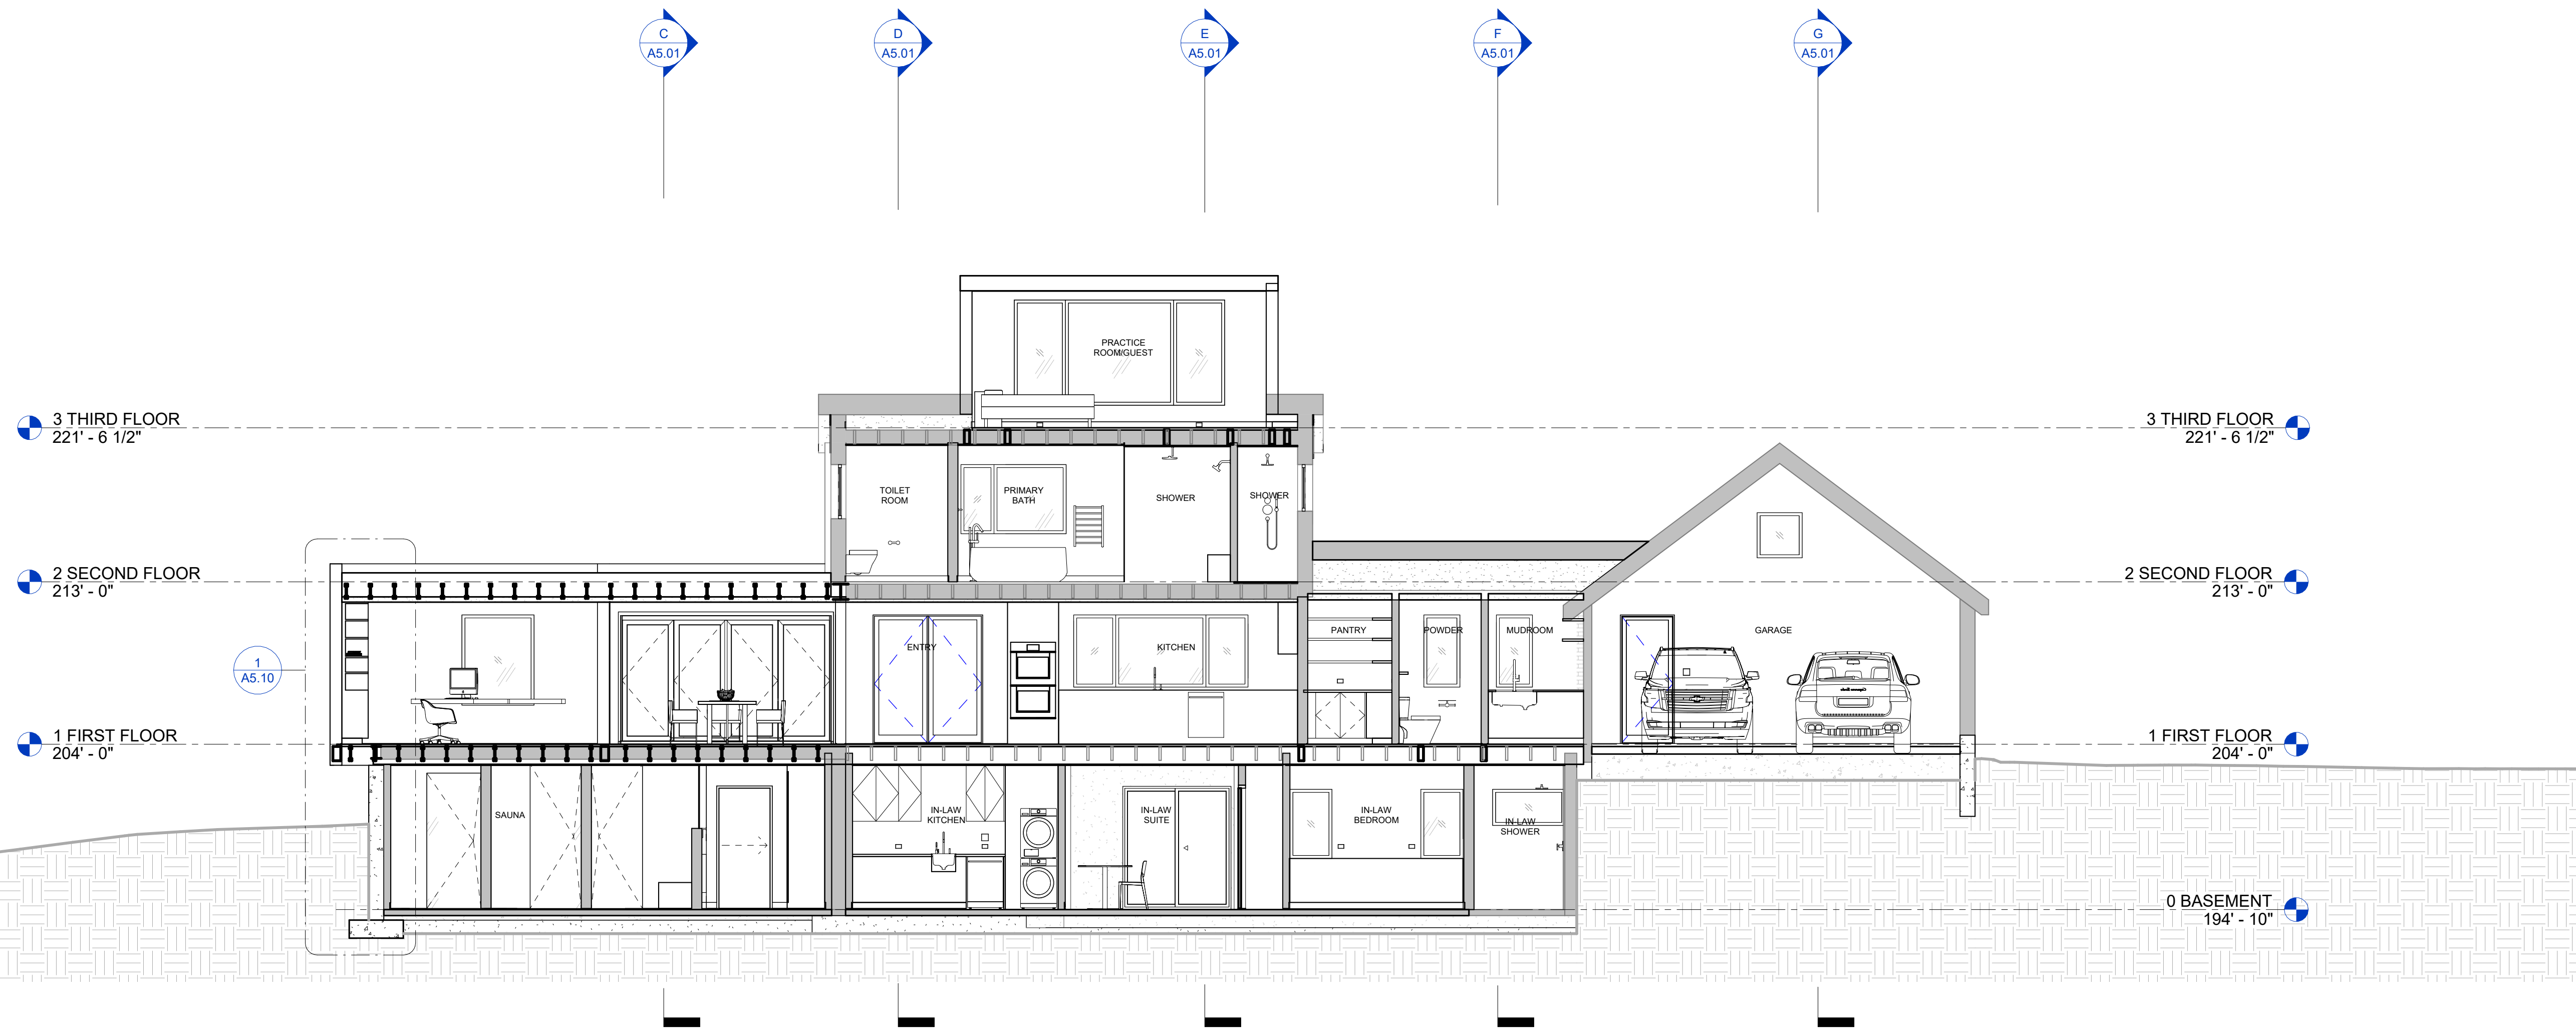

2 LONGITUDINAL SECTION 2
 3/16" = 1'-0"



REVISION HISTORY		
NO.	DESCRIPTION	DATE

PERMIT REVISION


DATE:	AUG 18, 2023
SCALE:	3/16" = 1'-0"
DRAWN BY:	CJ
CHECKED BY:	CR

SHEET TITLE	PROJECT #
	40035


BUILDING SECTIONS

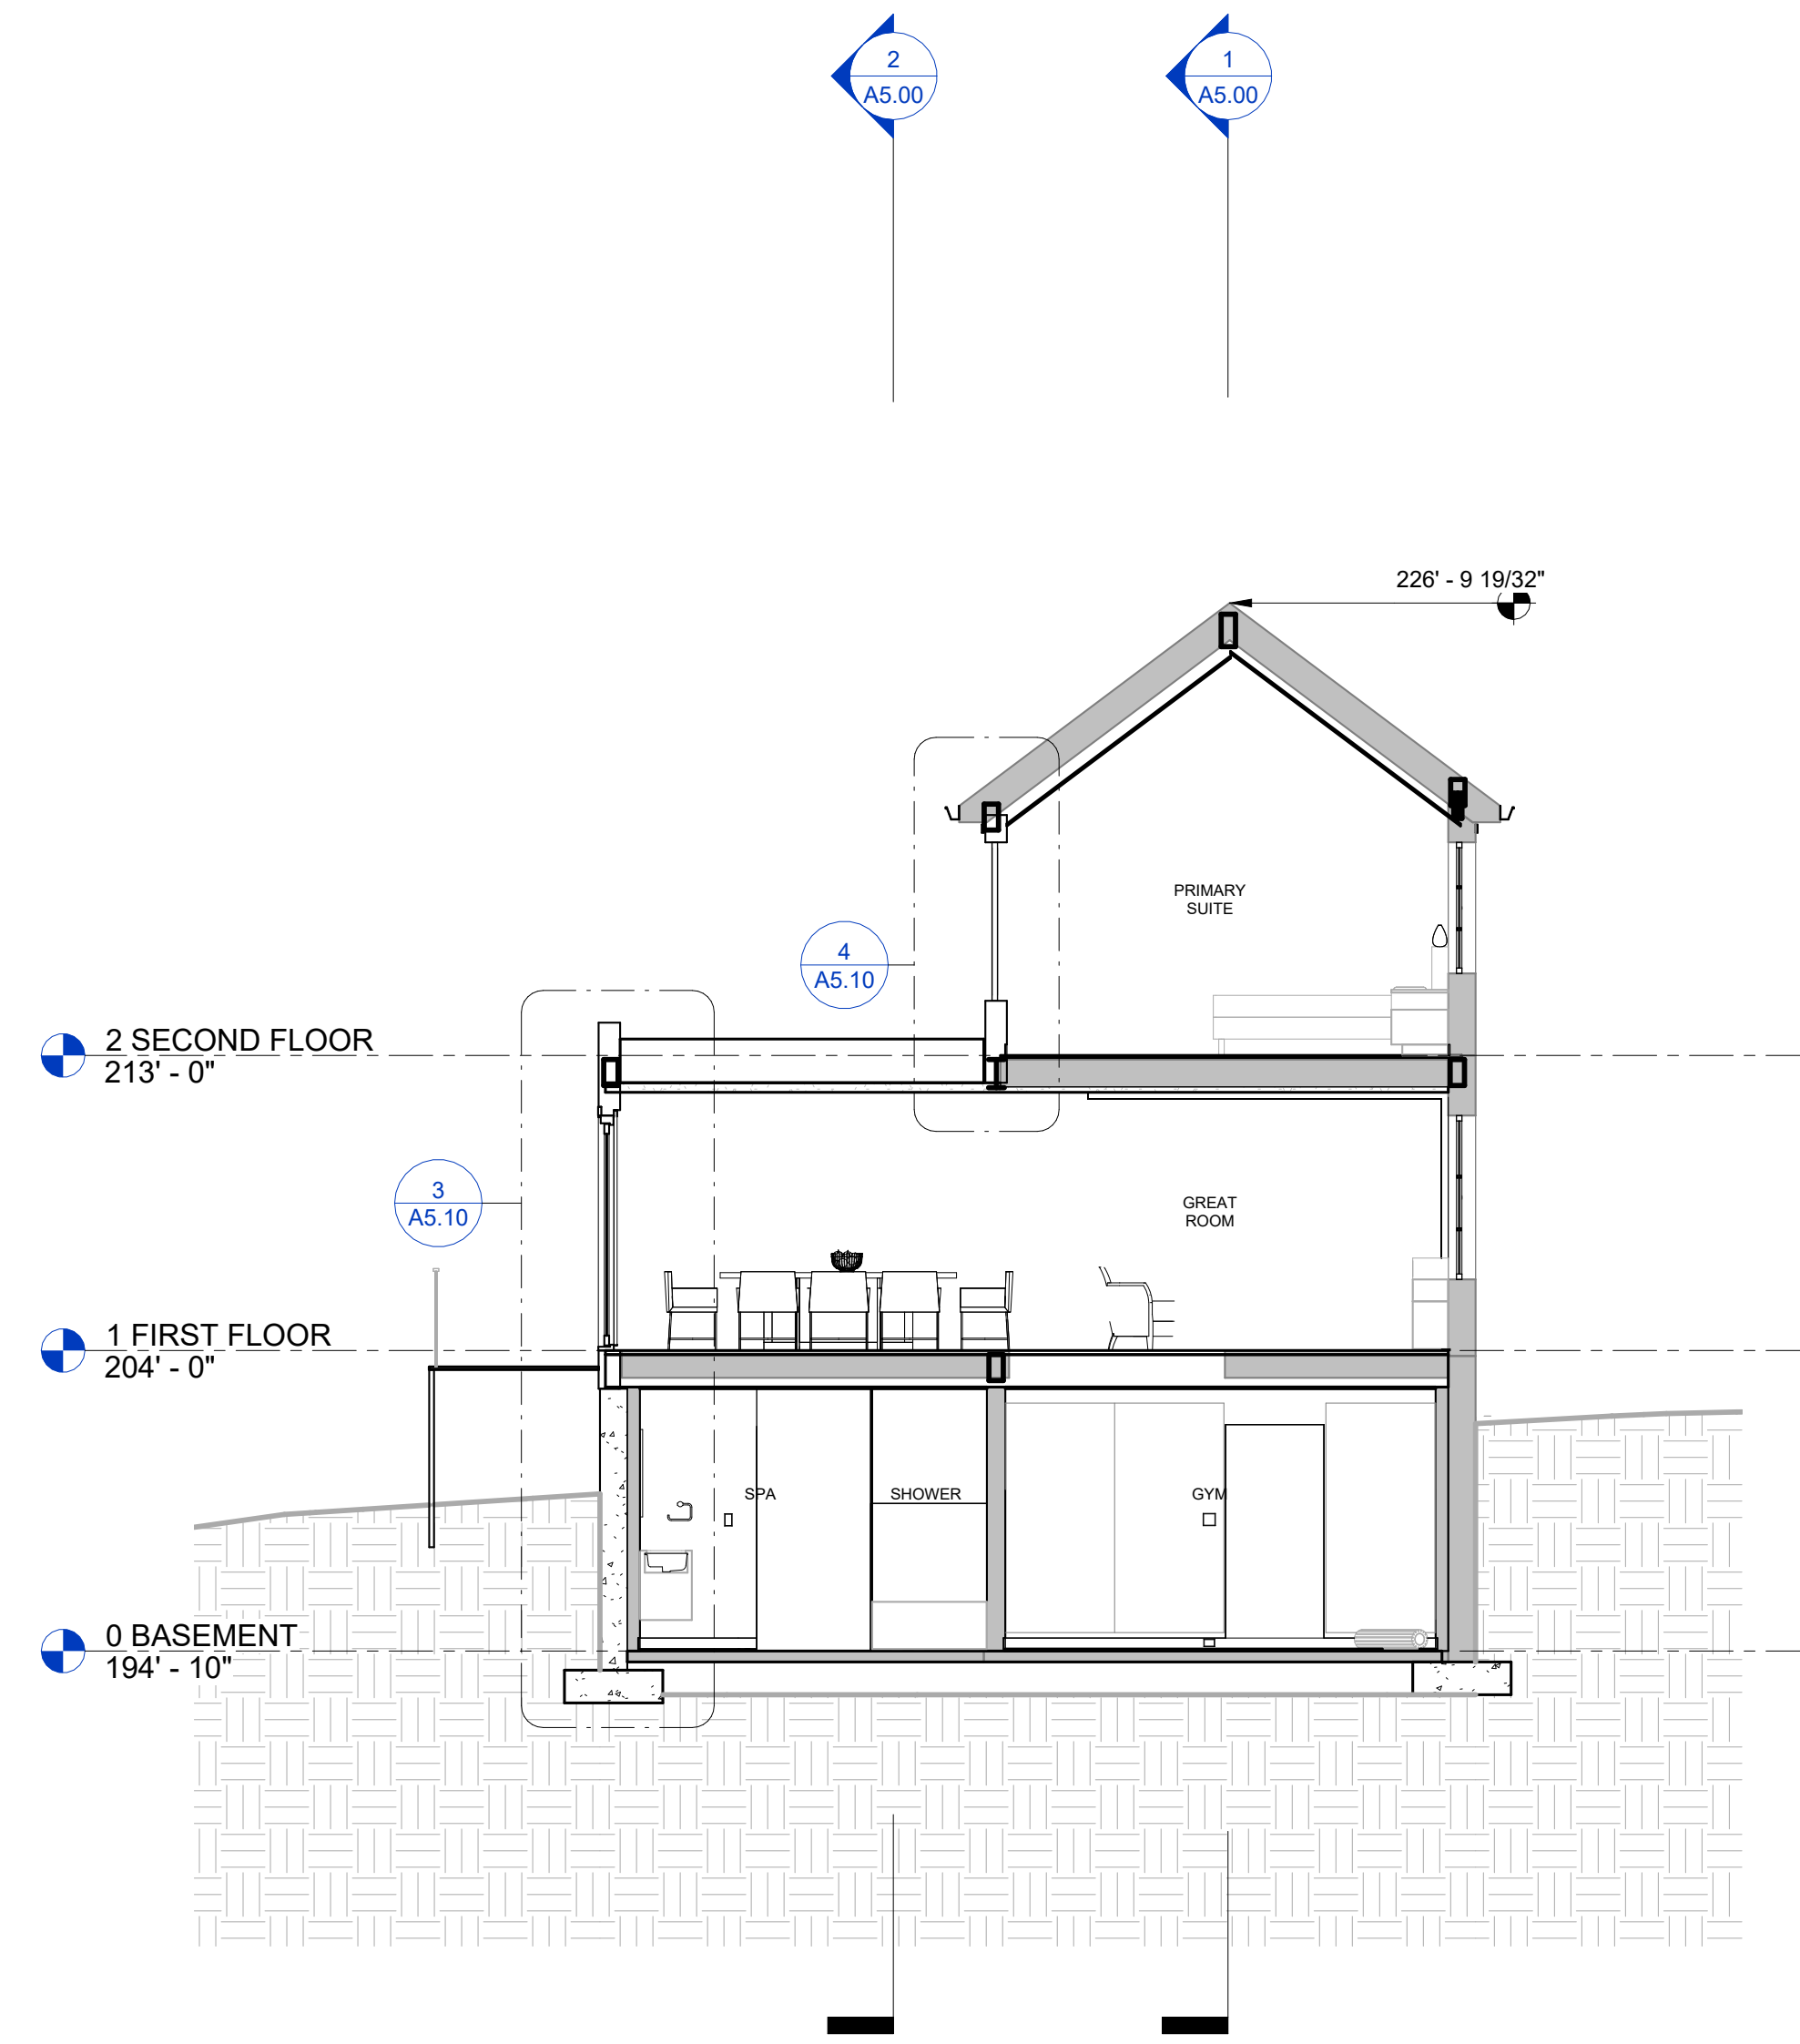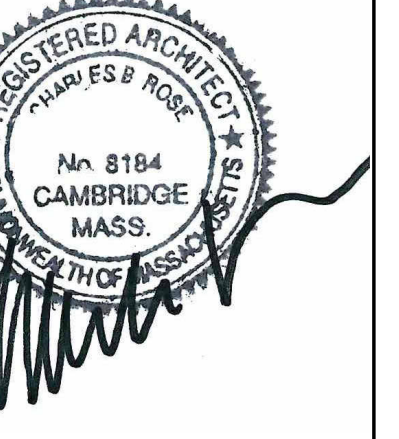


C TRANSVERSE SECTION C
 3/16" = 1'-0"

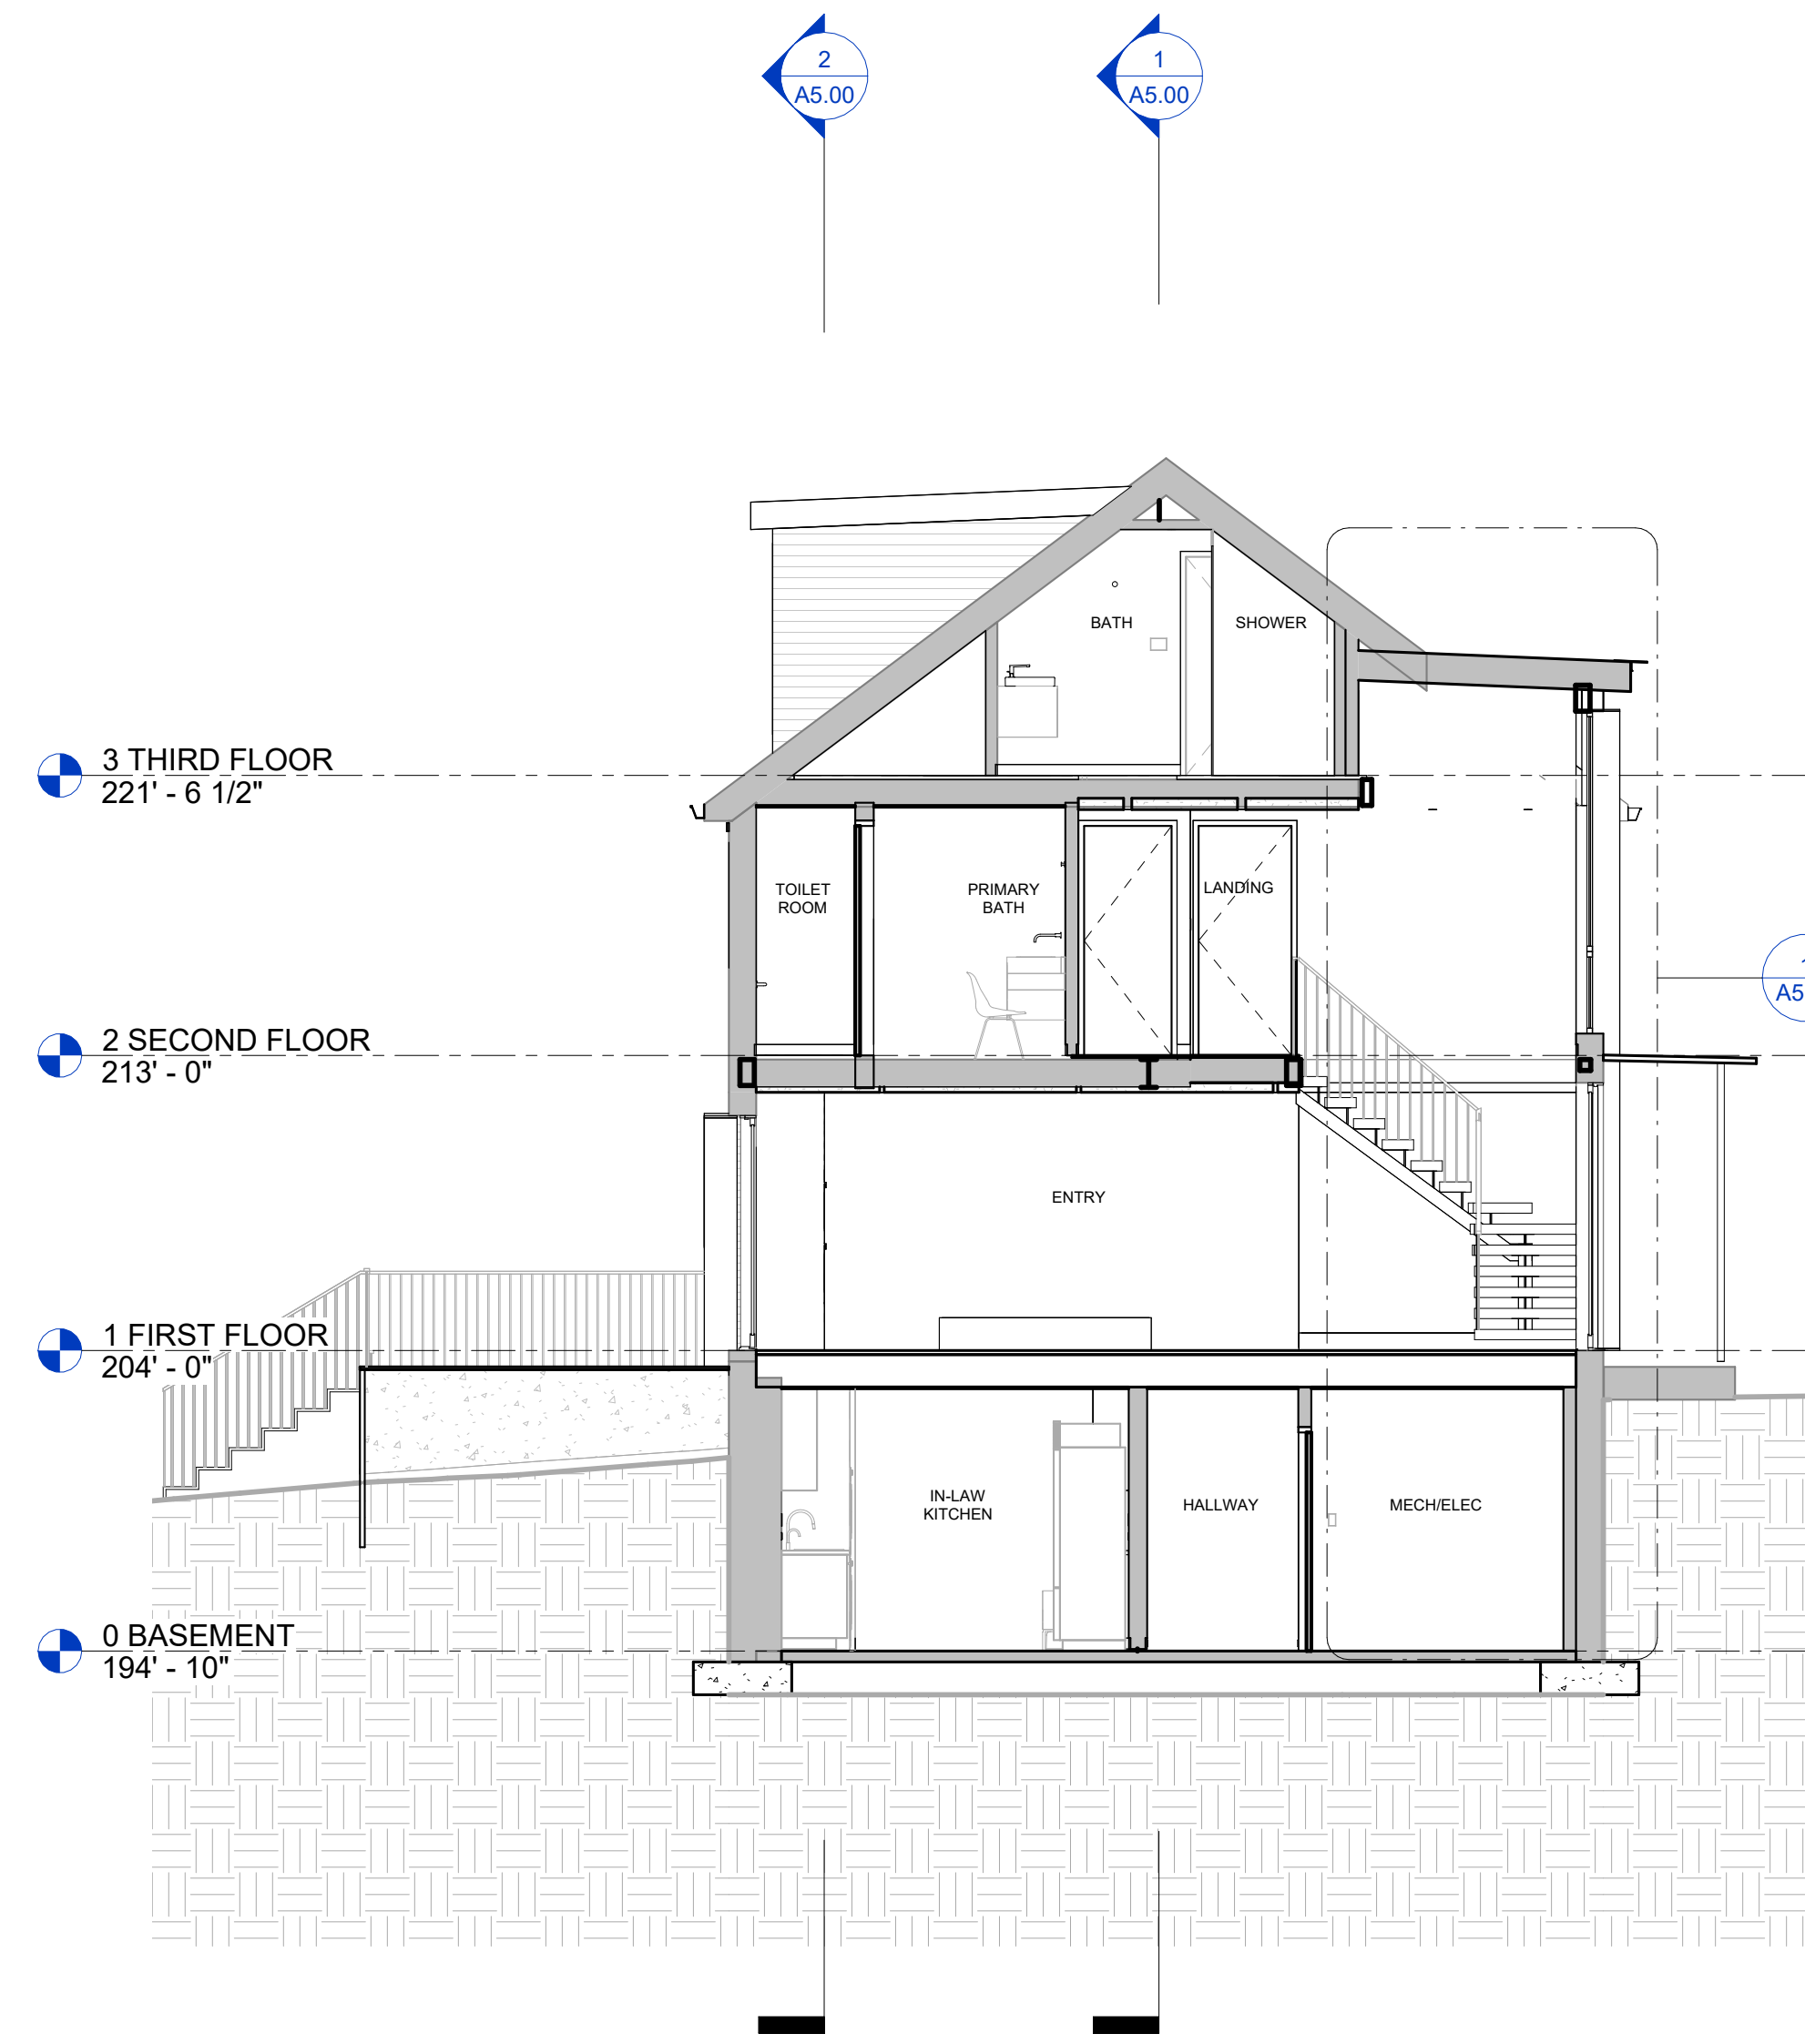


D TRANSVERSE SECTION D
 3/16" = 1'-0"

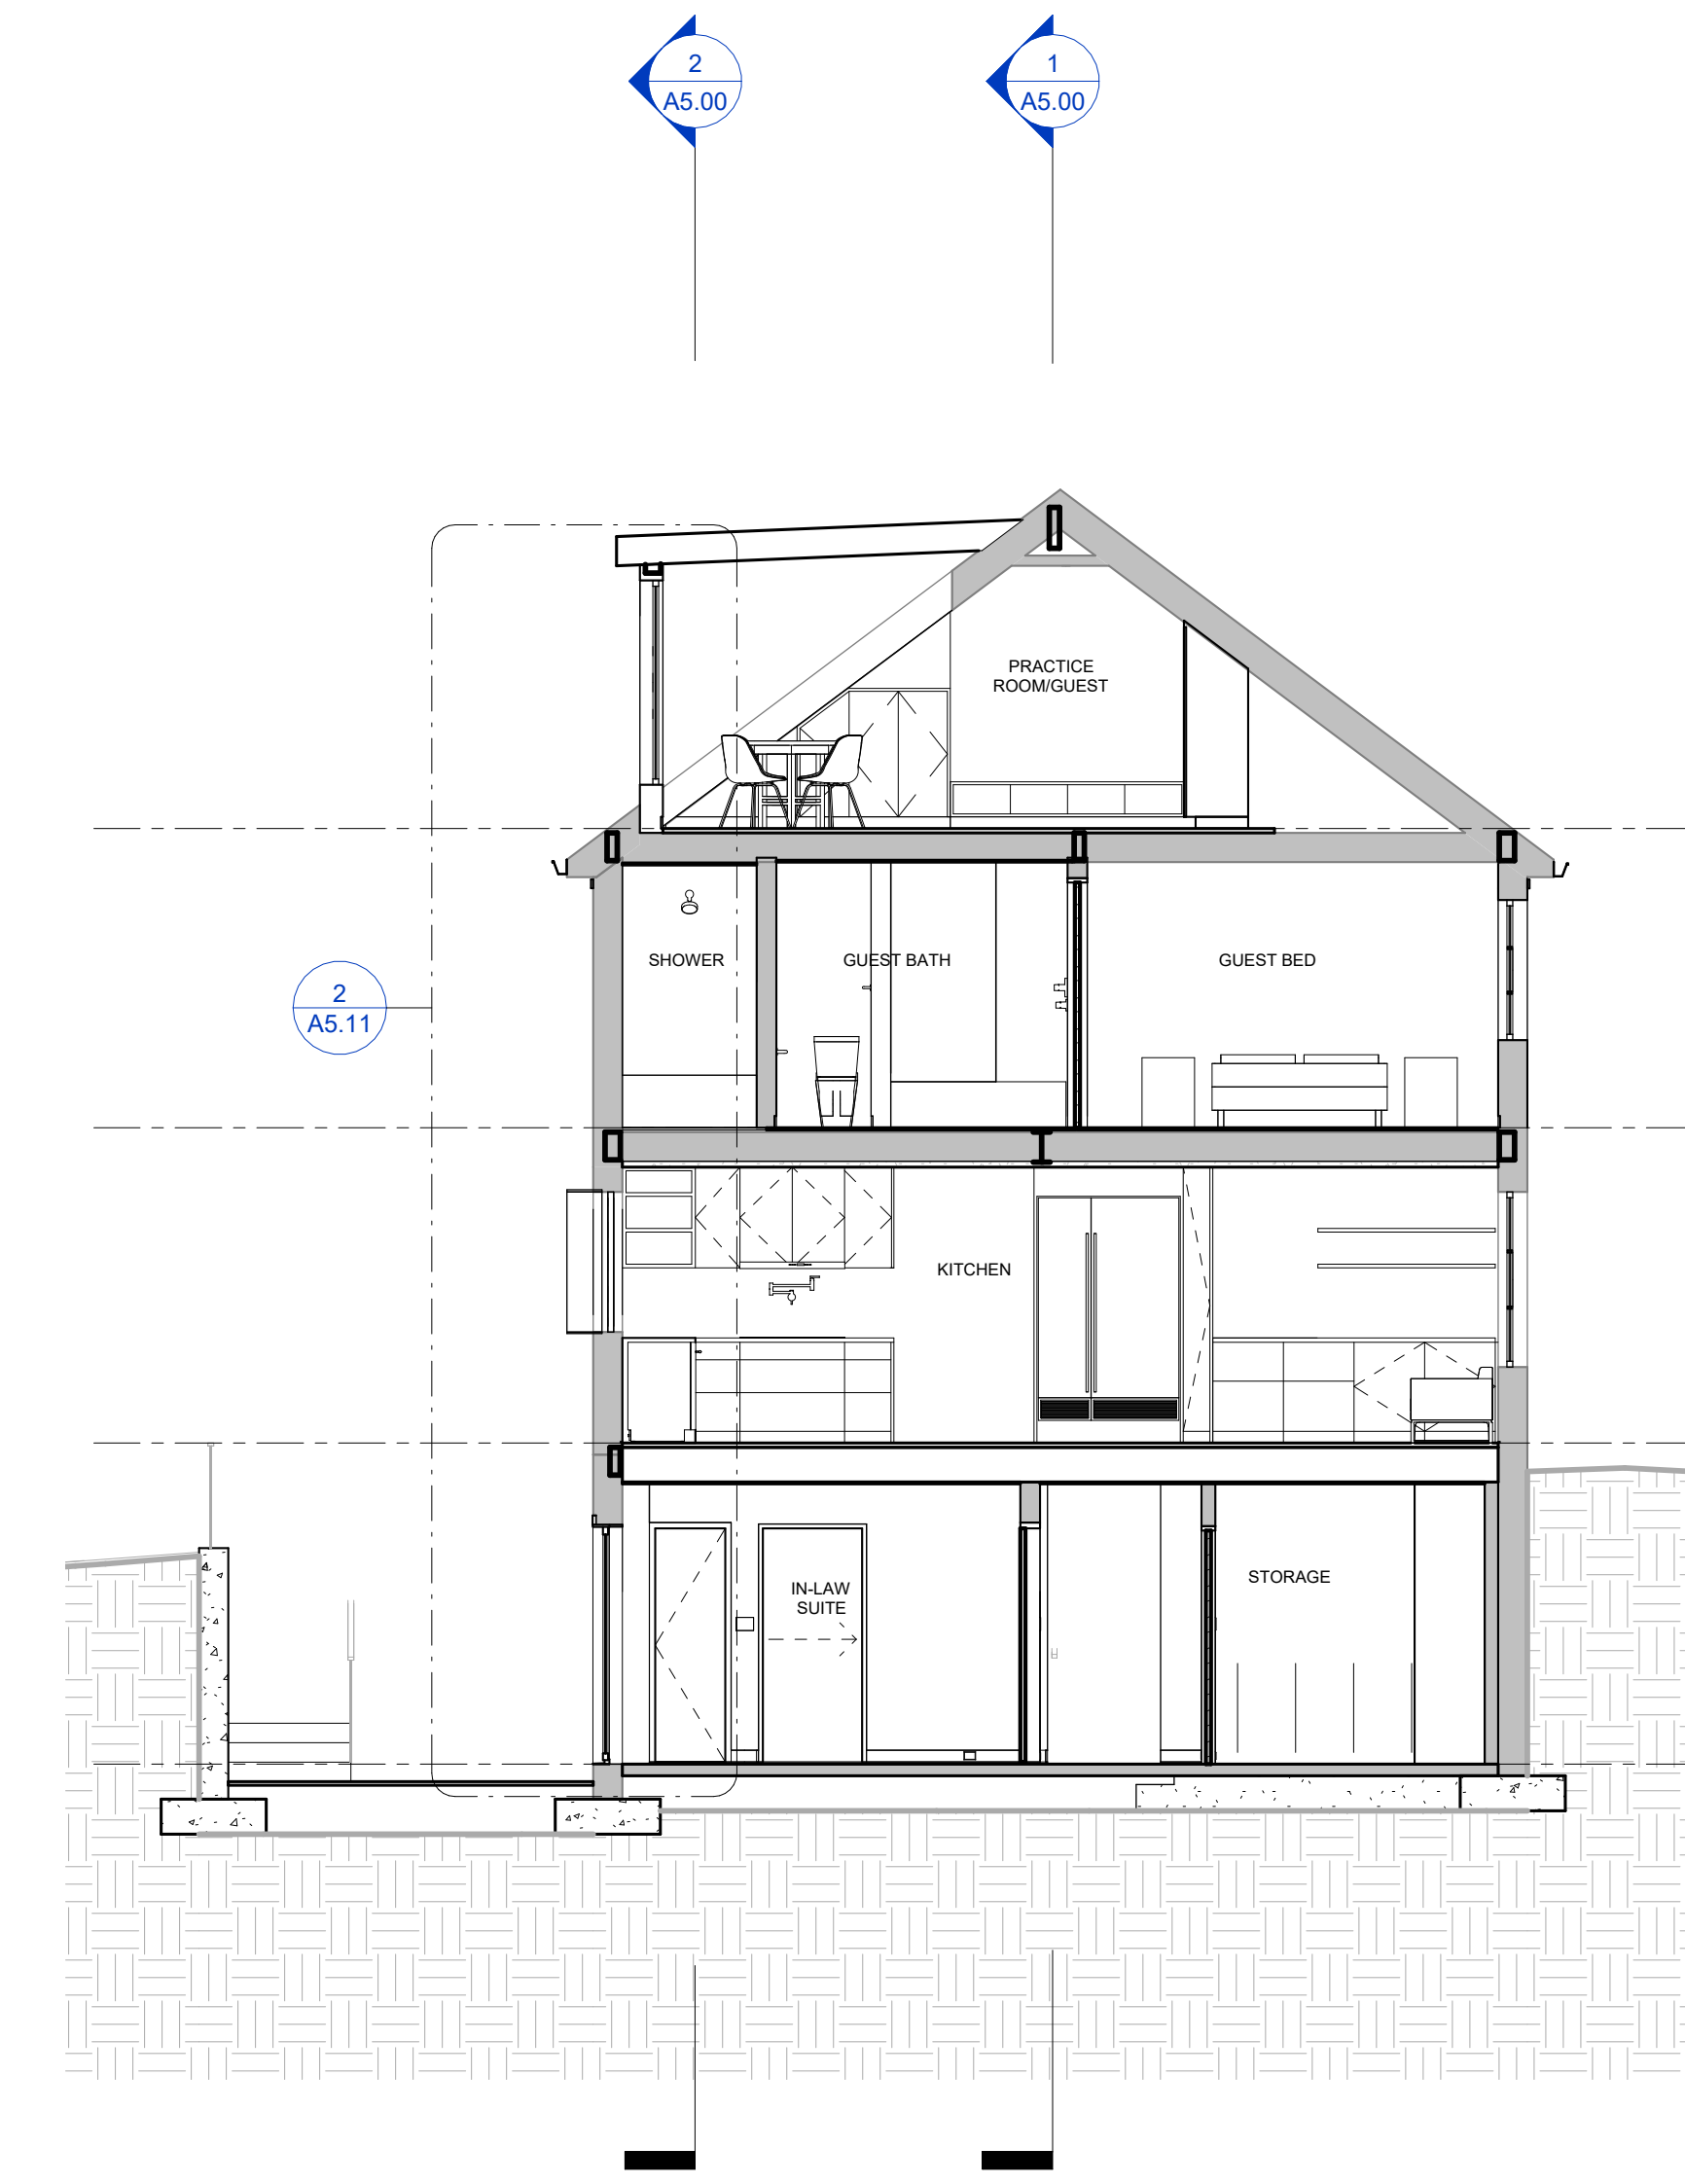

E TRANSVERSE SECTION E
 3/16" = 1'-0"

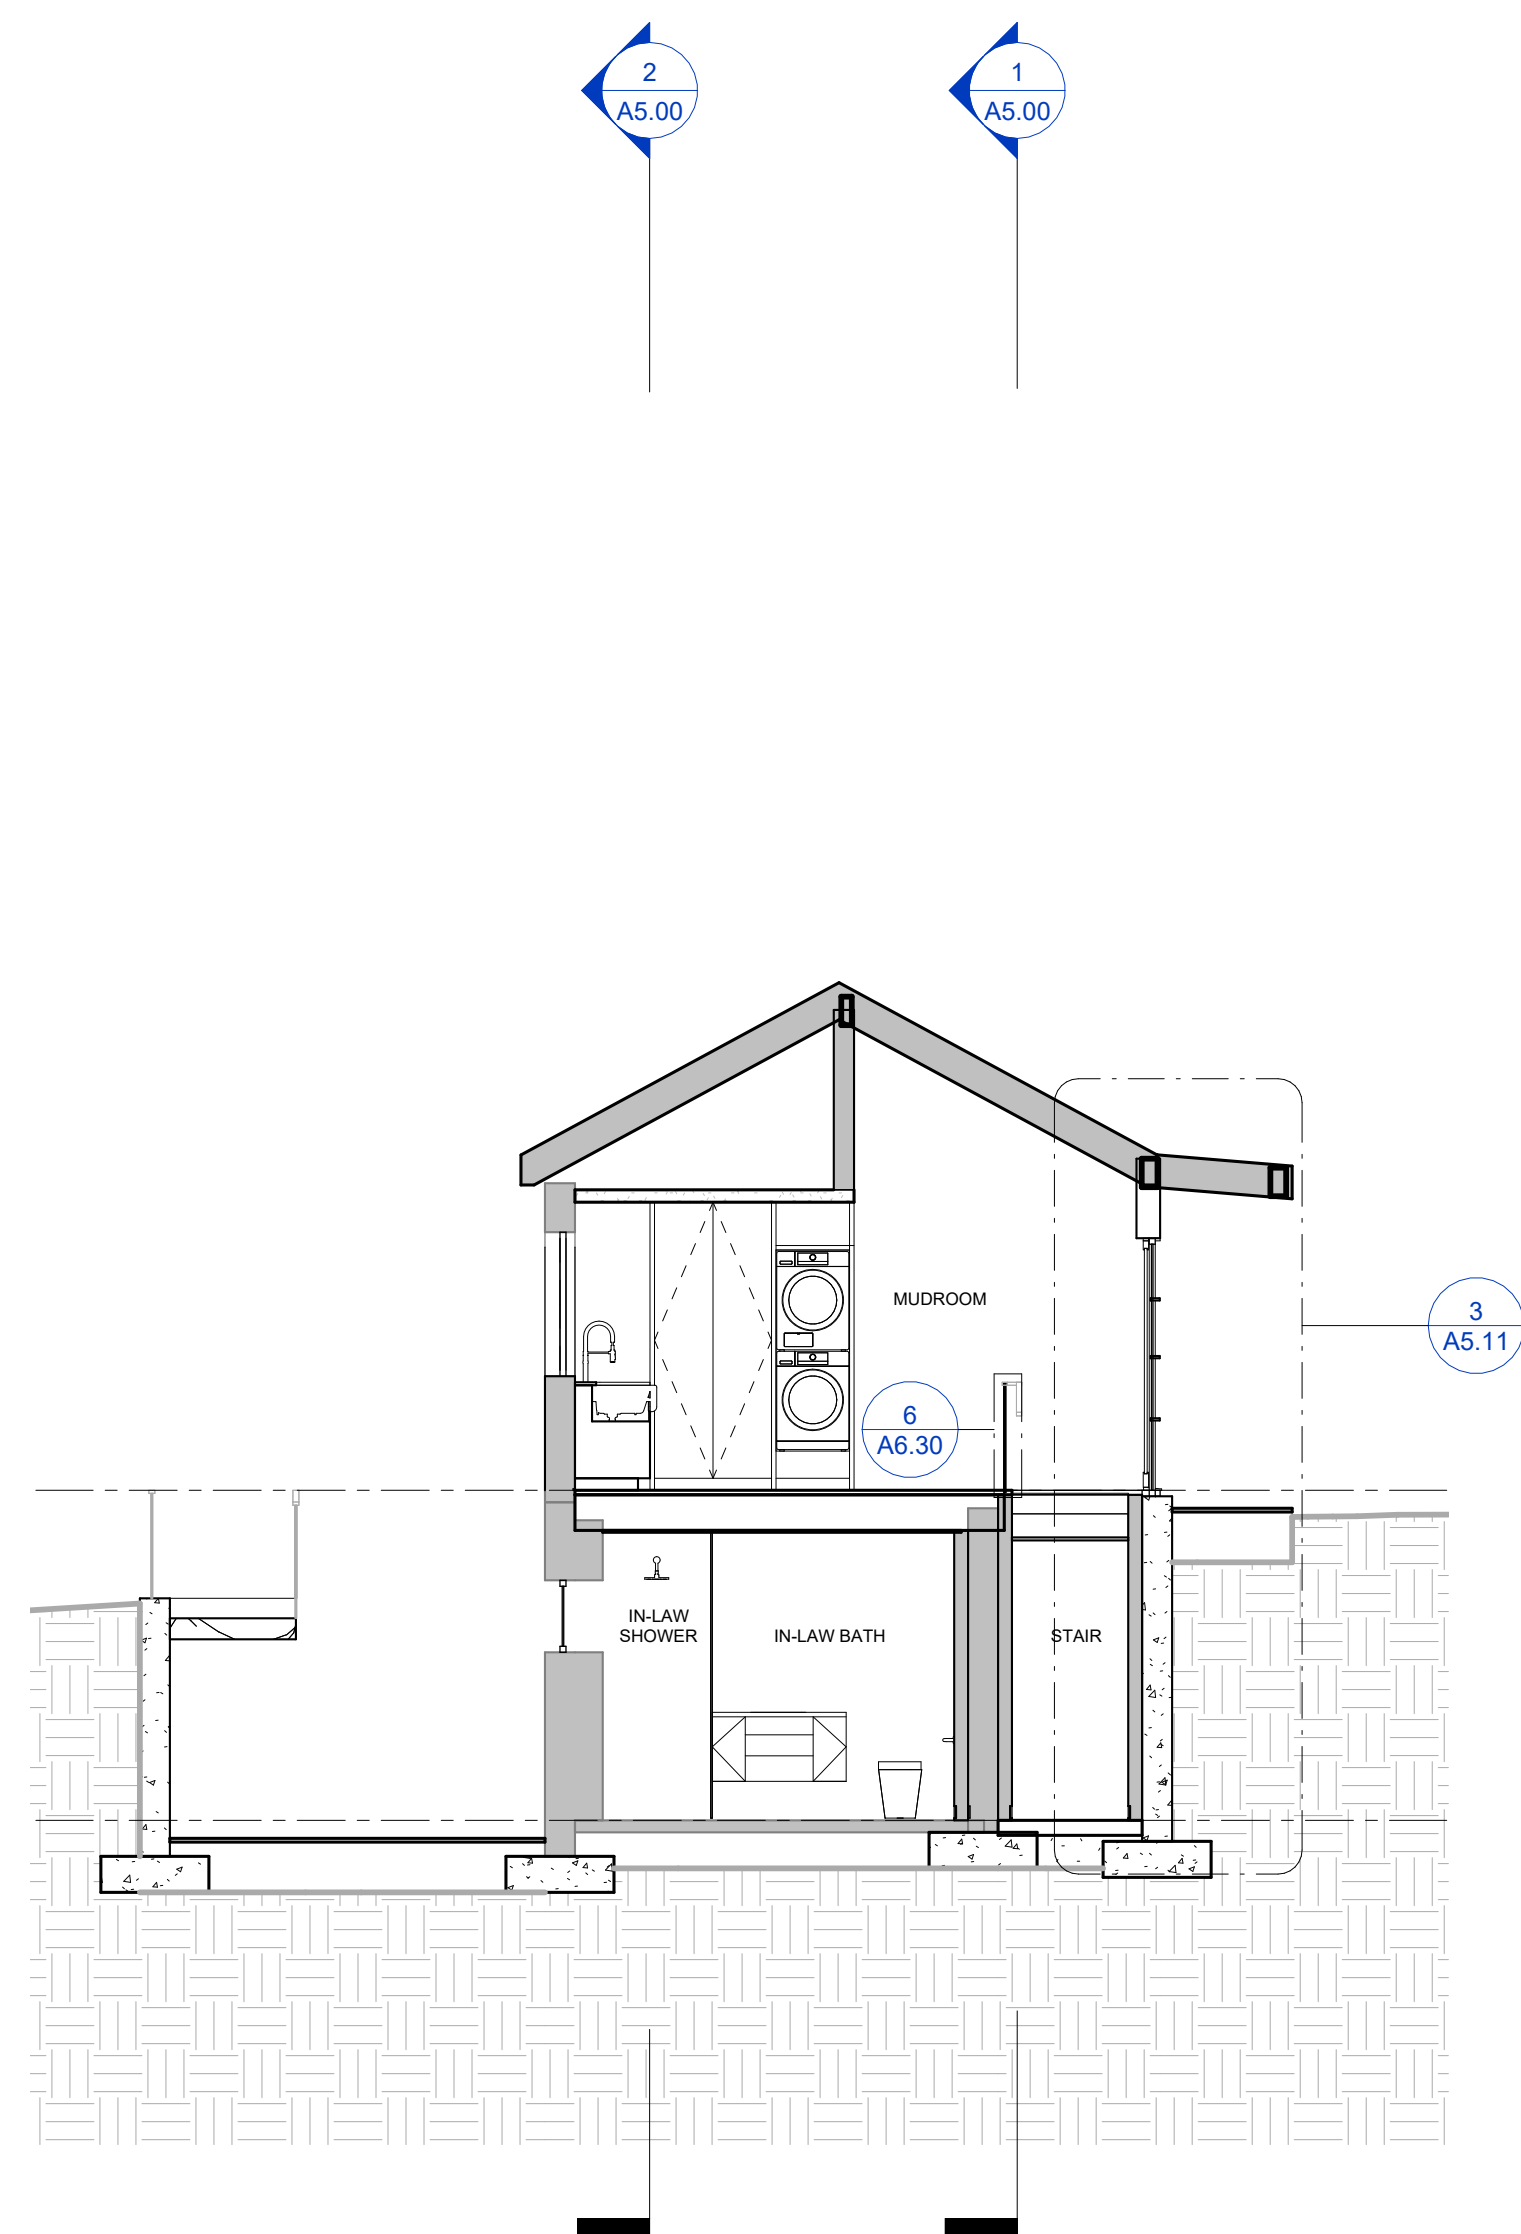

F TRANSVERSE SECTION F
 3/16" = 1'-0"

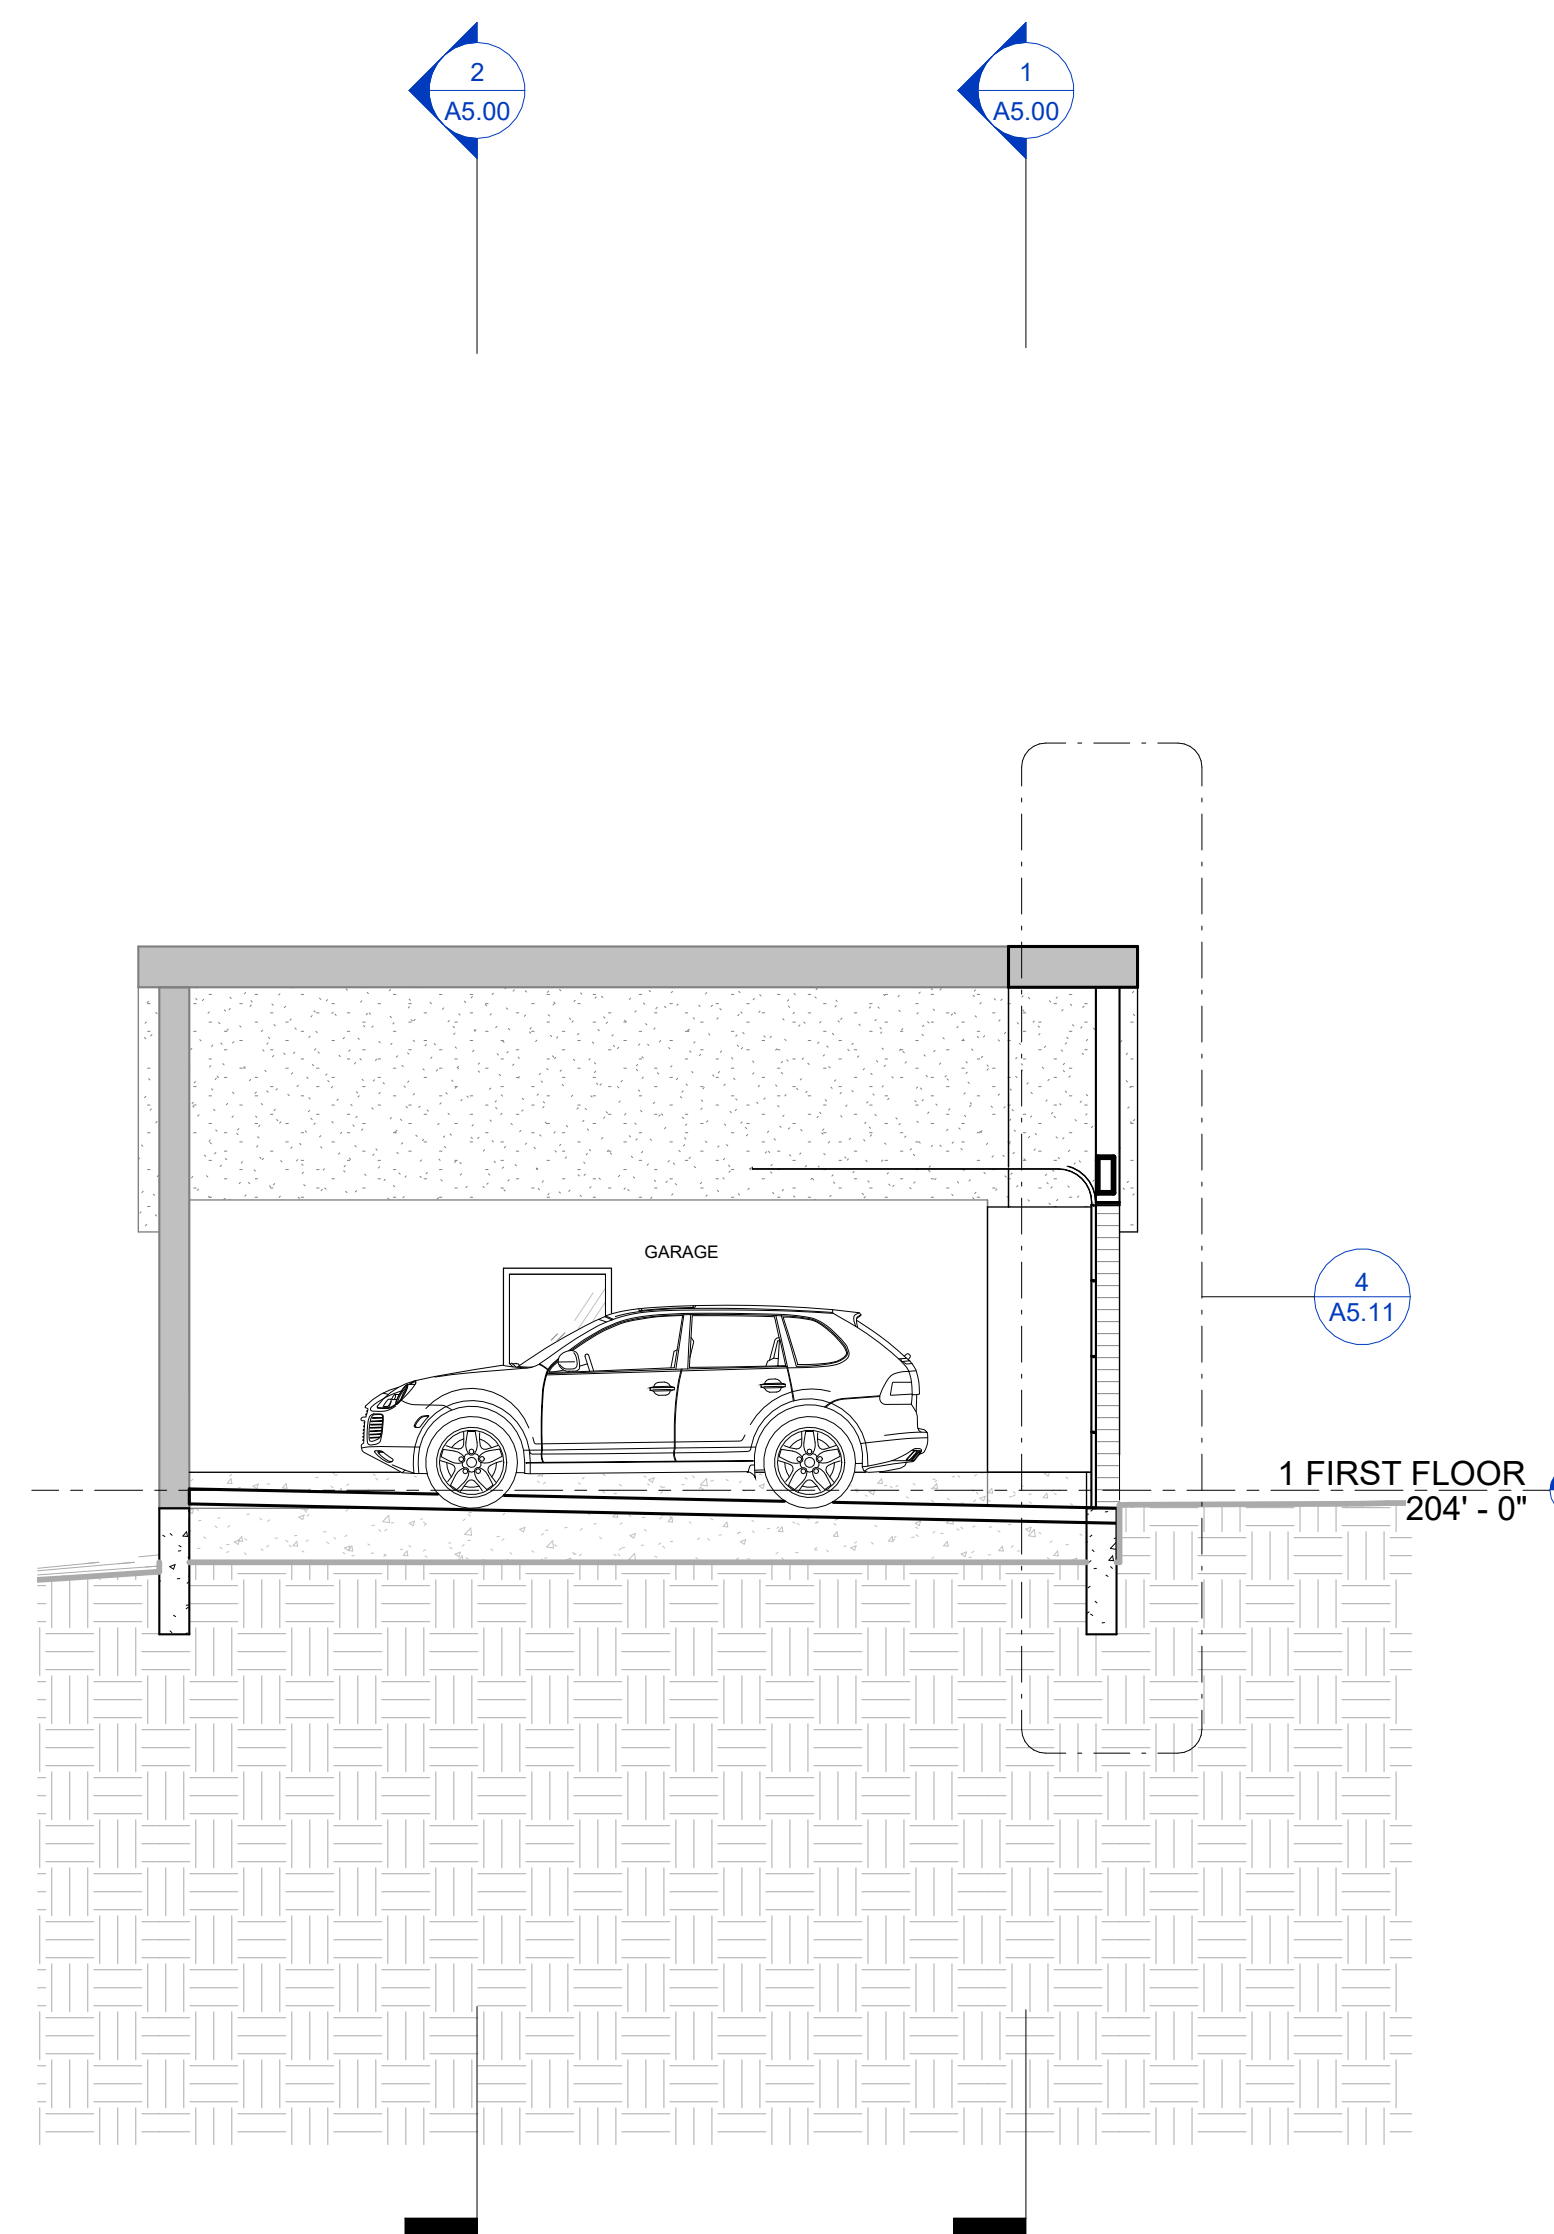


G TRANSVERSE SECTION G
 3/16" = 1'-0"

REVISION HISTORY		
NO.	DESCRIPTION	DATE


PERMIT REVISION

DATE:	AUG 18, 2023
SCALE:	3/16" = 1'-0"
DRAWN BY:	CJ
CHECKED BY:	CR


SHEET TITLE	PROJECT #
BUILDING SECTIONS	40035

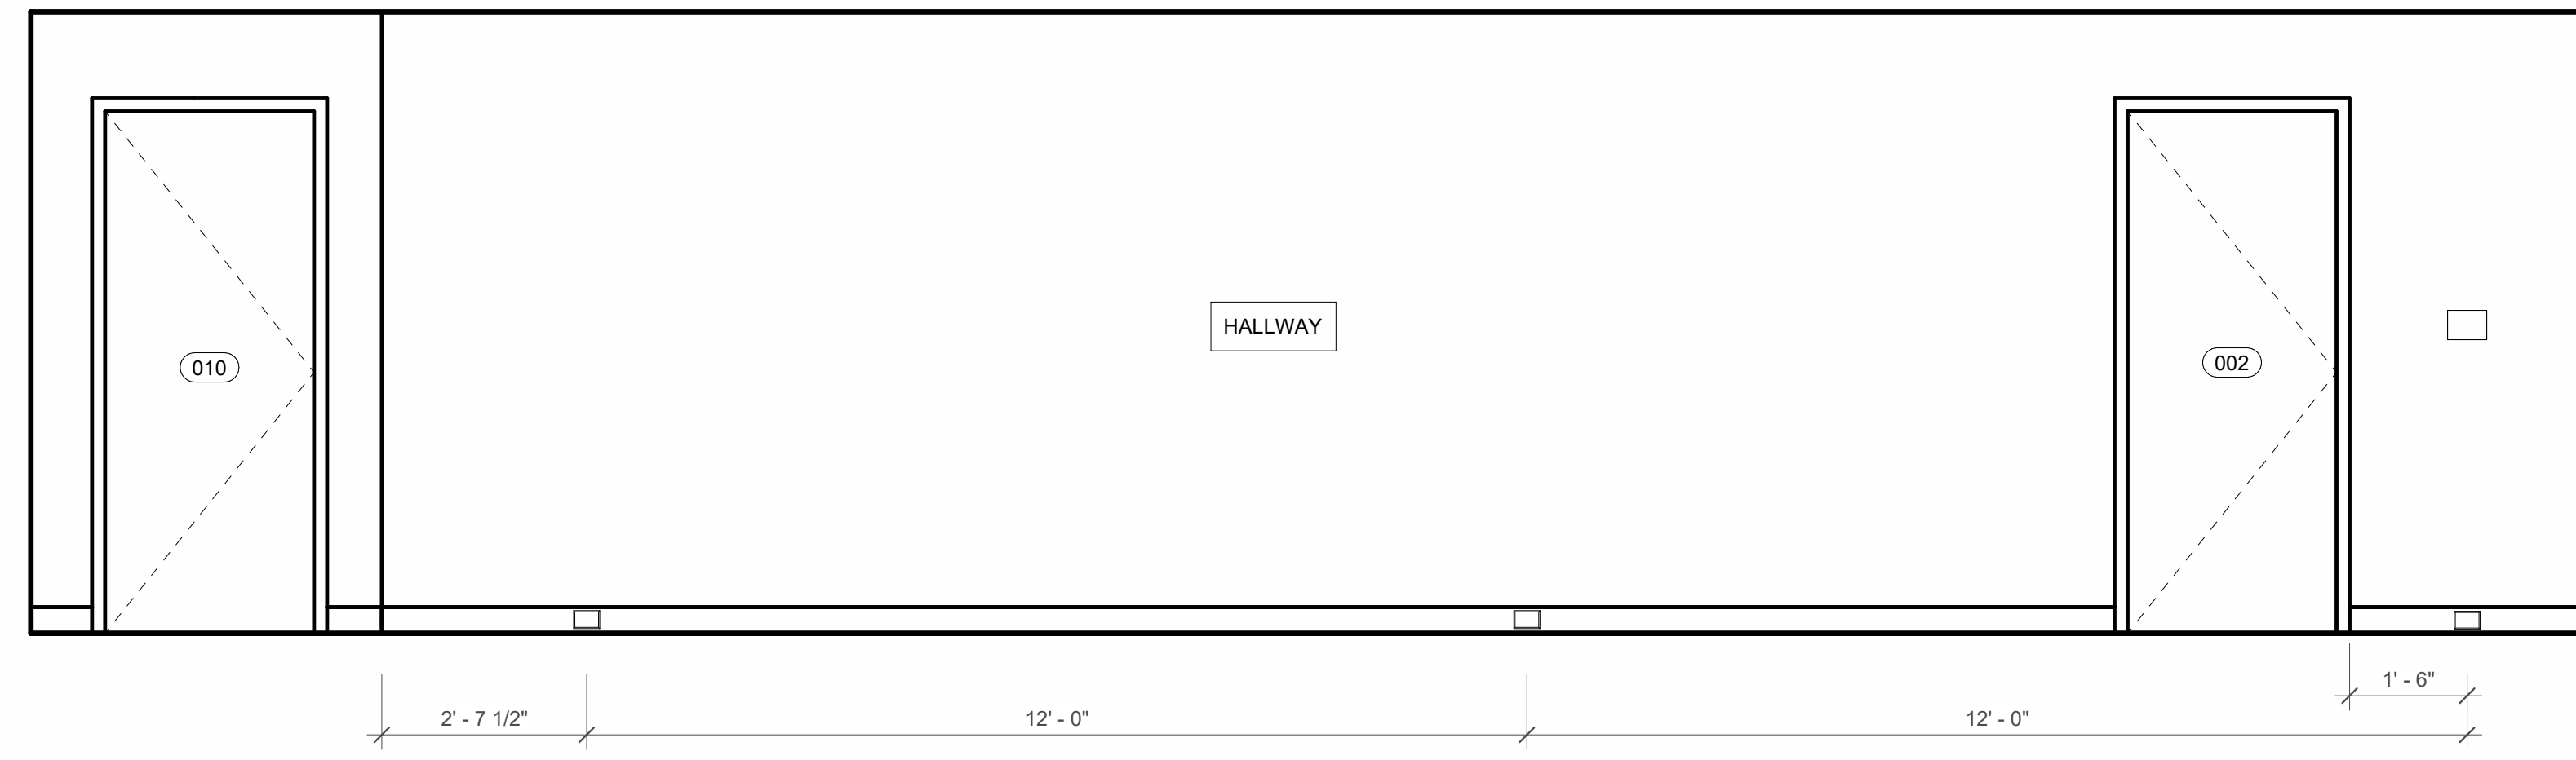


1 002 LOWER LEVEL HALL - NORTH
 1/2" = 1'-0"

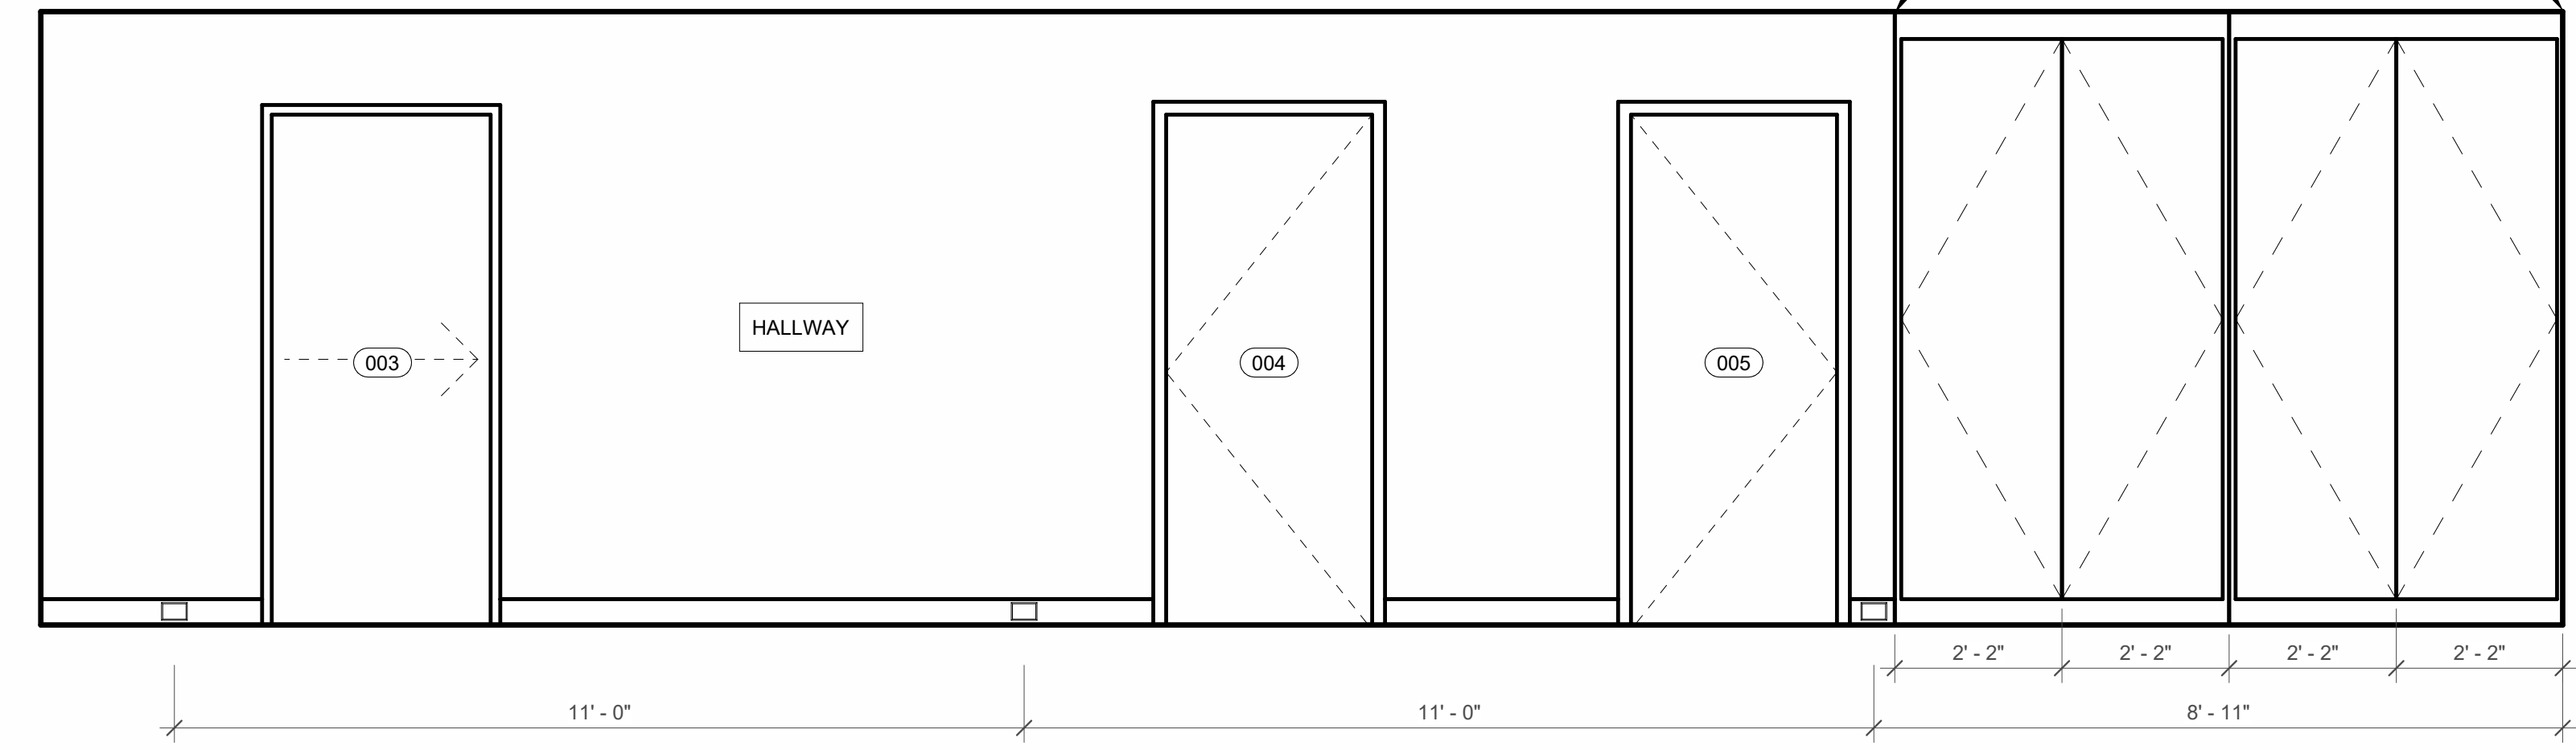


2 002 LOWER LEVEL HALL - SOUTH
 1/2" = 1'-0"

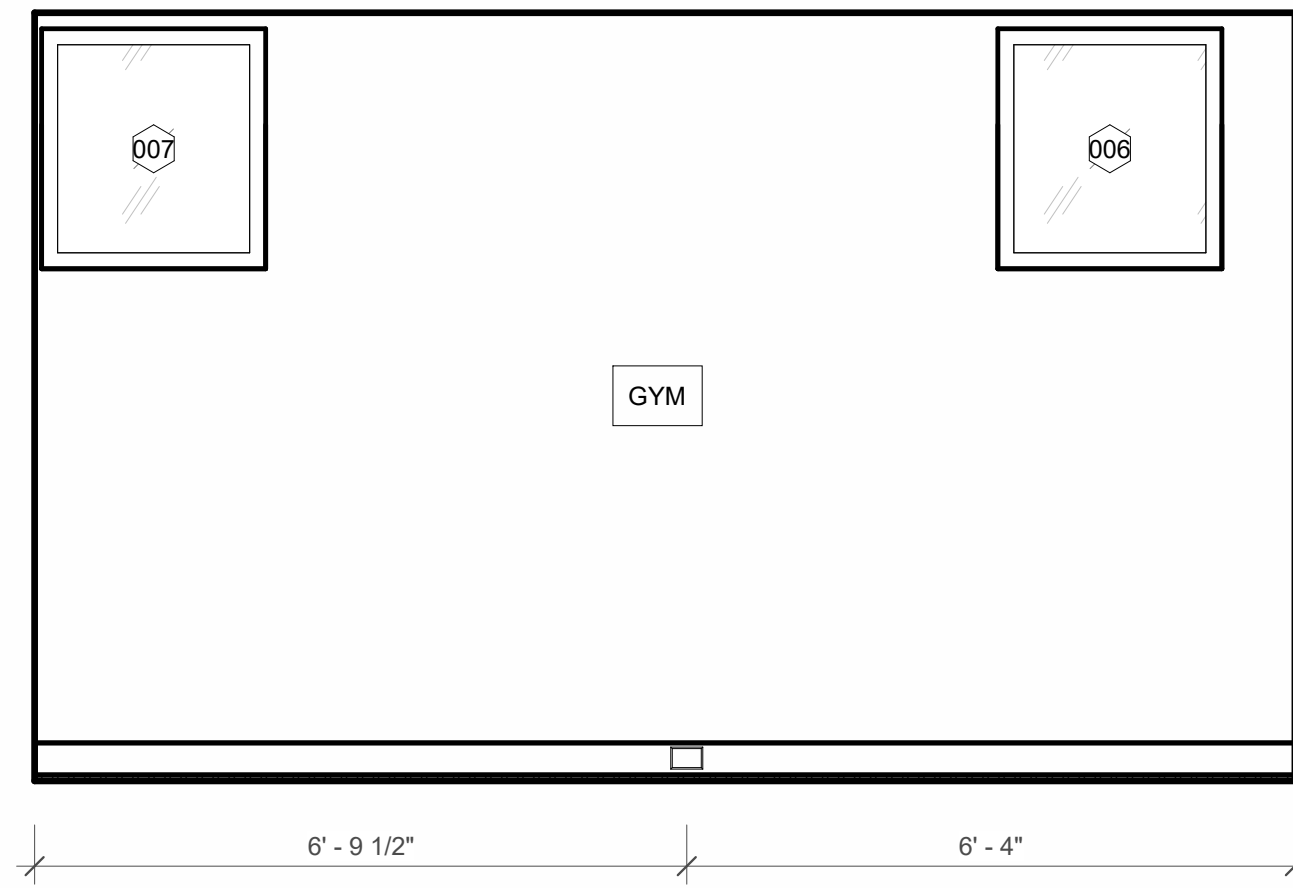


3 006 GYM - WEST
 1/2" = 1'-0"

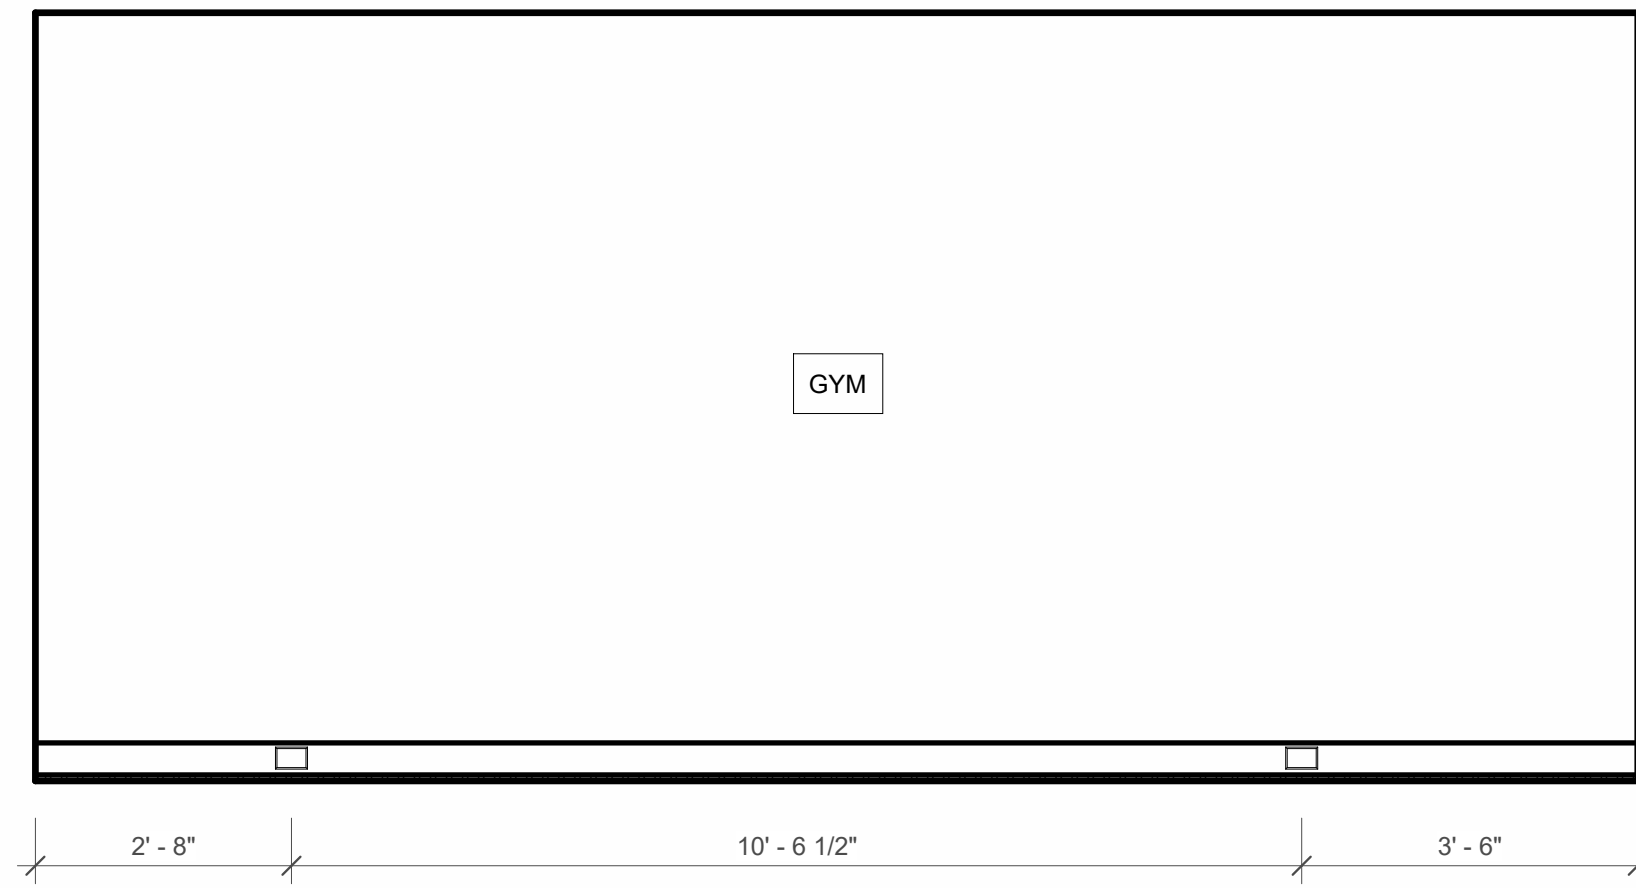


4 006 GYM - NORTH
 1/2" = 1'-0"

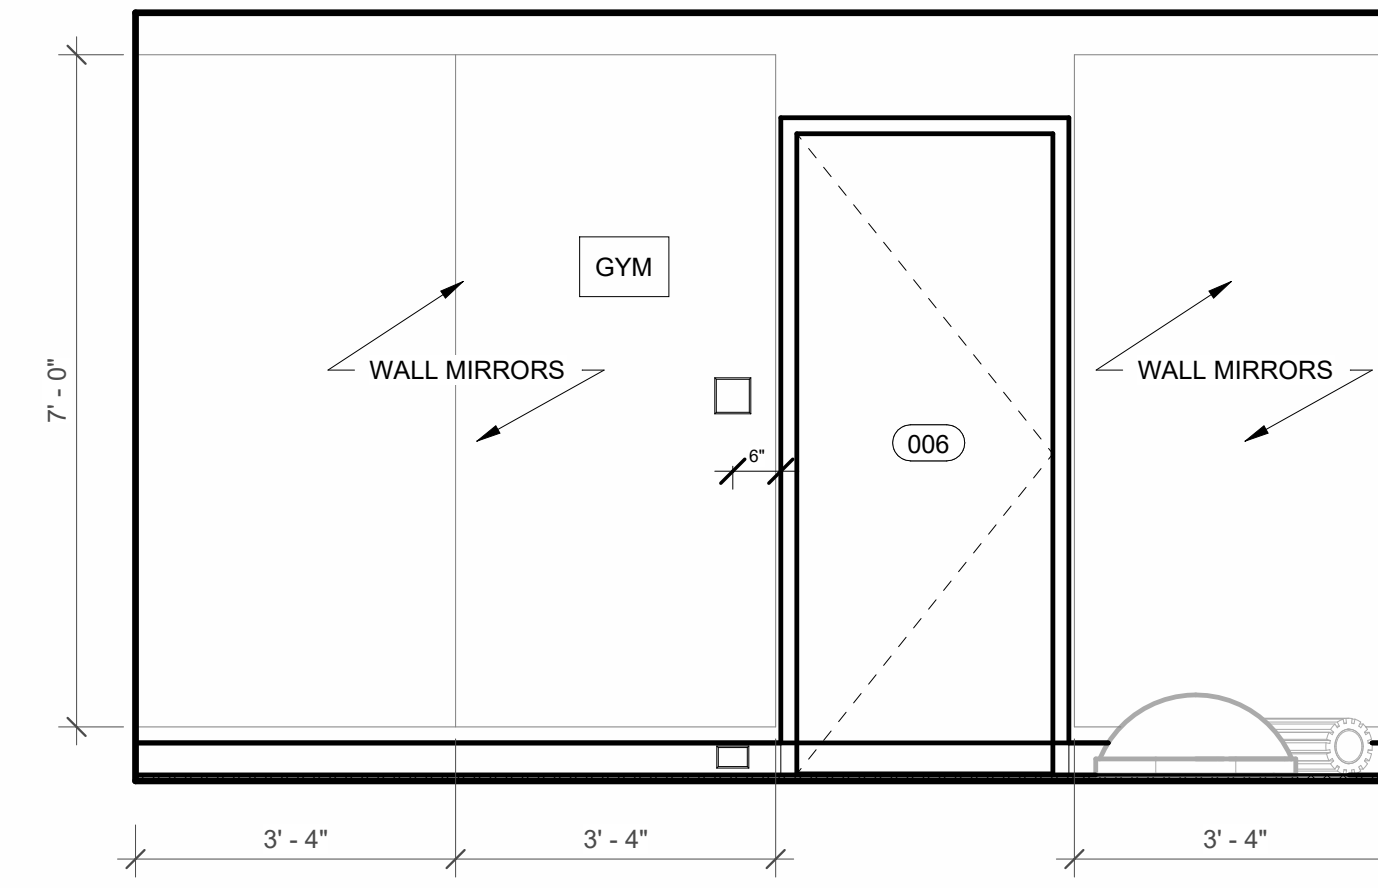


5 006 GYM - EAST
 1/2" = 1'-0"

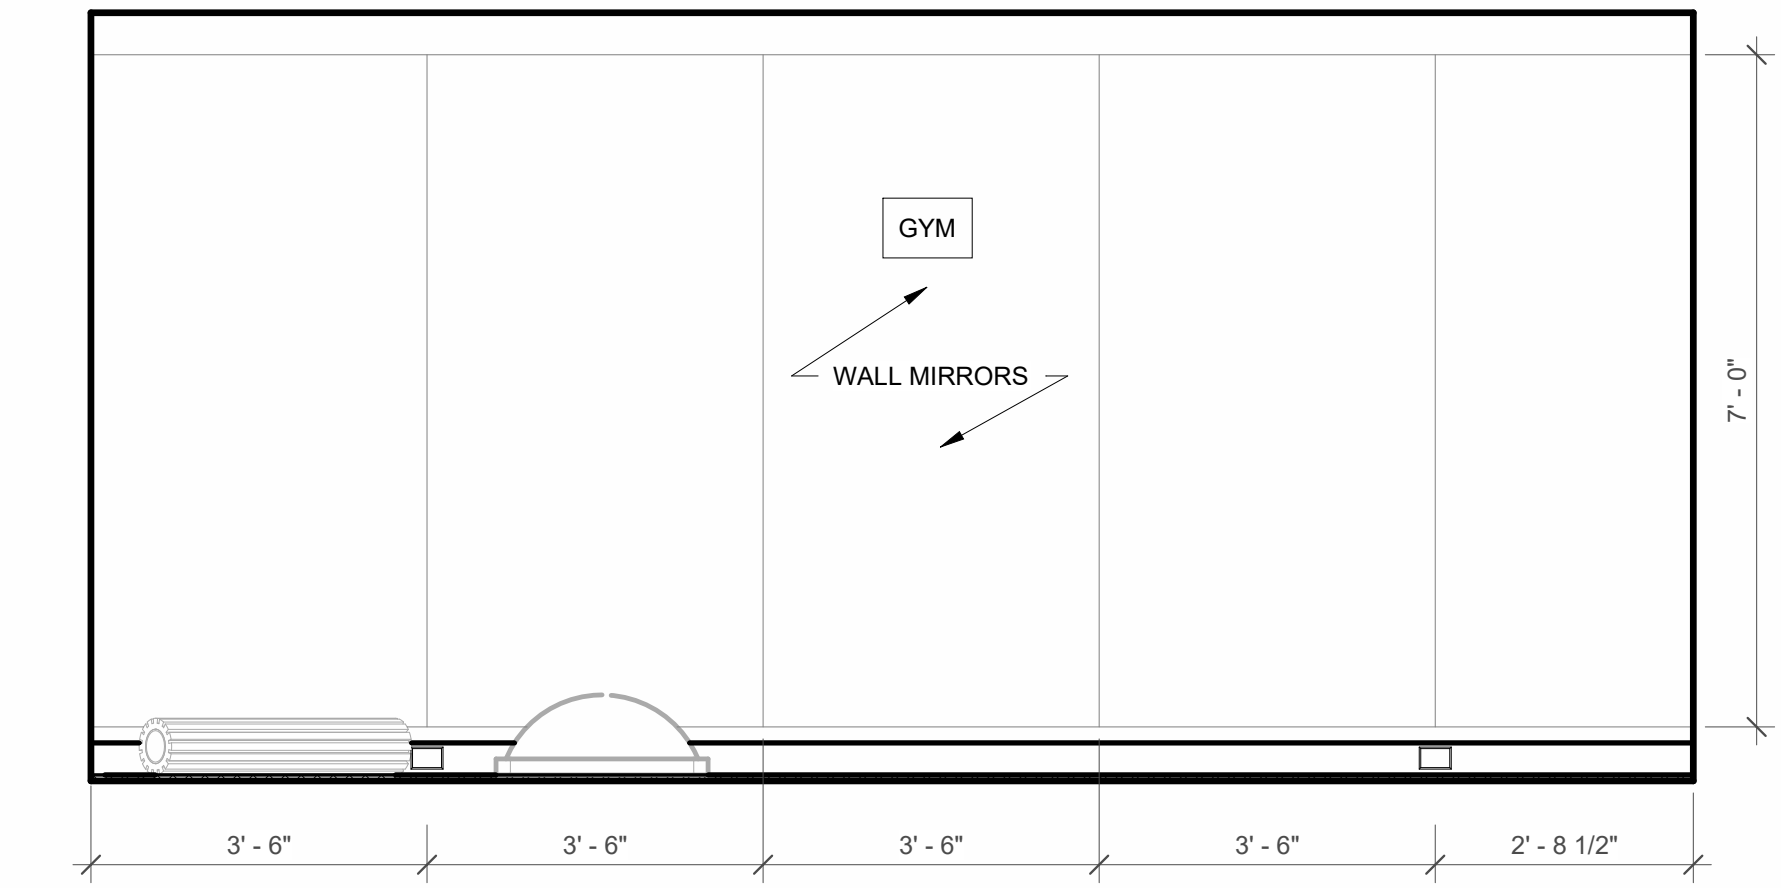


6 006 GYM - SOUTH
 1/2" = 1'-0"

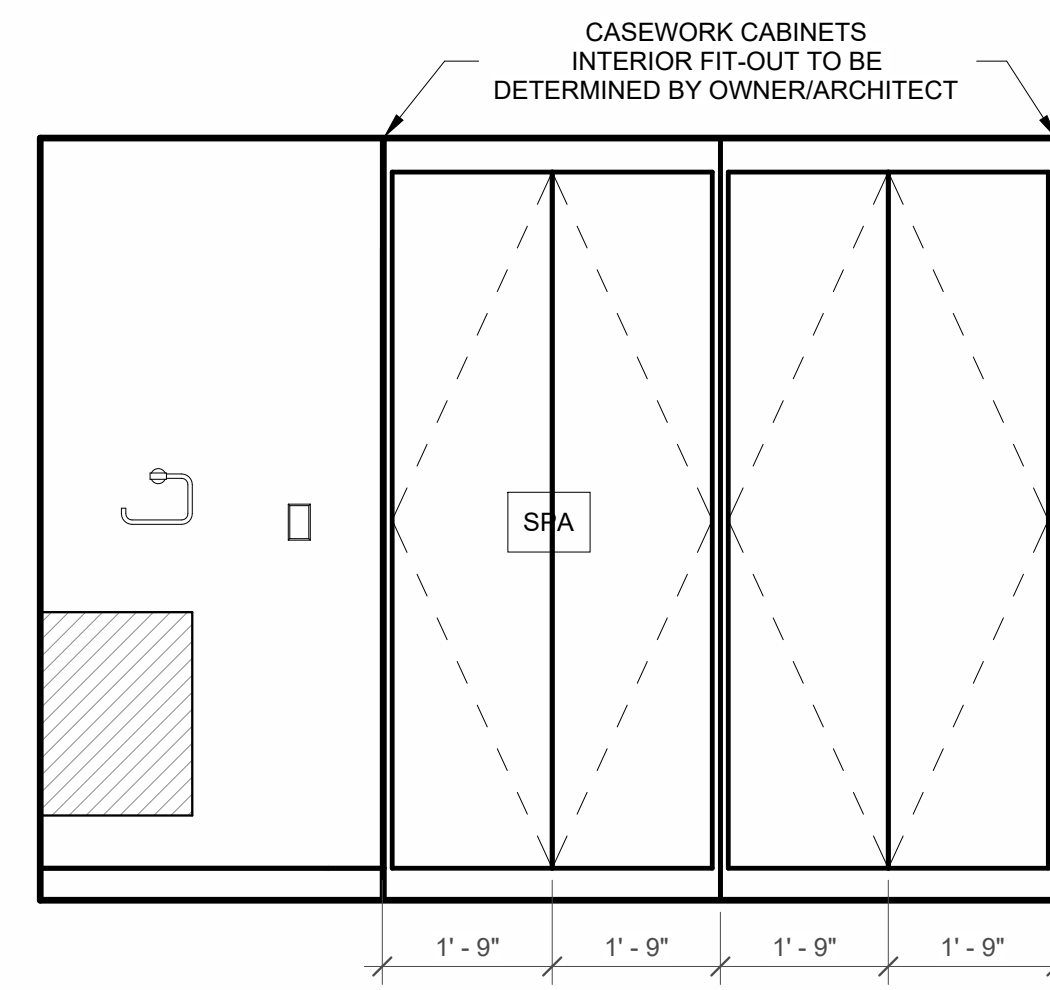


7 010 SPA - EAST
 1/2" = 1'-0"

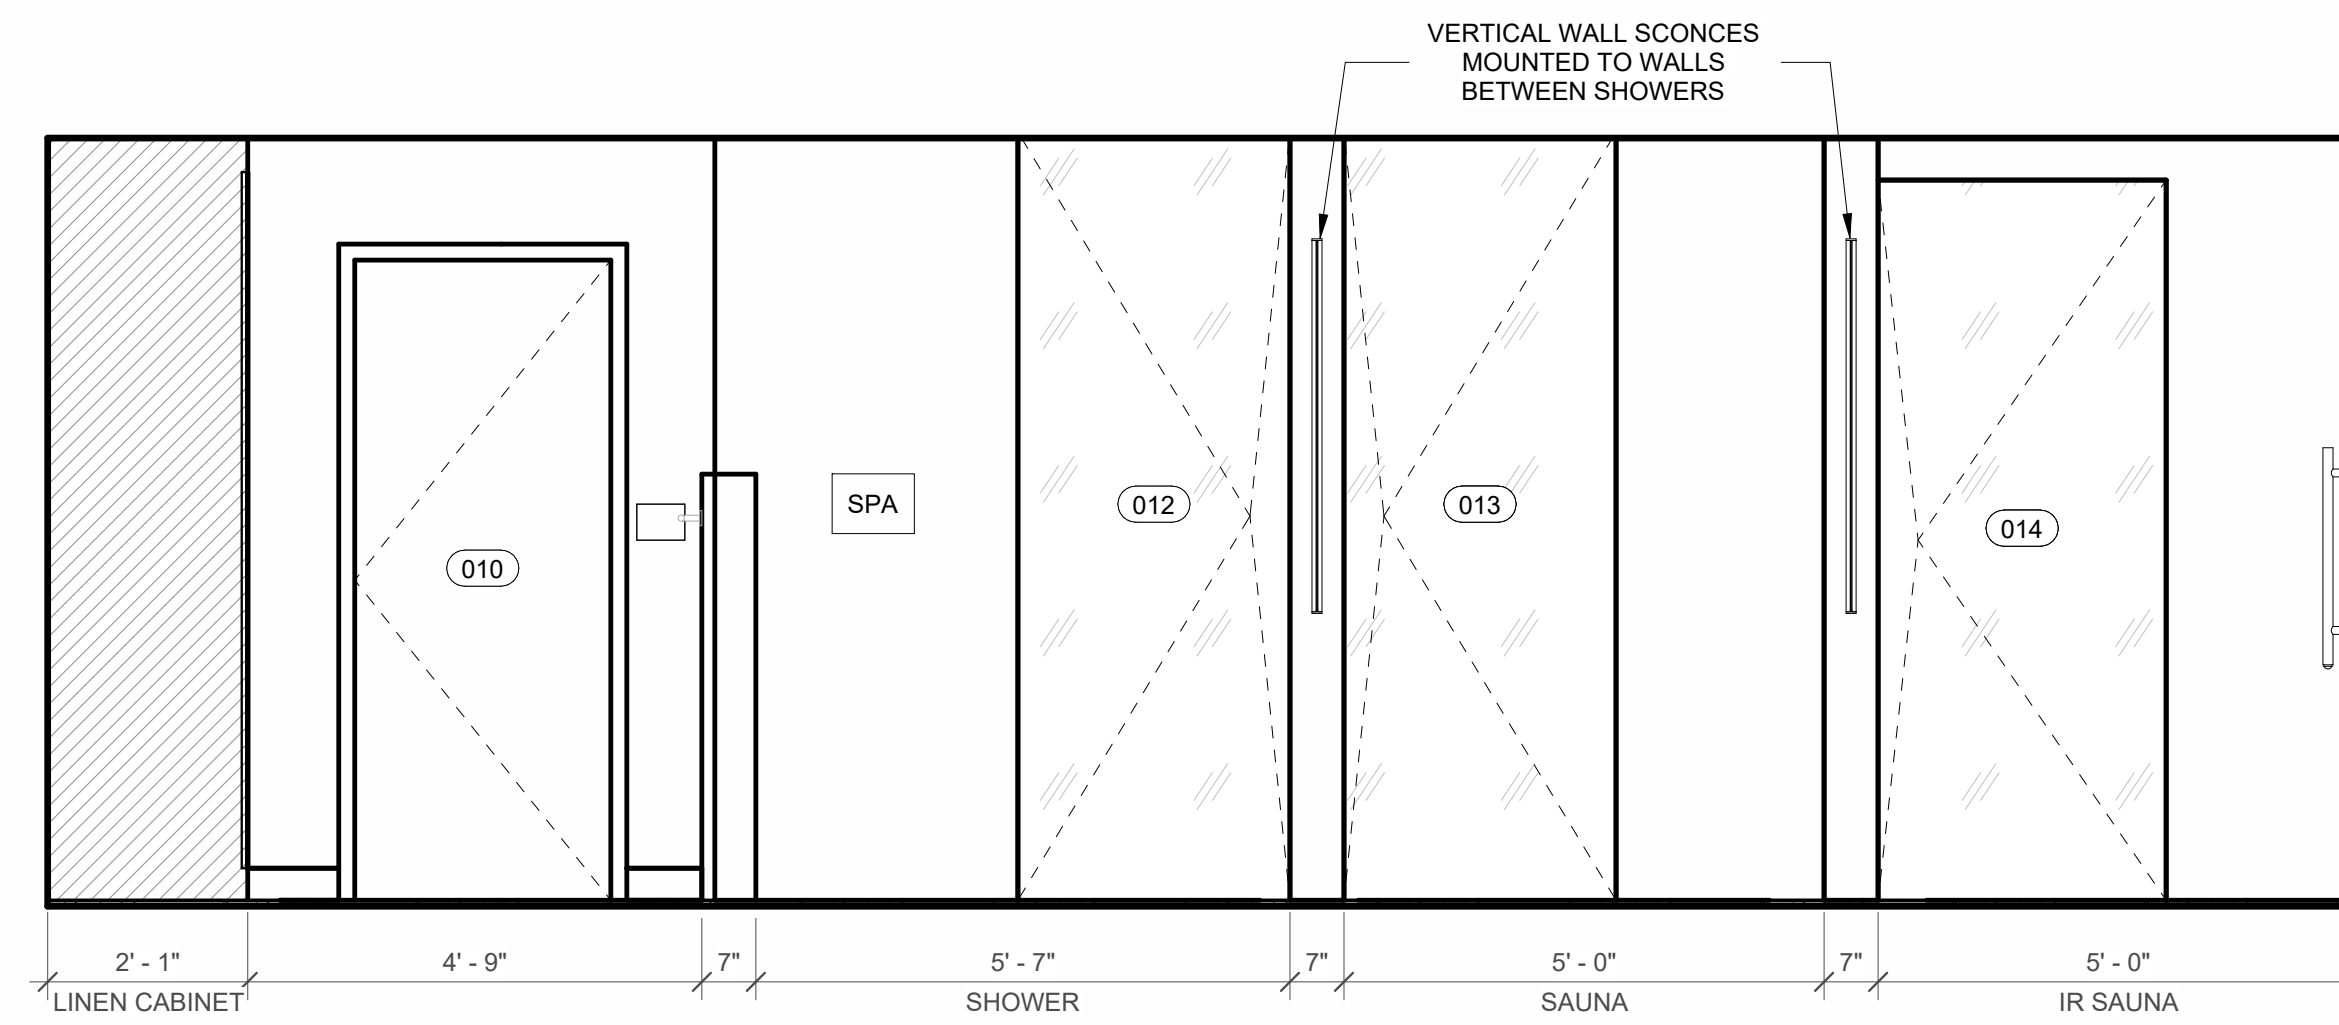


8 010 SPA - SOUTH
 1/2" = 1'-0"

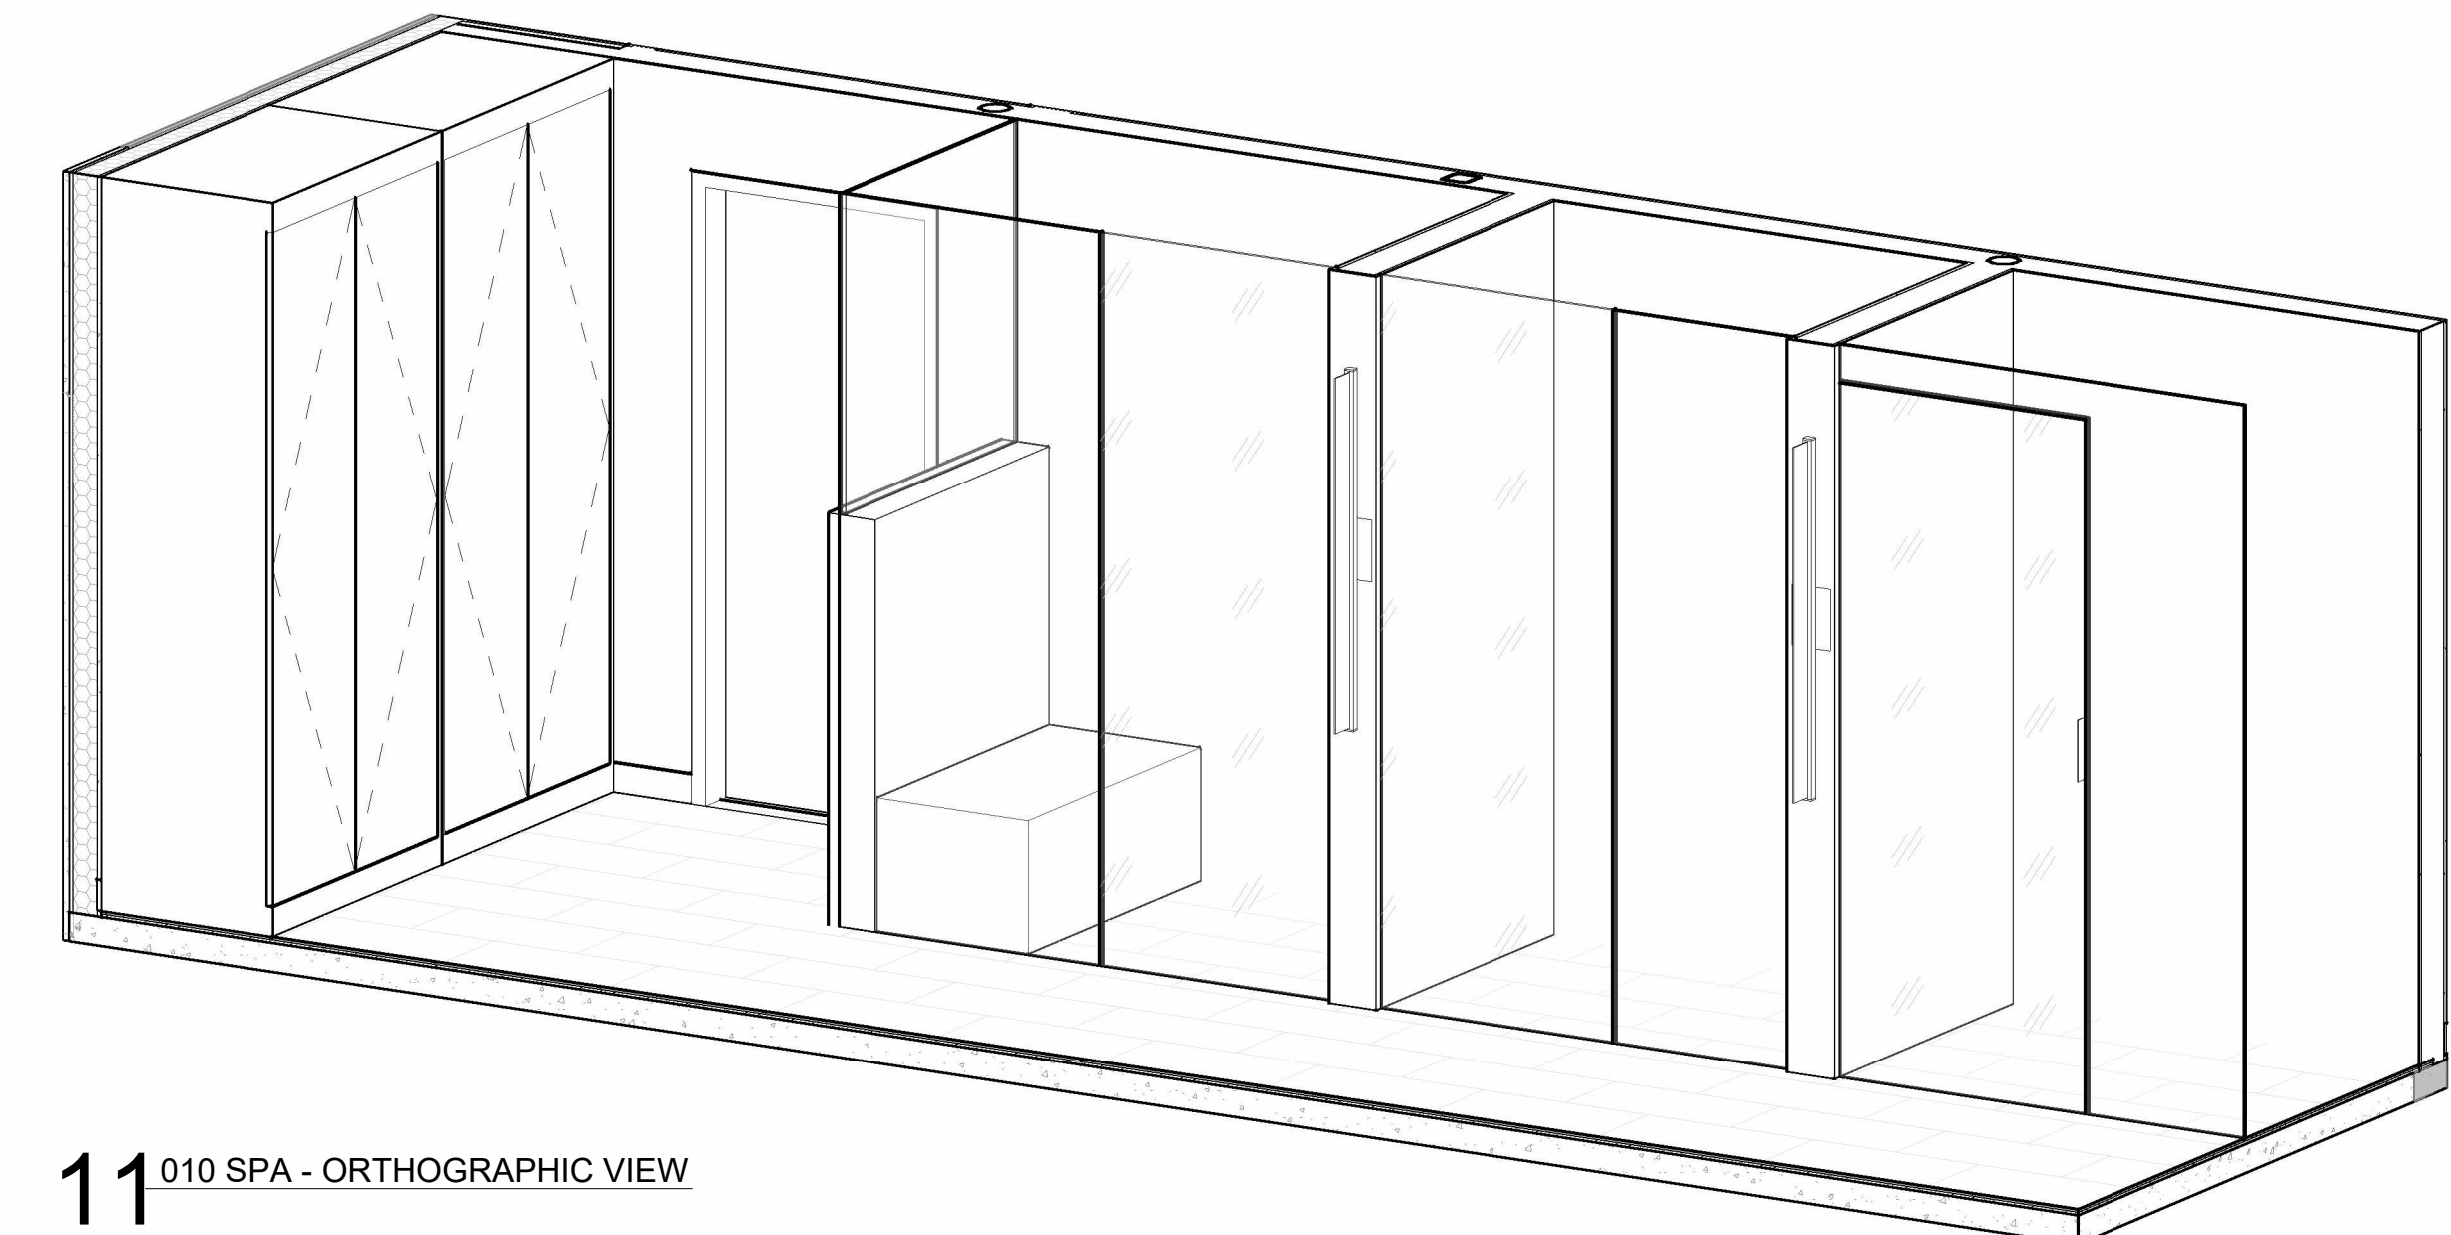


11 010 SPA - ORTHOGRAPHIC VIEW

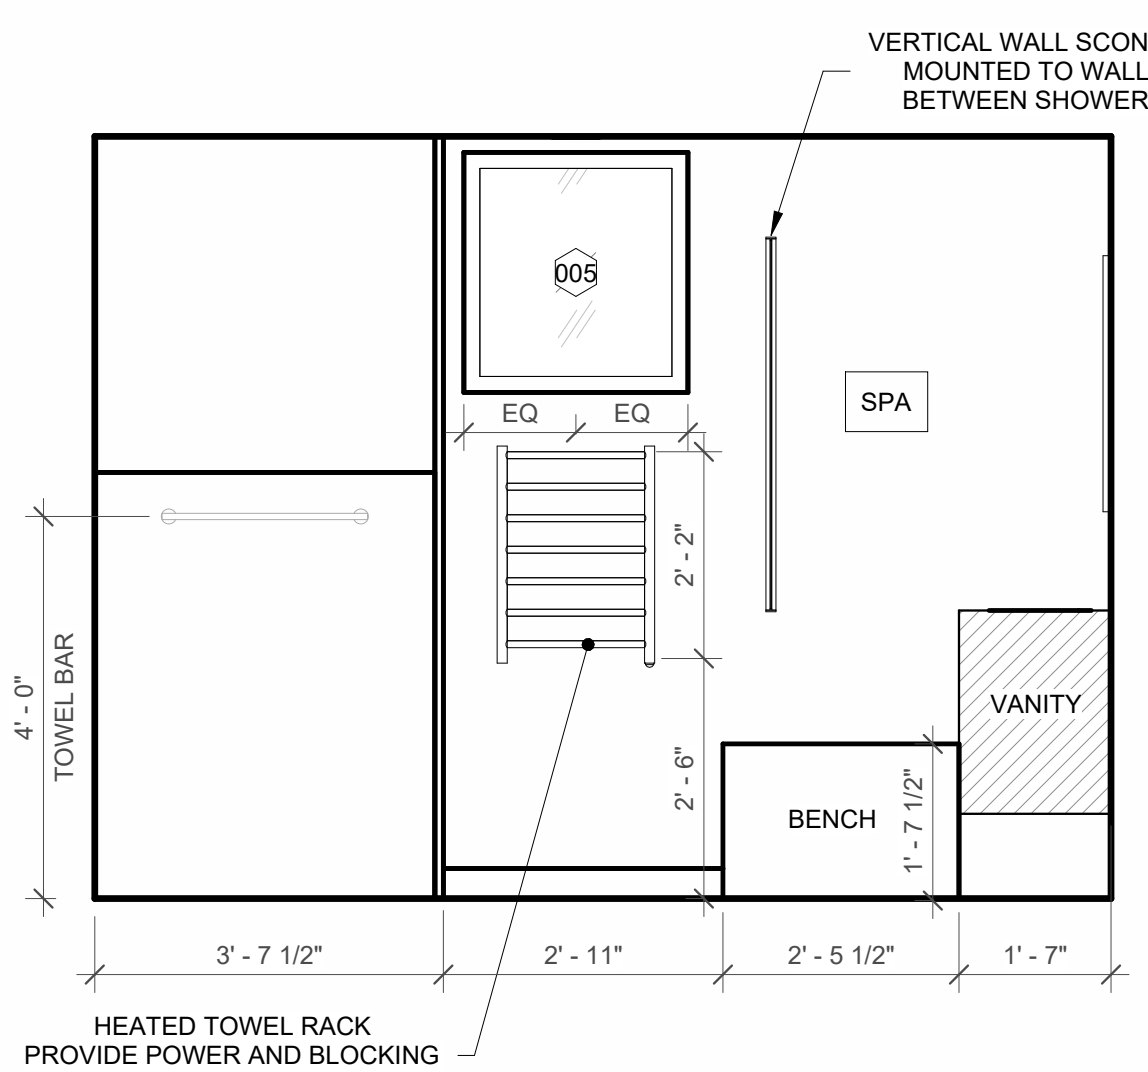

9 010 SPA - WEST
 1/2" = 1'-0"

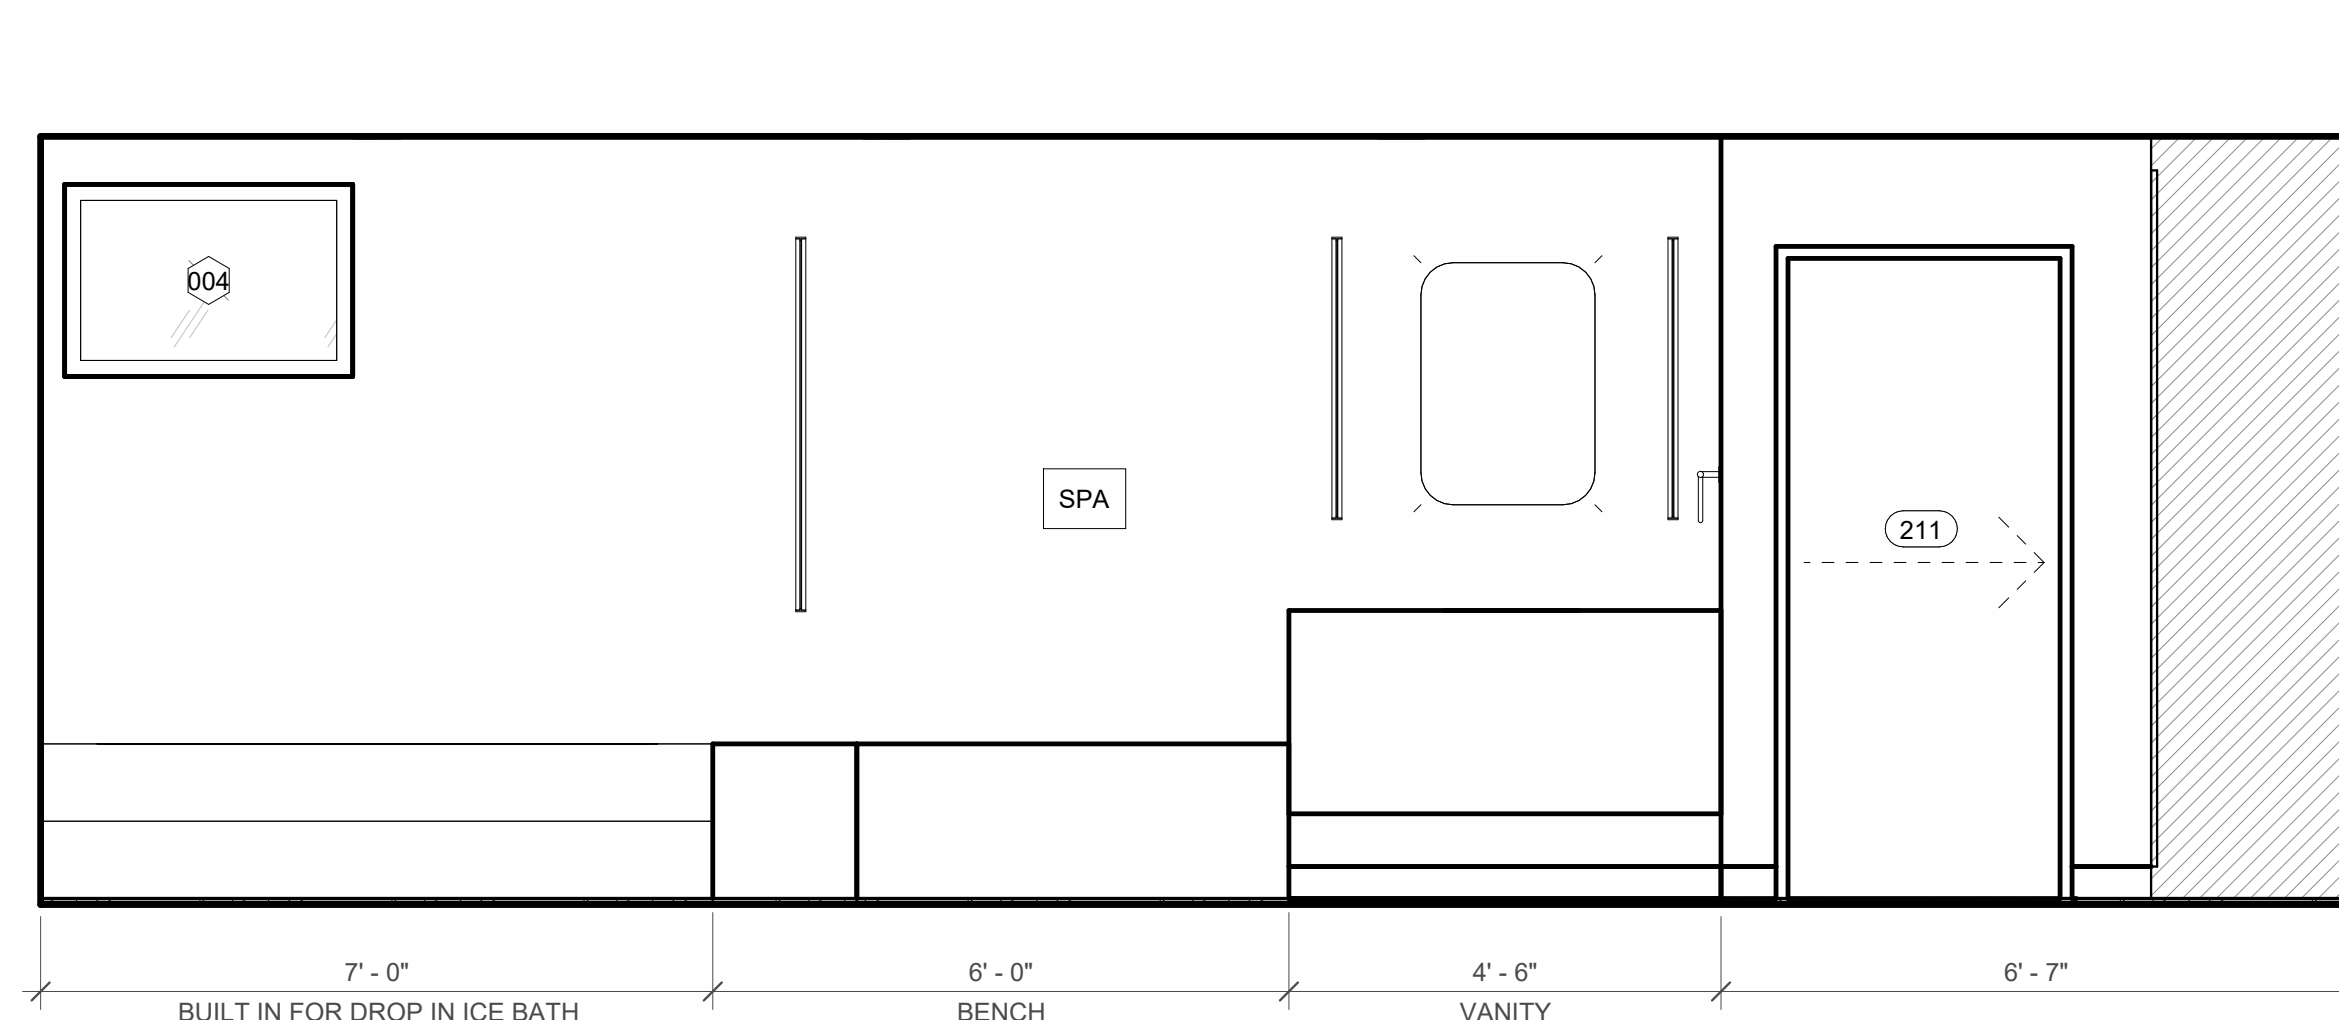

10 010 SPA - NORTH
 1/2" = 1'-0"

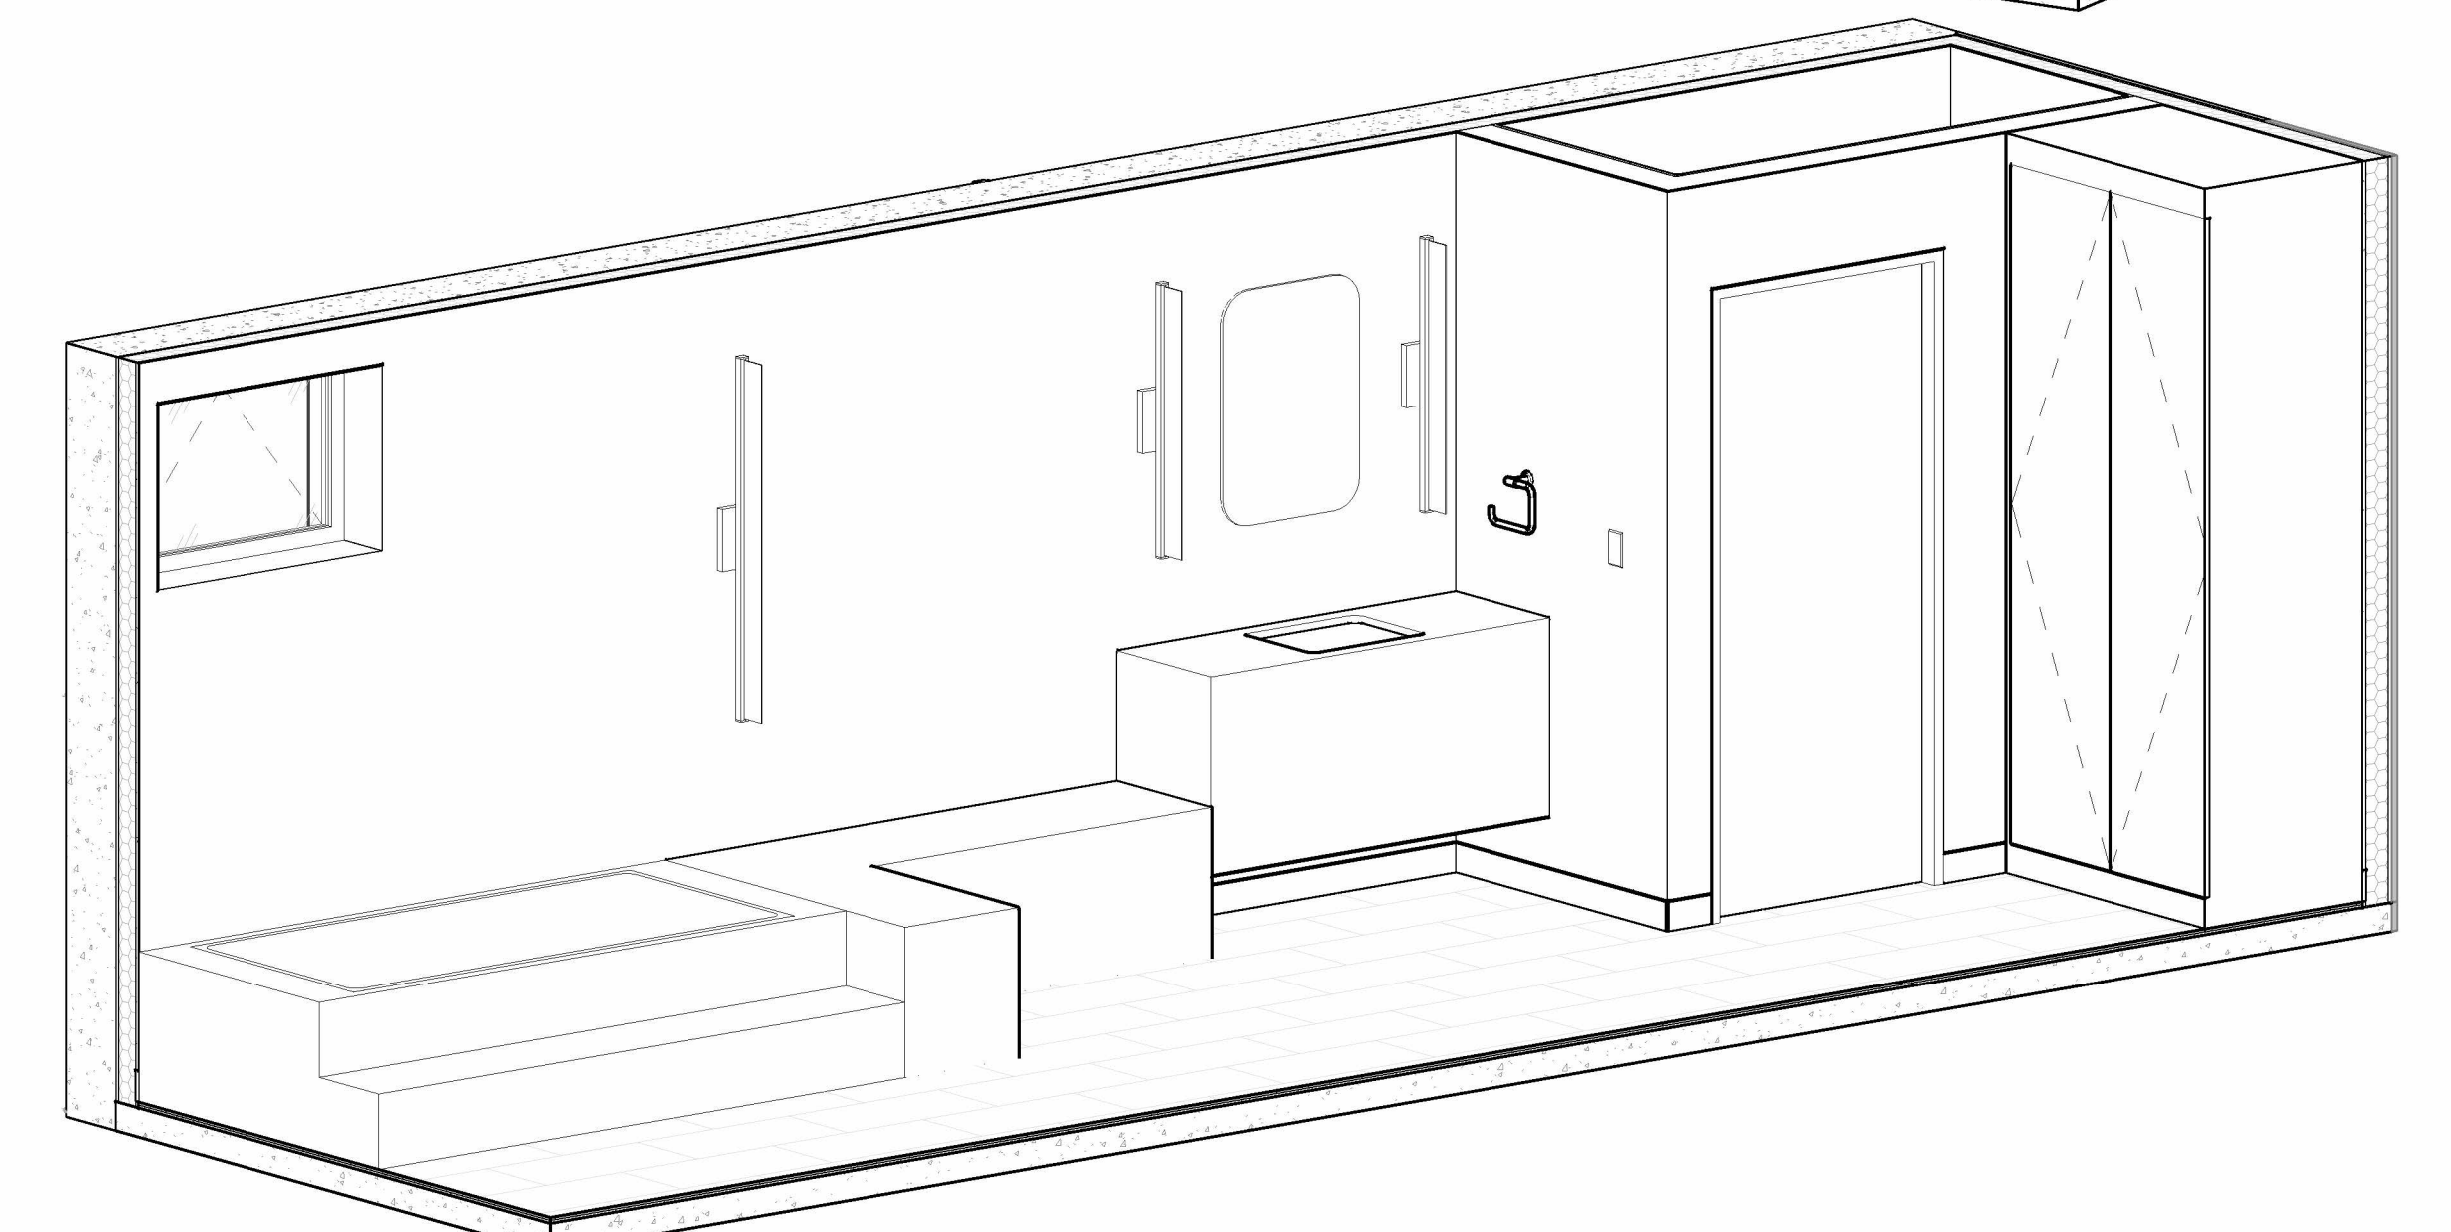

12 010 SPA - ORTHOGRAPHIC VIEW 2

NO.	DESCRIPTION	DATE


PERMIT REVISION

DATE:	AUG 18, 2023
SCALE:	1/2" = 1'-0"
DRAWN BY:	CJ
CHECKED BY:	Checker


SHEET TITLE PROJECT #: 40035

INTERIOR ELEVATIONS


A6.00

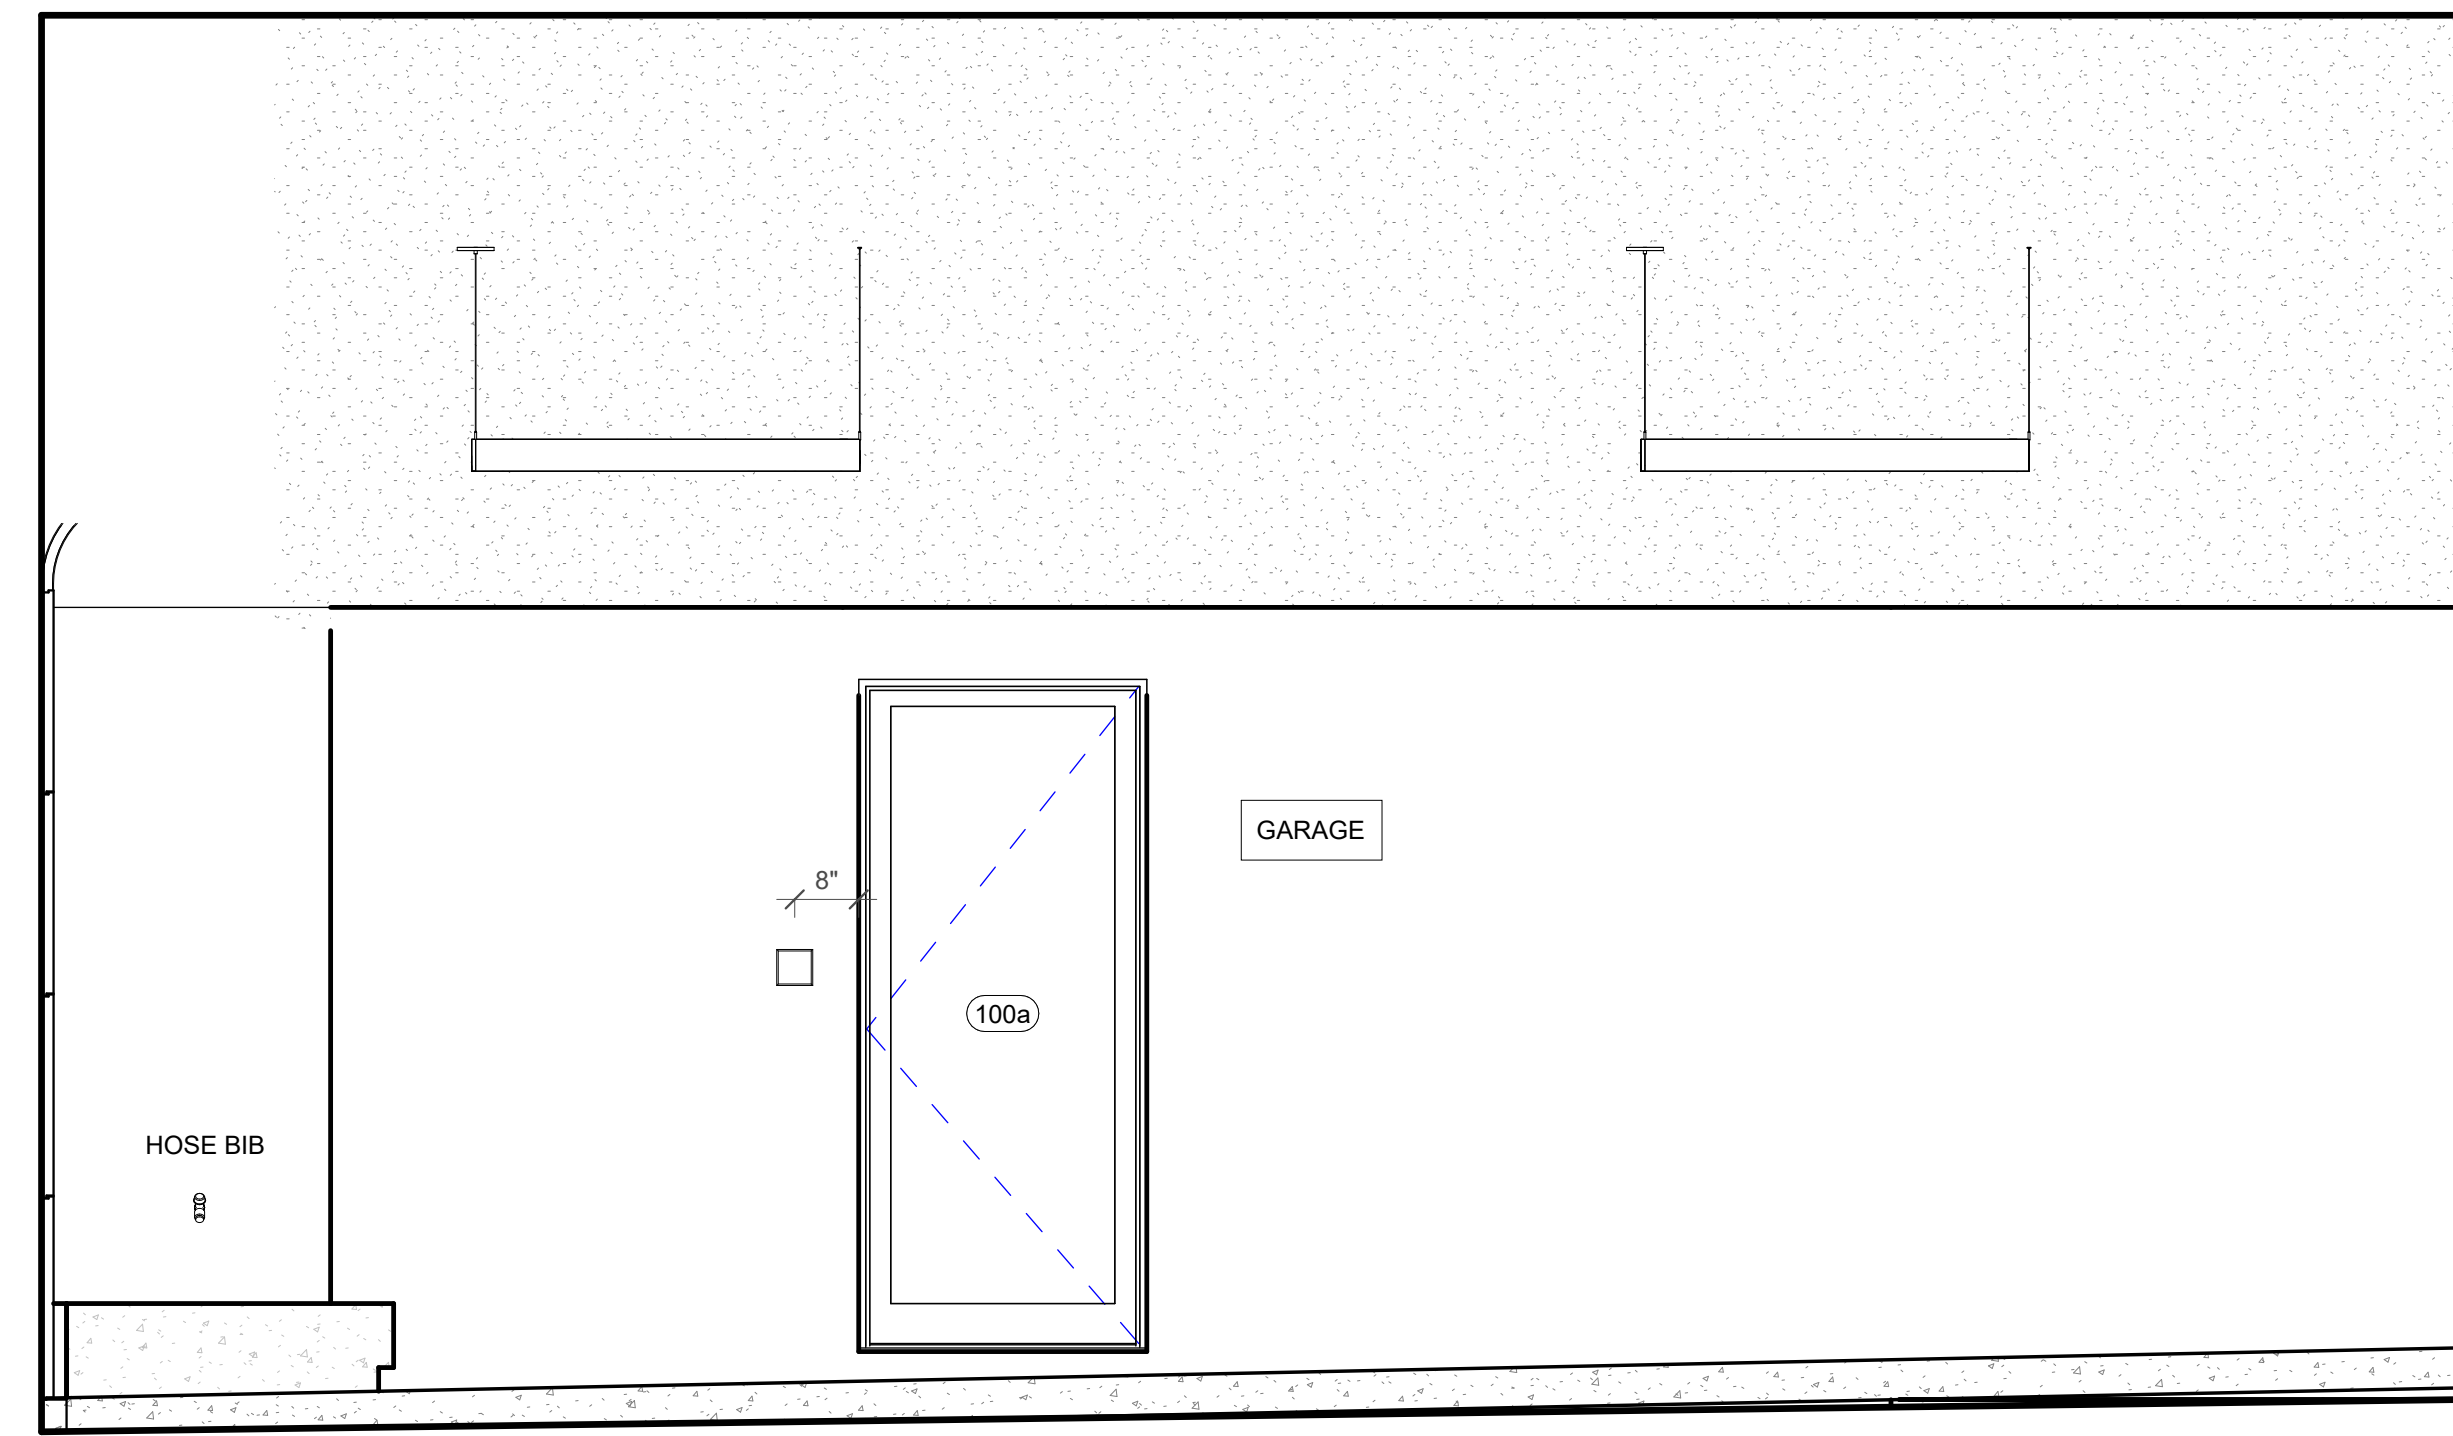


1 100 GARAGE - WEST ELEVATION
 1/2" = 1'-0"

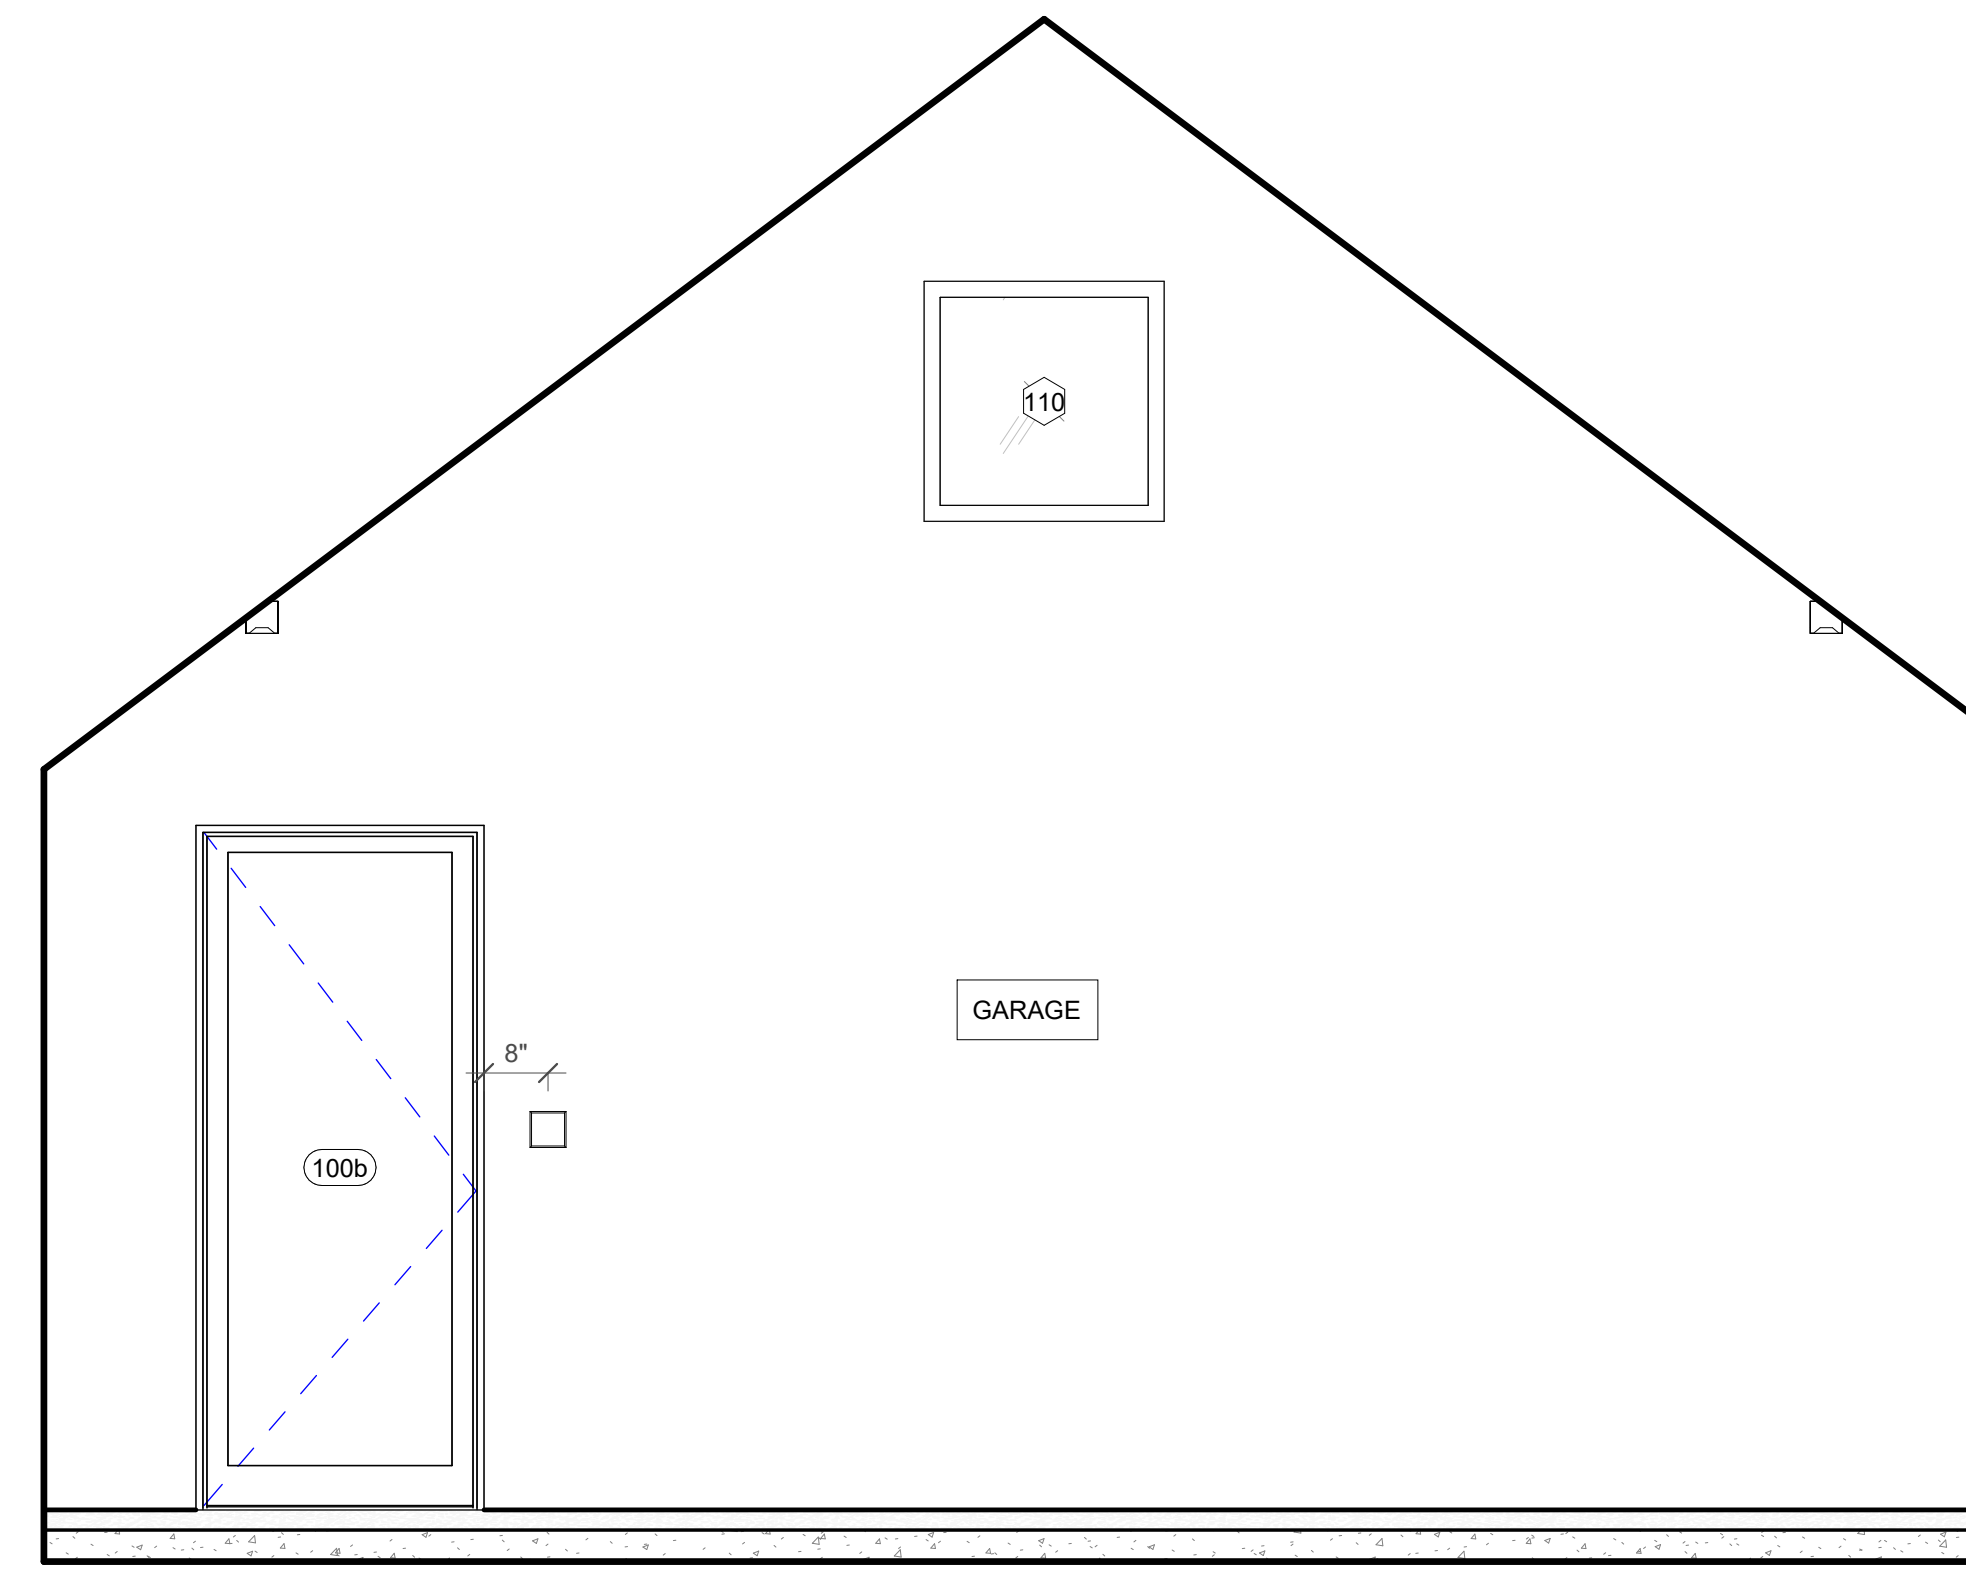


2 100 GARAGE - NORTH ELEVATION
 1/2" = 1'-0"

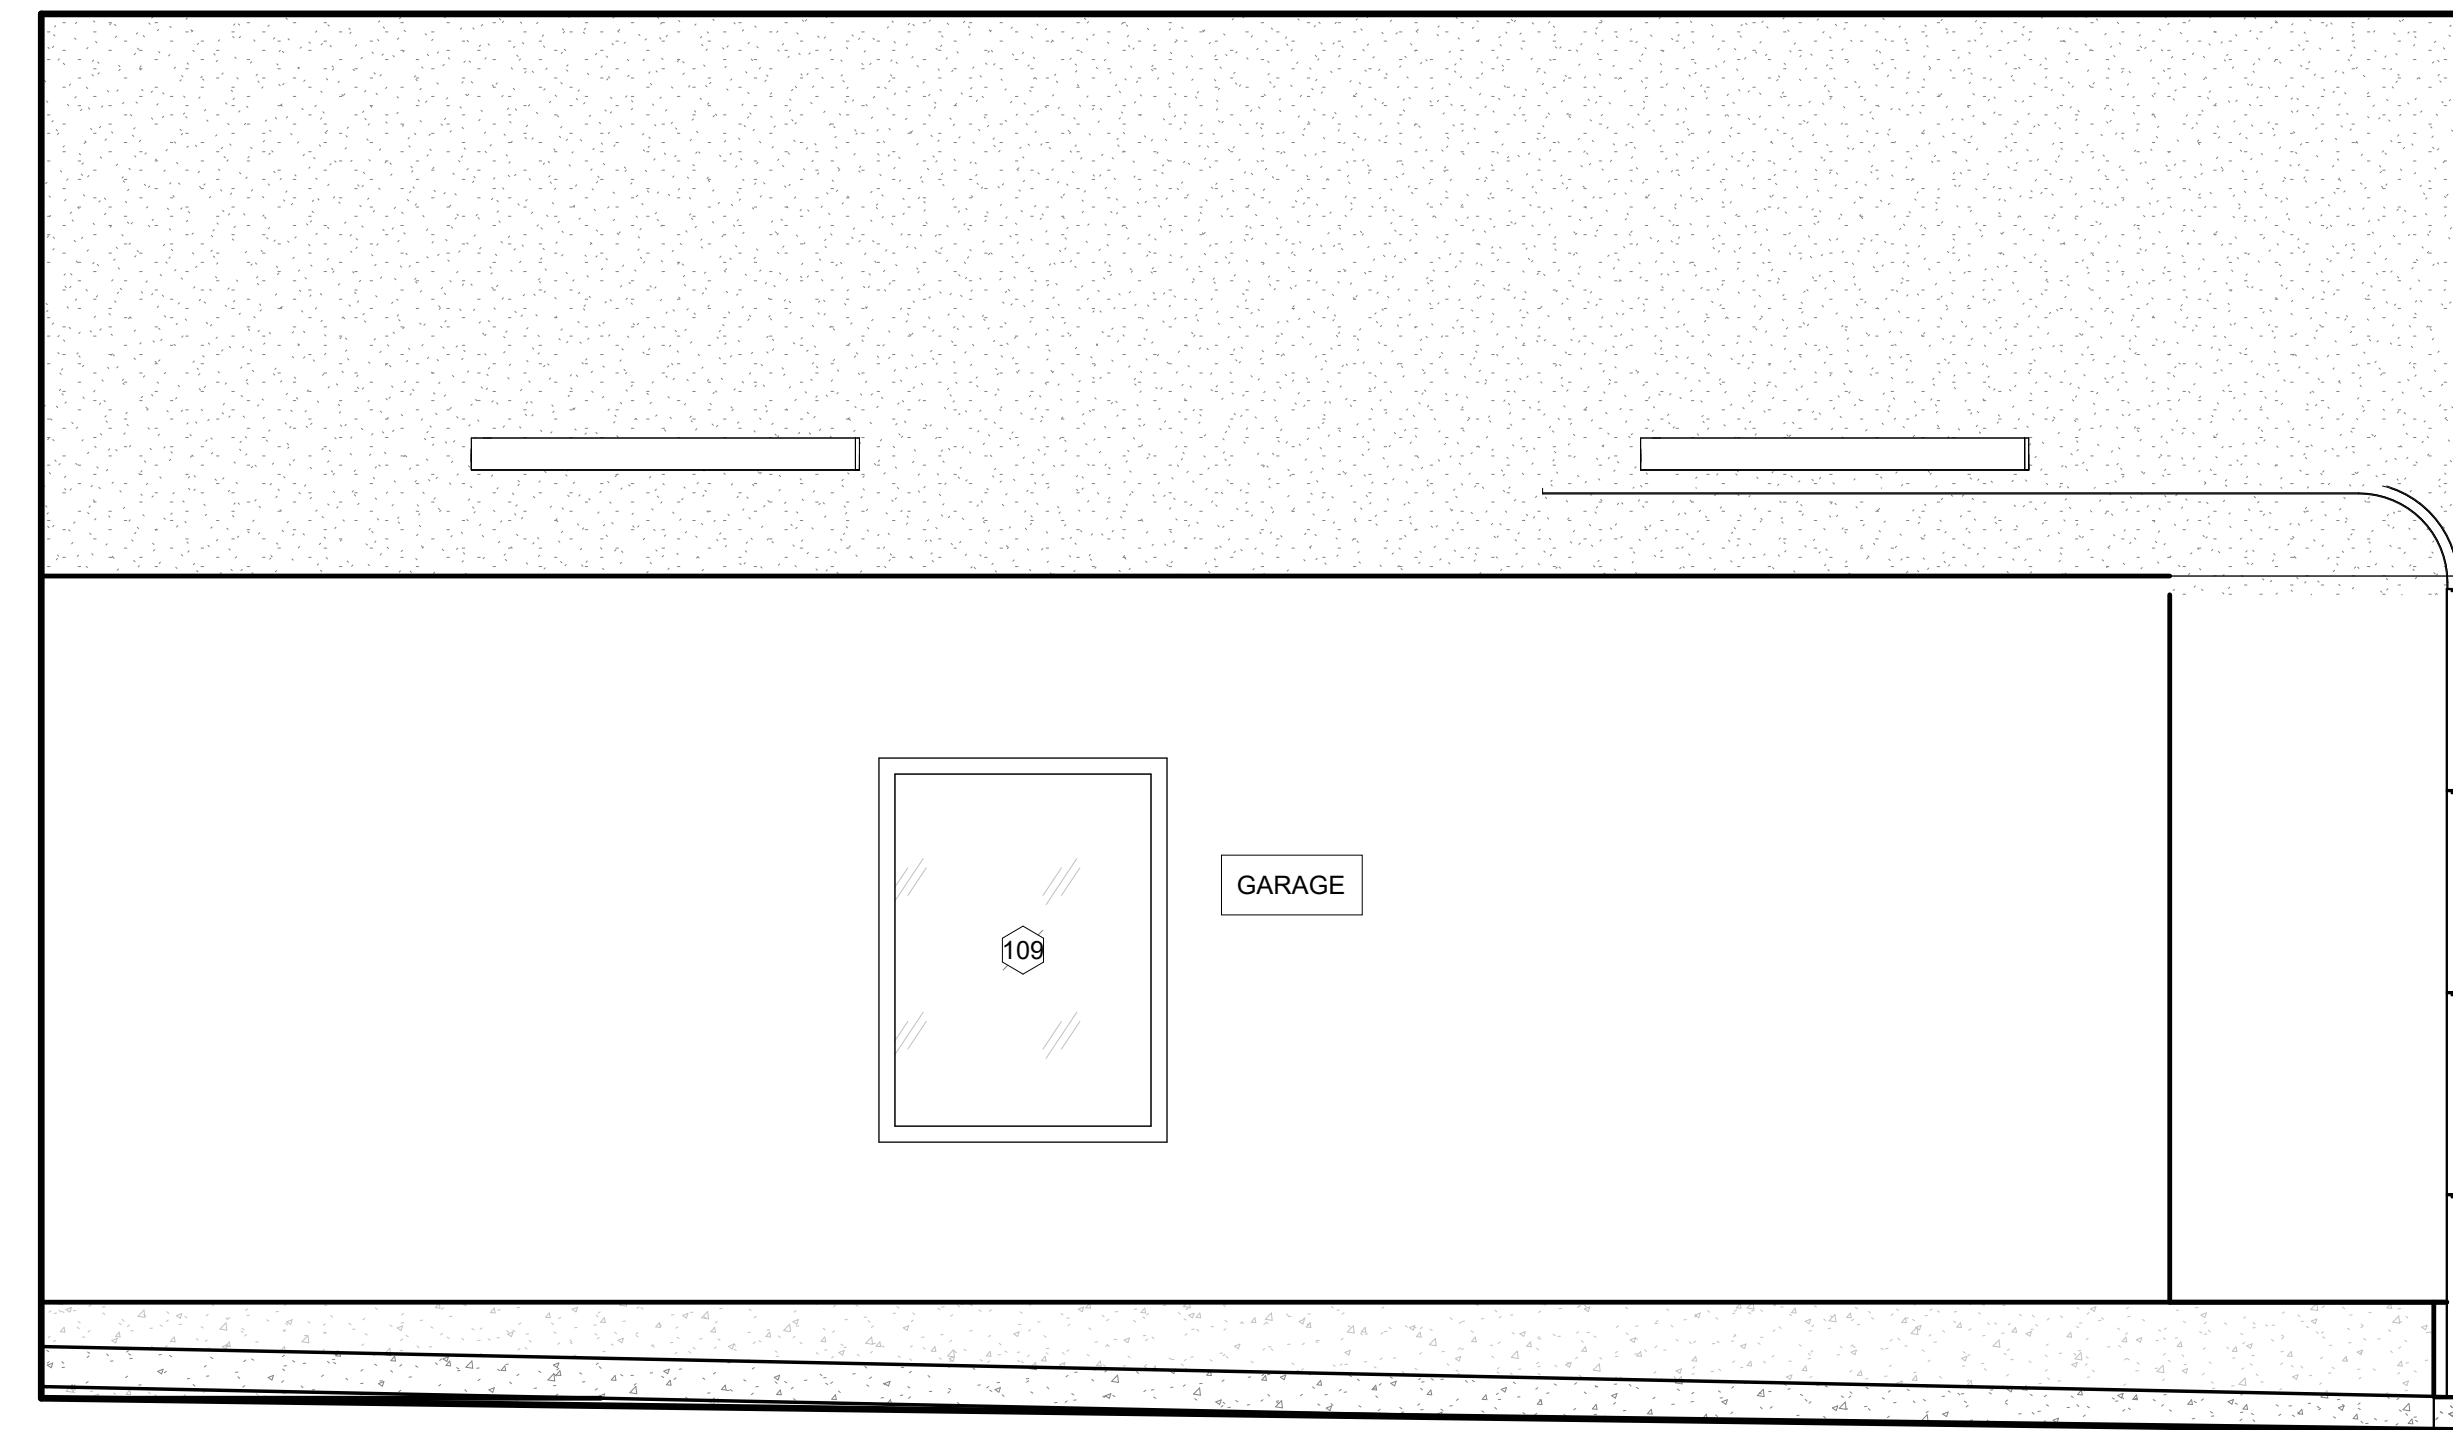


3 100 GARAGE - EAST ELEVATION
 1/2" = 1'-0"

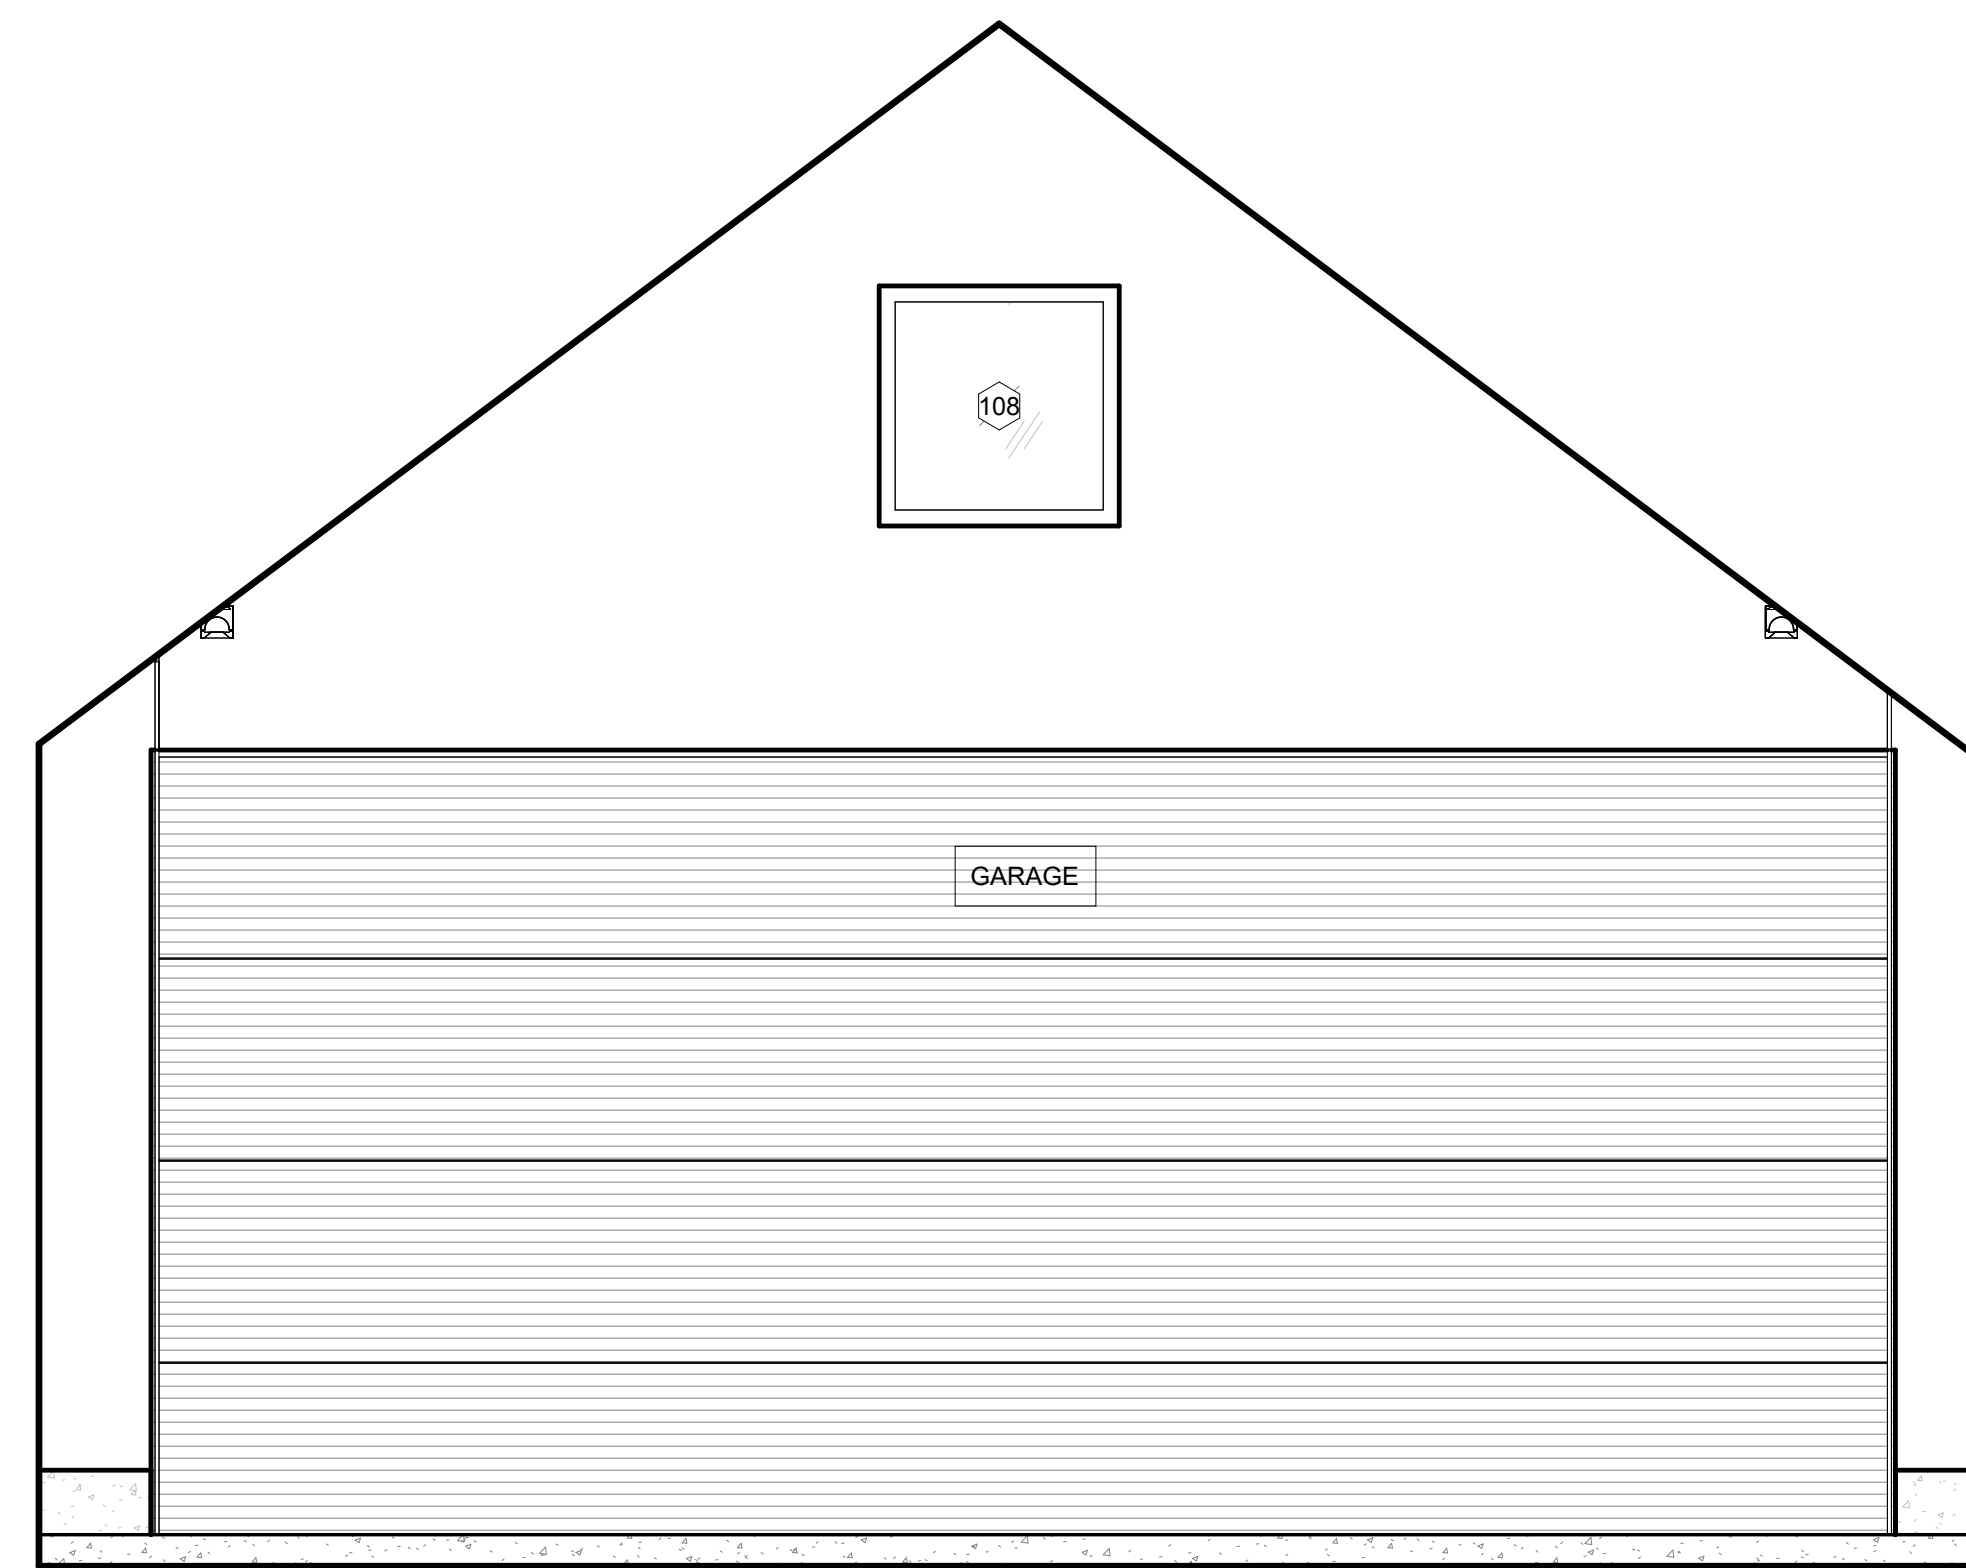


4 100 GARAGE - SOUTH ELEVATION
 1/2" = 1'-0"

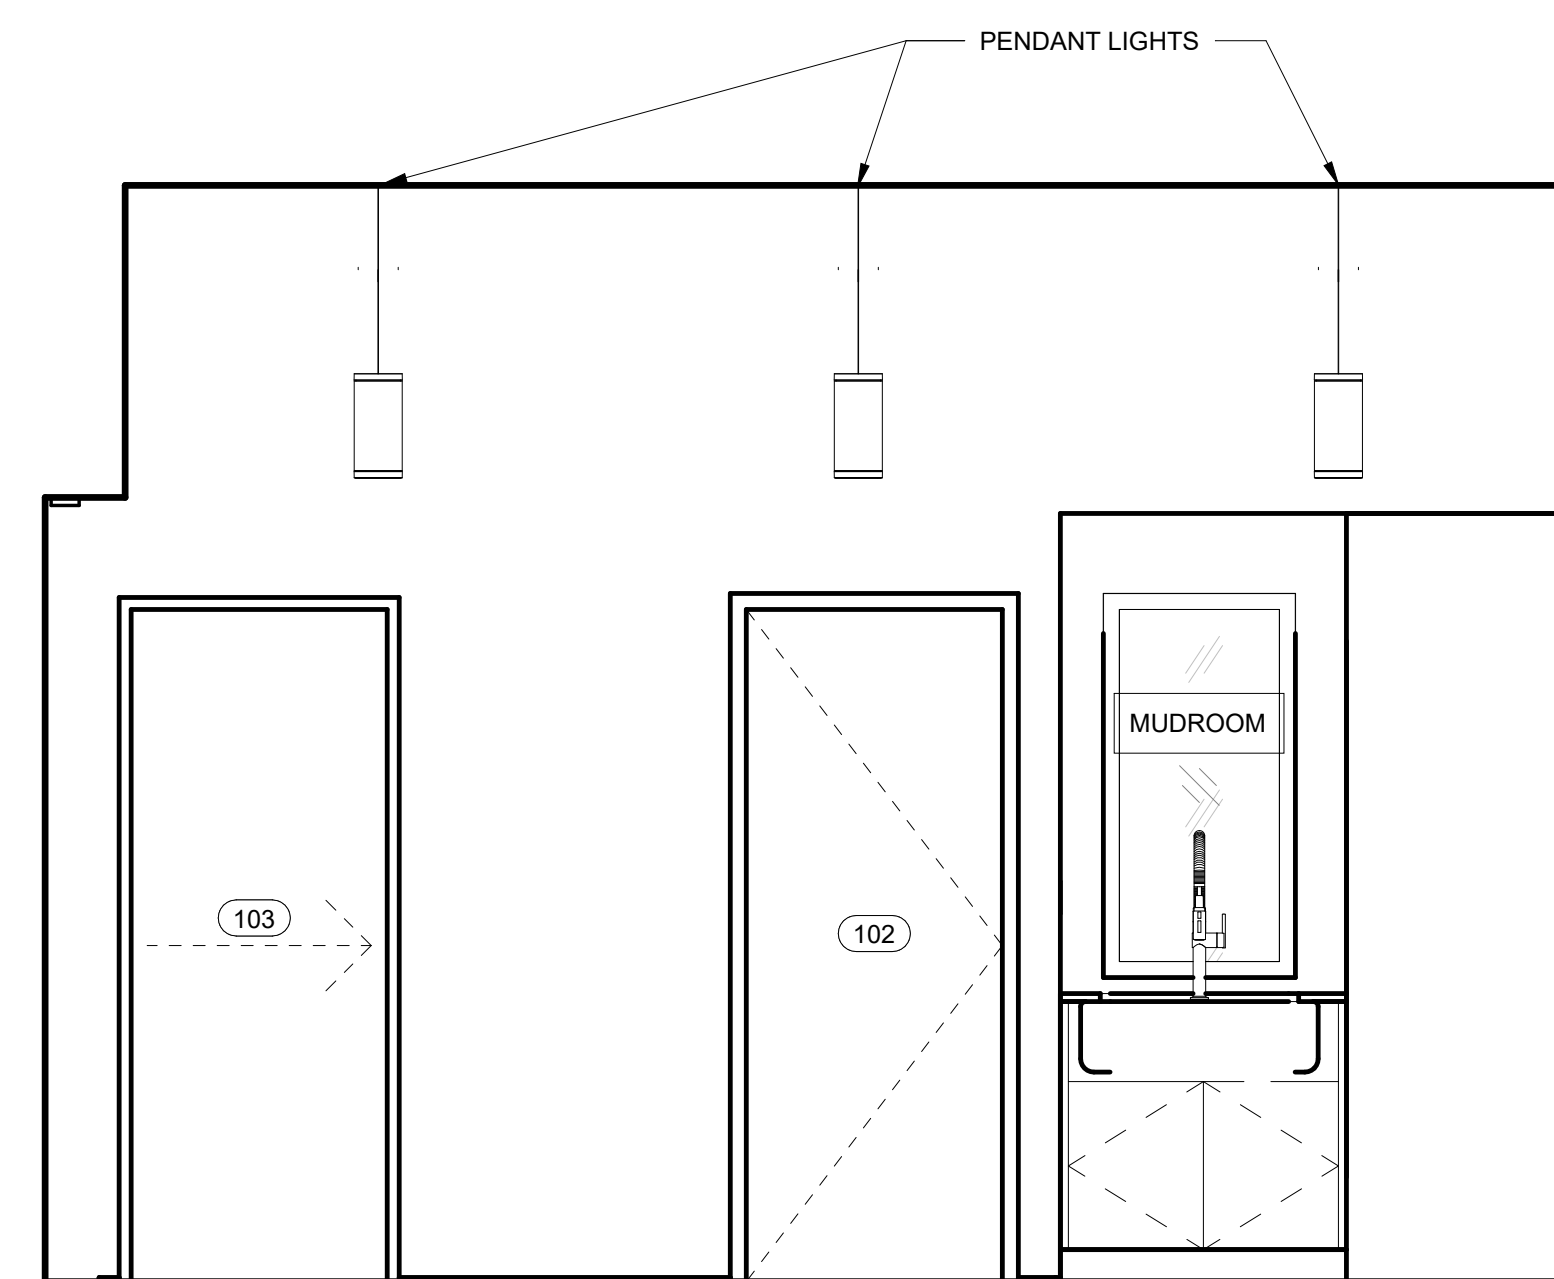

5 101 MUD HALL - NORTH ELEVATION
 1/2" = 1'-0"

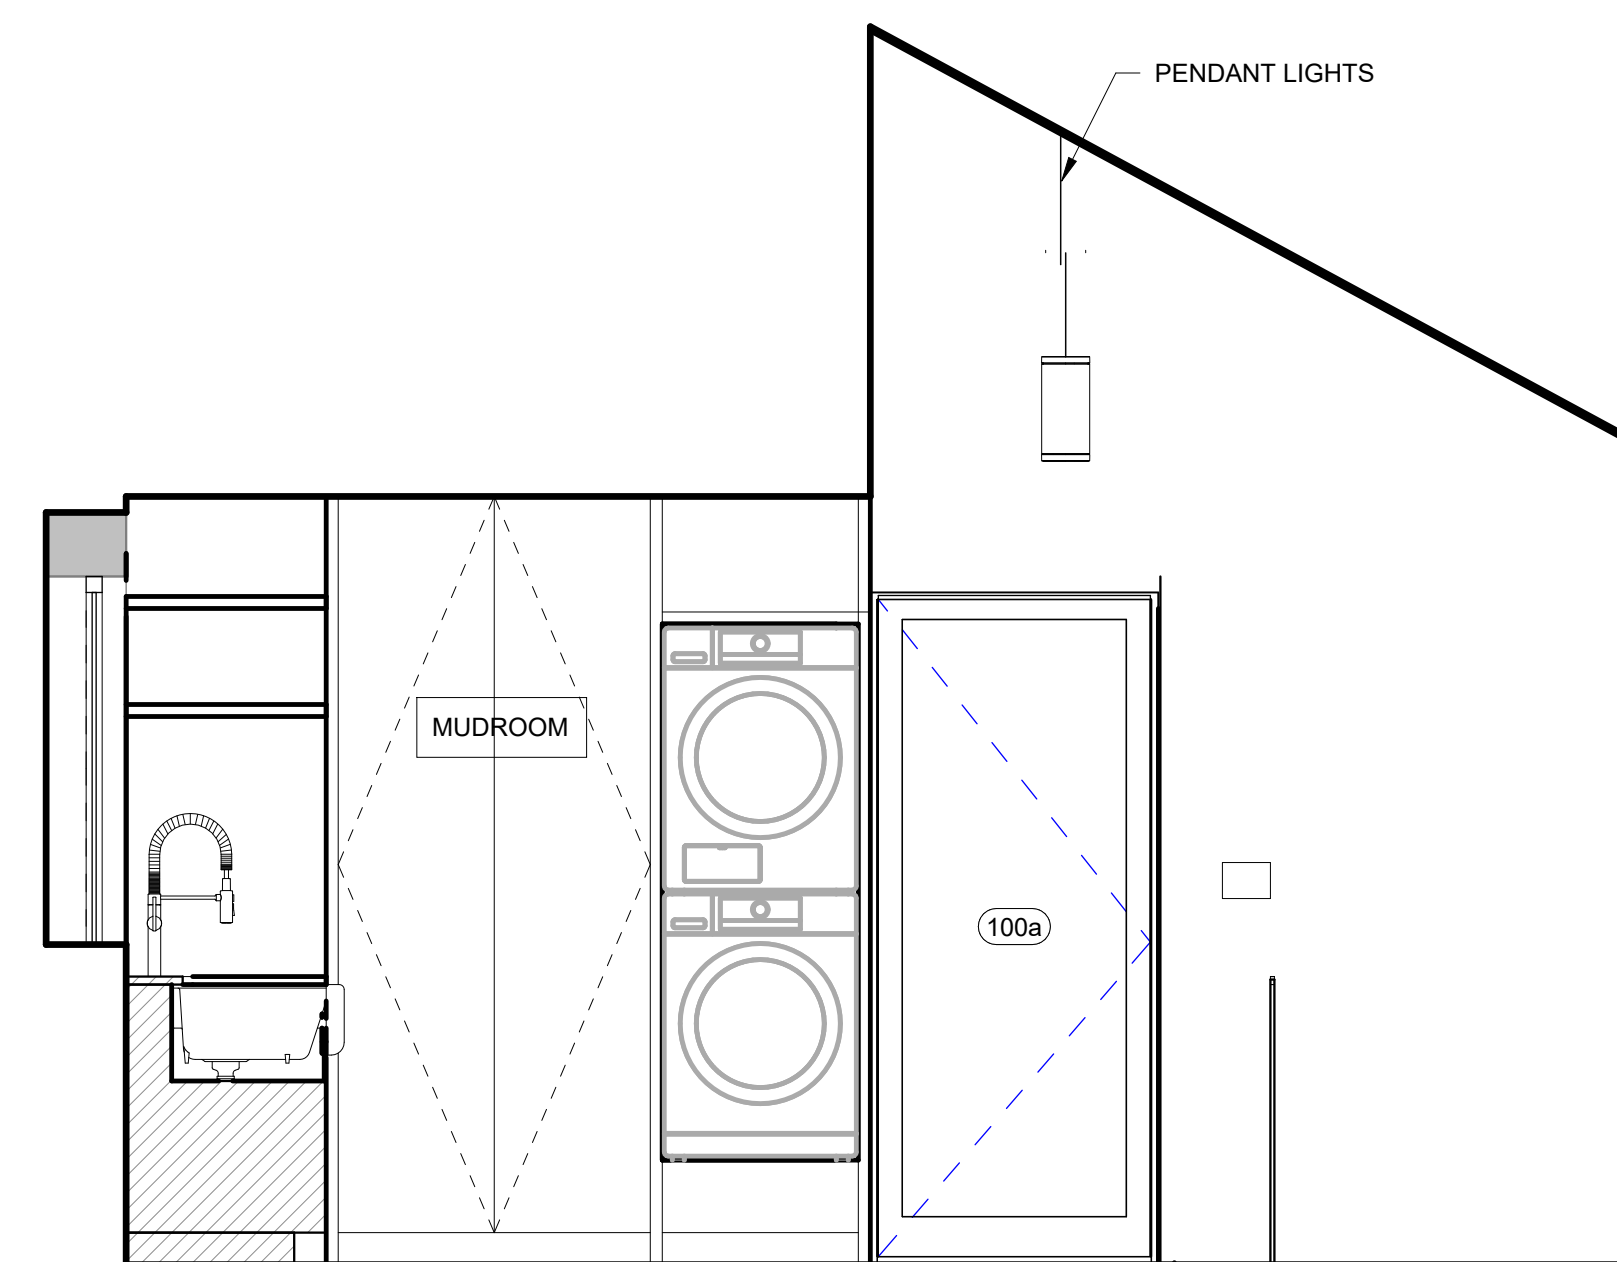

6 101 MUD HALL - EAST ELEVATION
 1/2" = 1'-0"

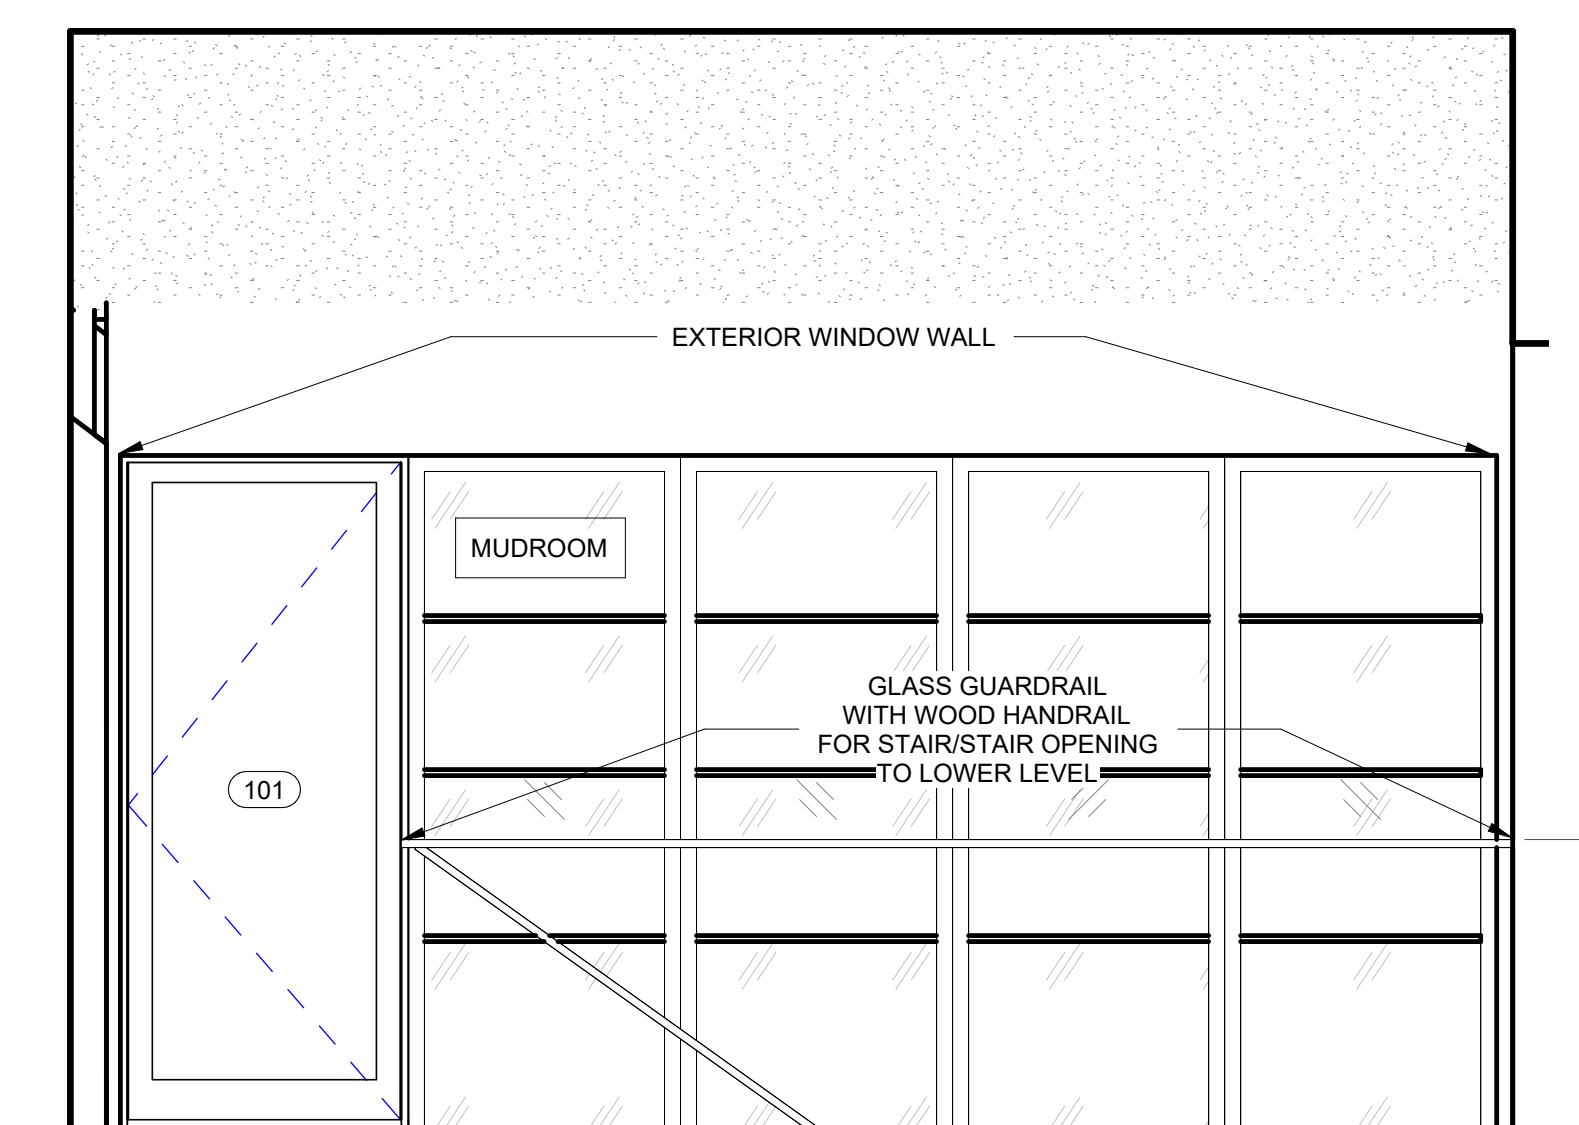

7 101 MUD HALL - SOUTH ELEVATION
 1/2" = 1'-0"



REVISION HISTORY		
NO.	DESCRIPTION	DATE

PERMIT REVISION


DATE:	AUG 18, 2023
SCALE:	1/2" = 1'-0"
DRAWN BY:	CJ
CHECKED BY:	CR

SHEET TITLE	PROJECT #
	40035


INTERIOR ELEVATIONS

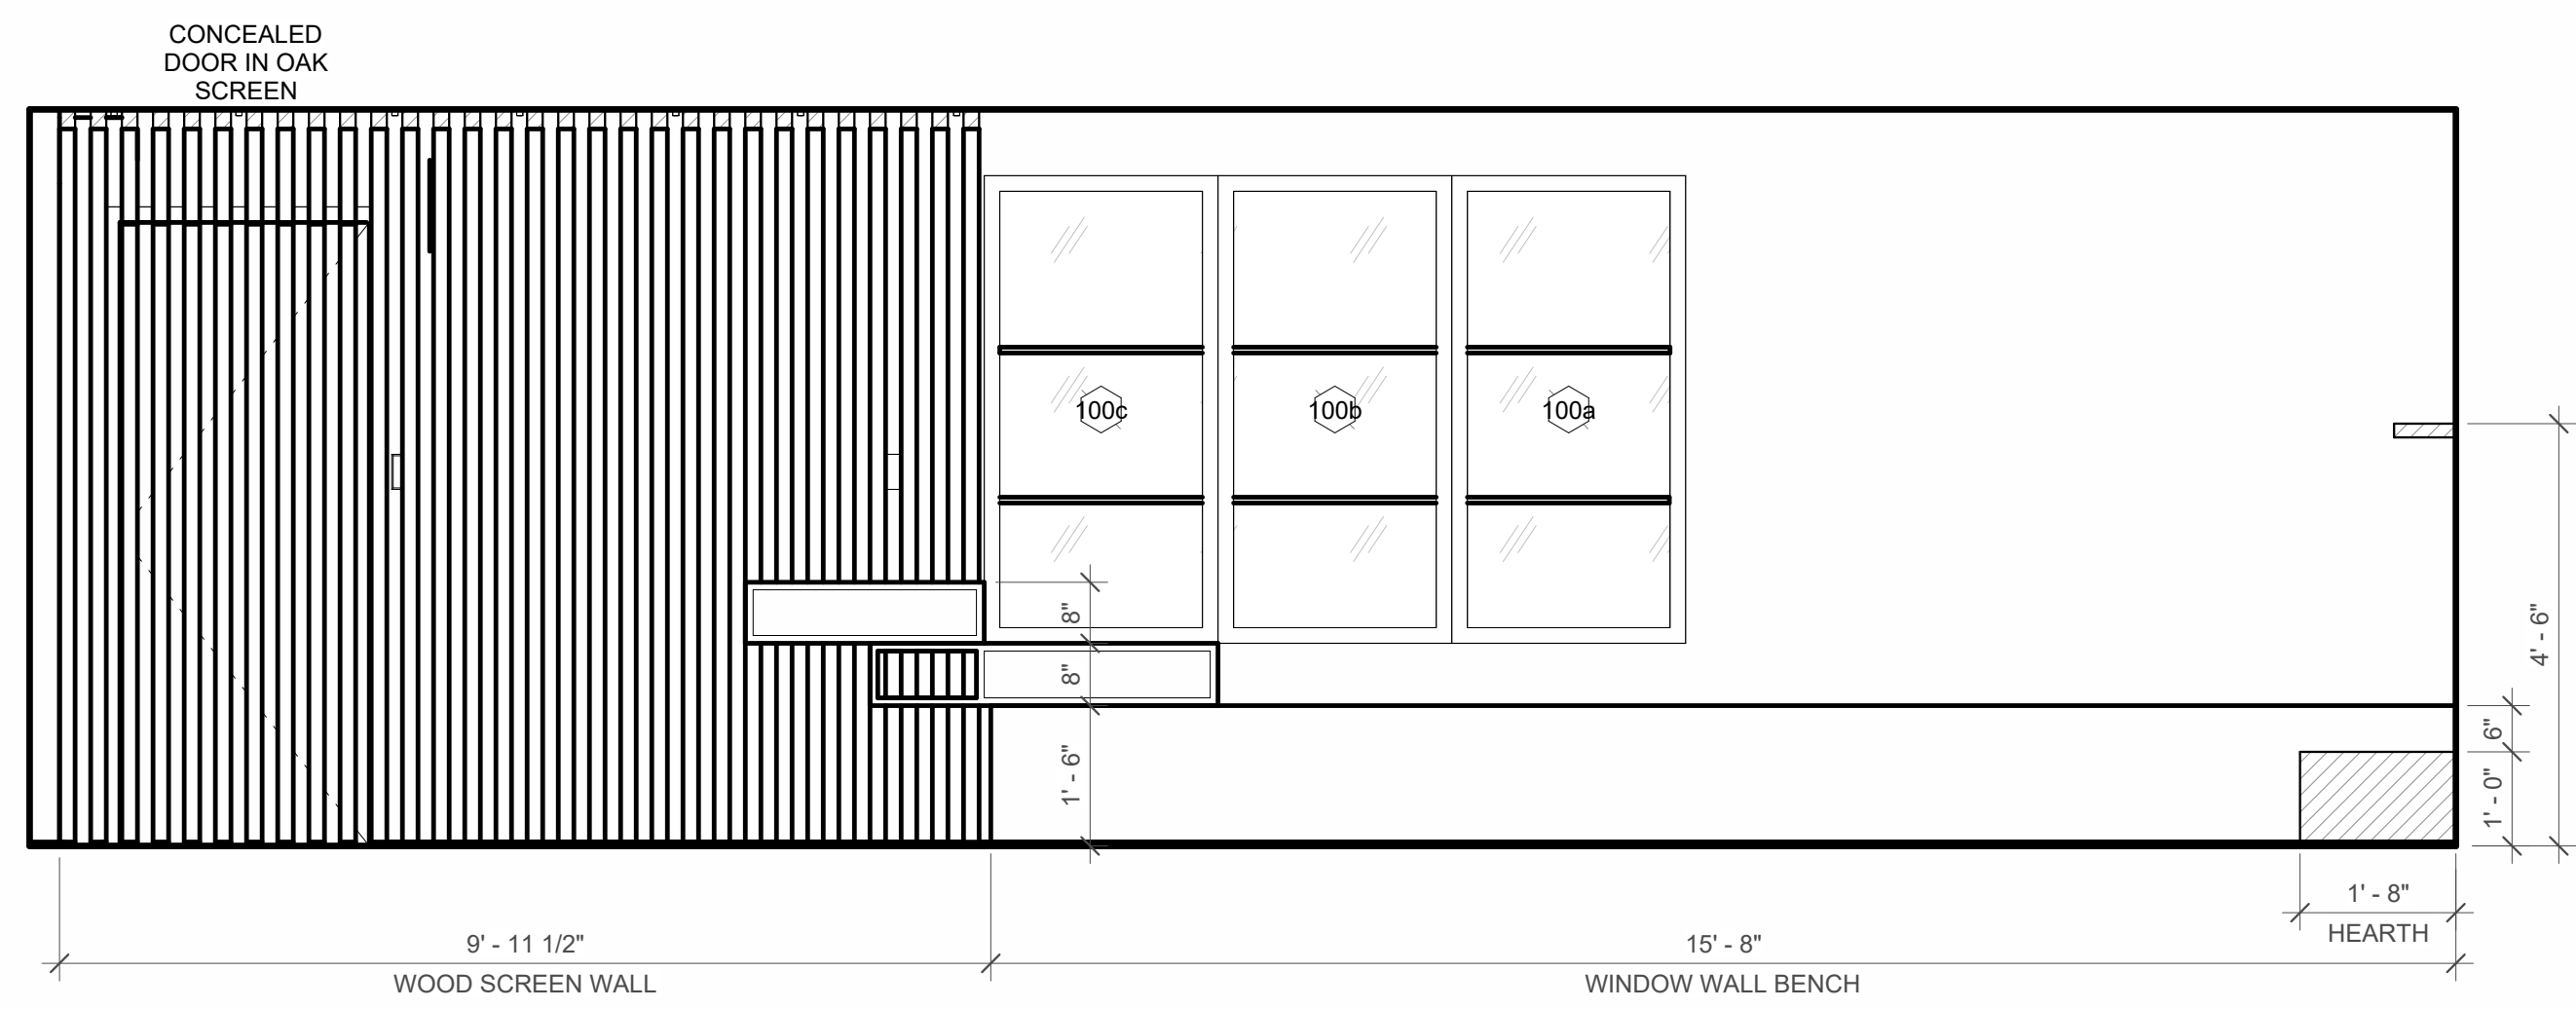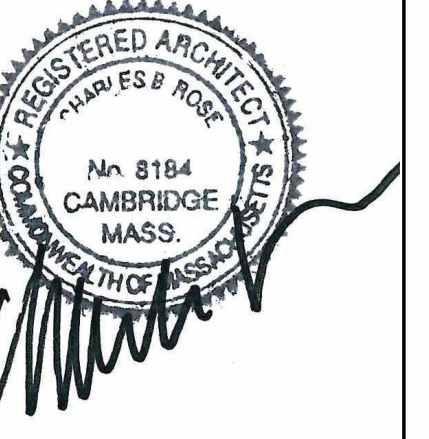


1 106 GREAT ROOM - SOUTH
 1/2" = 1'-0"

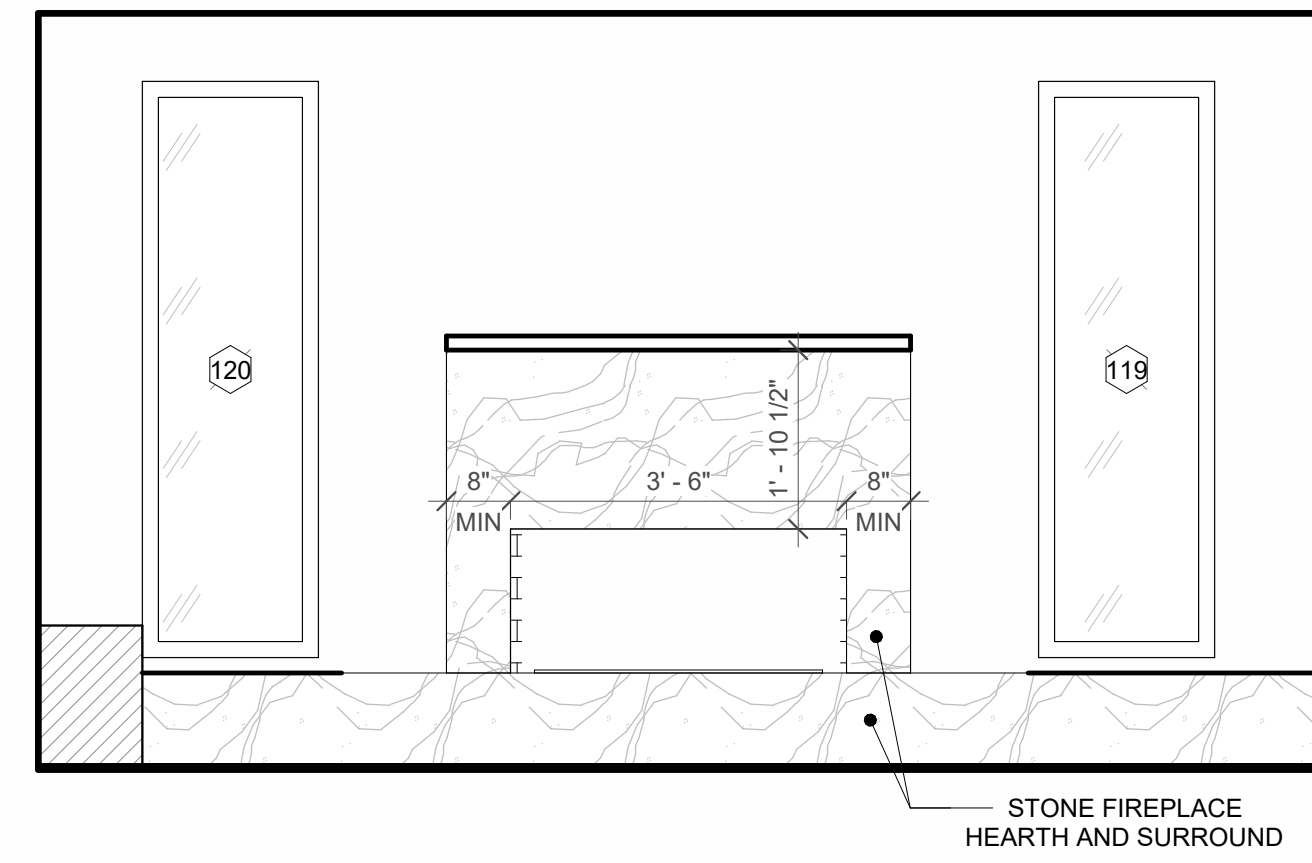


2 106 GREAT ROOM - WEST
 1/2" = 1'-0"

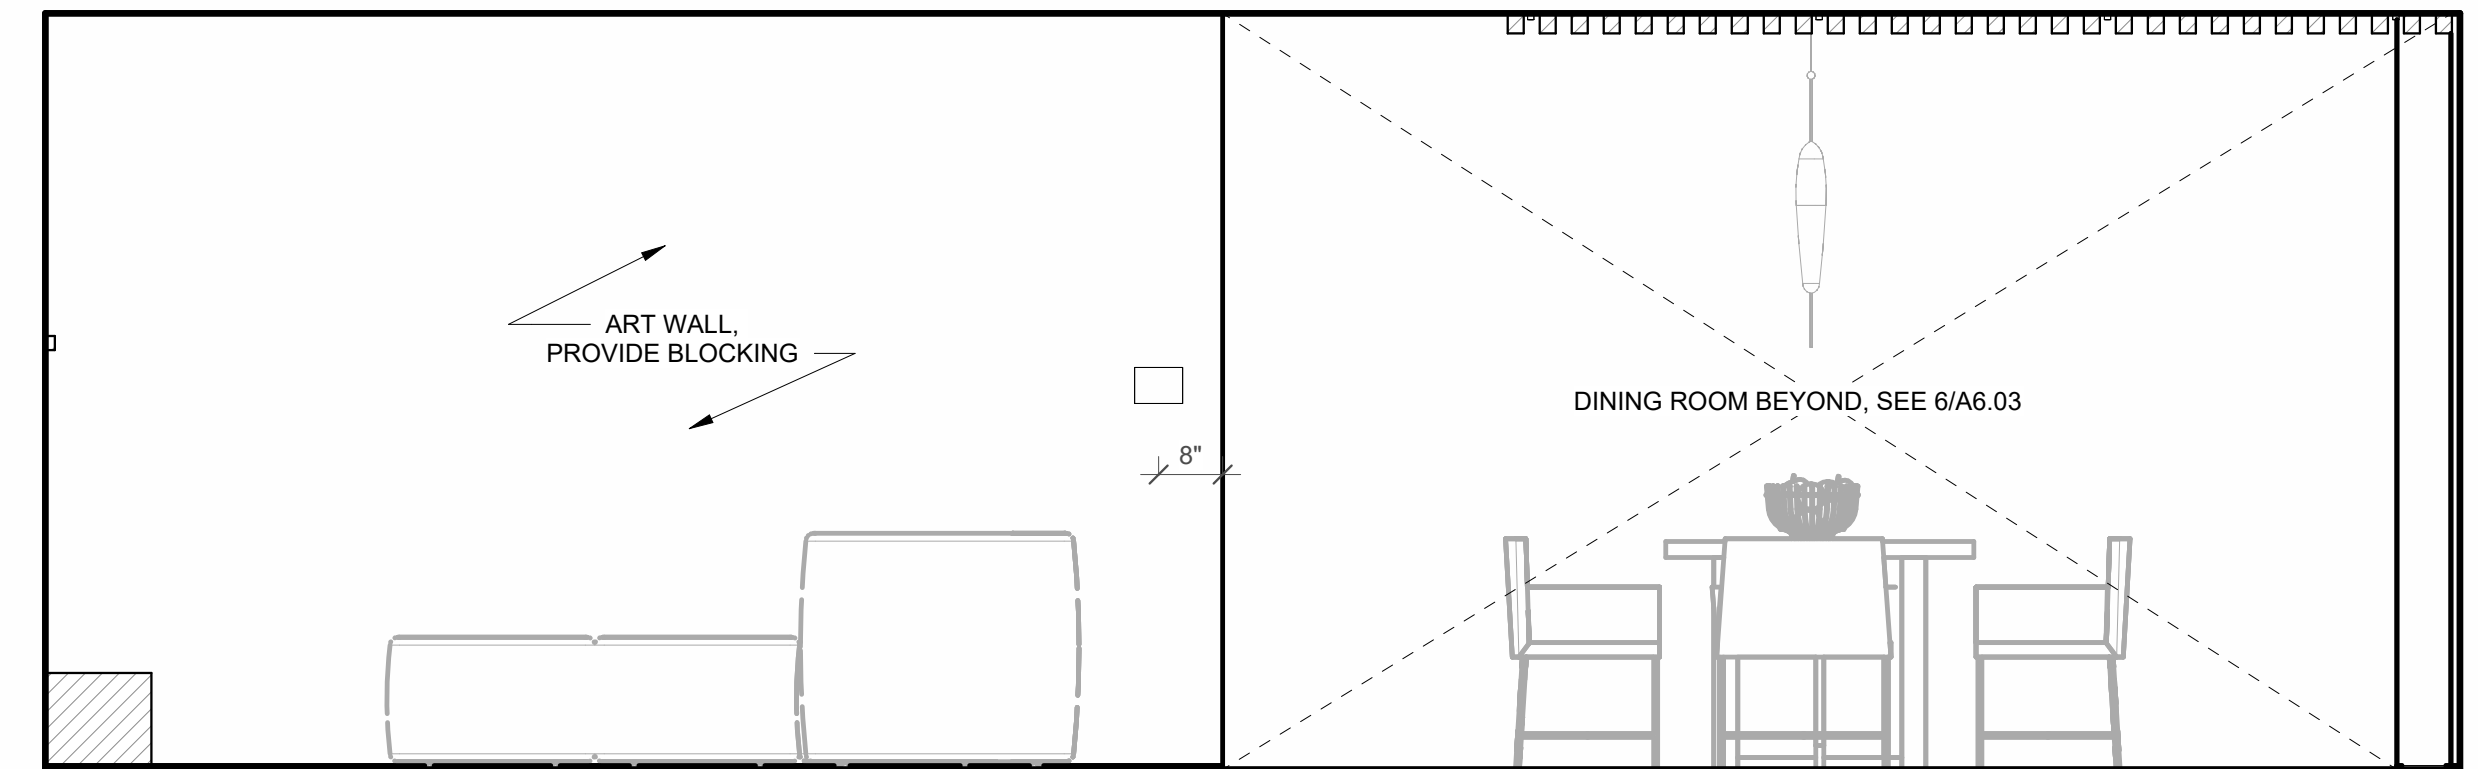


3 106 GREAT ROOM - NORTH
 1/2" = 1'-0"

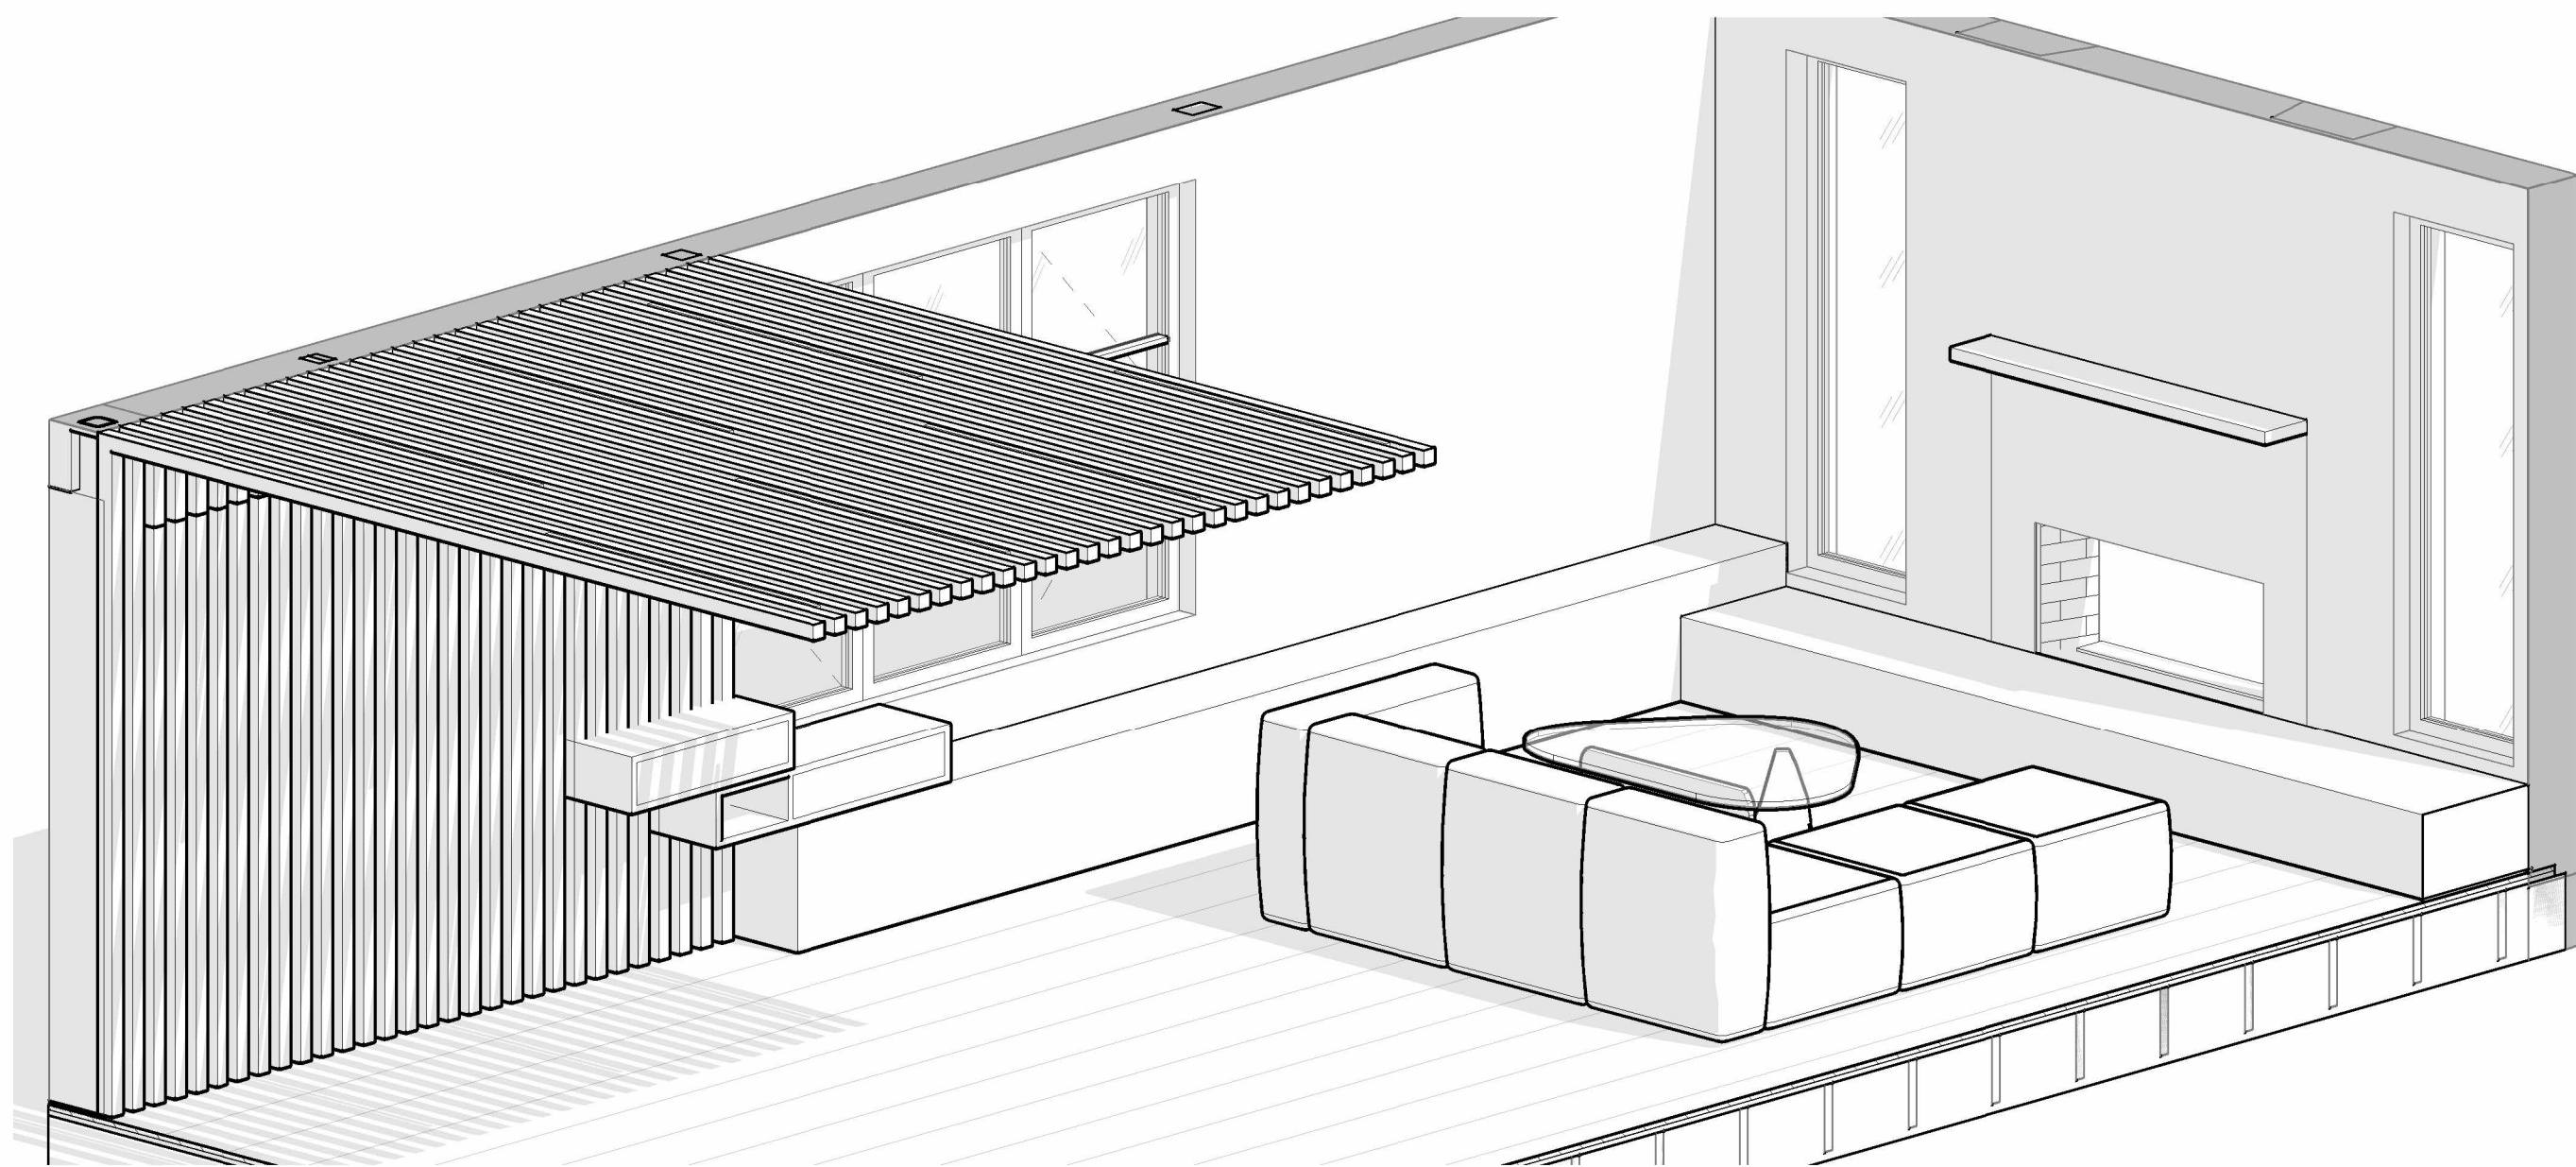


4 106 GREAT ROOM - ORTHOGRAPHIC VIEW B

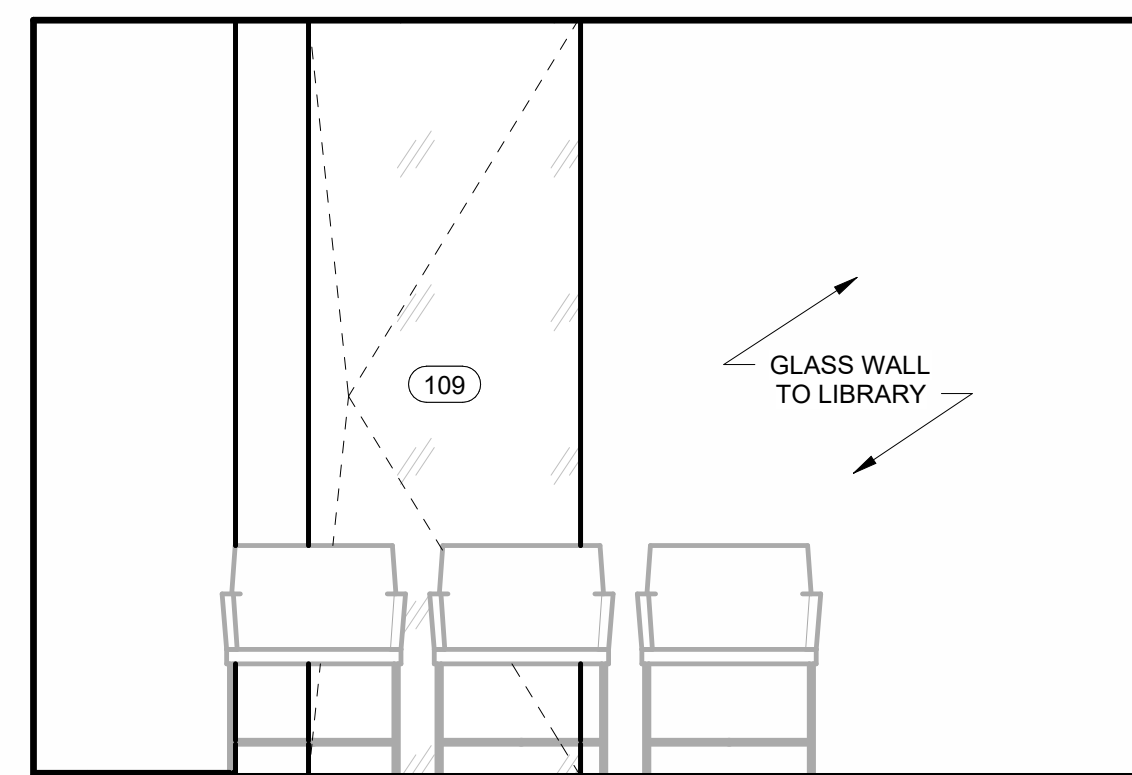


5 108 DINING - WEST
 1/2" = 1'-0"

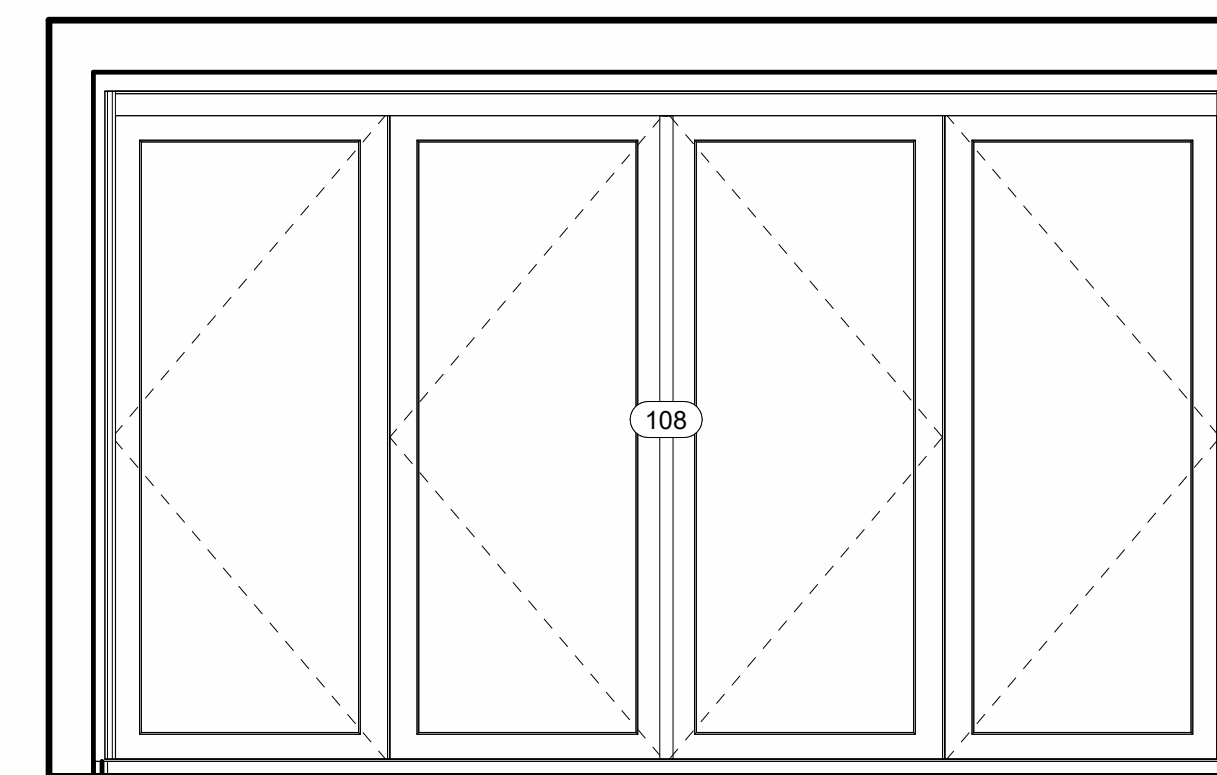


6 108 DINING - NORTH
 1/2" = 1'-0"

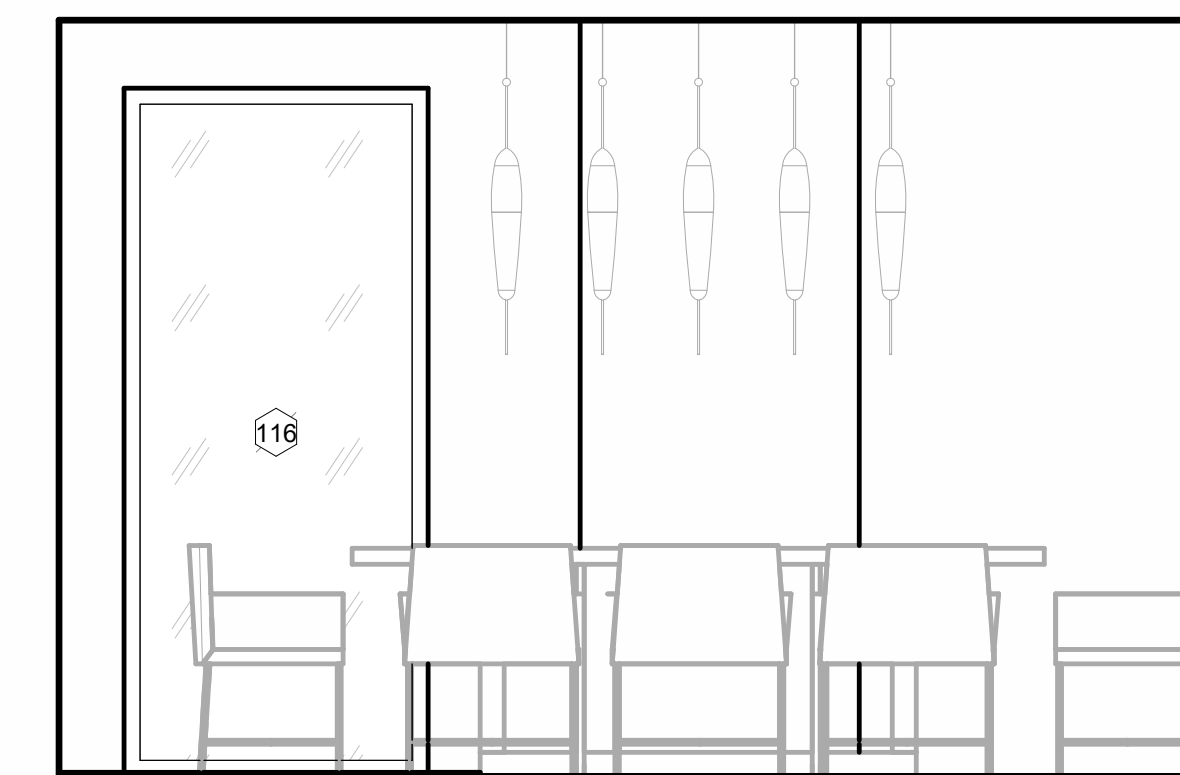


7 108 DINING - EAST
 1/2" = 1'-0"

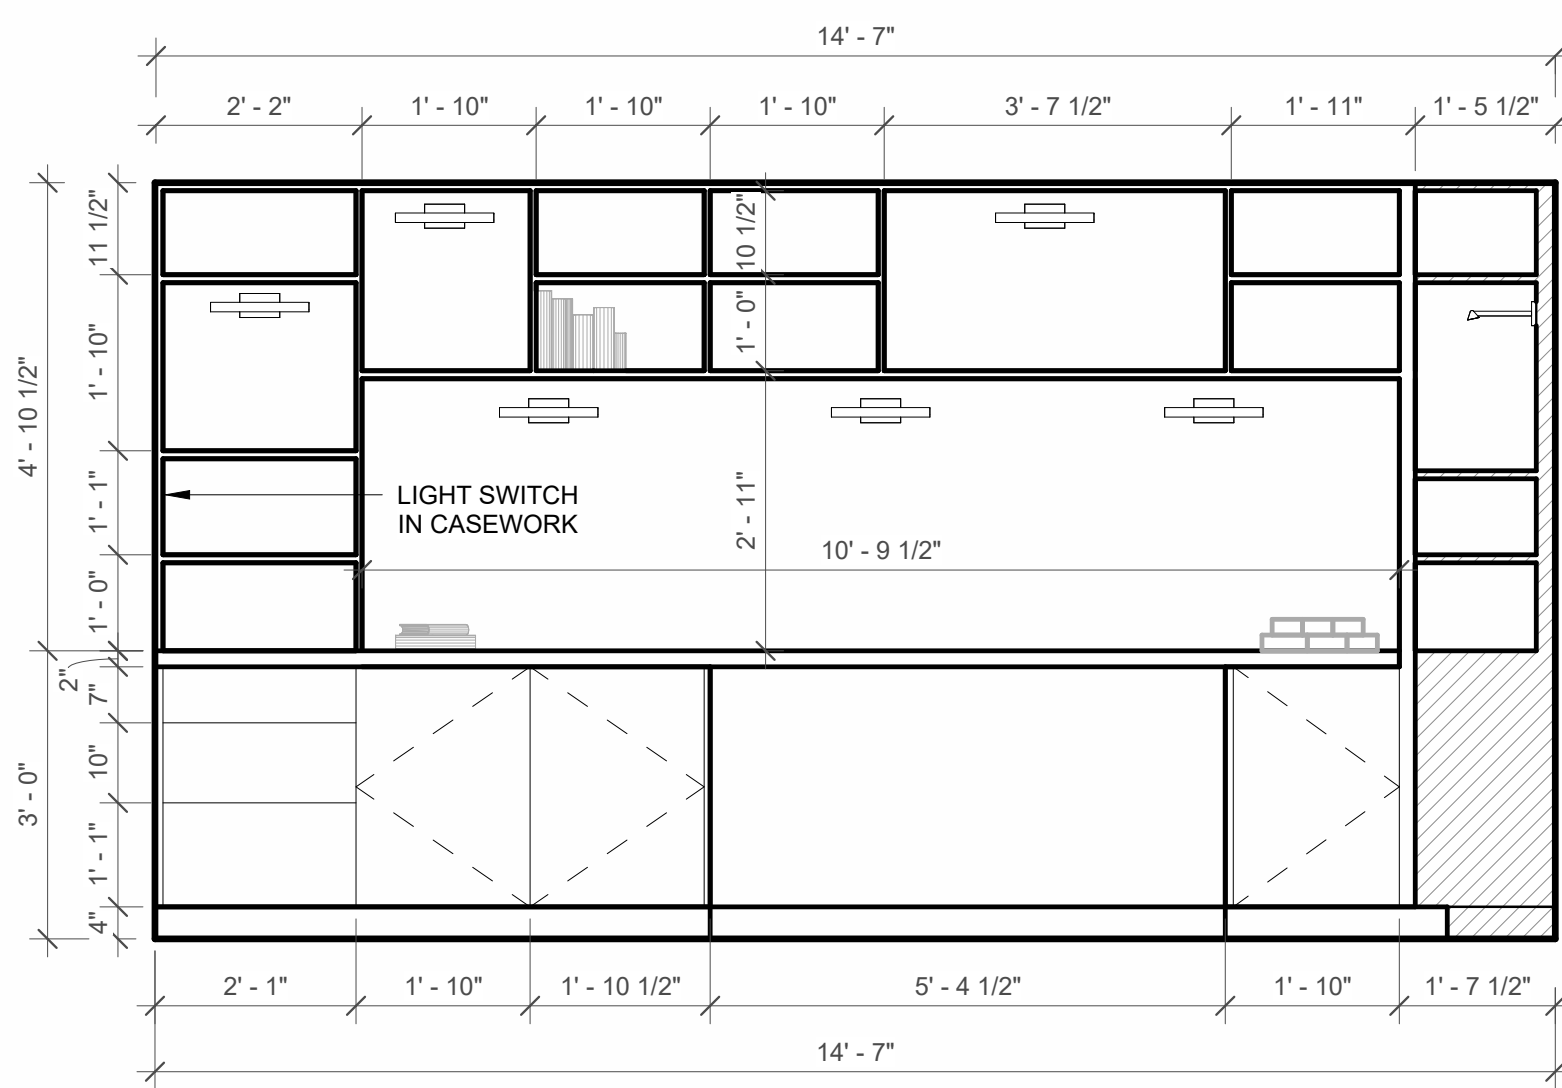


8 109 LIBRARY - SOUTH
 1/2" = 1'-0"

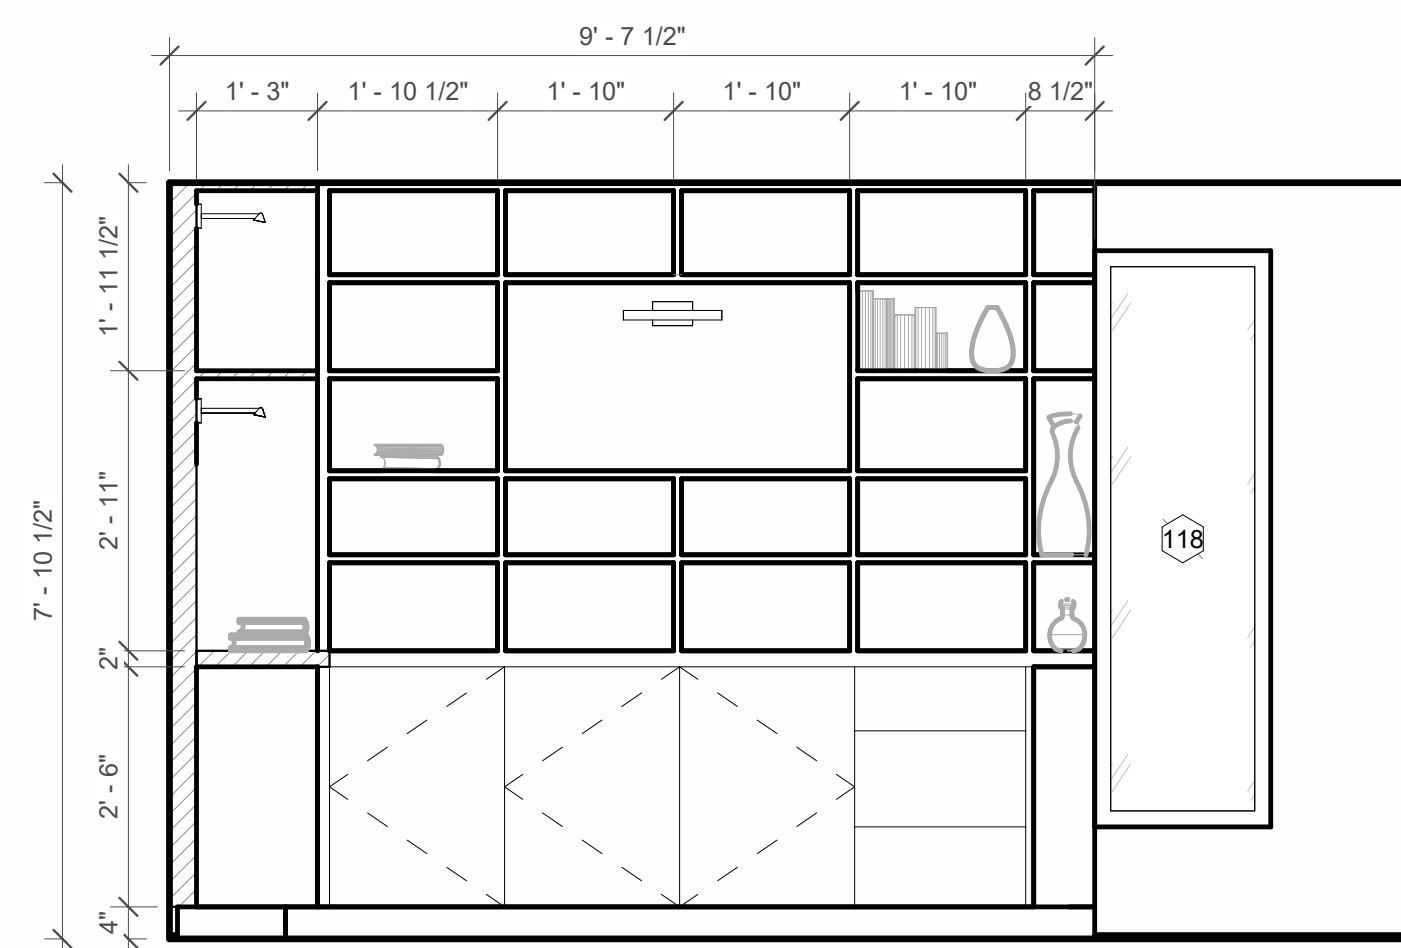

9 109 LIBRARY - WEST
 1/2" = 1'-0"

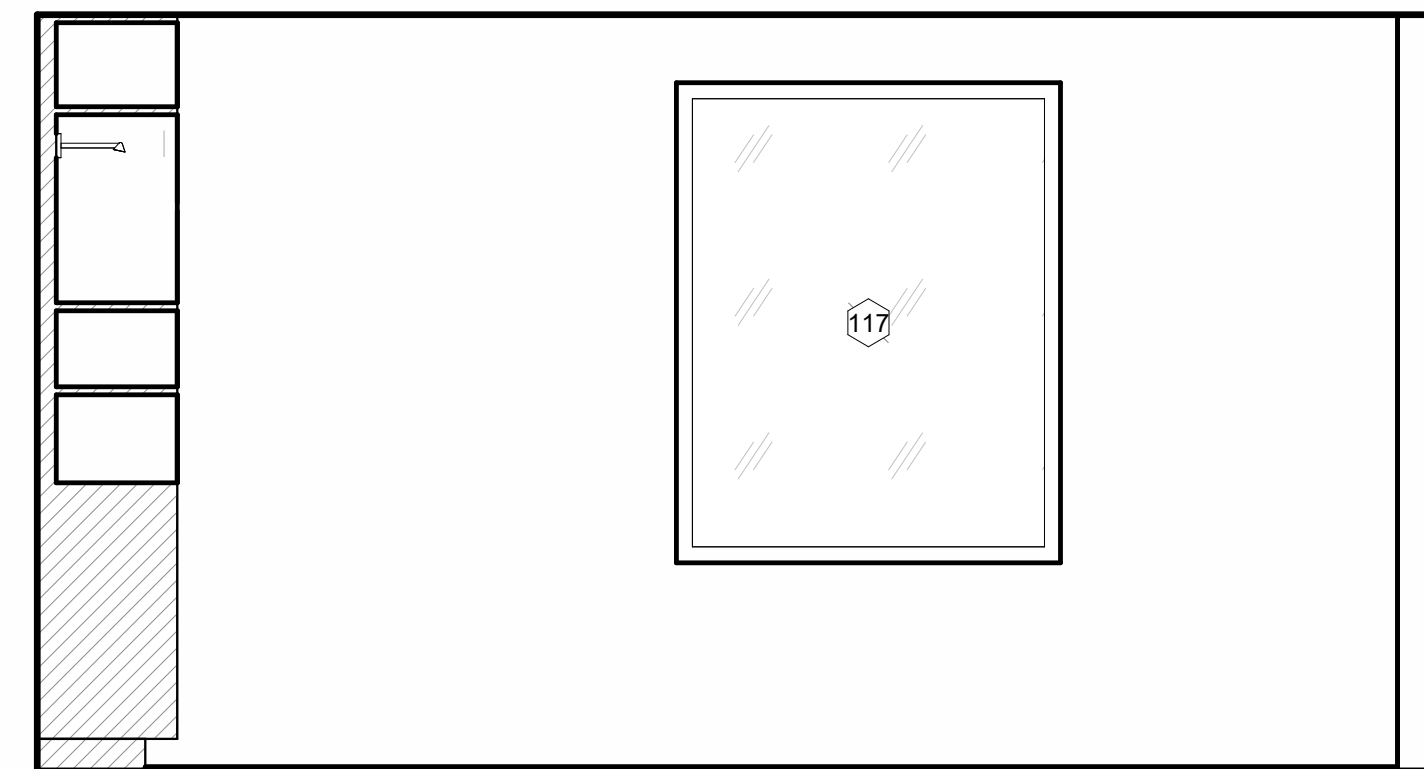

10 109 LIBRARY - NORTH
 1/2" = 1'-0"

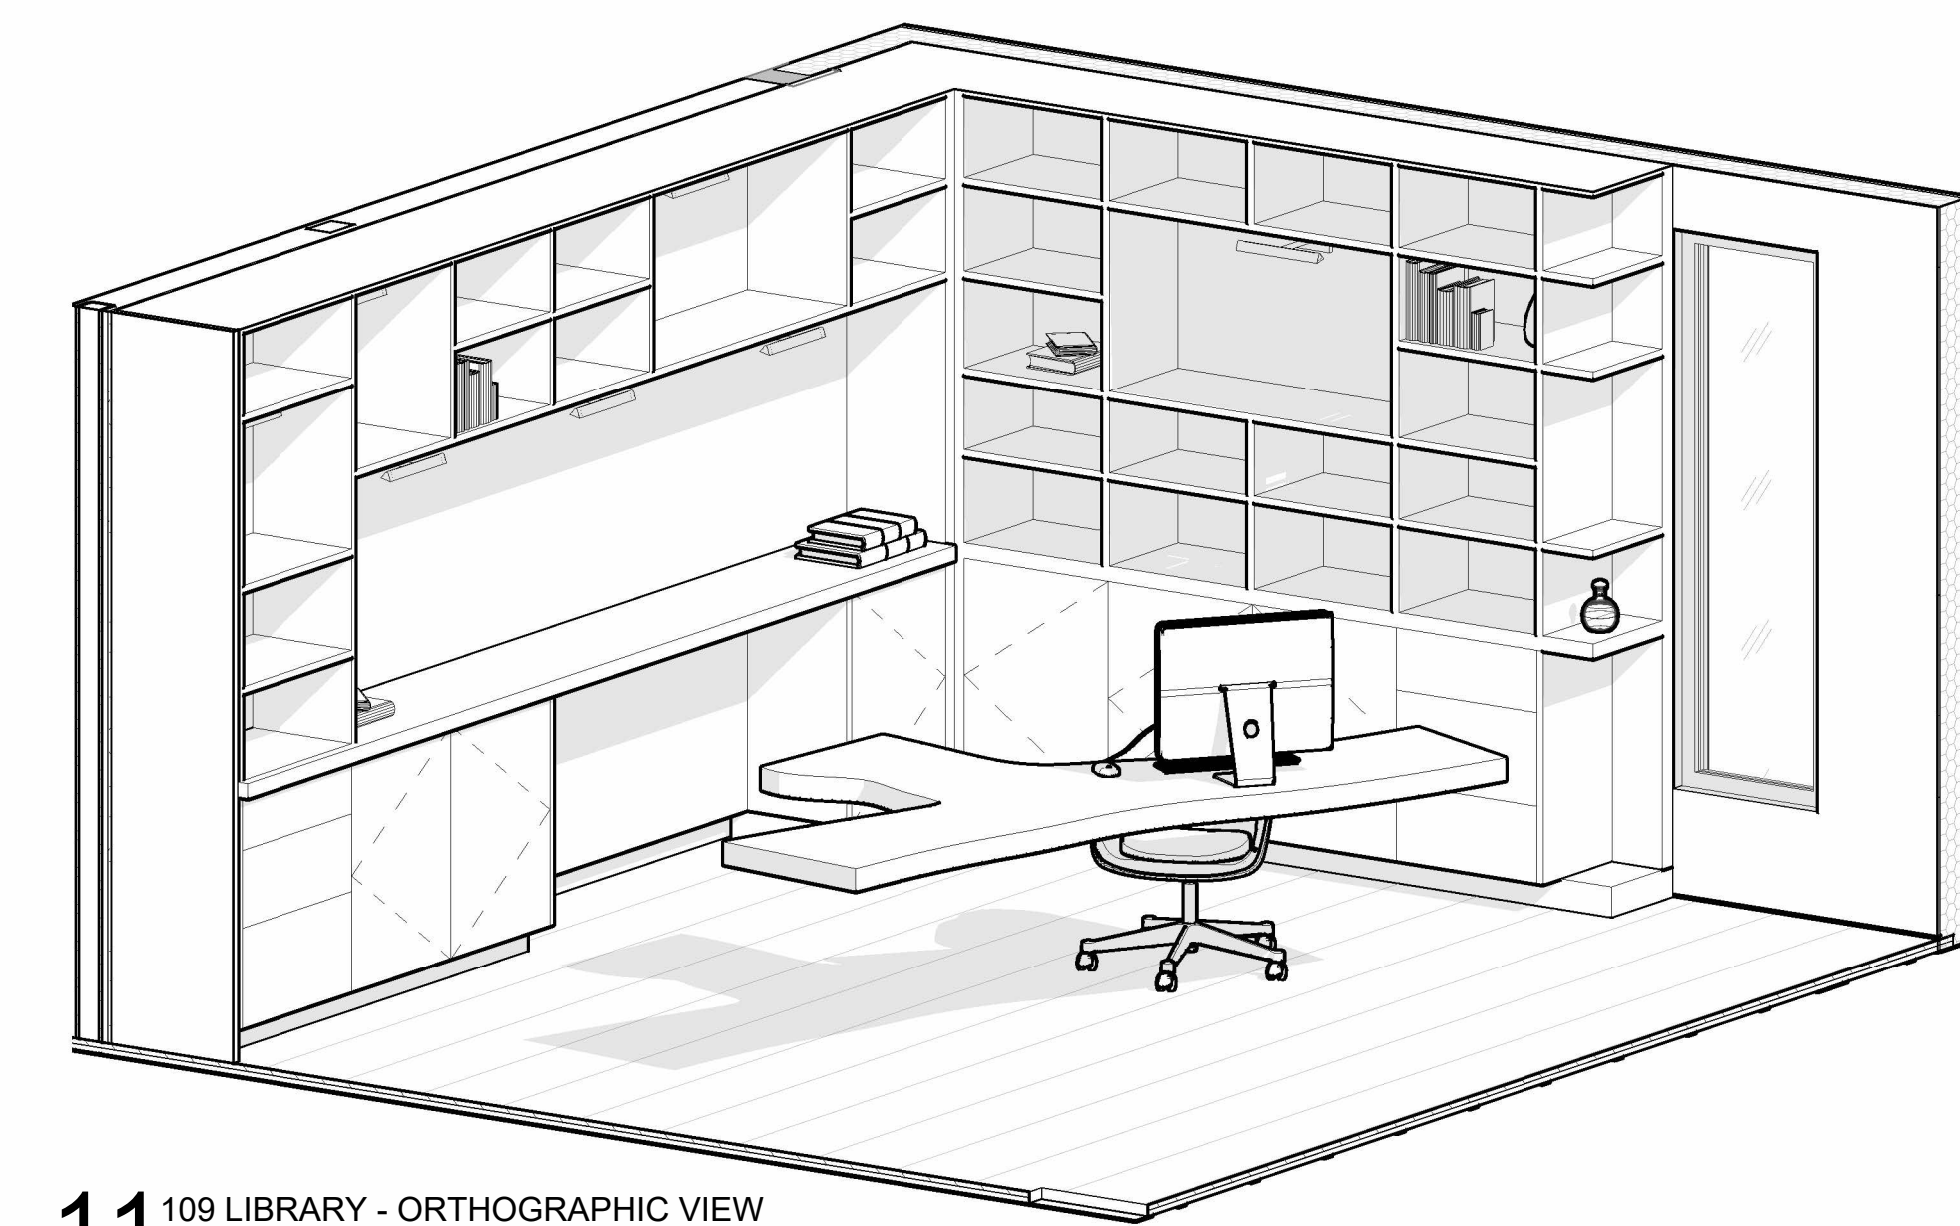

11 109 LIBRARY - ORTHOGRAPHIC VIEW



REVISION HISTORY		
NO.	DESCRIPTION	DATE

PERMIT REVISION


DATE:	AUG 18, 2023
SCALE:	1/2" = 1'-0"
DRAWN BY:	CJ
CHECKED BY:	CR

SHEET TITLE	PROJECT #
	40035


INTERIOR ELEVATIONS

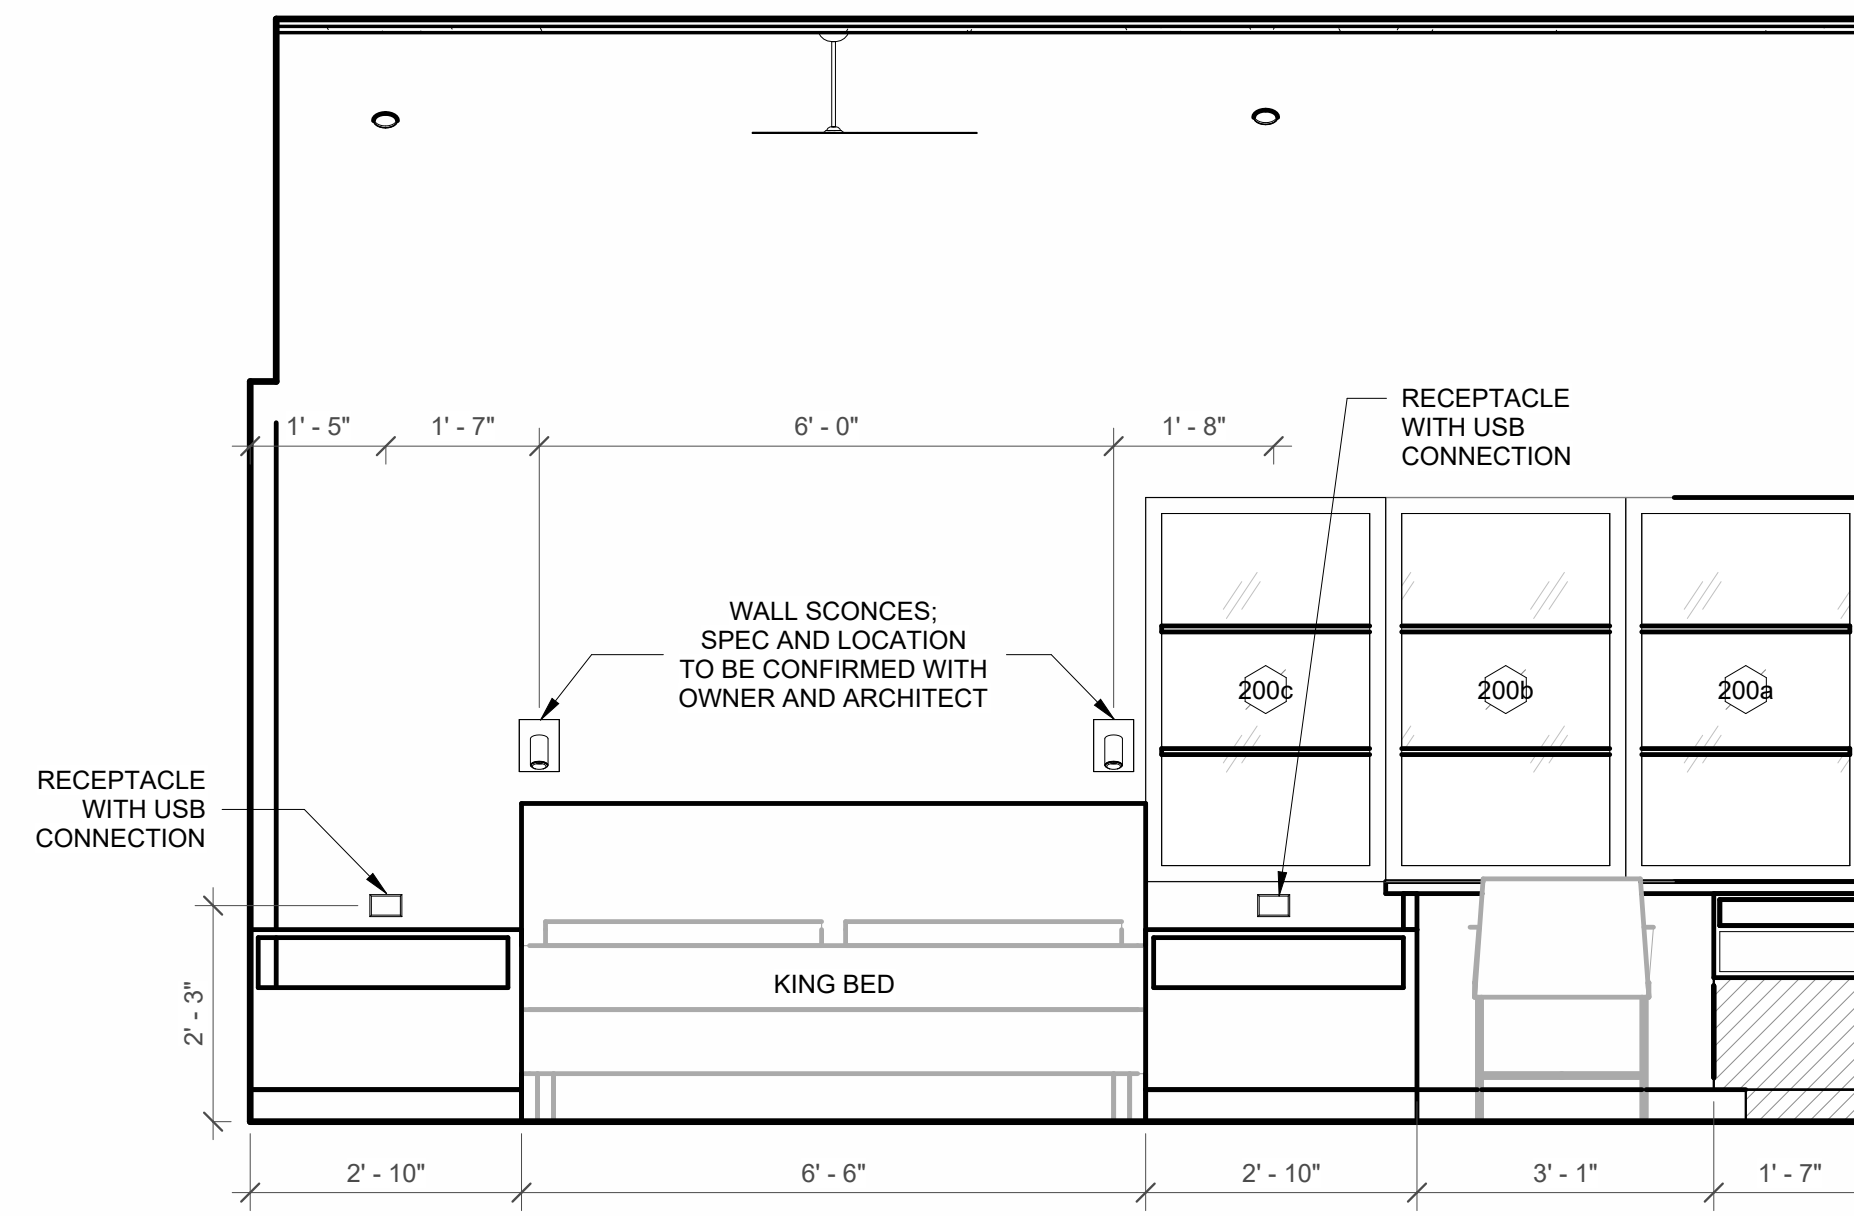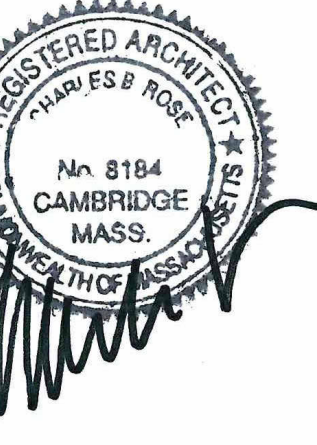


1 201 PRIMARY BED - SOUTH ELEVATION
 1/2" = 1'-0"

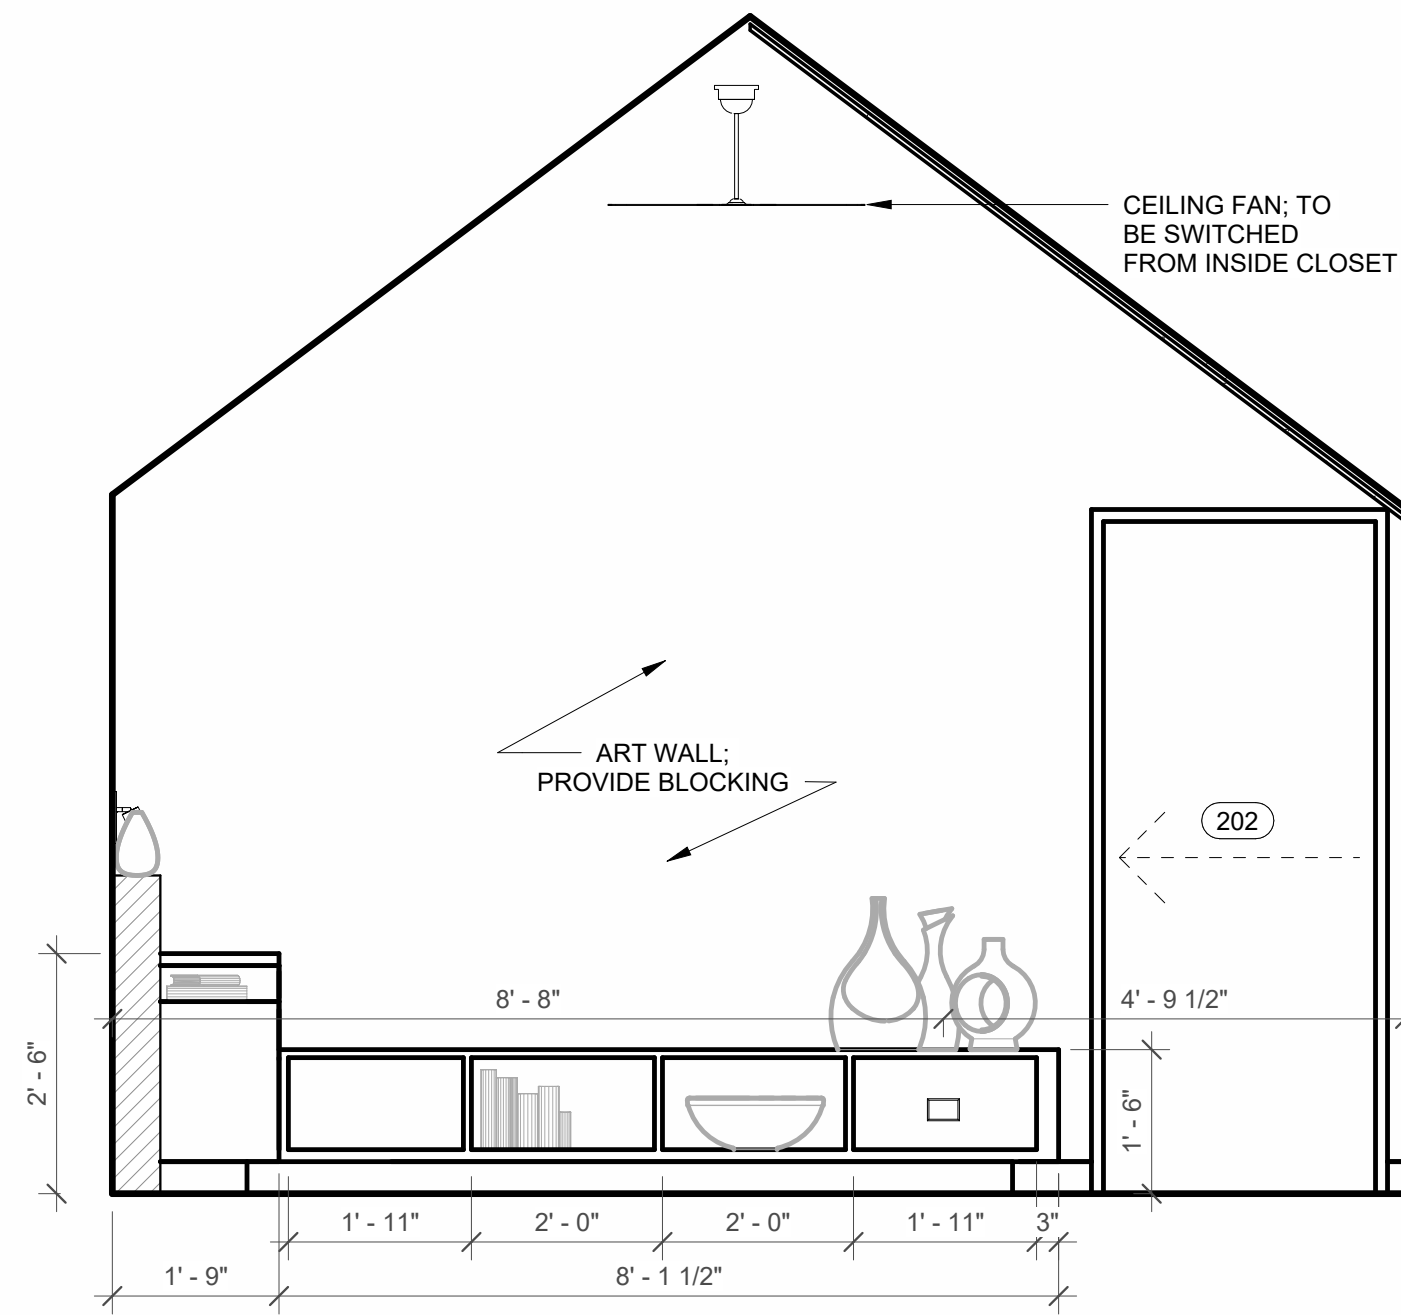


2 201 PRIMARY BED - WEST ELEVATION
 1/2" = 1'-0"

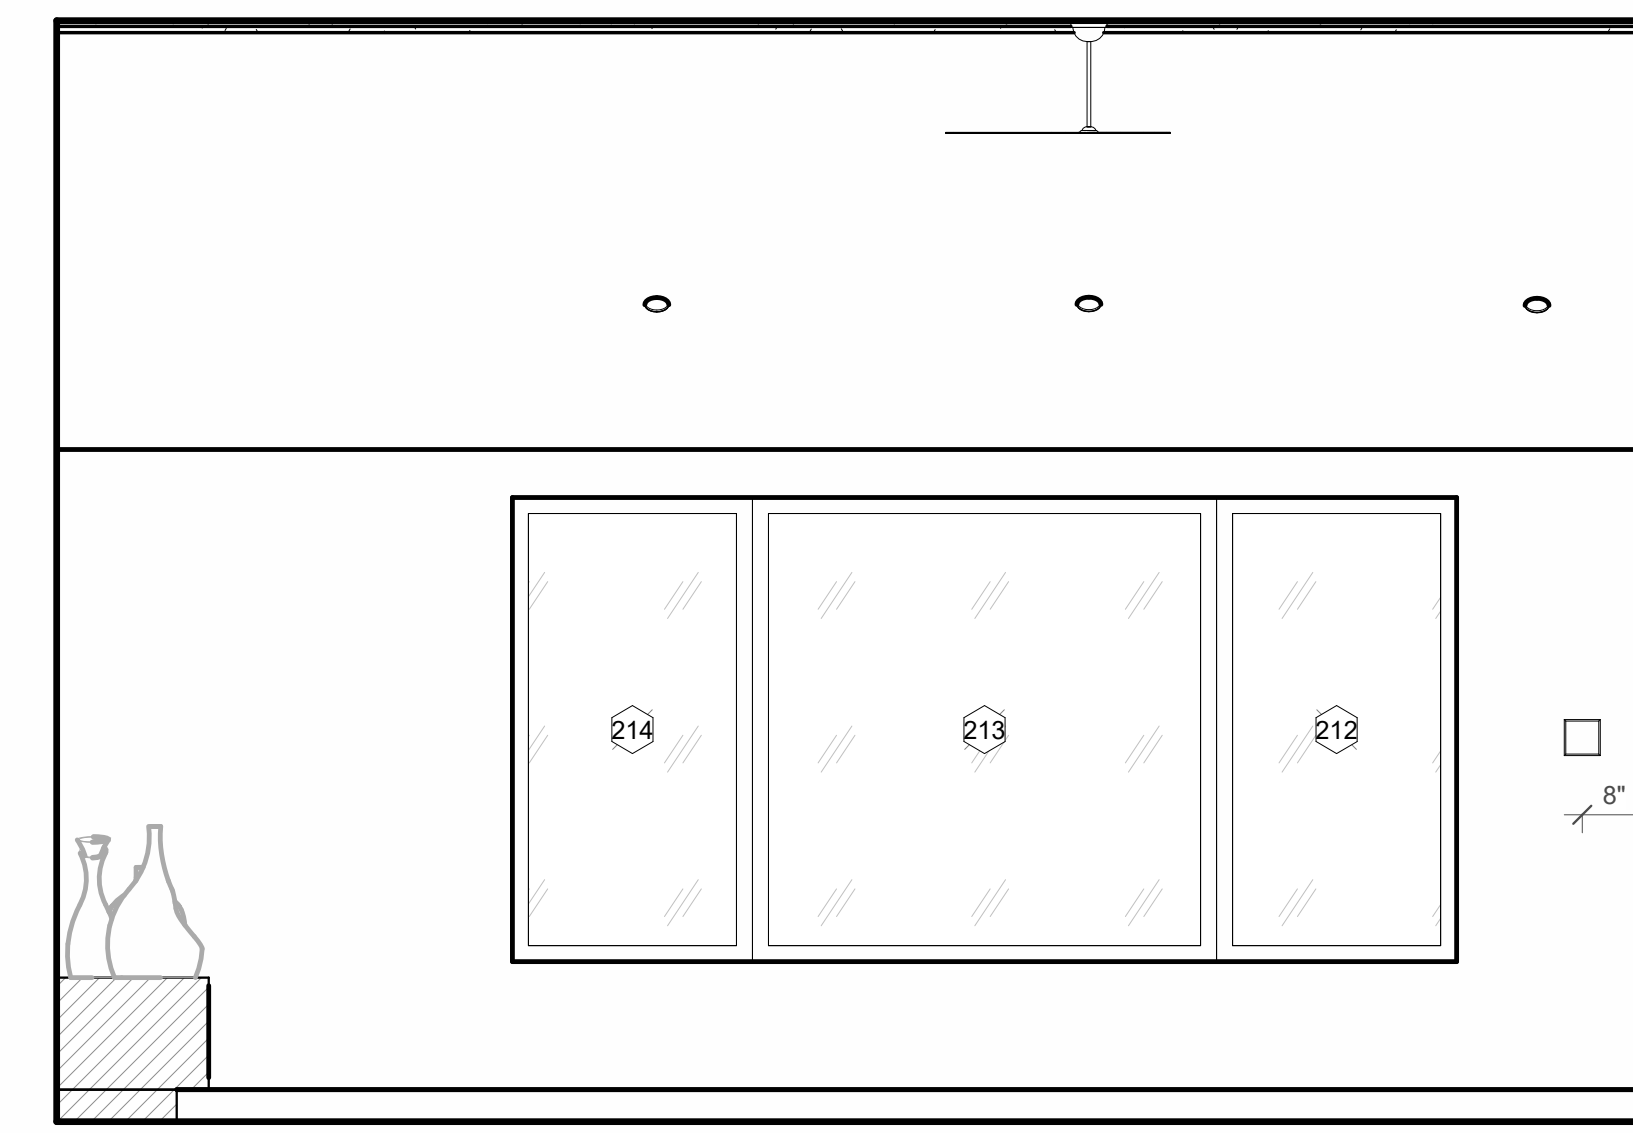


3 201 PRIMARY BED - NORTH ELEVATION
 1/2" = 1'-0"

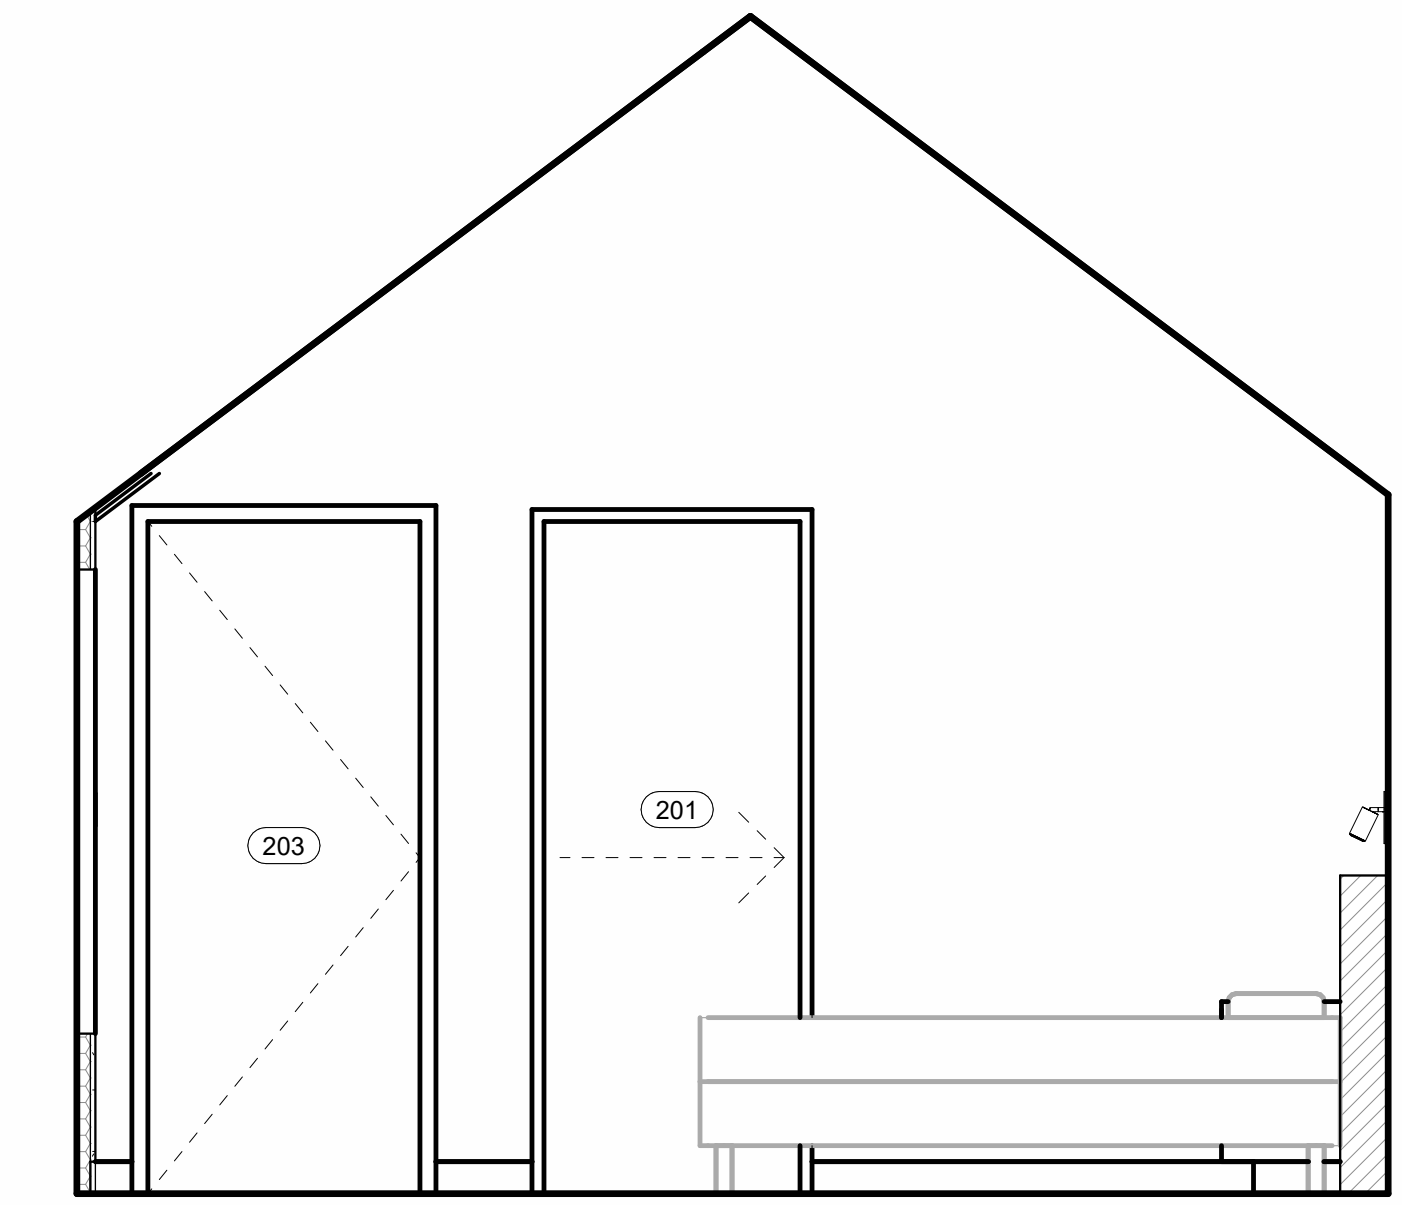


4 201 PRIMARY BED - EAST ELEVATION
 1/2" = 1'-0"

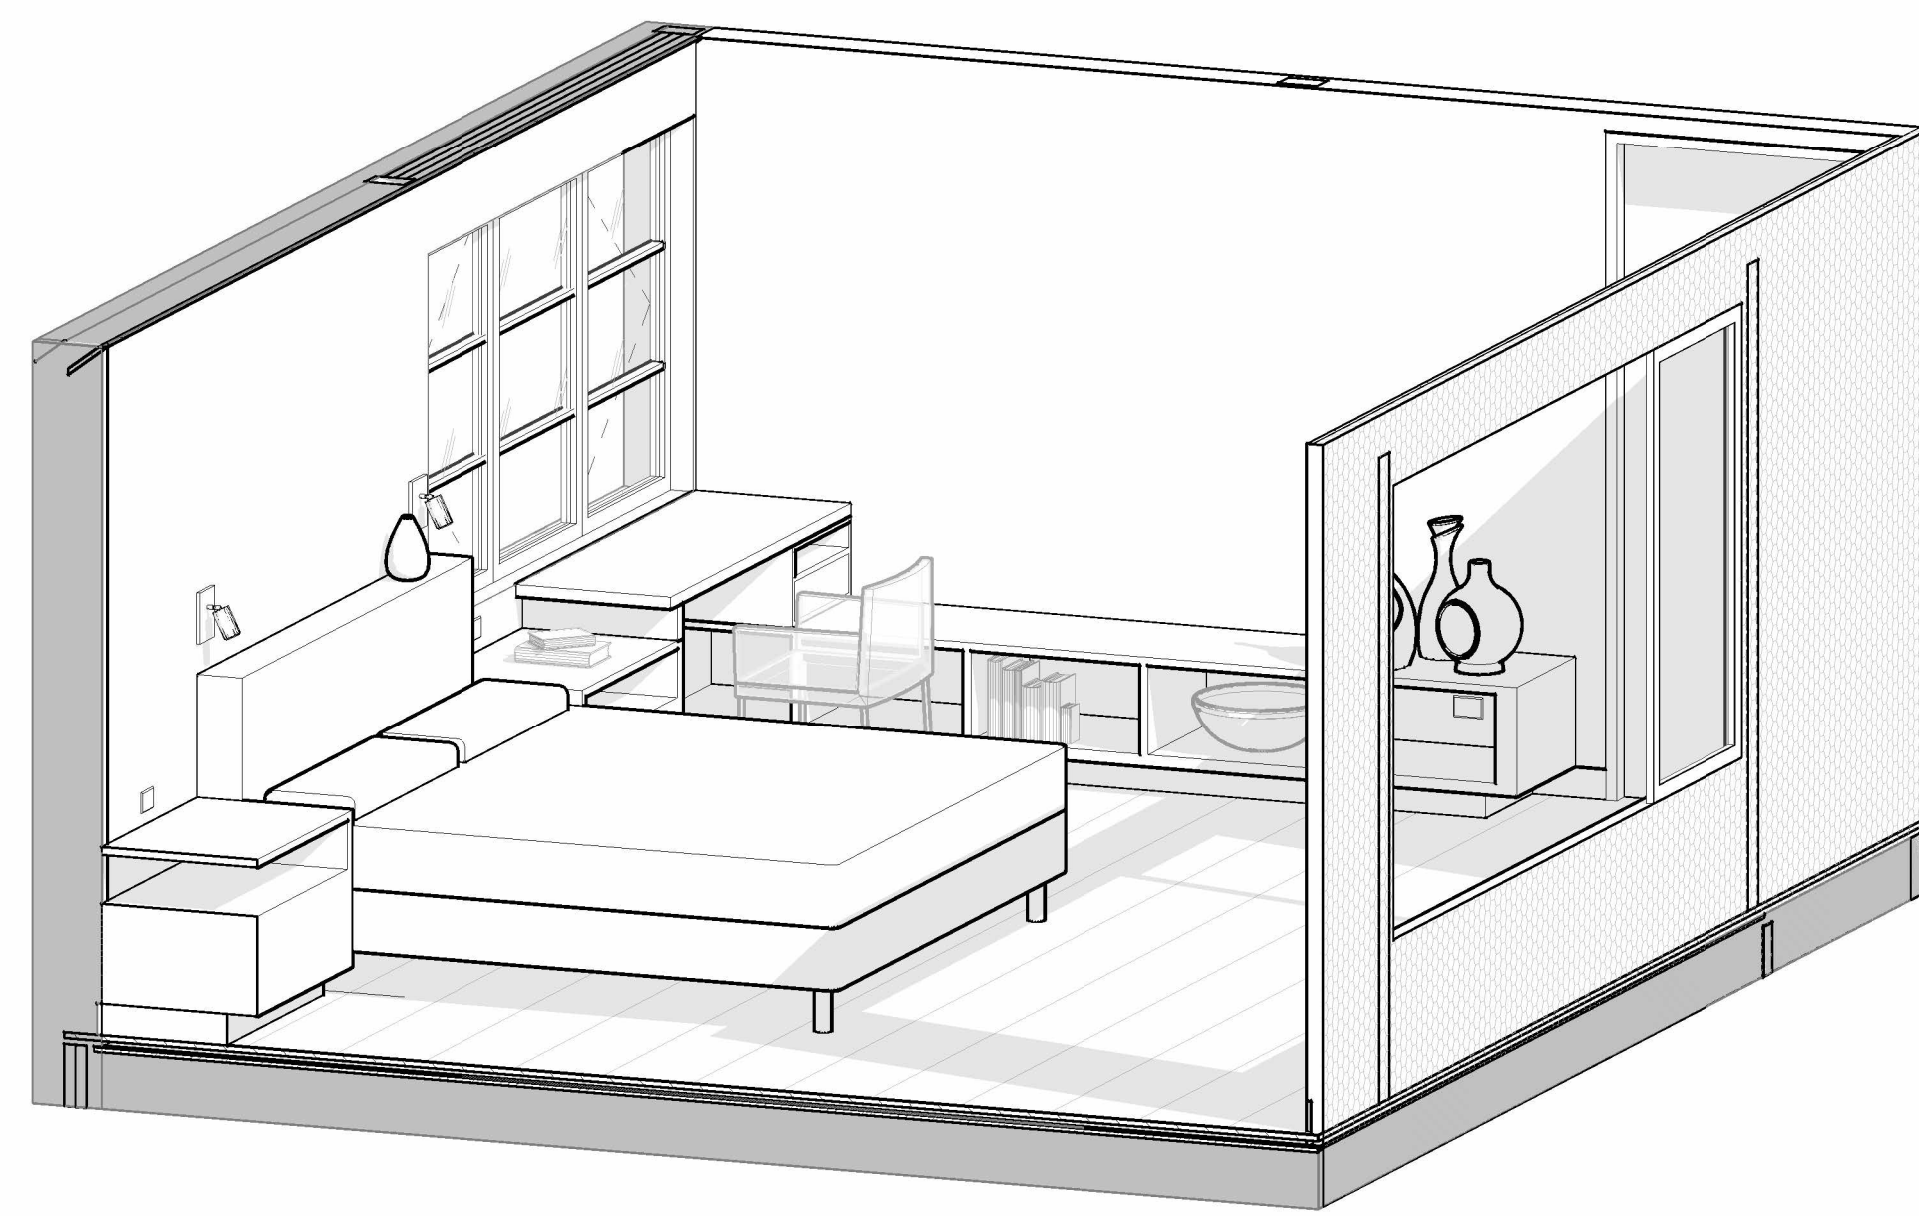


5 201 PRIMARY BEDROOM - ORTHOGRAPHIC VIEW A

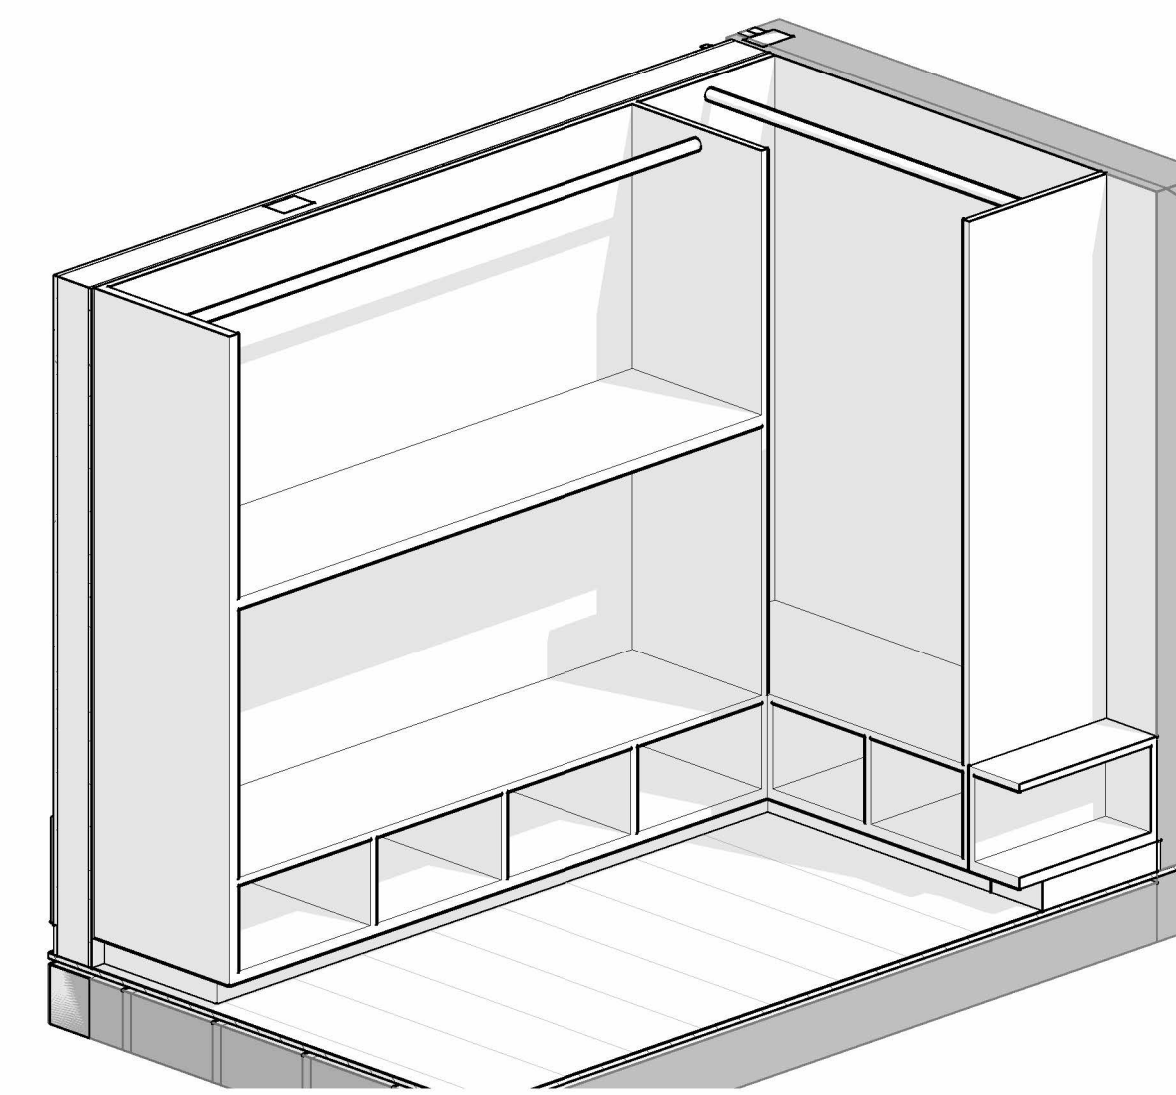


6 202 PRIMARY CLOSET - ORTHOGRAPHIC VIEW A

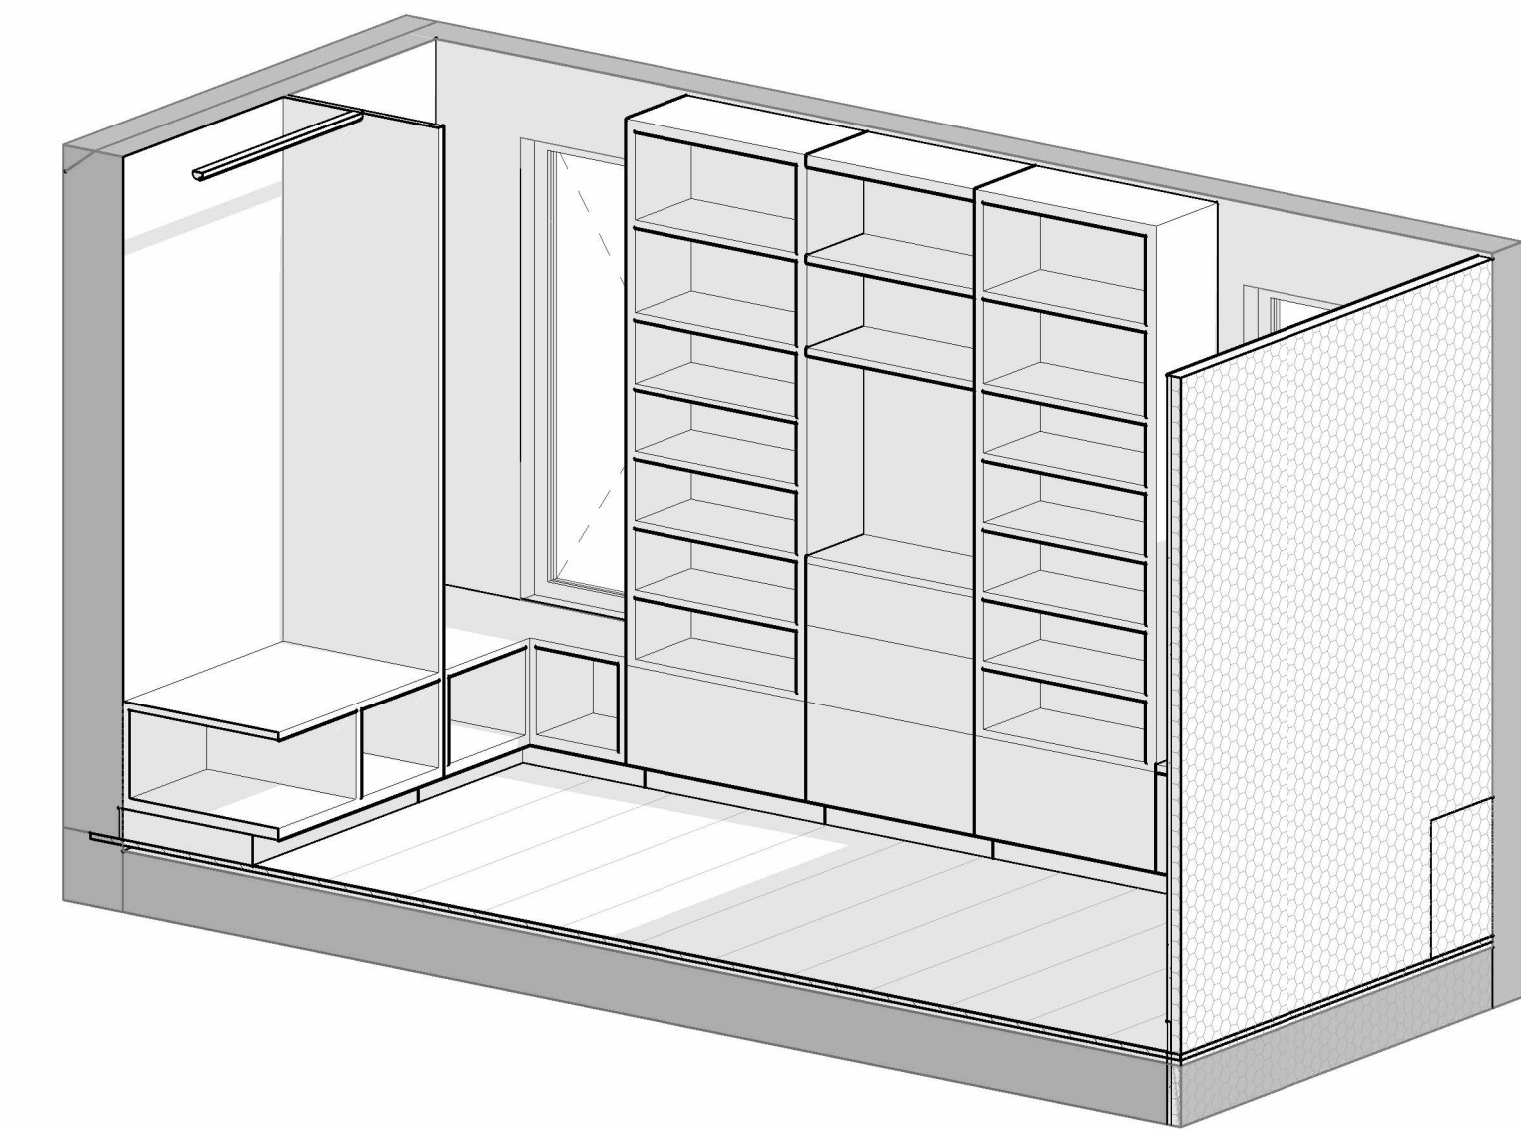


7 202 PRIMARY CLOSET - ORTHOGRAPHIC VIEW B

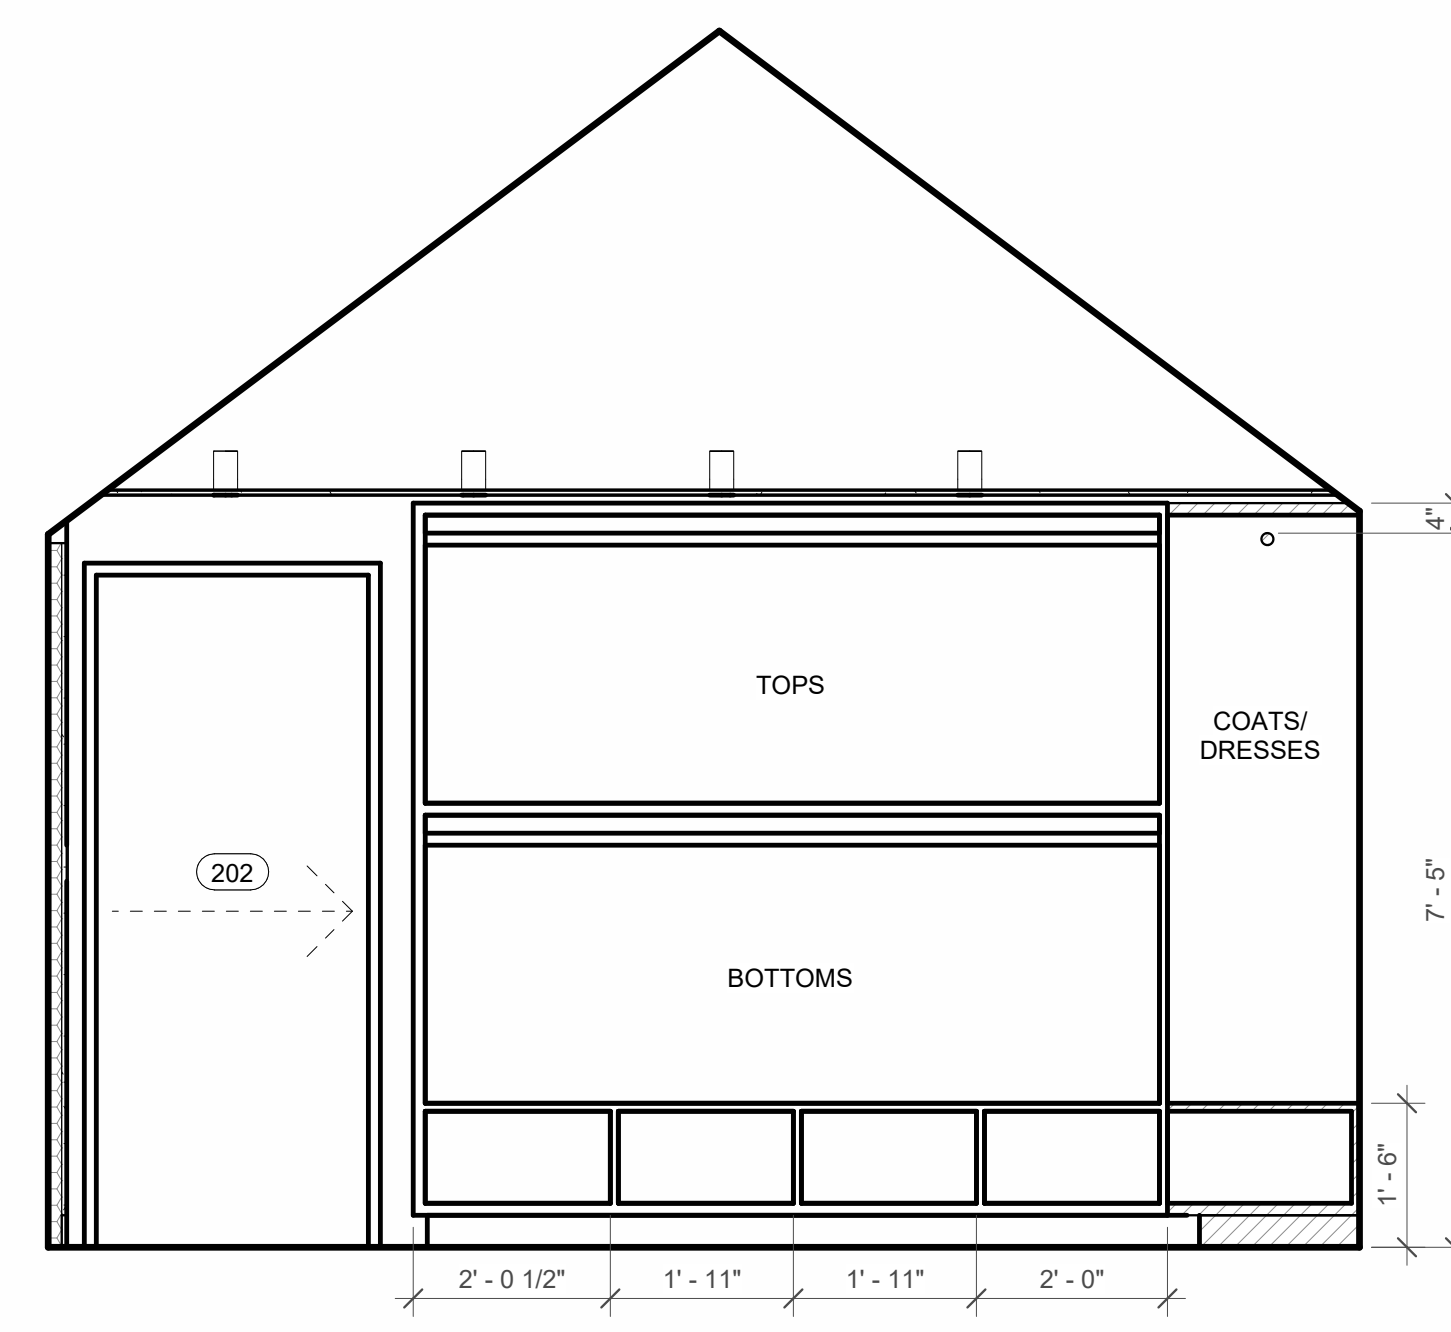


8 202 PRIMARY CLOSET - EAST ELEVATION
 1/2" = 1'-0"

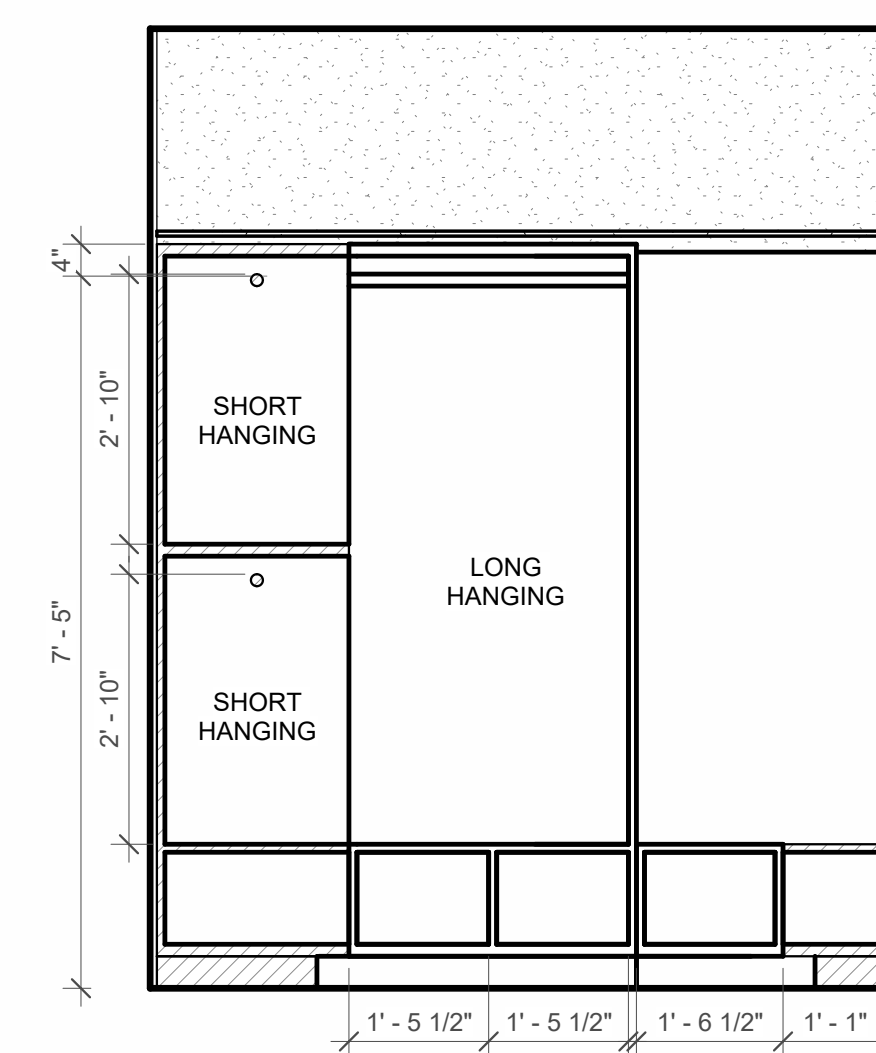


9 202 PRIMARY CLOSET - SOUTH ELEVATION
 1/2" = 1'-0"

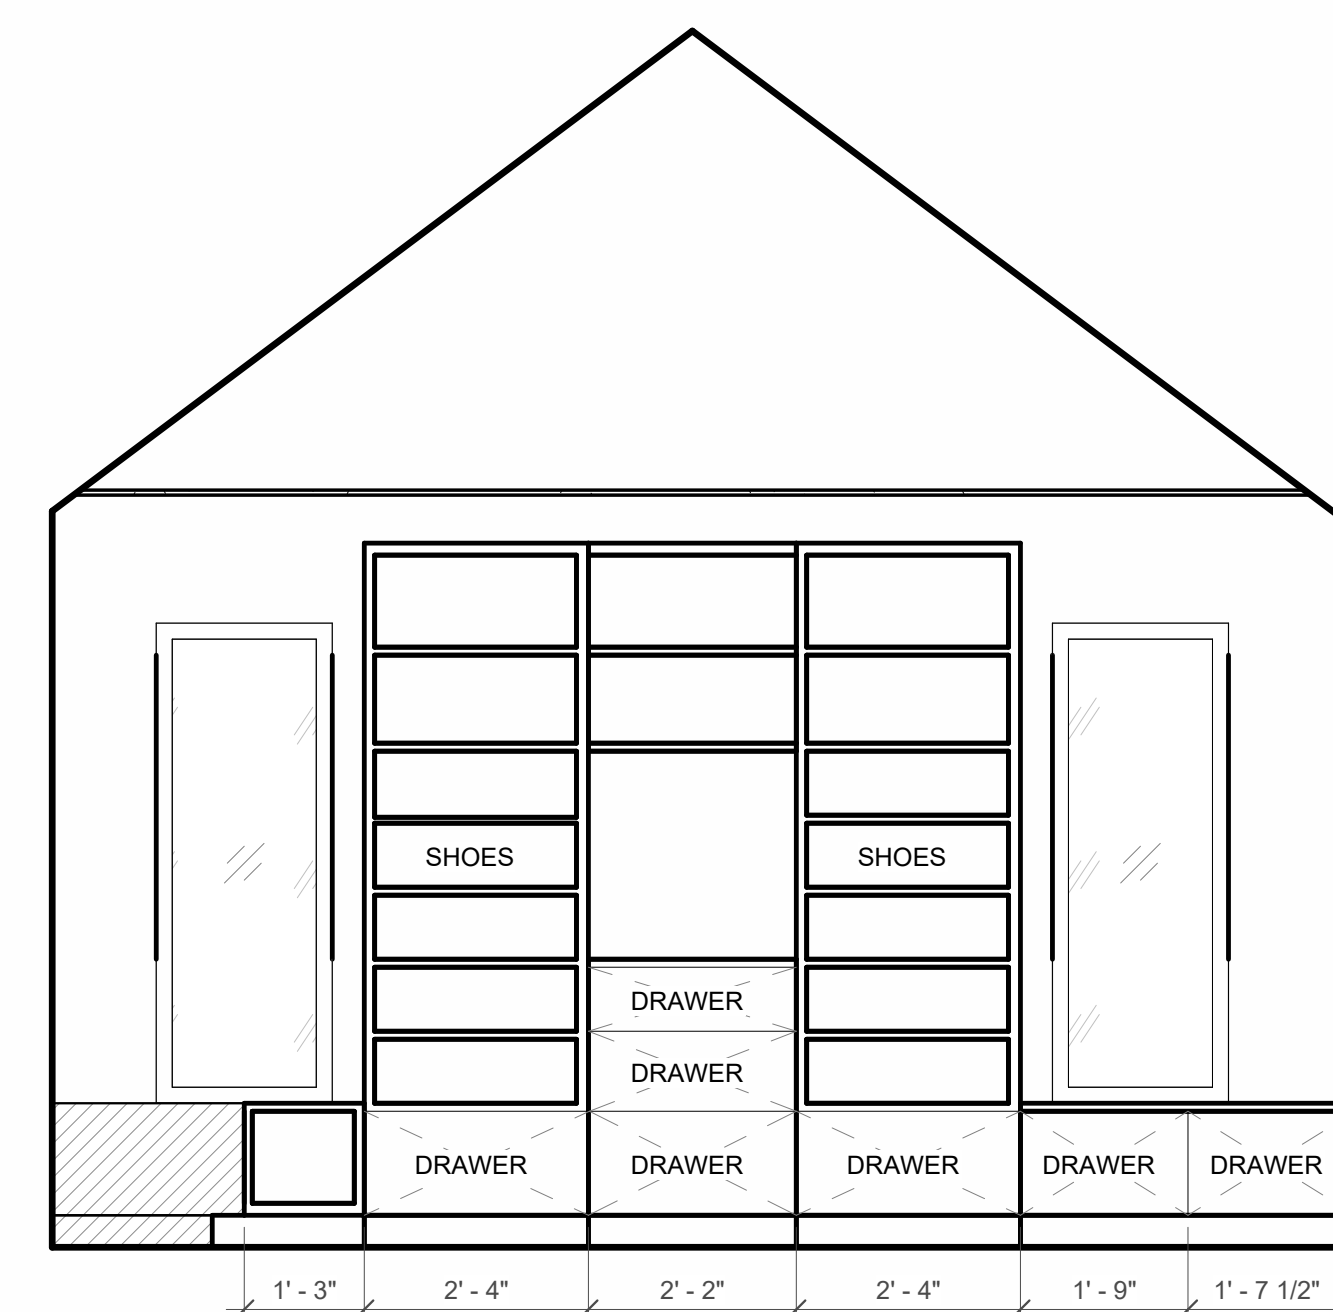


10 202 PRIMARY CLOSET - WEST ELEVATION
 1/2" = 1'-0"

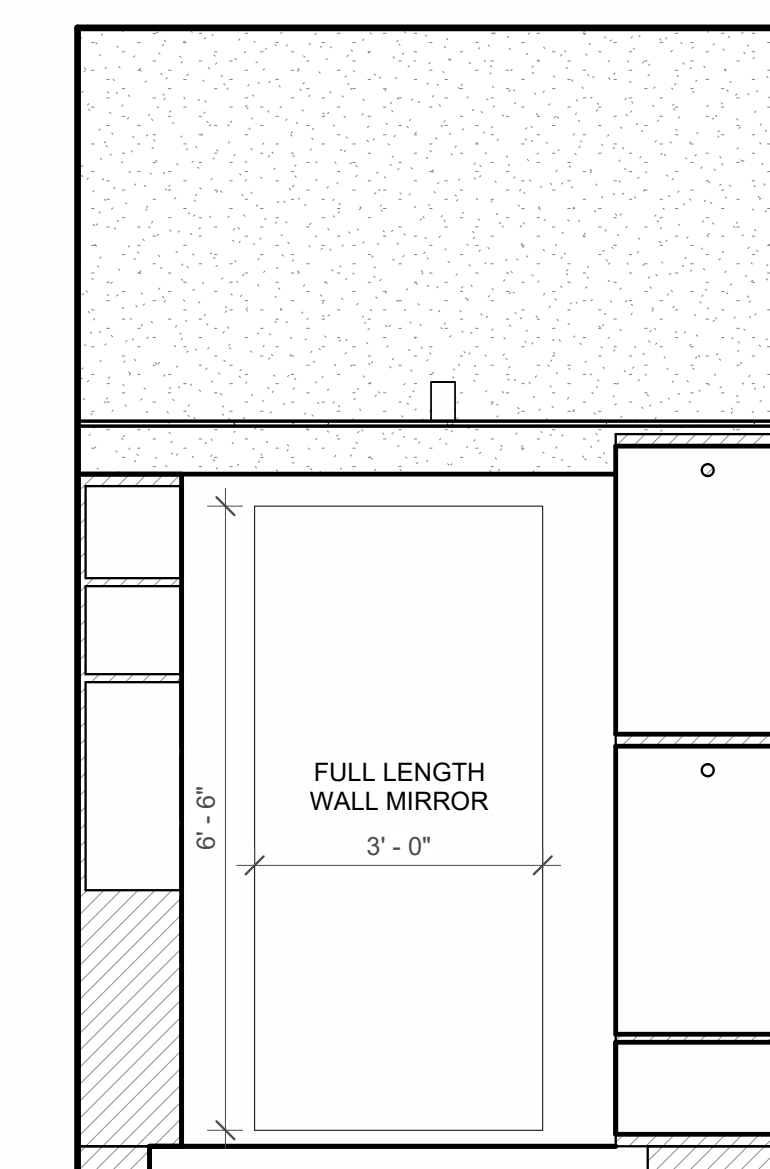


11 202 PRIMARY CLOSET - NORTH ELEVATION
 1/2" = 1'-0"

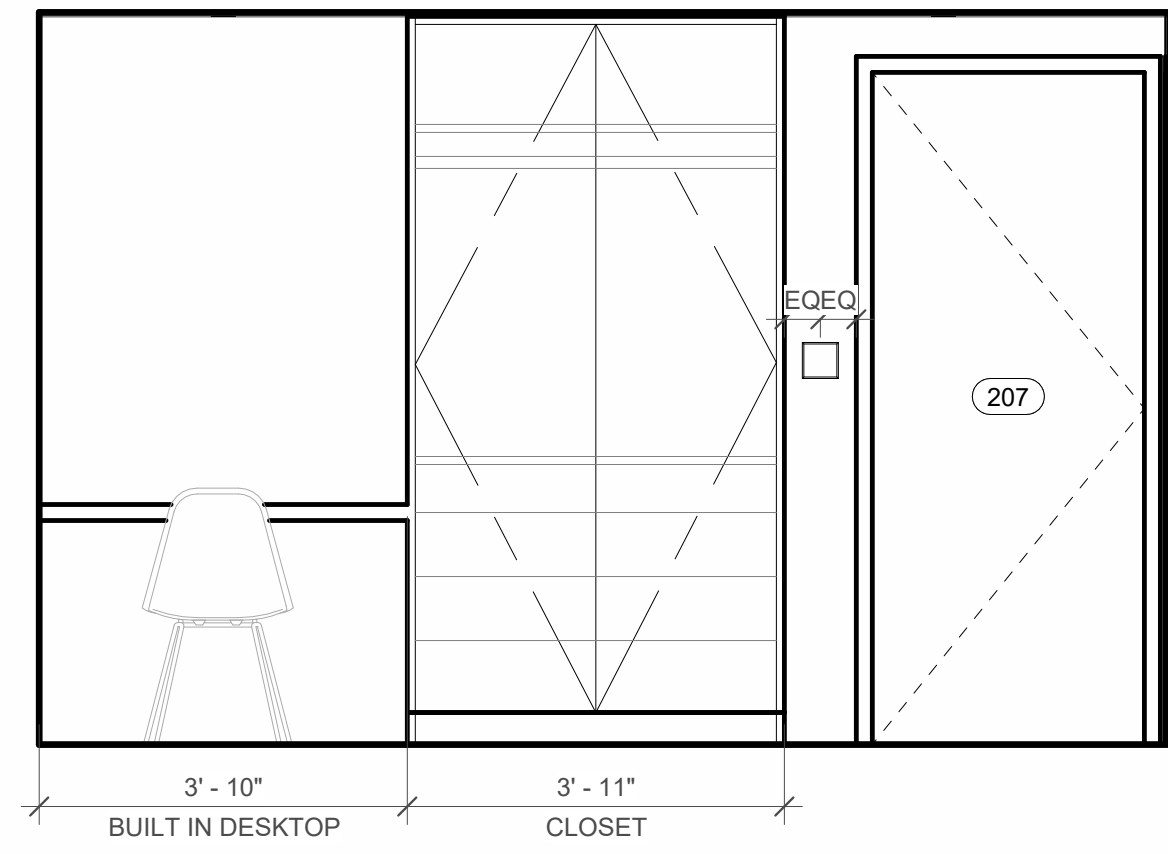


1 207 GUEST BED - WEST ELEVATION
 1/2" = 1'-0"

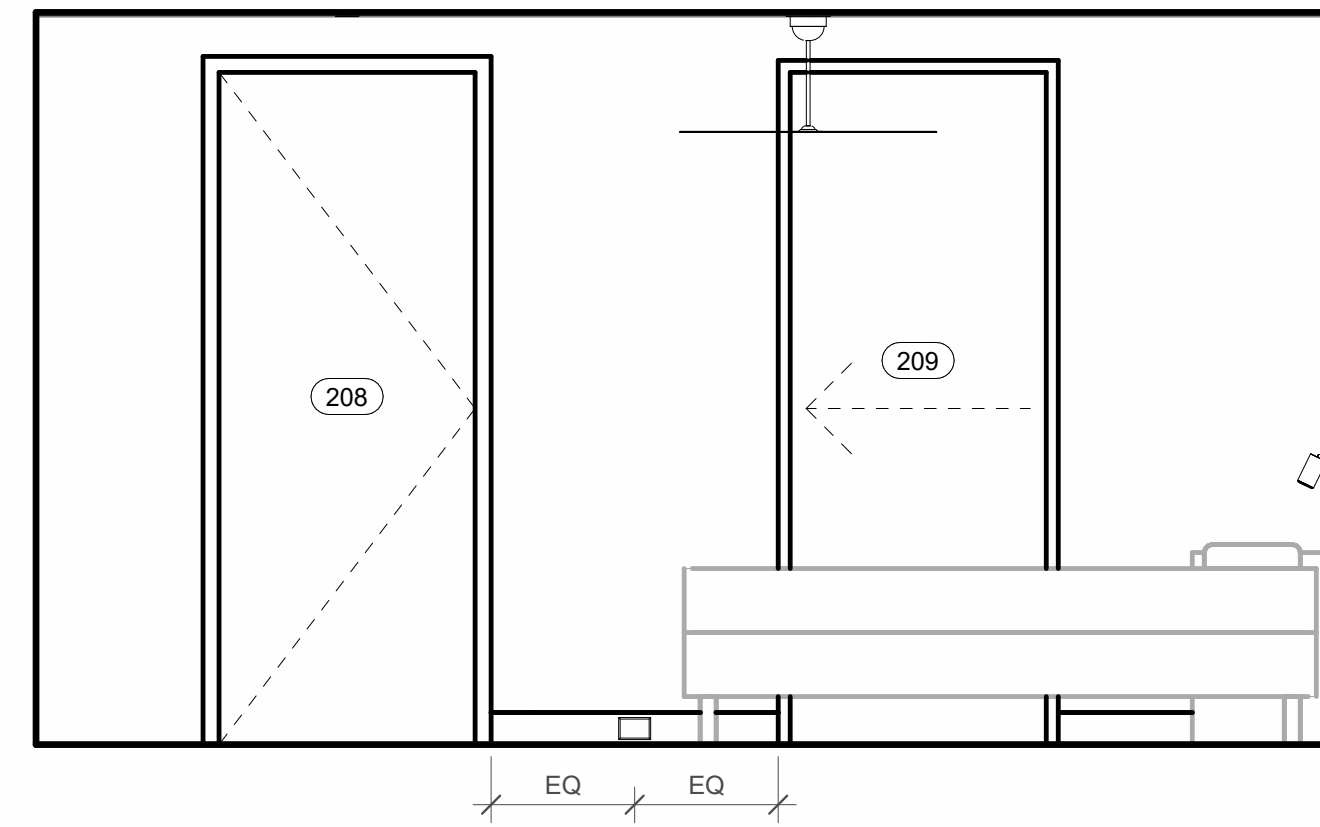


2 207 GUEST BED - NORTH ELEVATION
 1/2" = 1'-0"

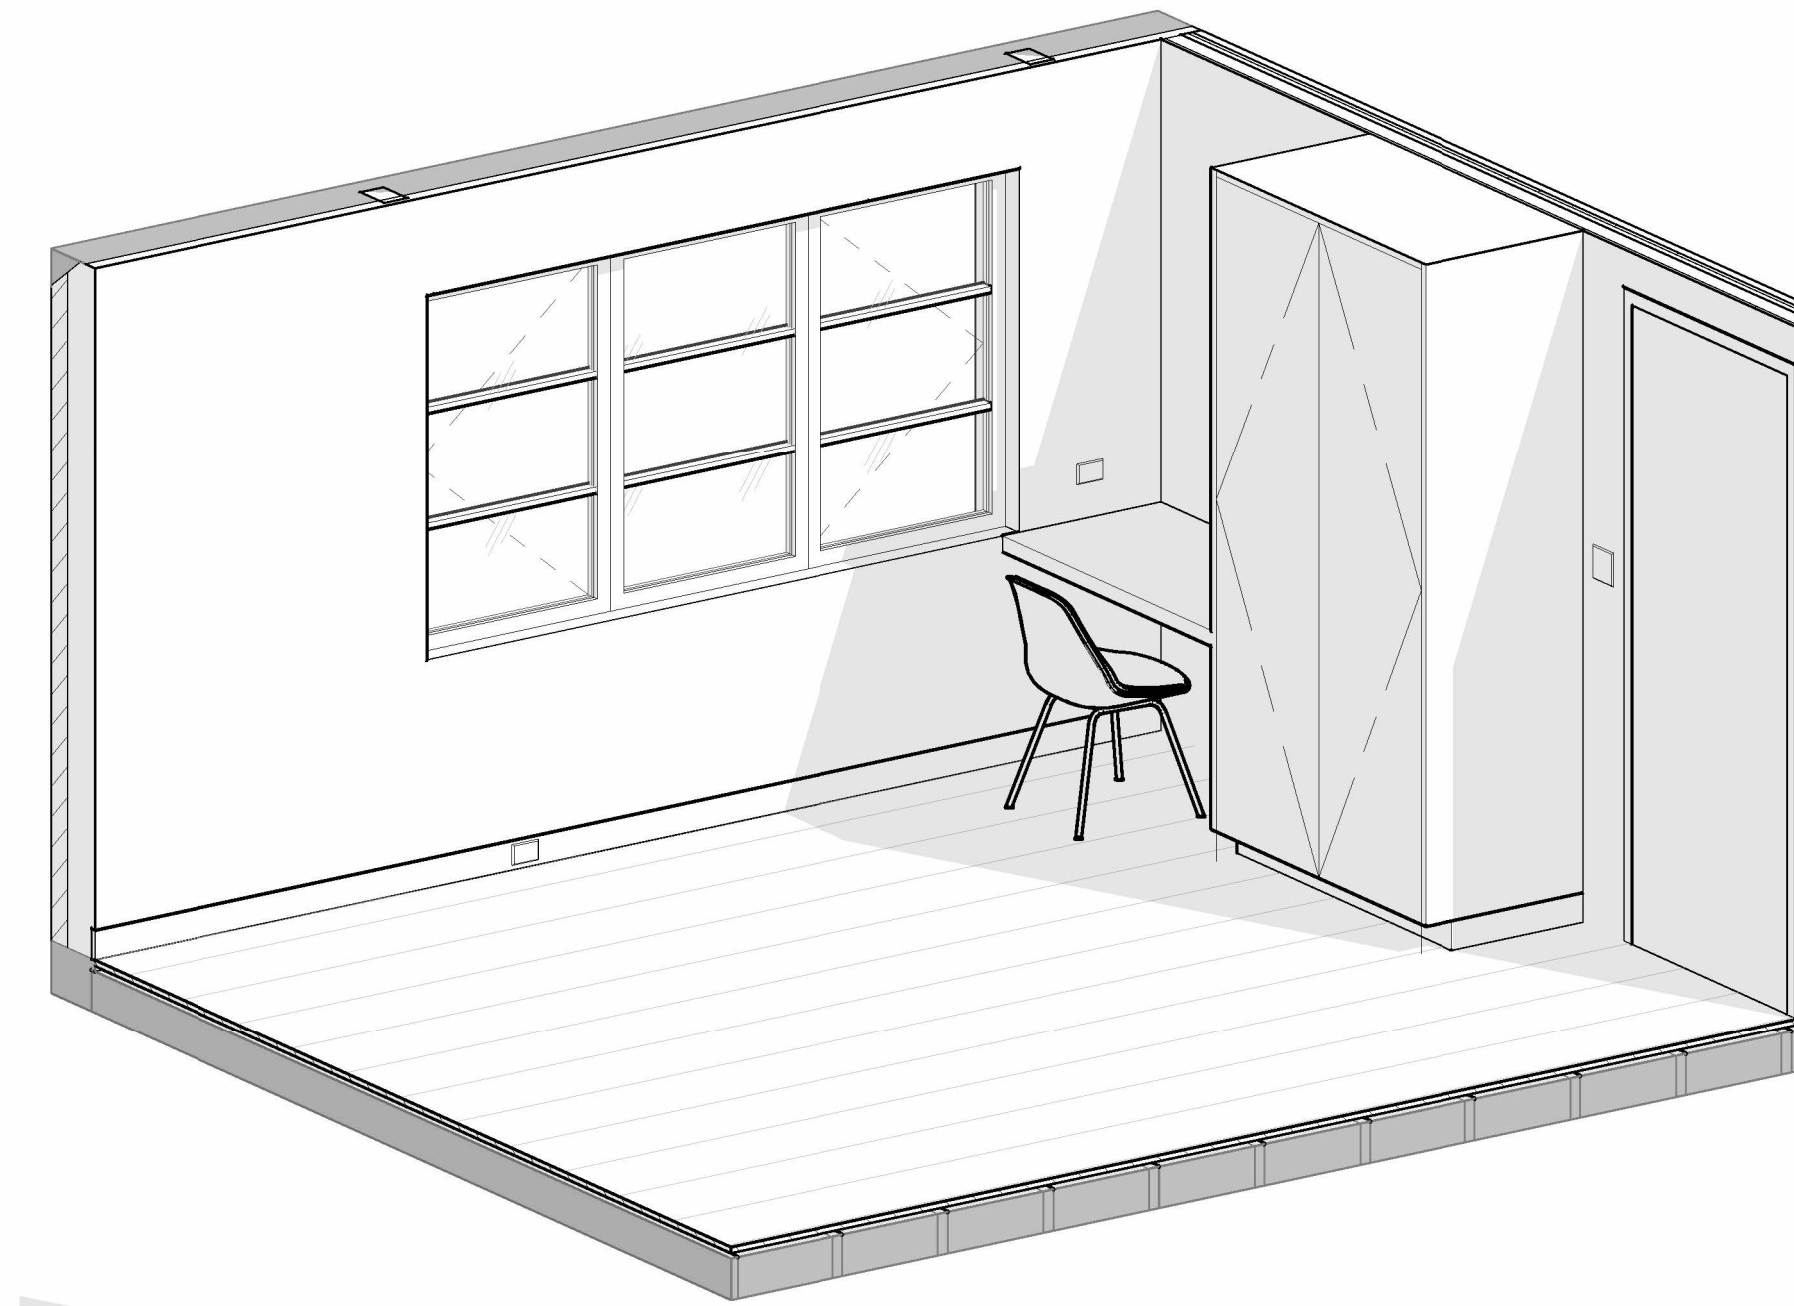


5 207 GUEST BED - ORTHOGRAPHIC VIEW A

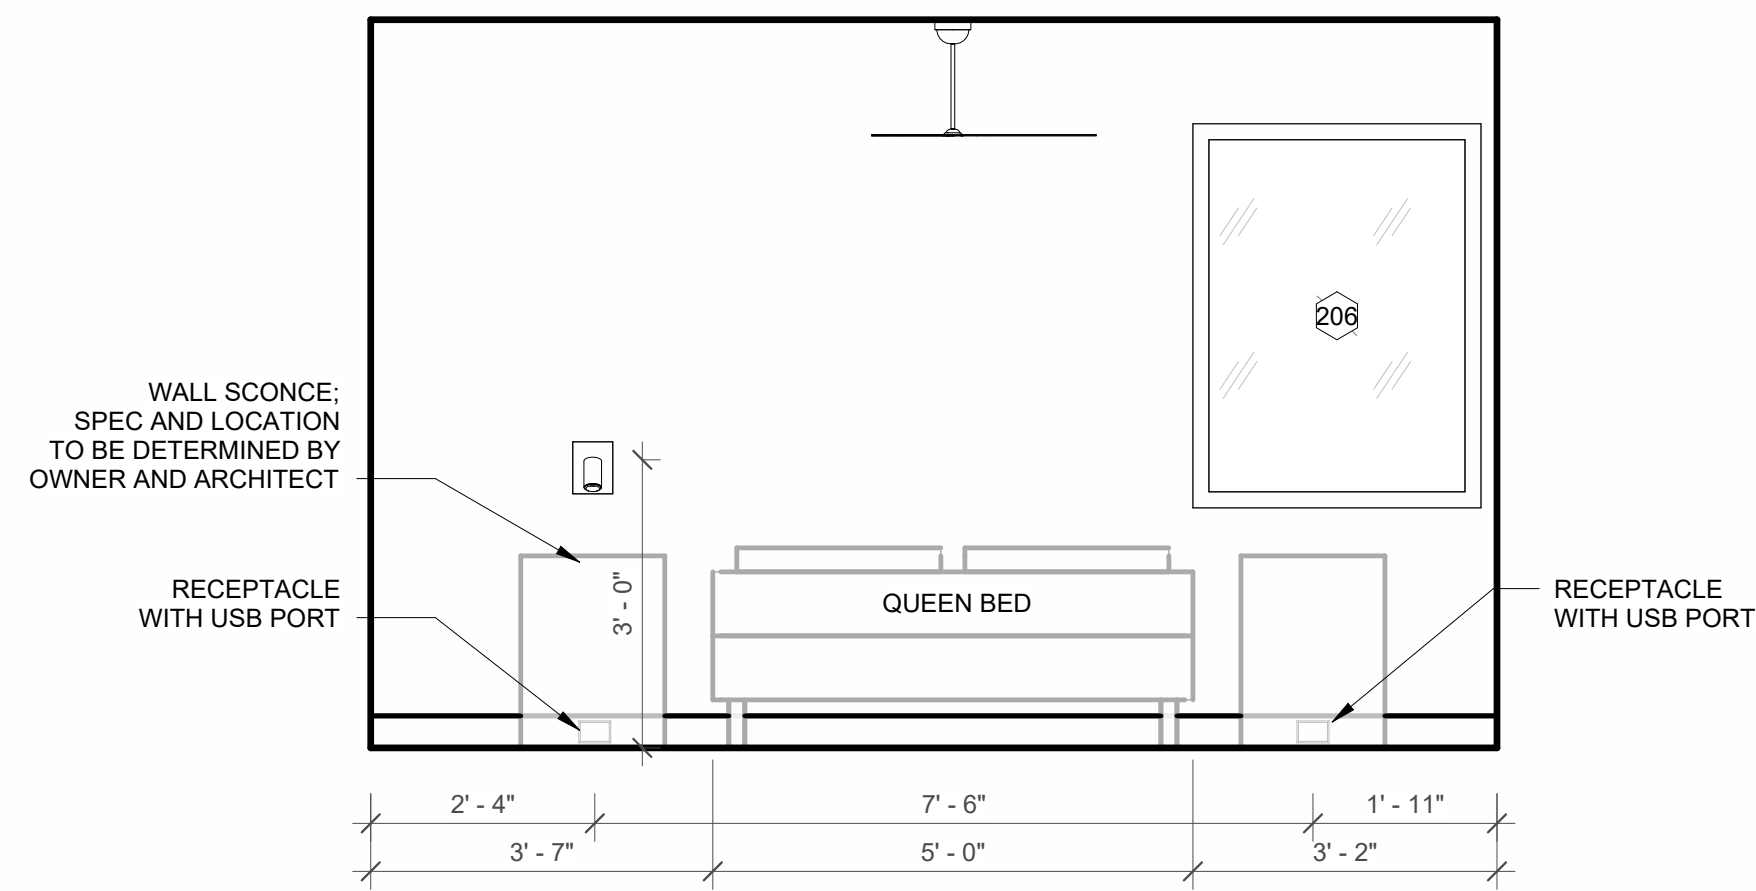


3 207 GUEST BED - EAST ELEVATION
 1/2" = 1'-0"

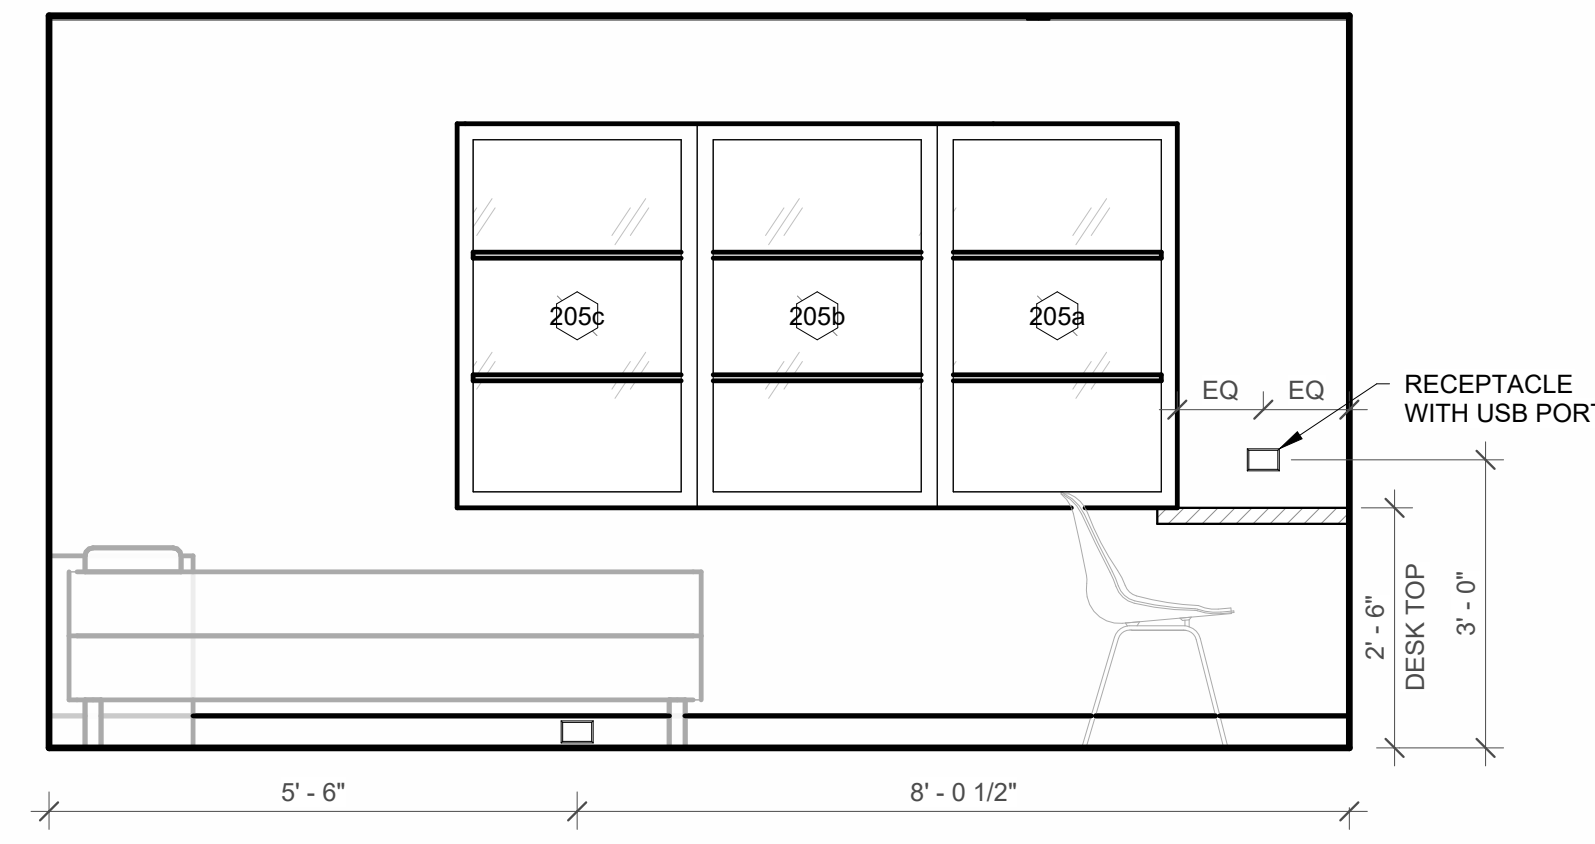


4 207 GUEST BED - SOUTH ELEVATION
 1/2" = 1'-0"

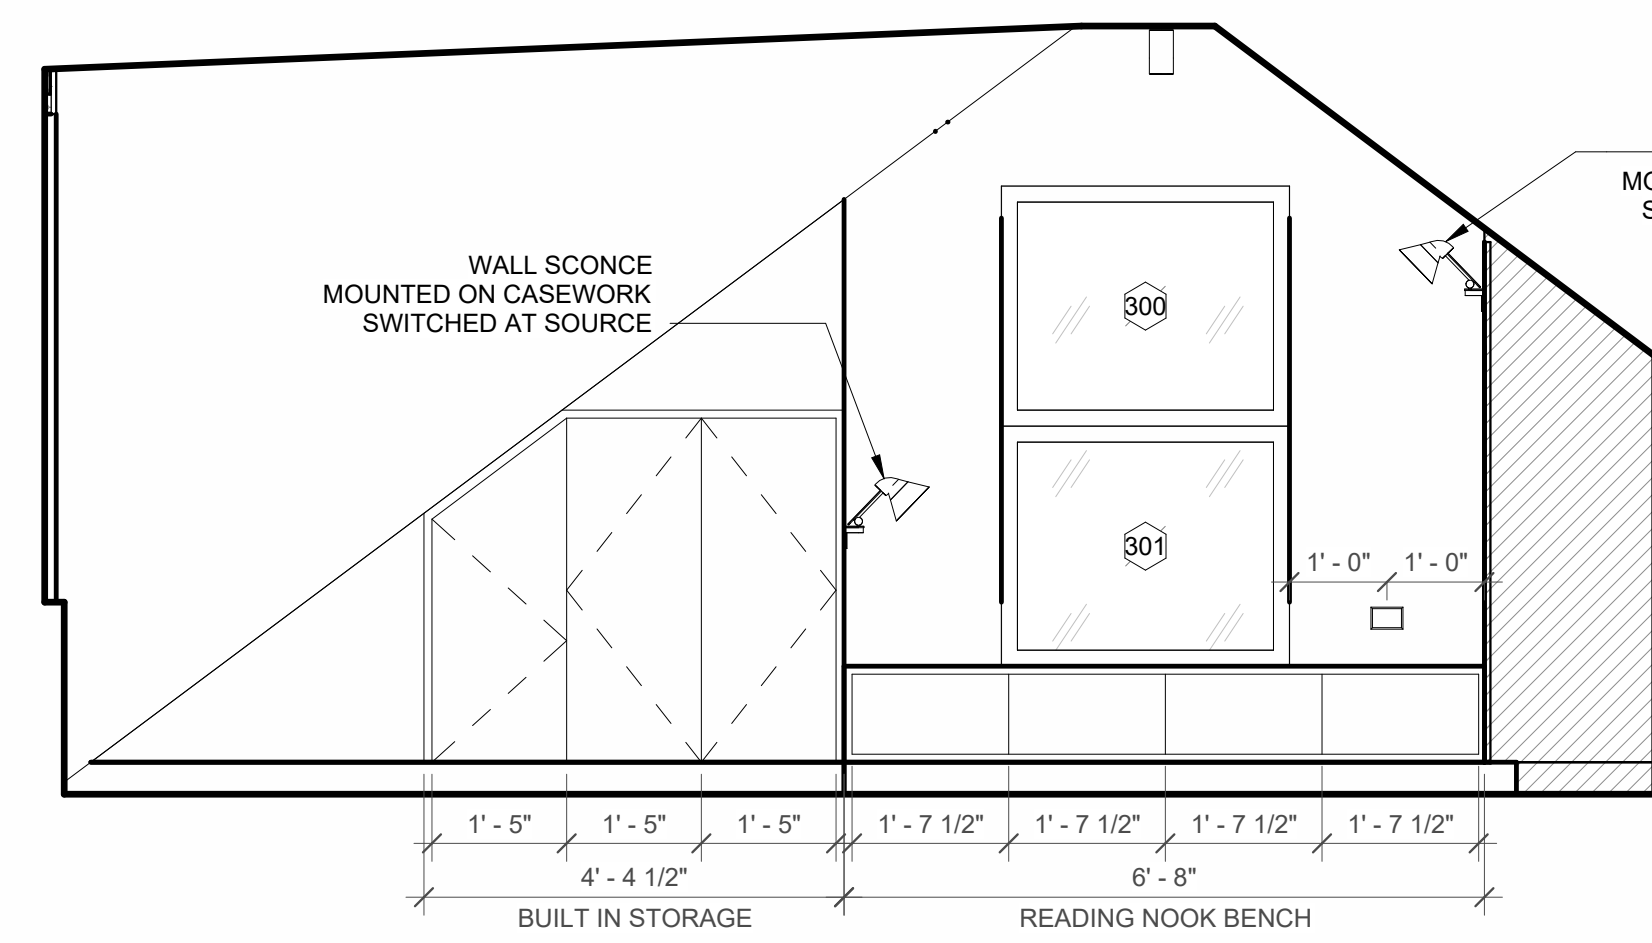


6 300 ATTIC - EAST ELEVATION
 1/2" = 1'-0"

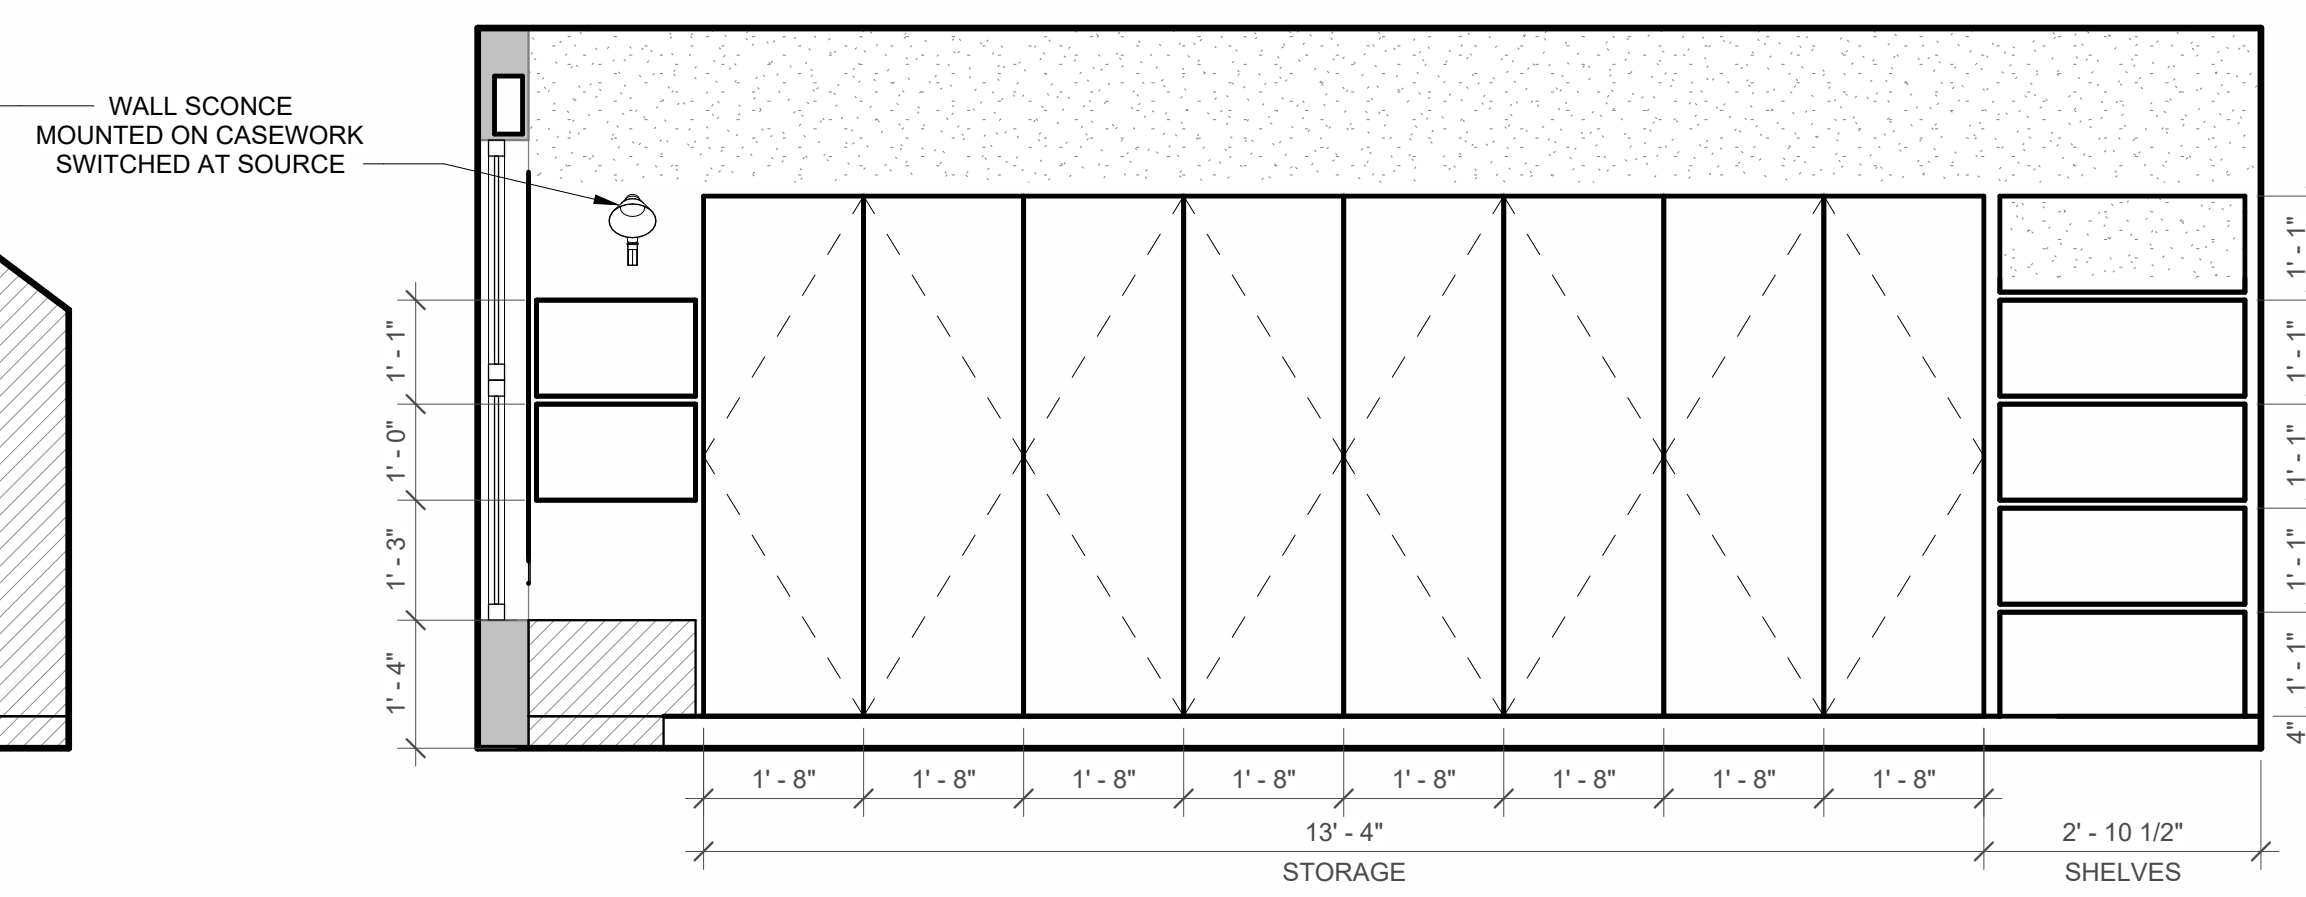


7 300 ATTIC - SOUTH ELEVATION
 1/2" = 1'-0"

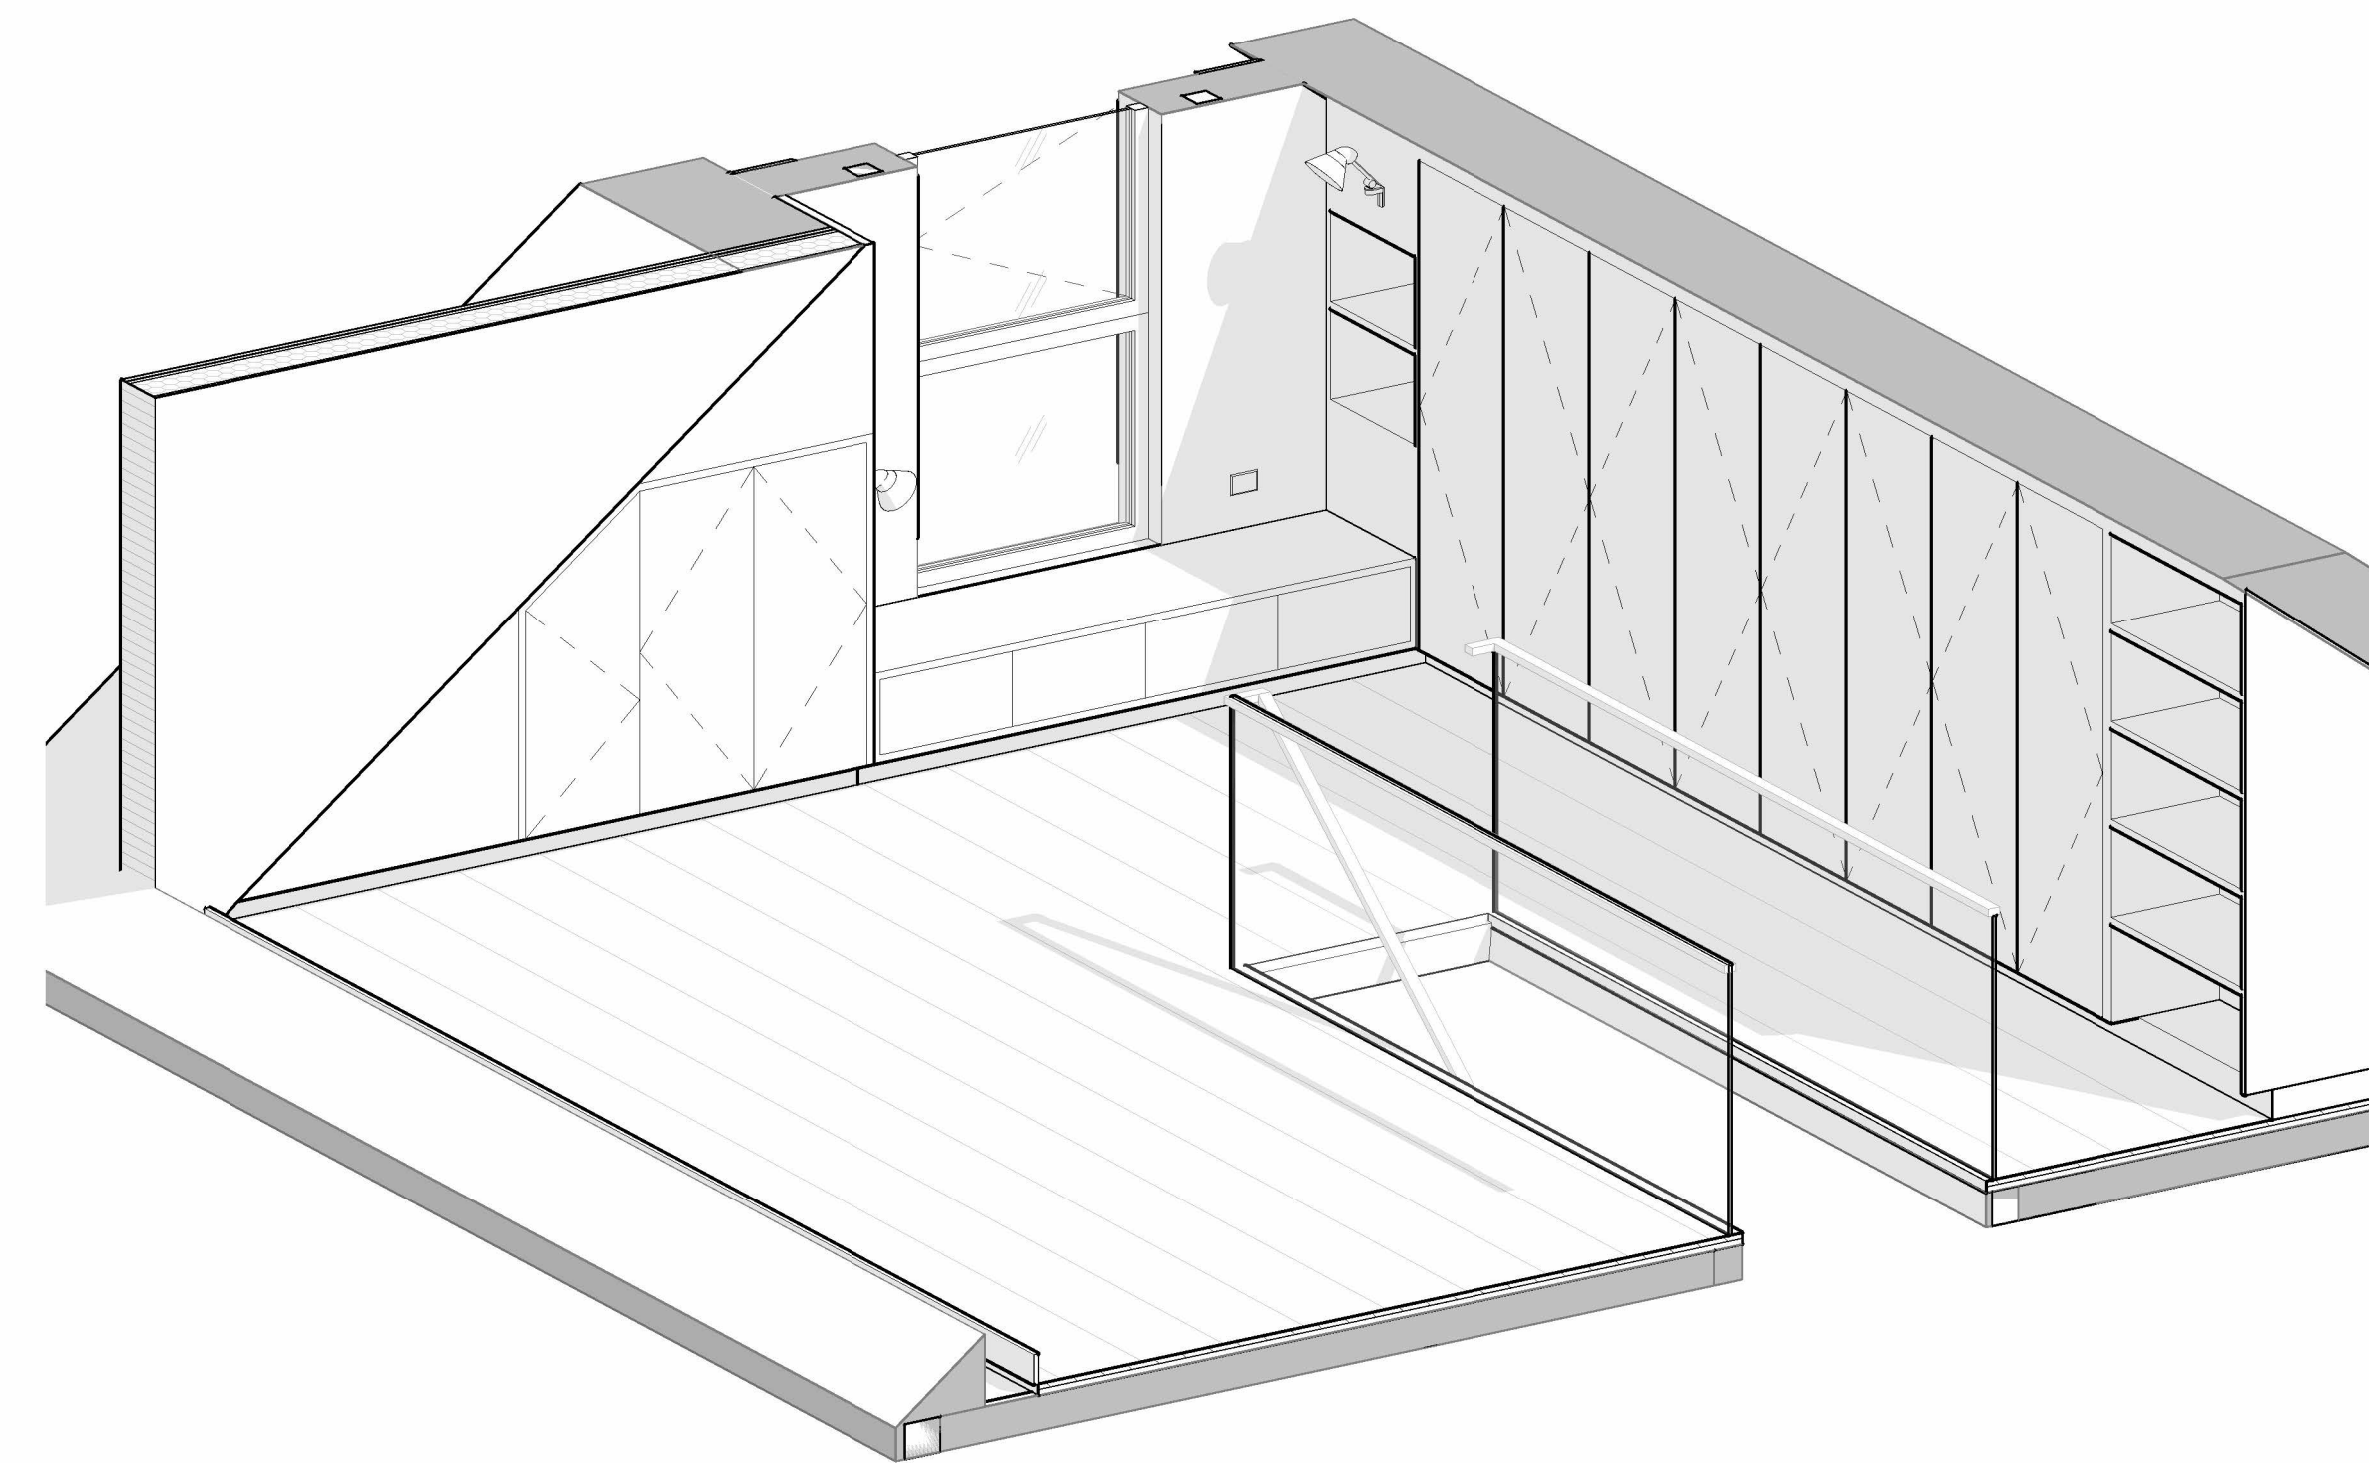

10 300 PRACTICE ROOM - ORTHOGRAPHIC VIEW A

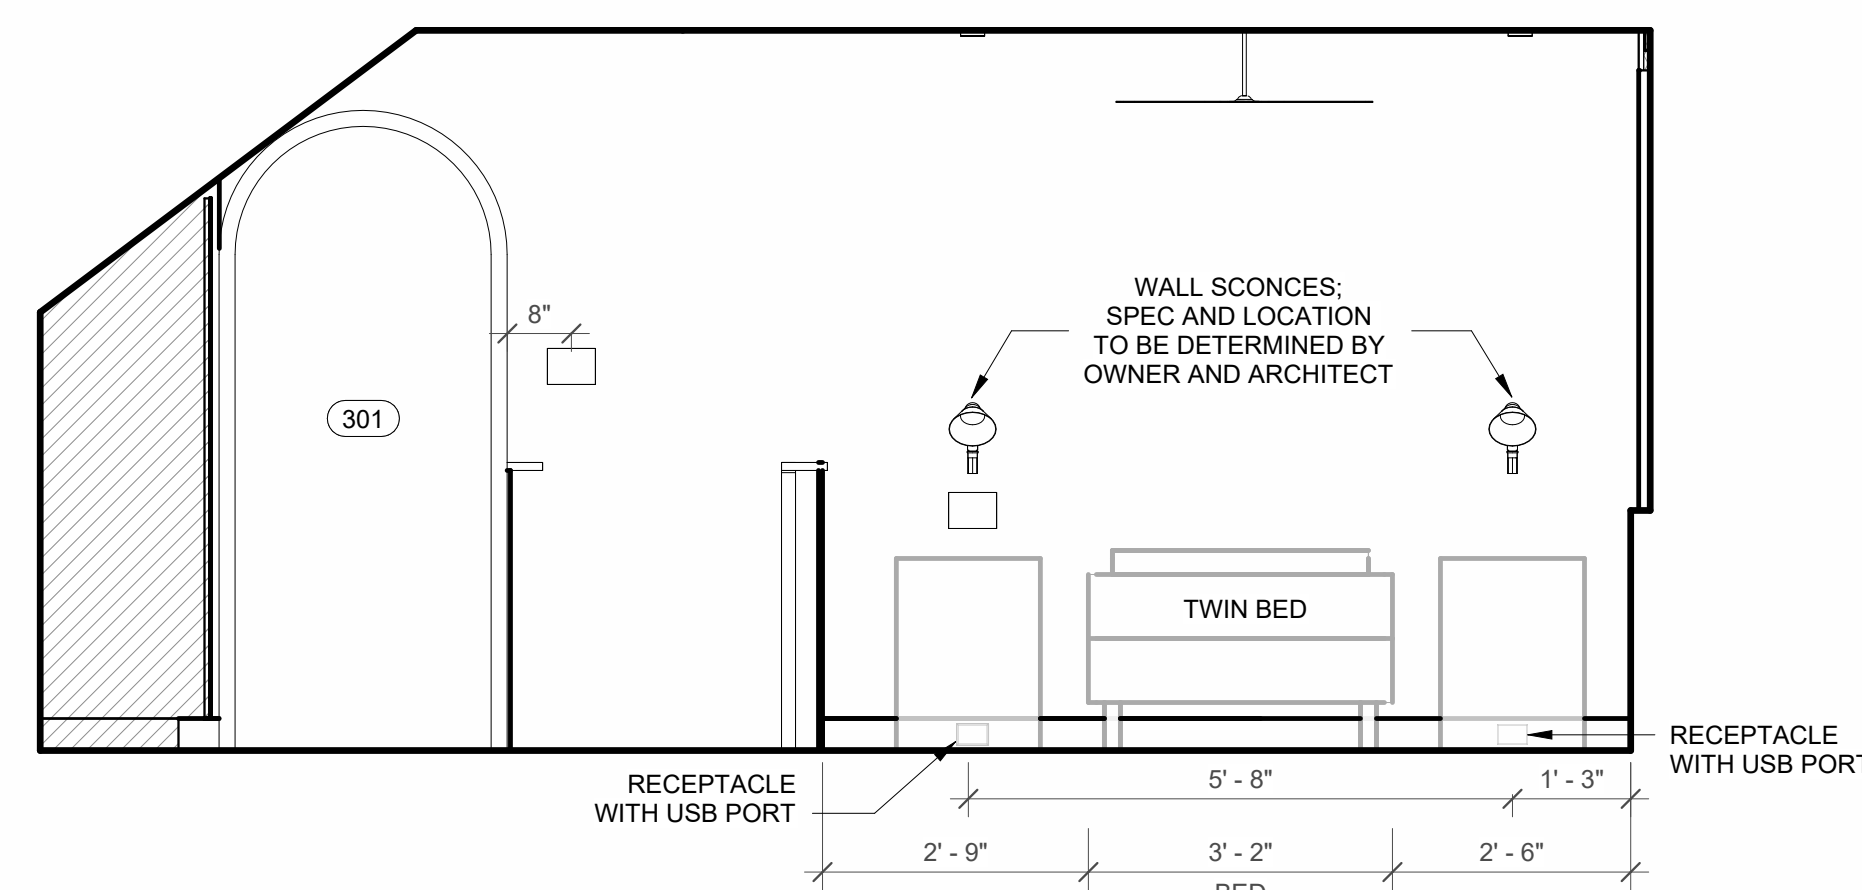

8 300 ATTIC - WEST ELEVATION
 1/2" = 1'-0"

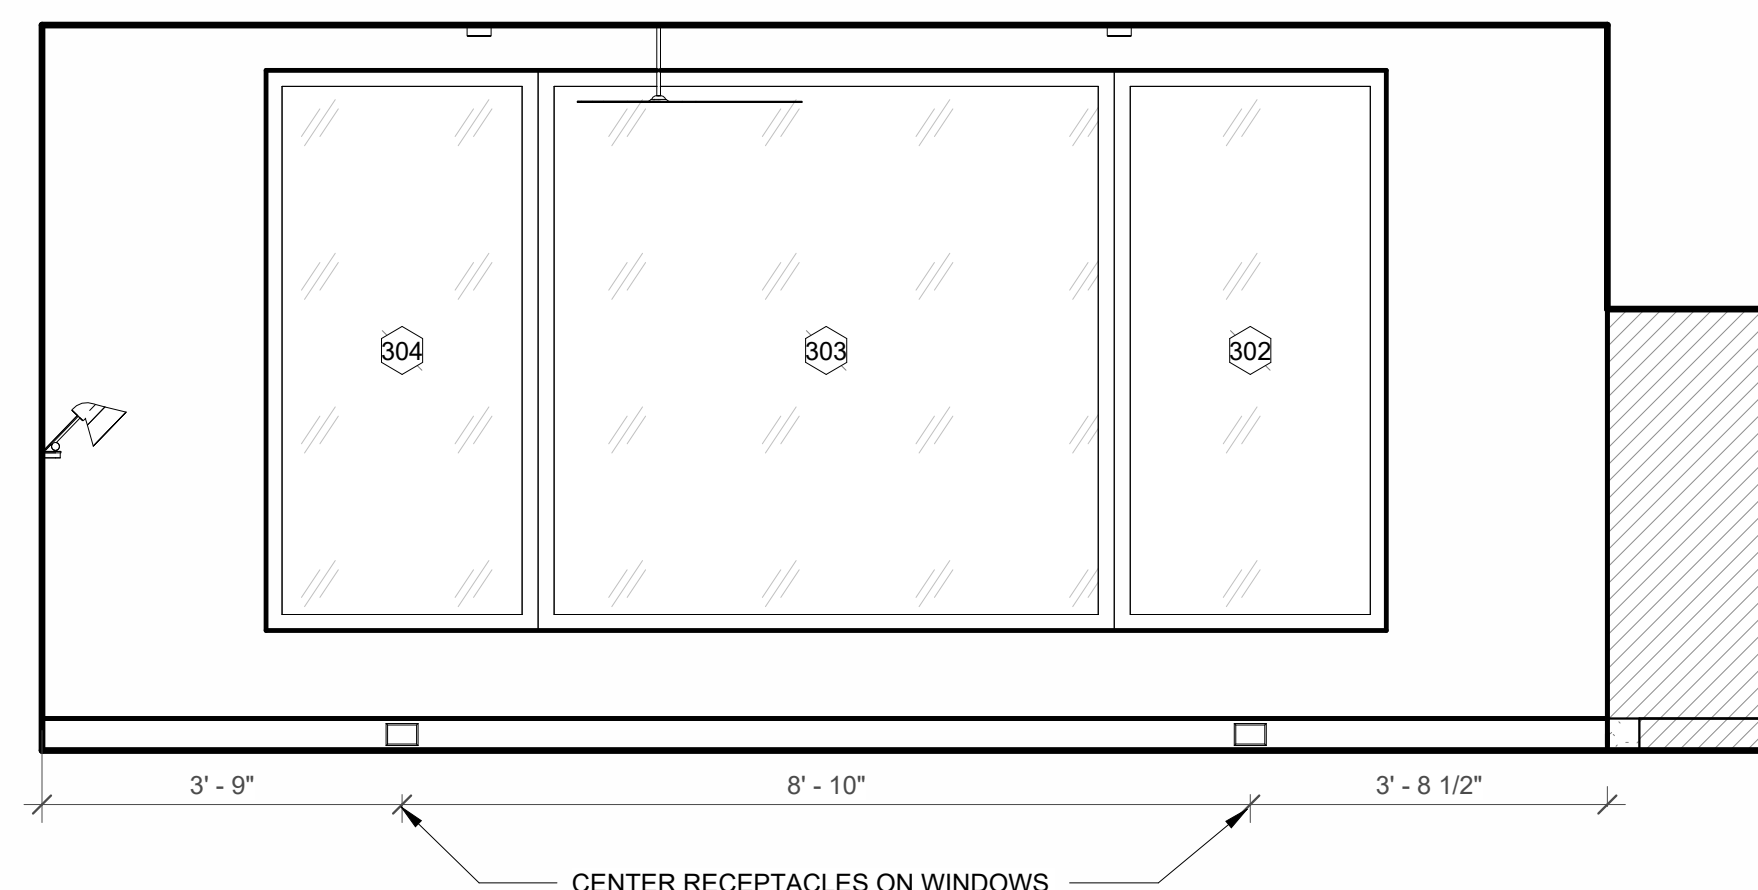

9 300 ATTIC - NORTH ELEVATION
 1/2" = 1'-0"



REVISION HISTORY		
NO.	DESCRIPTION	DATE

PERMIT REVISION


DATE:	AUG 18, 2023
SCALE:	1/2" = 1'-0"
DRAWN BY:	CJ
CHECKED BY:	CR

SHEET TITLE PROJECT #: 40035


INTERIOR ELEVATIONS

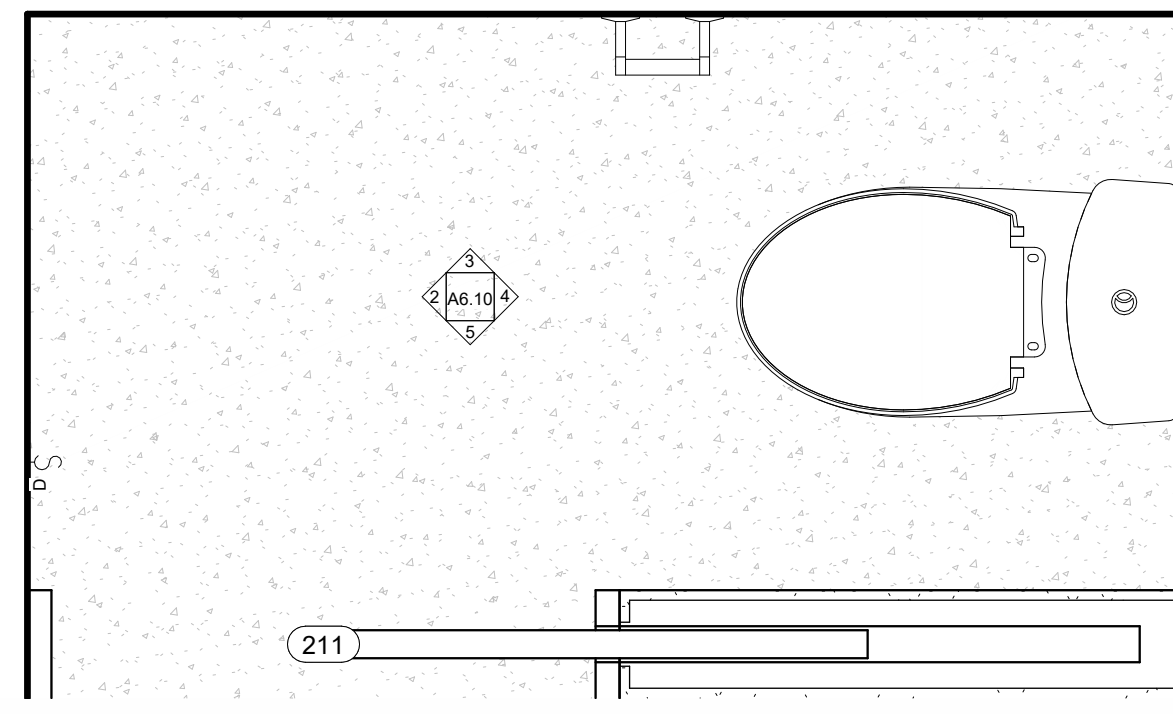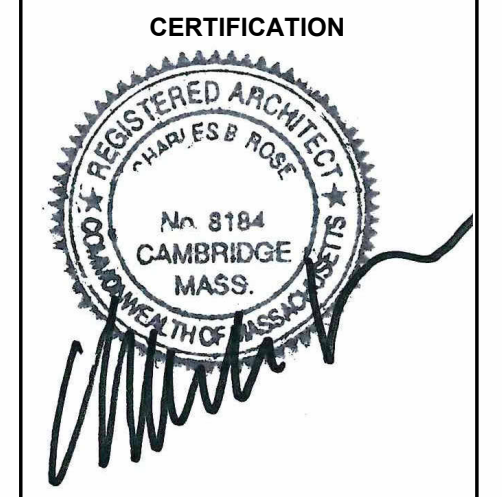


1 011 SPA TOILET ROOM
 1" = 1'-0"

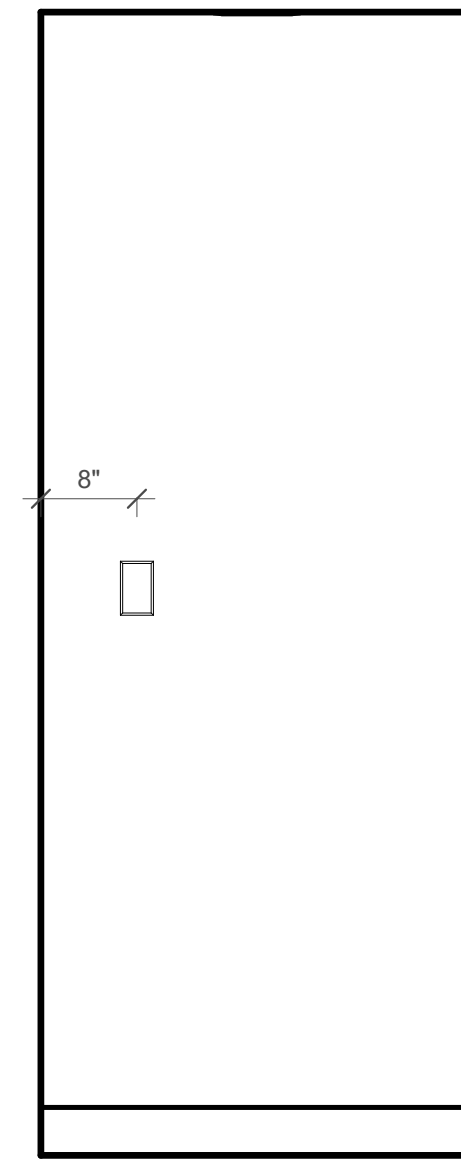


2 011 TOILET - WEST
 3/4" = 1'-0"

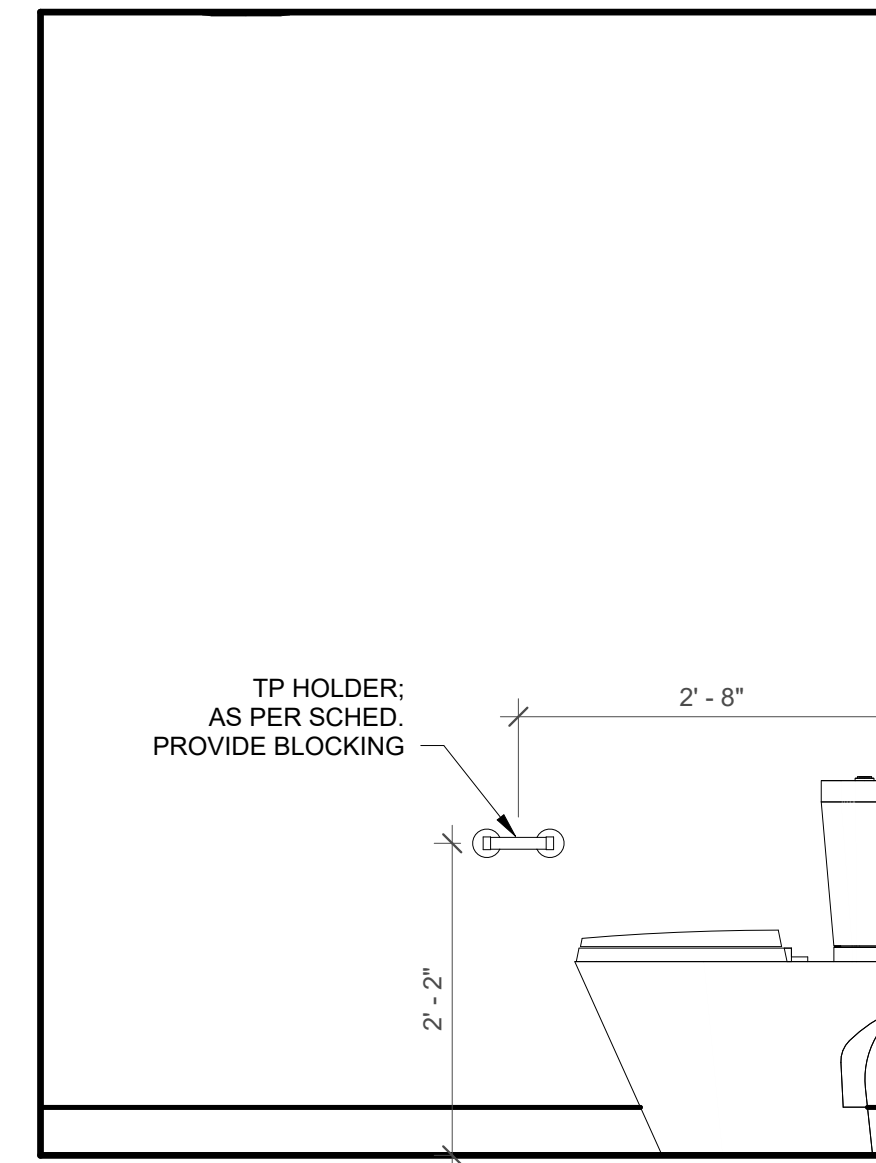


3 011 TOILET - NORTH
 3/4" = 1'-0"

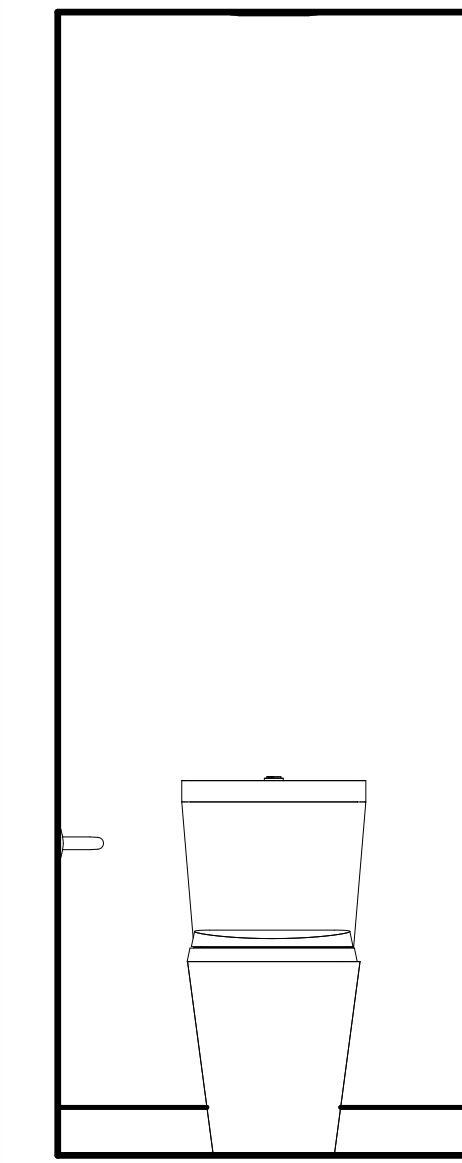


4 011 TOILET - EAST
 3/4" = 1'-0"

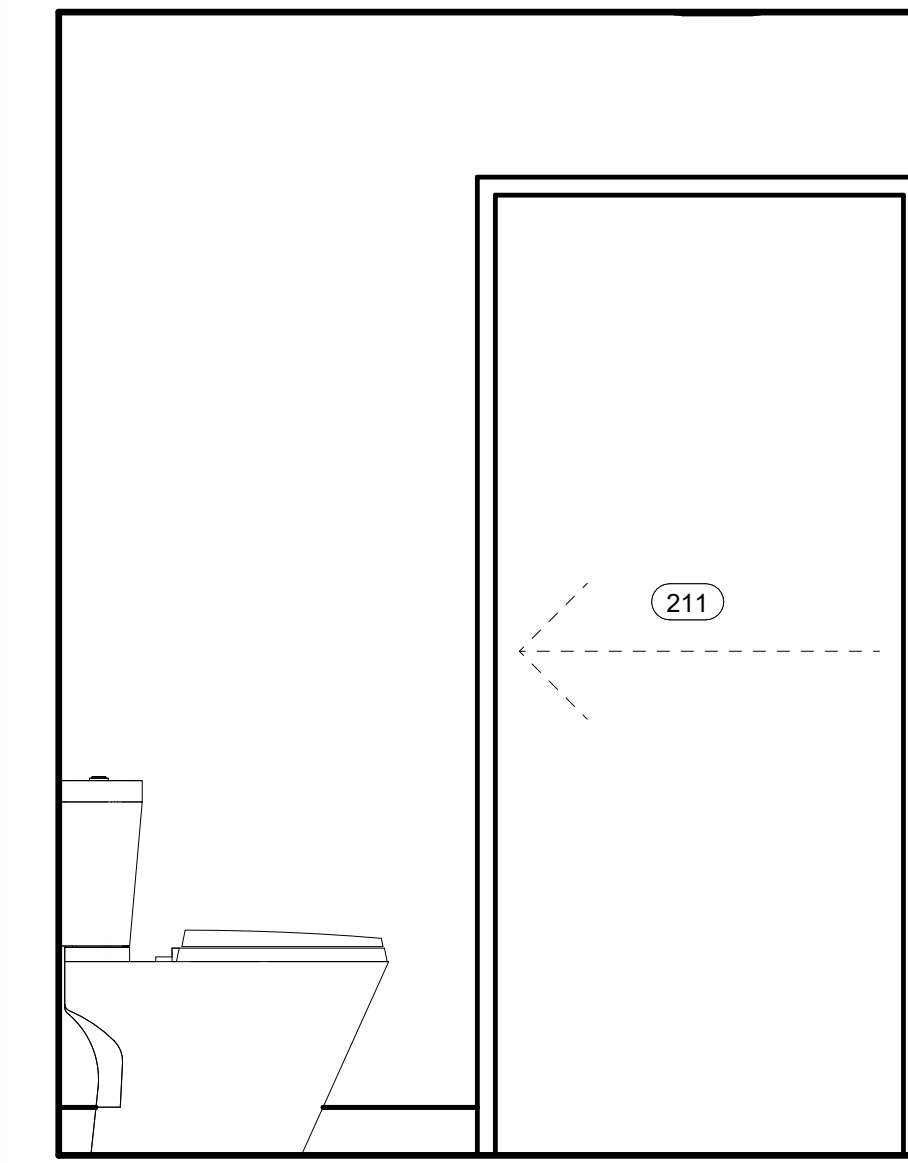


5 011 TOILET - SOUTH
 3/4" = 1'-0"

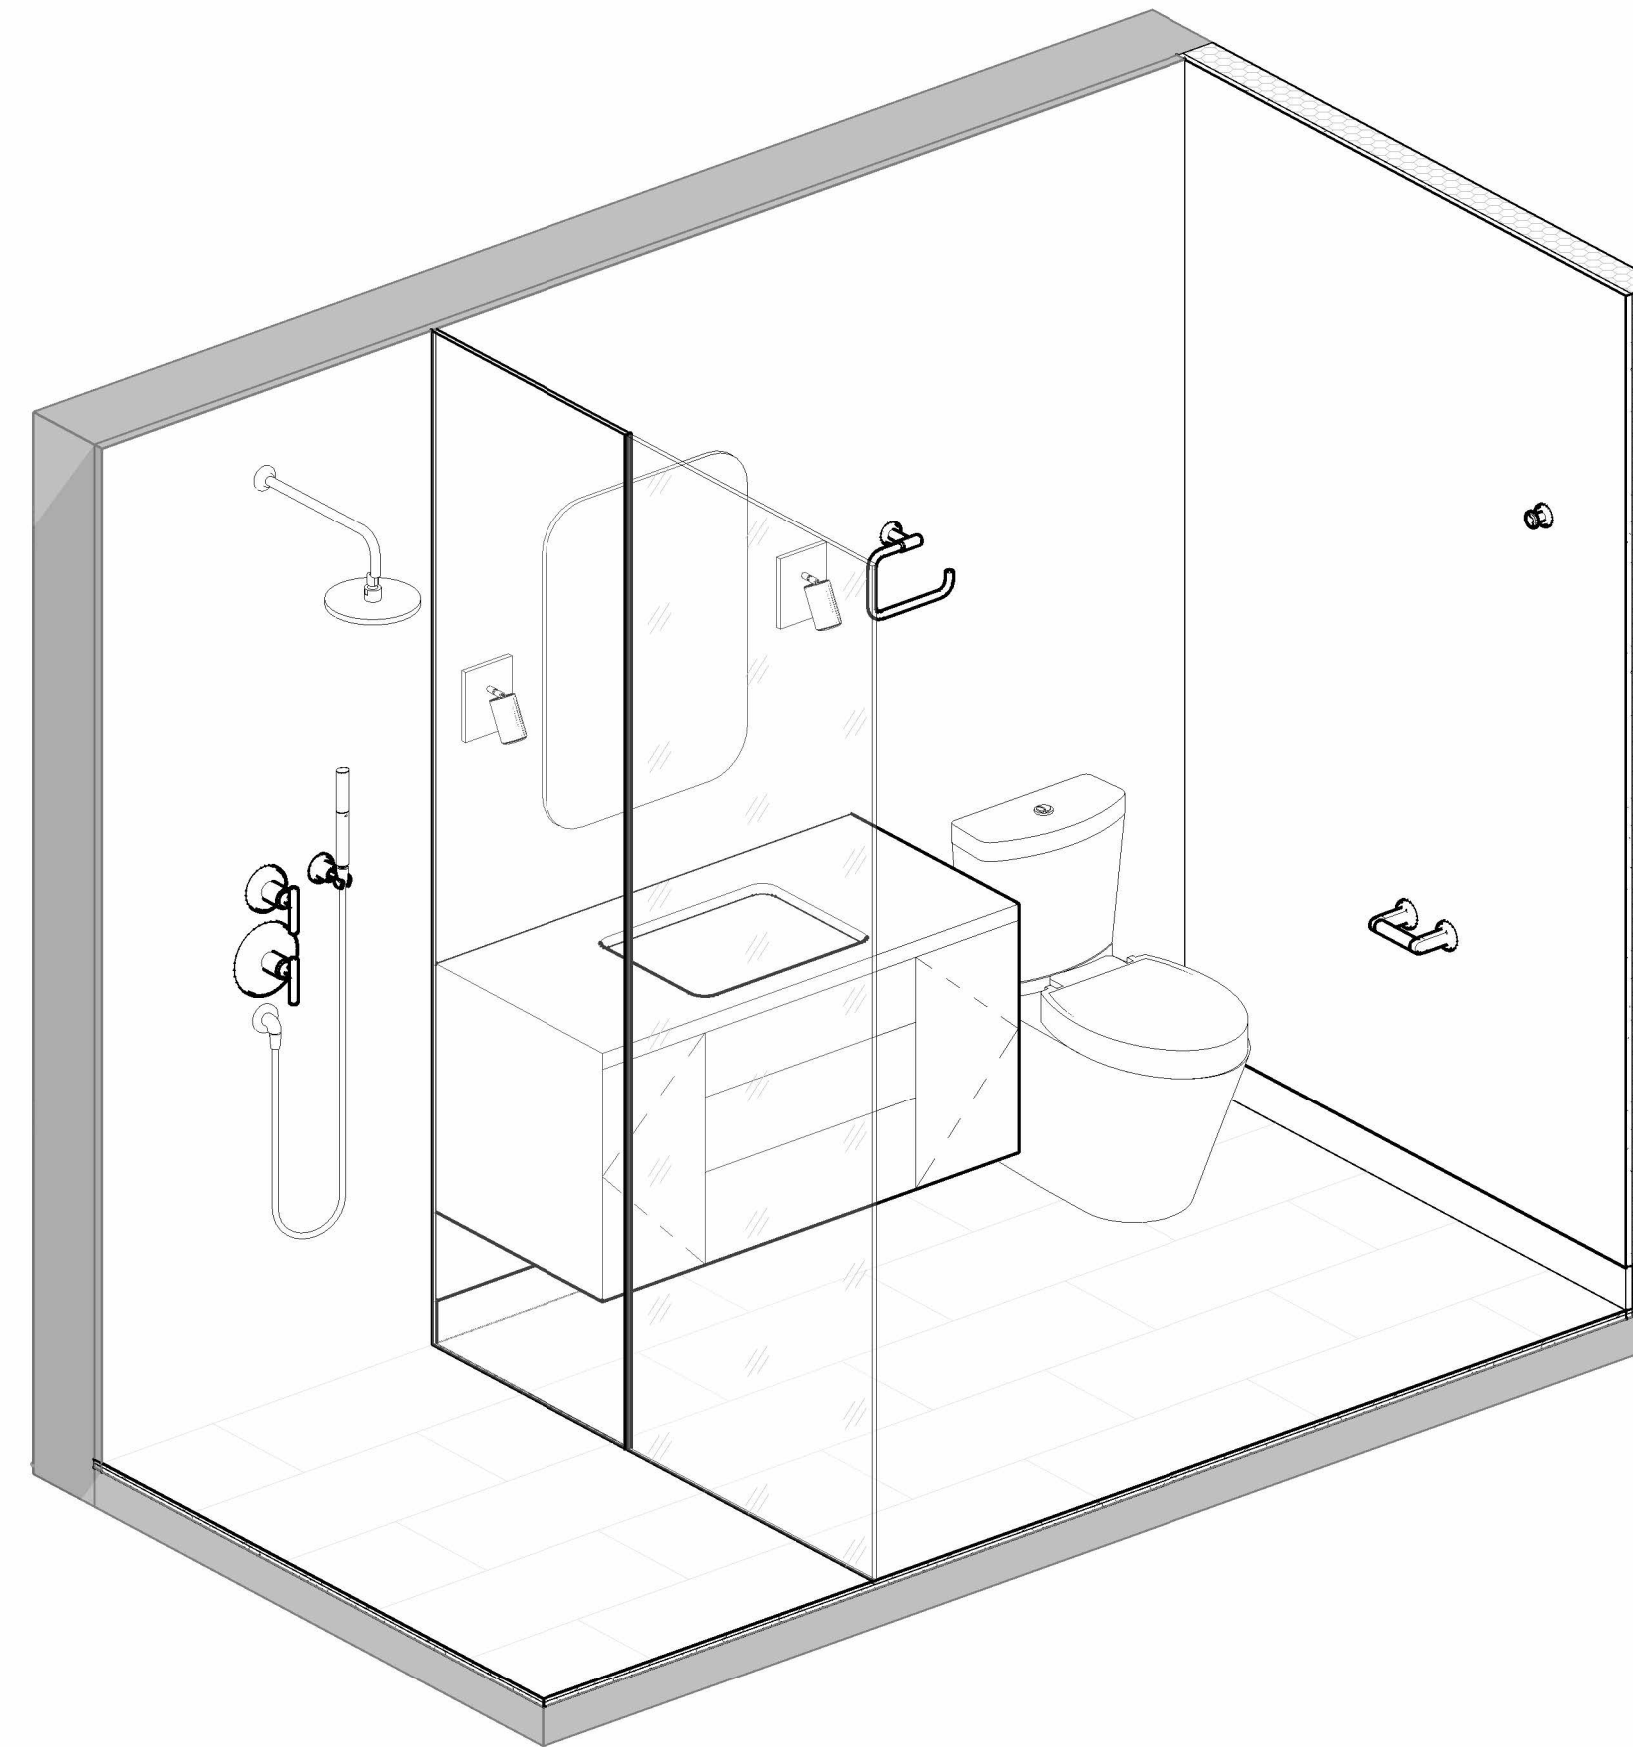


7 026 IN-LAW BATH - ORTHOGRAPHIC VIEW A

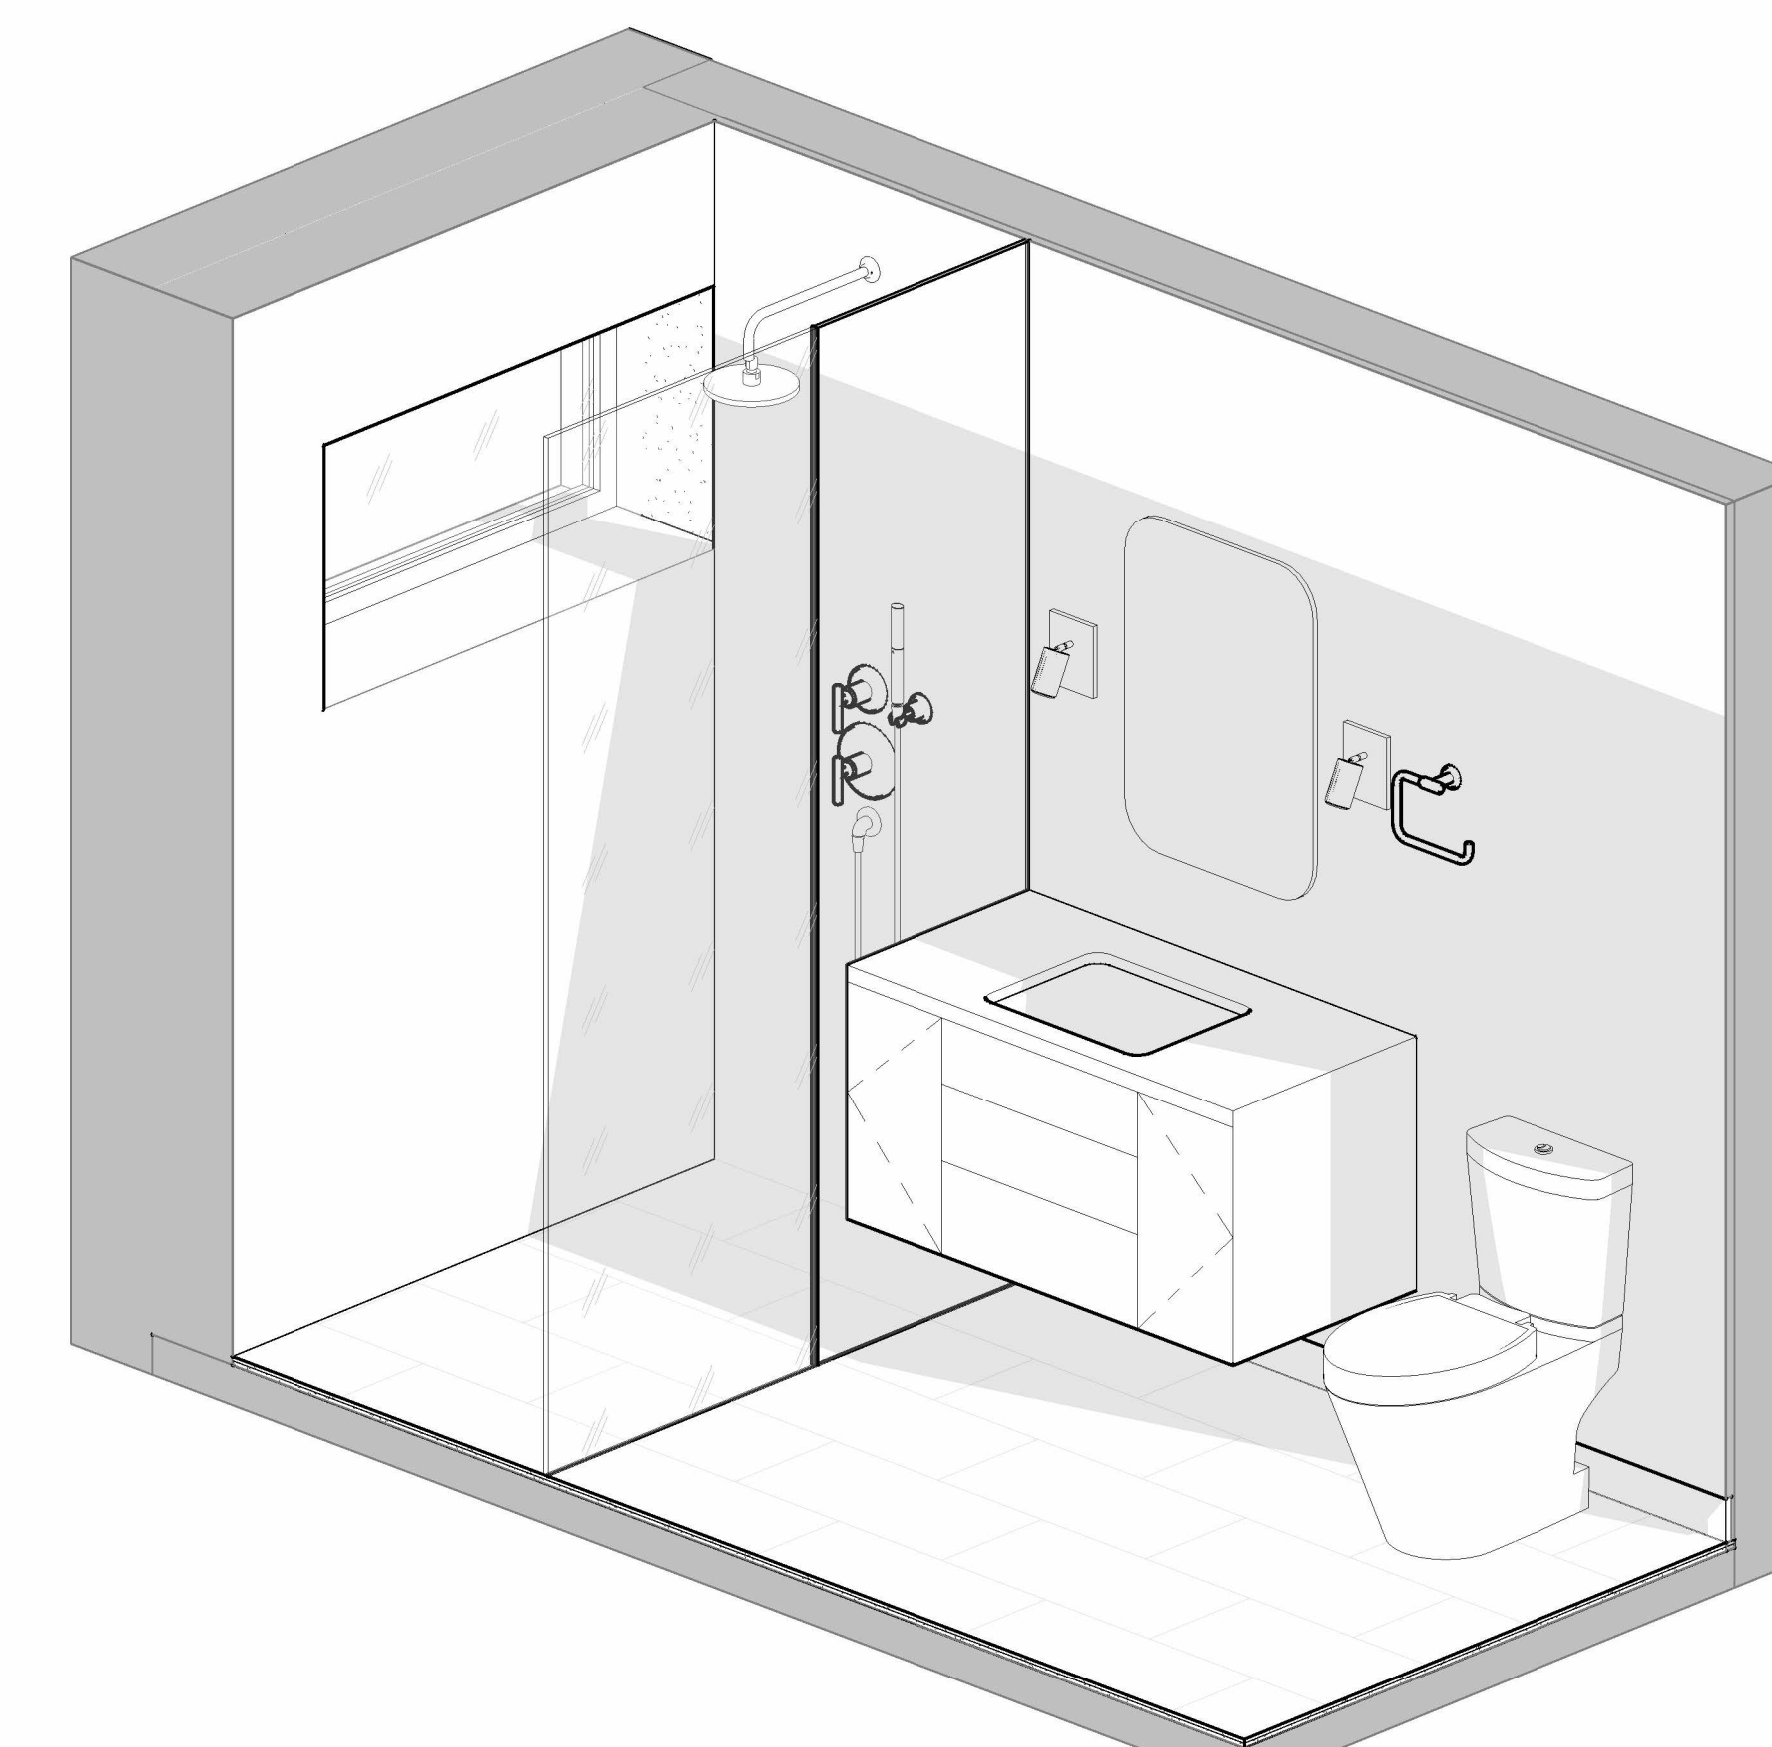


8 026 IN-LAW BATH - ORTHOGRAPHIC VIEW B

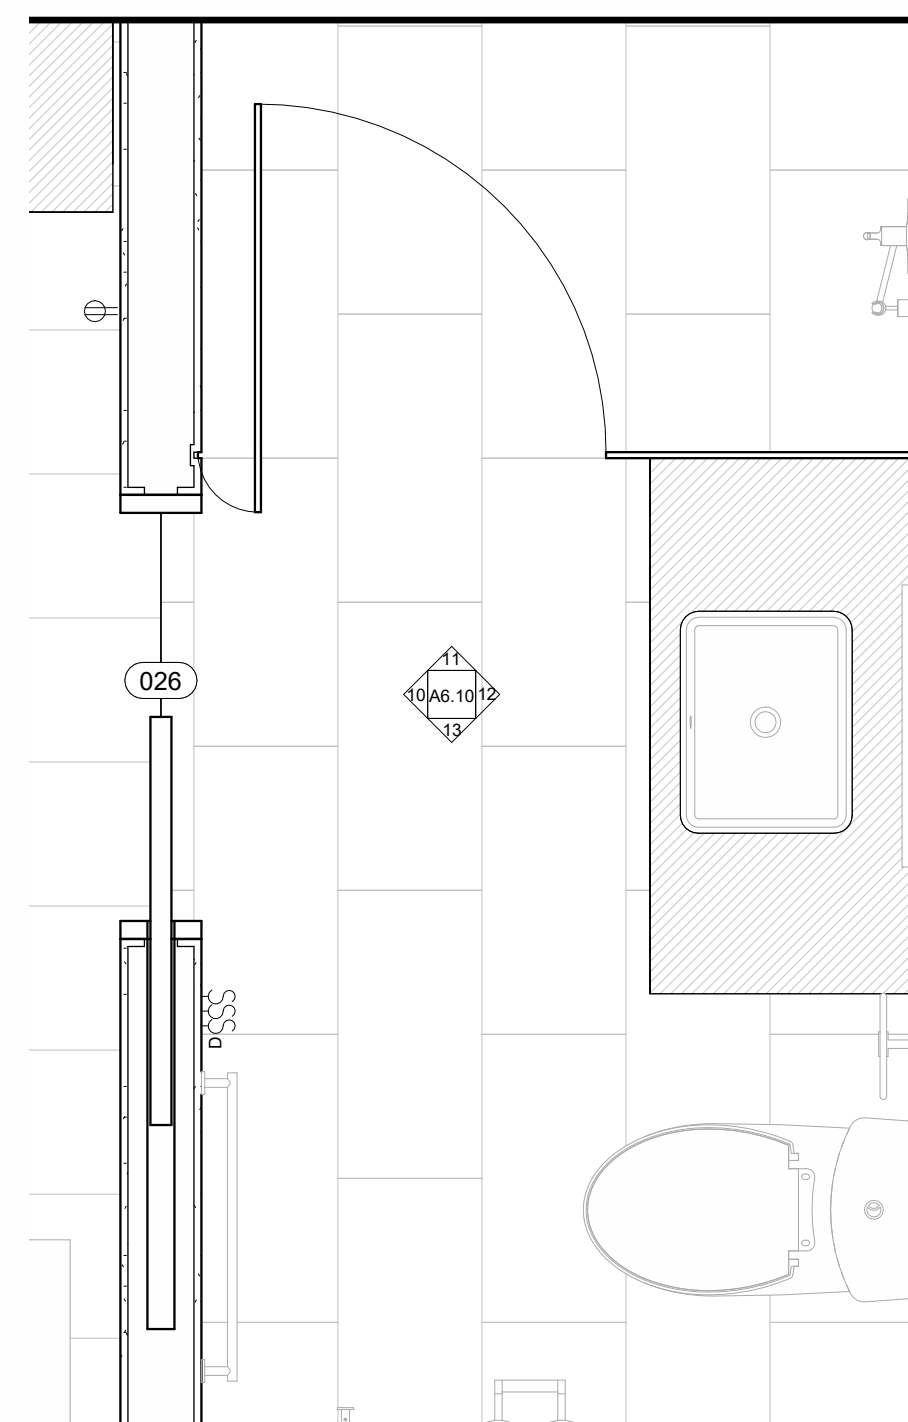


9 026 IN-LAW BATHROOM
 3/4" = 1'-0"

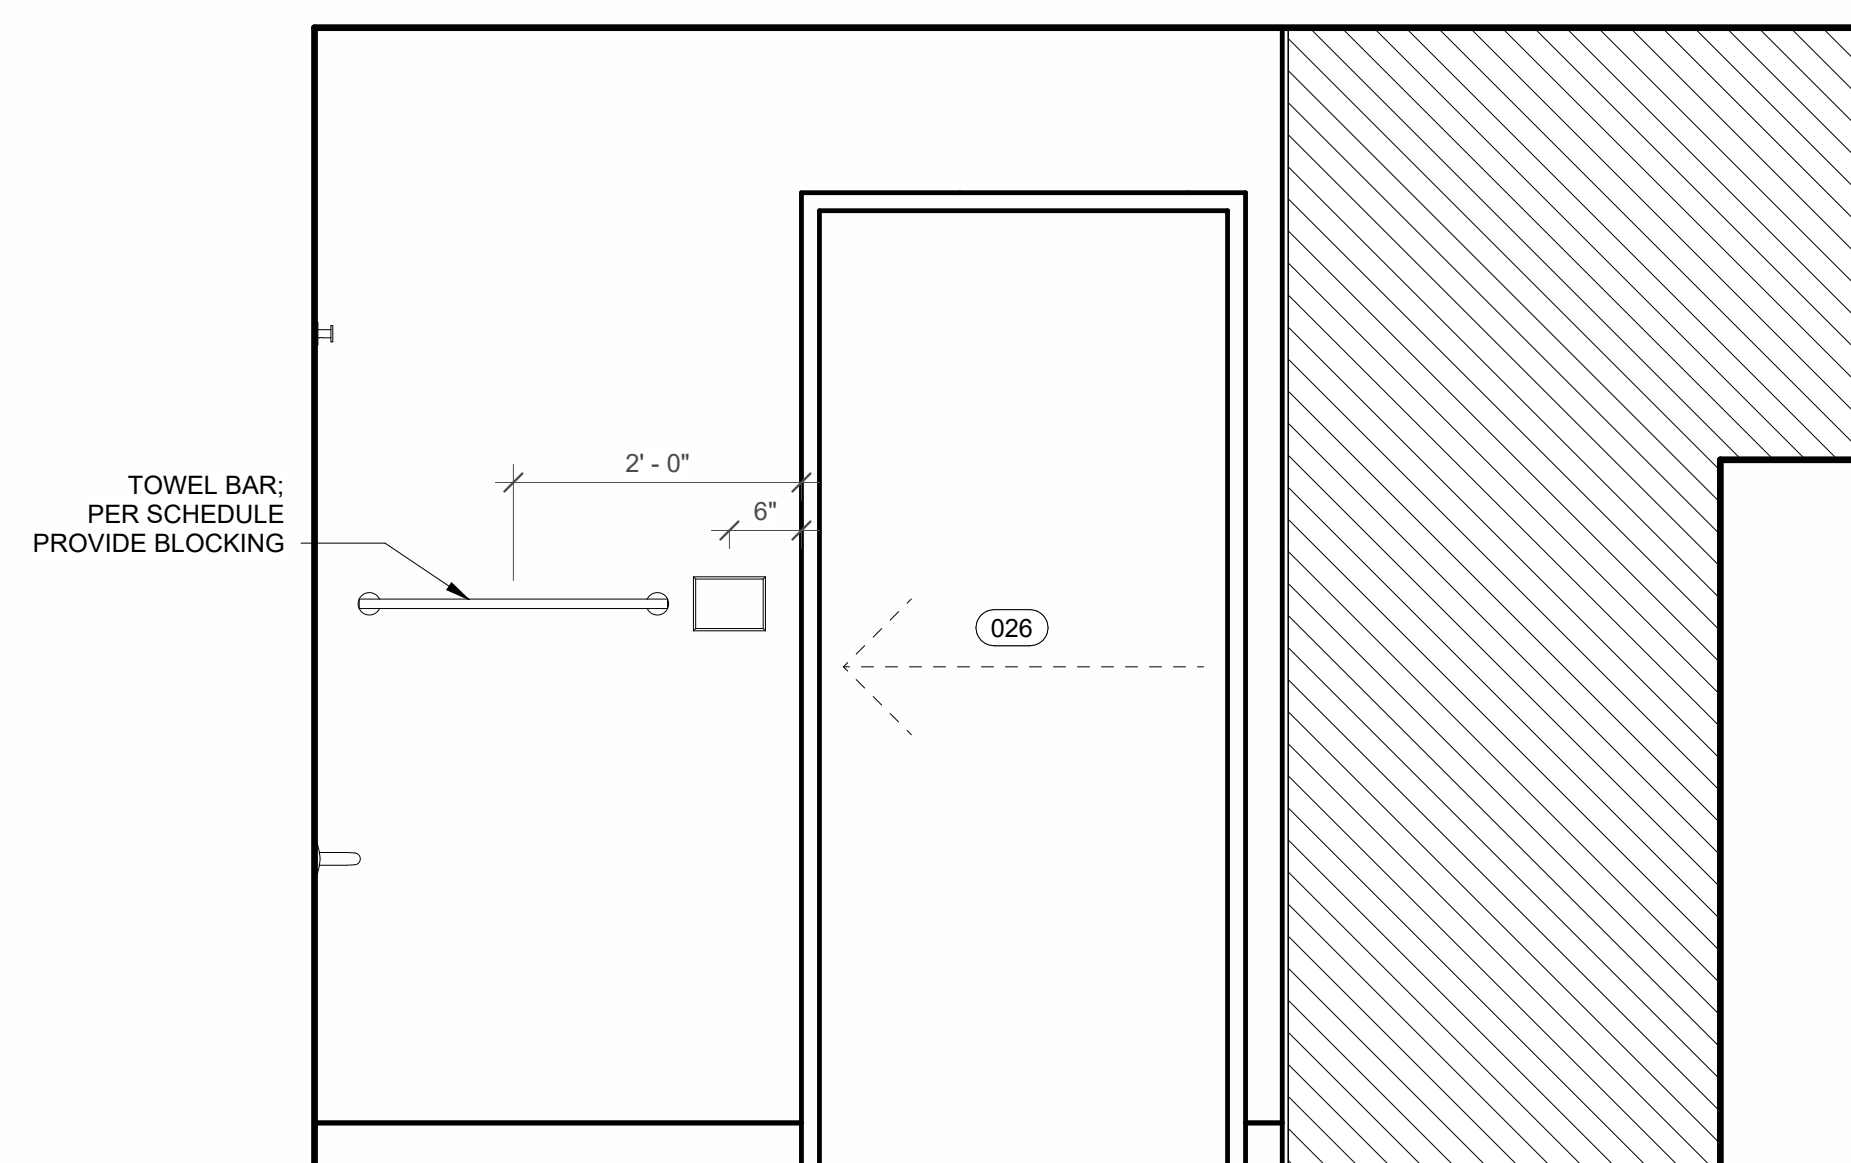


10 026 IN-LAW BATHROOM - WEST ELEVATION
 3/4" = 1'-0"

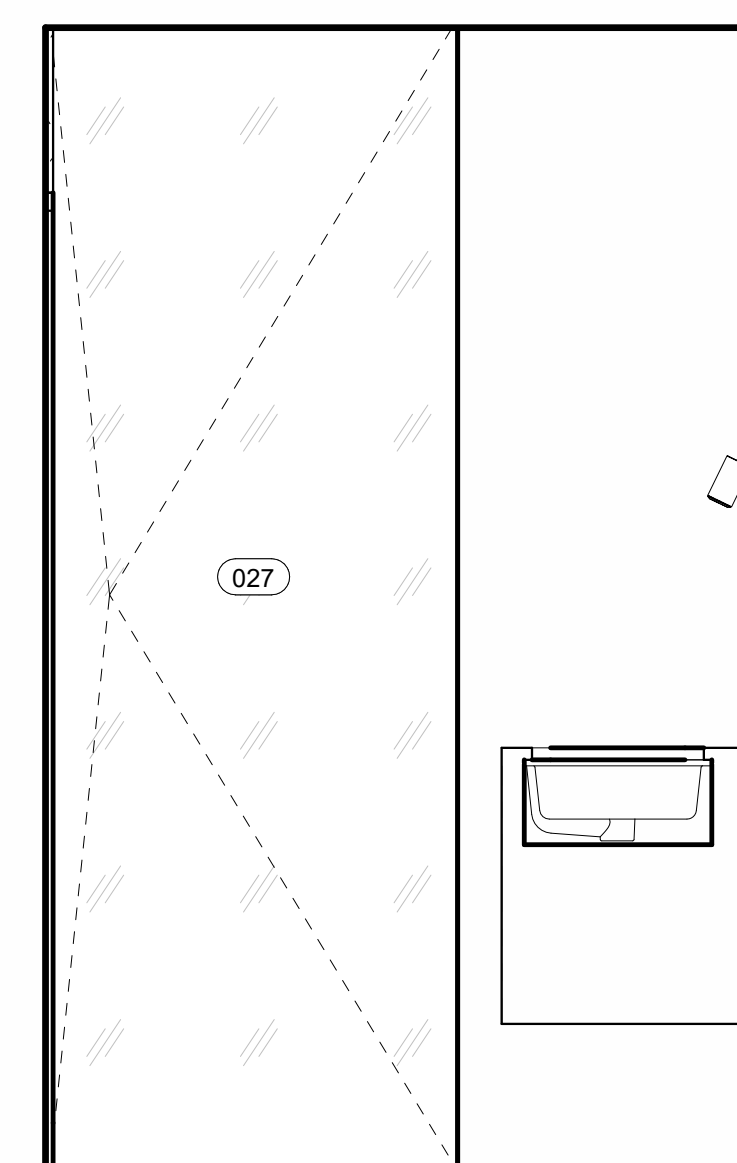

11 026 IN-LAW BATHROOM - NORTH ELEVATION
 3/4" = 1'-0"

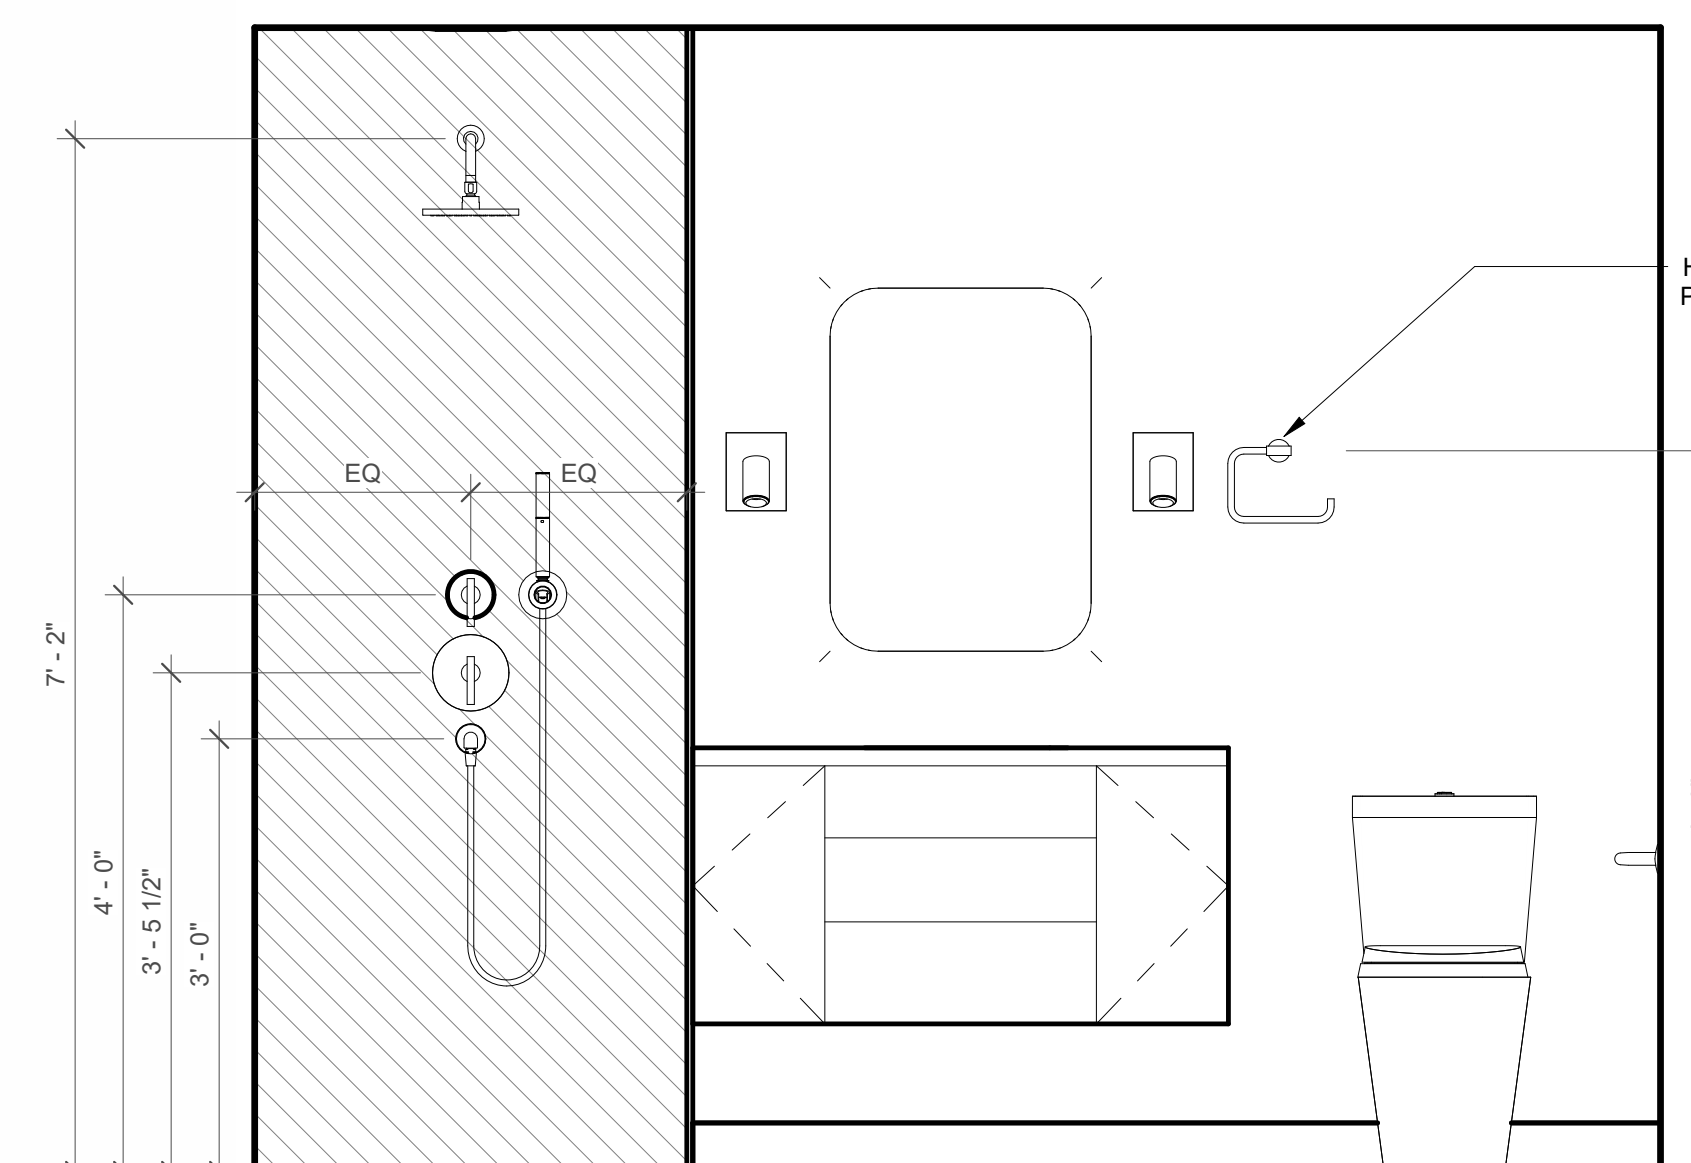

12 026 IN-LAW BATHROOM - EAST ELEVATION
 3/4" = 1'-0"

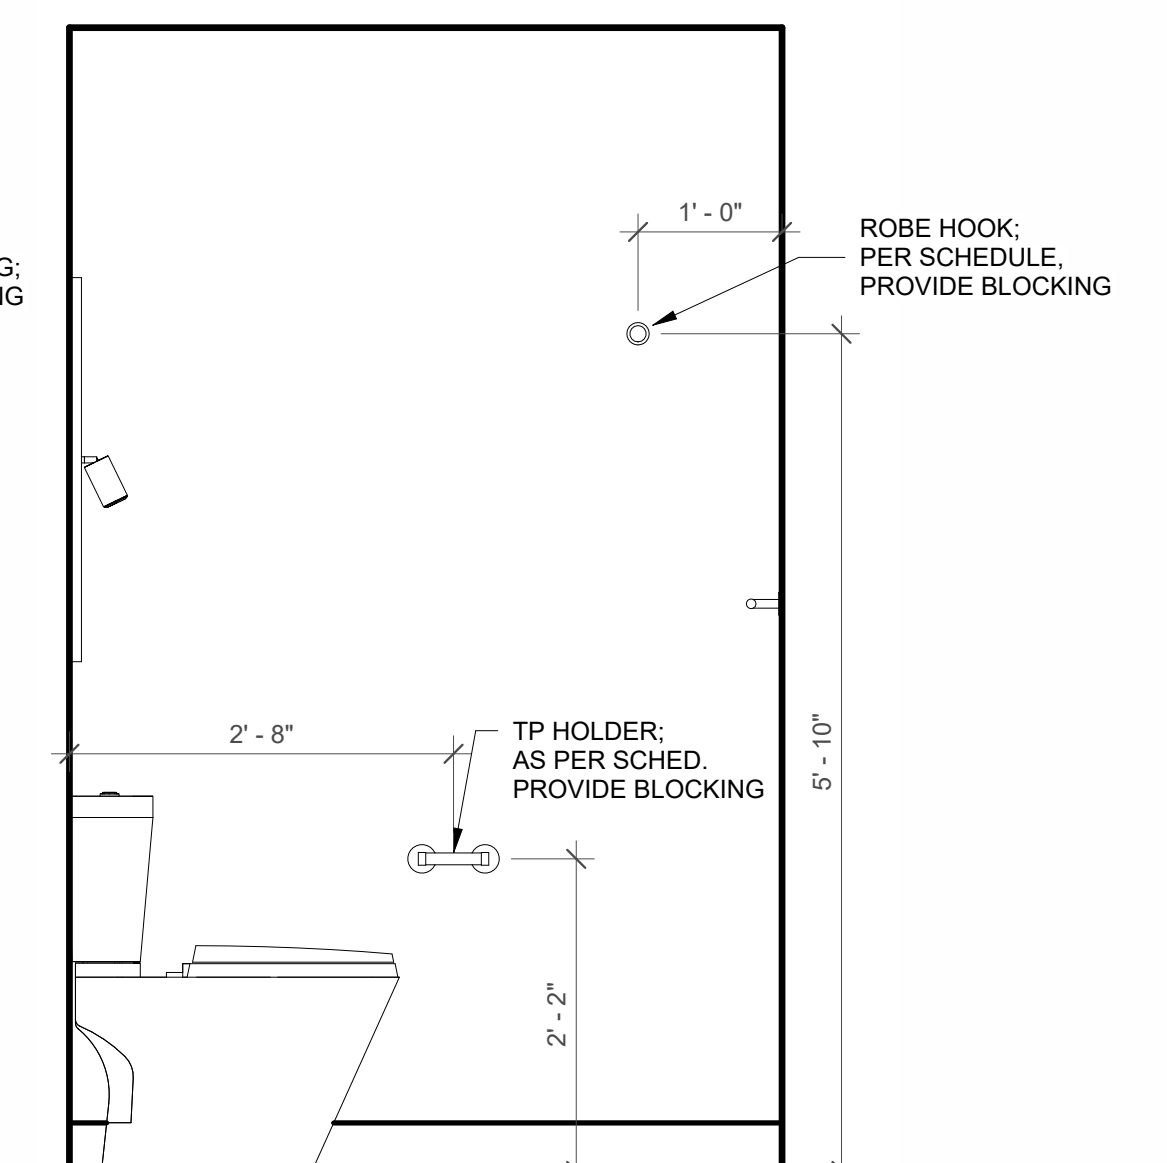




13 026 IN-LAW BATHROOM - SOUTH ELEVATION
 3/4" = 1'-0"

REVISION HISTORY		
NO.	DESCRIPTION	DATE

PERMIT REVISION	
DATE:	AUG 18, 2023
SCALE:	As indicated
DRAWN BY:	CJ
CHECKED BY:	CR

SHEET TITLE PROJECT #: 40035




ENLARGED INTERIOR PLANS & ELEVATIONS

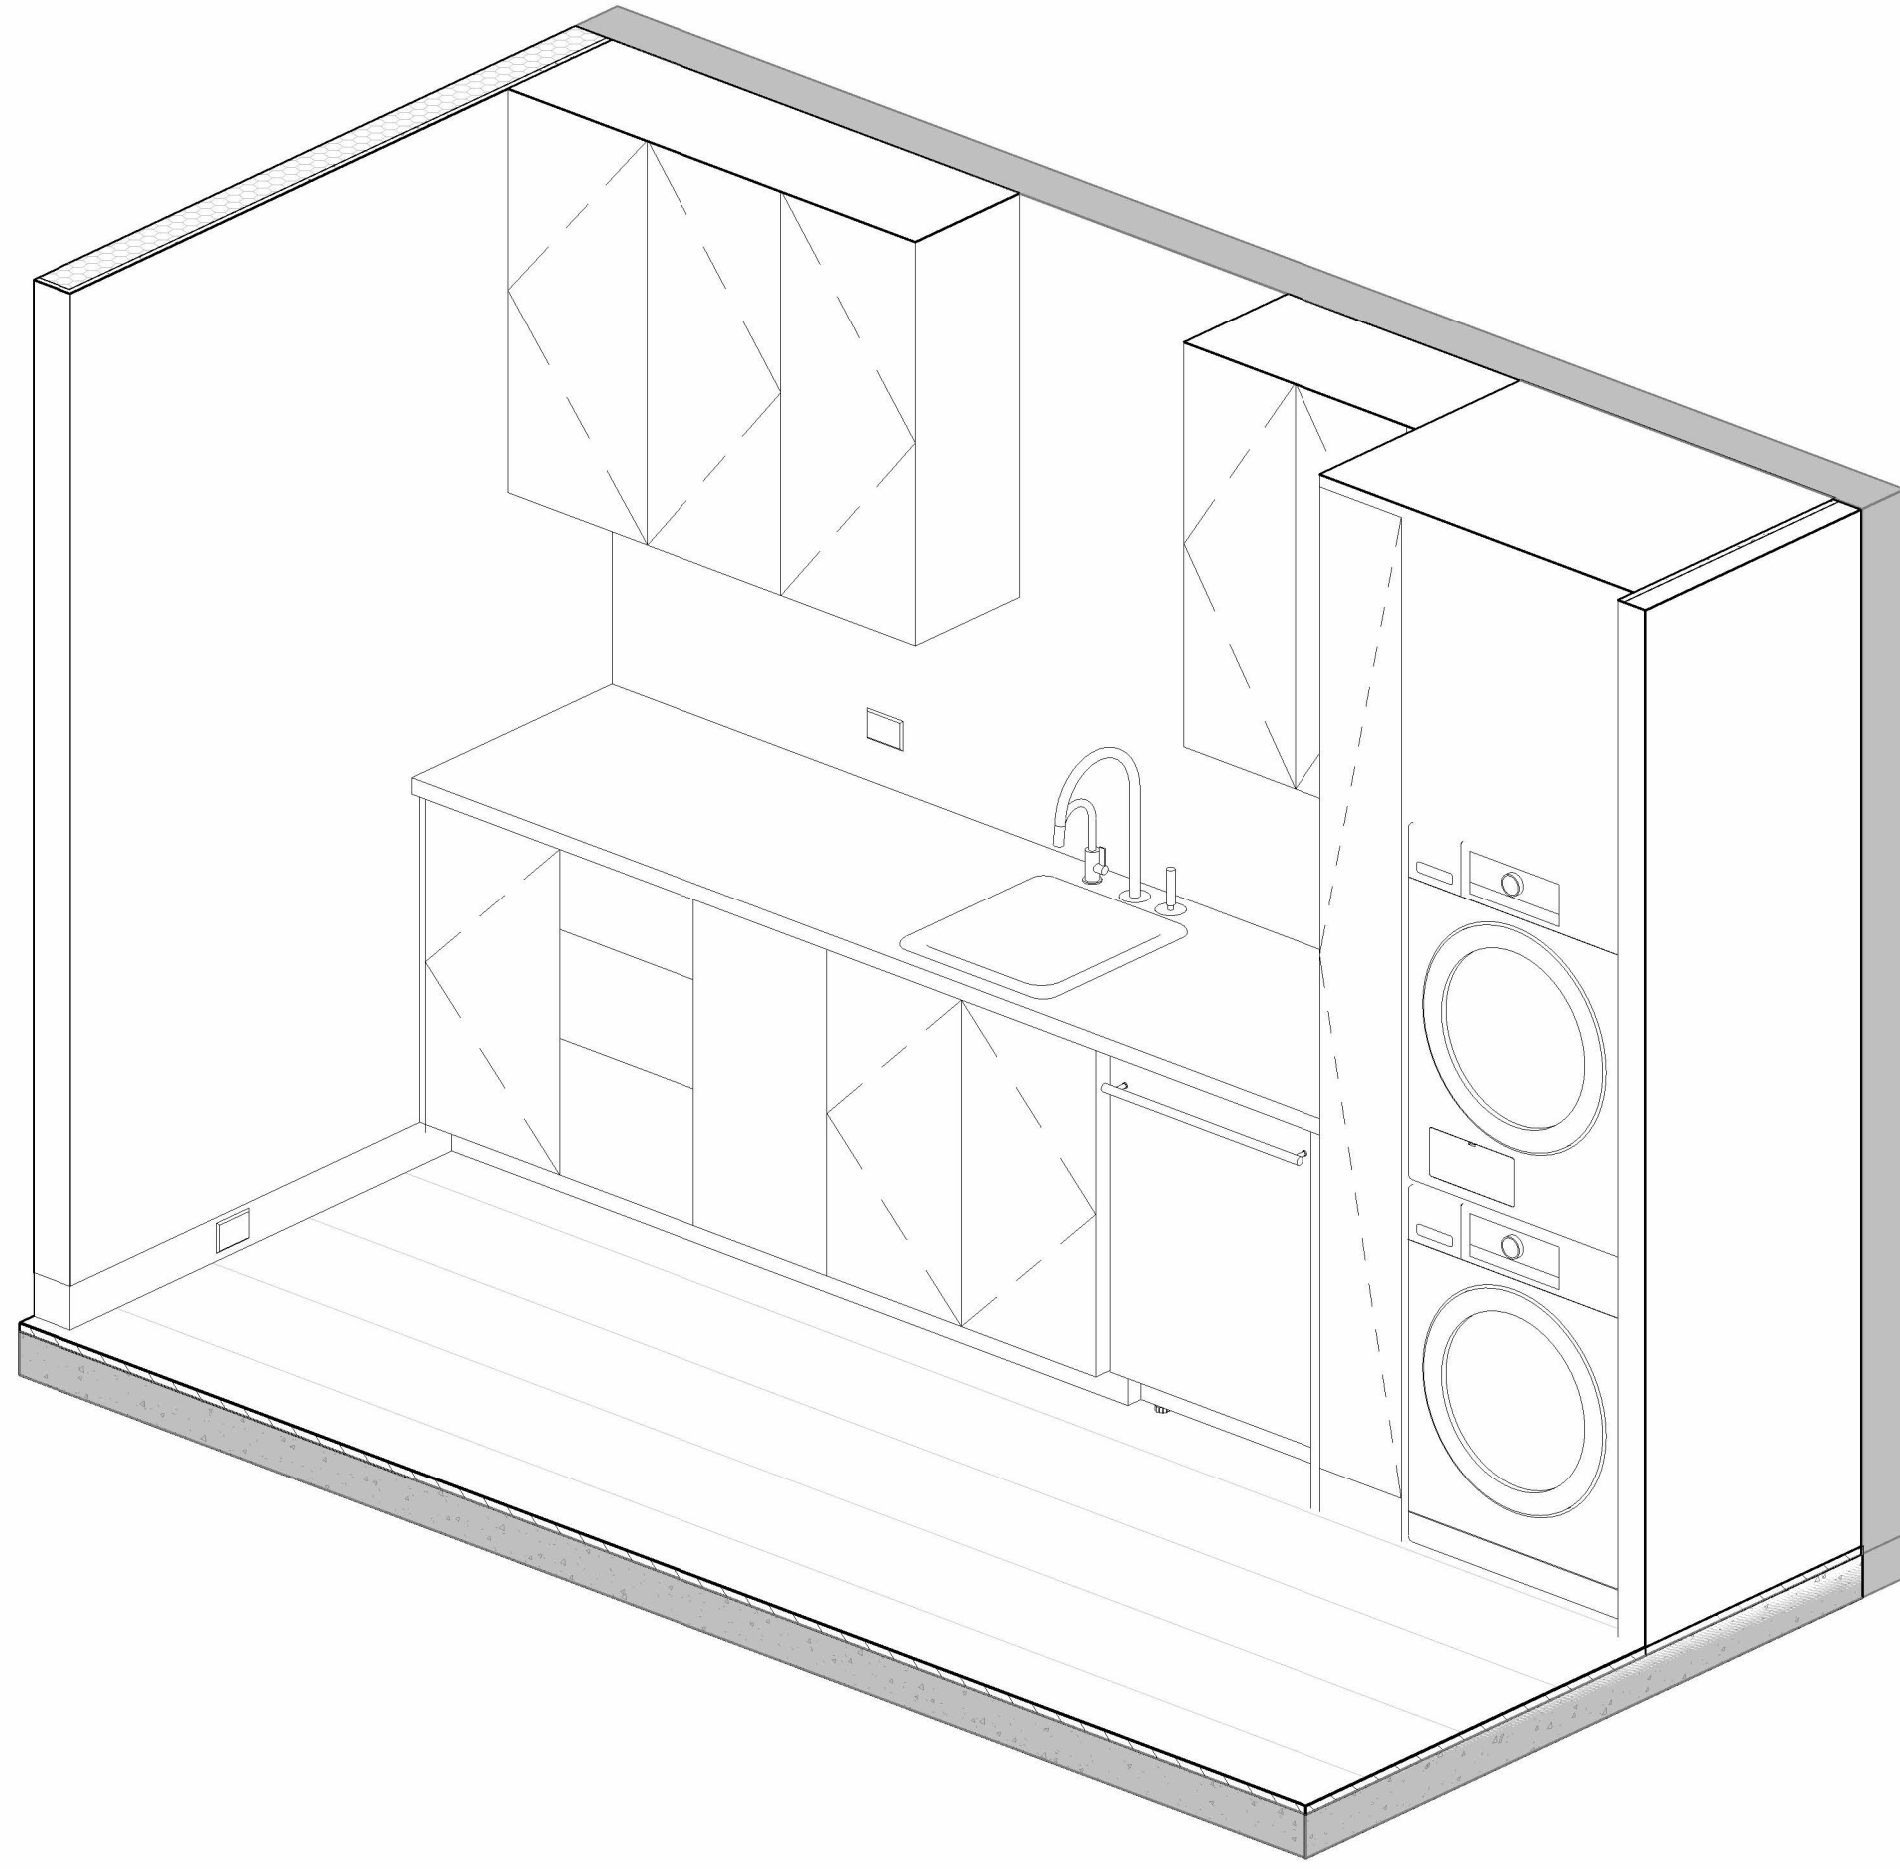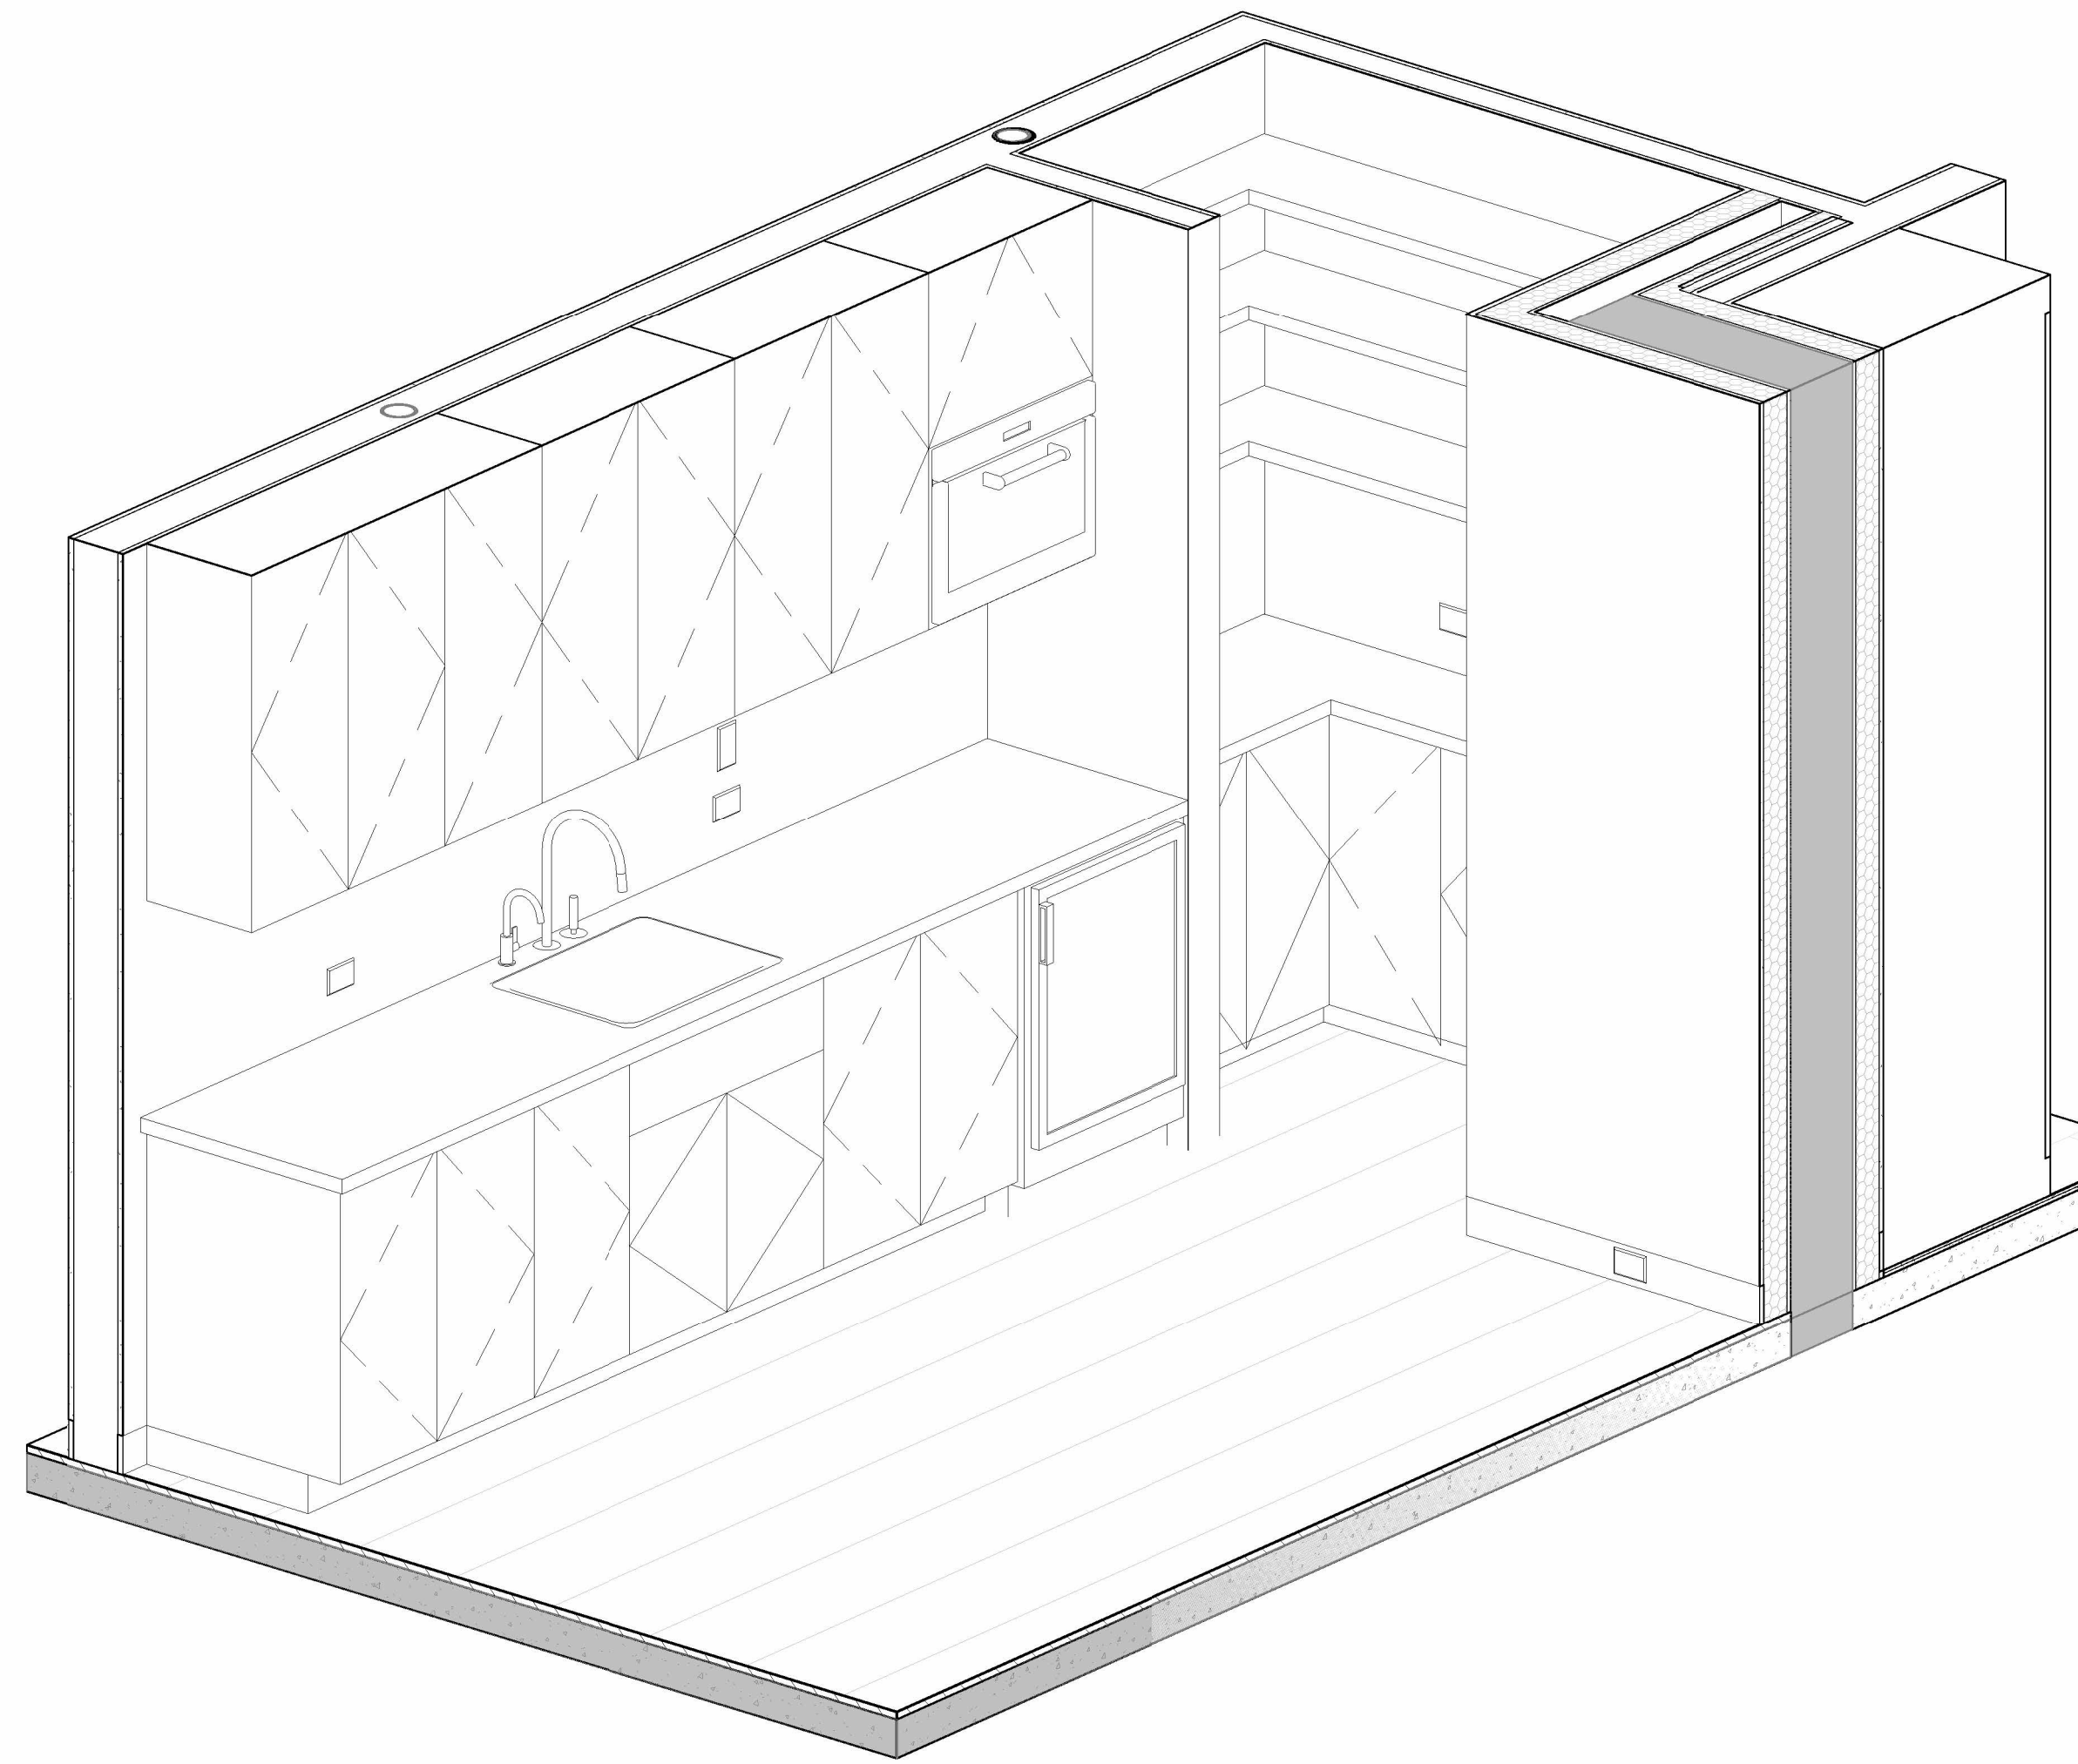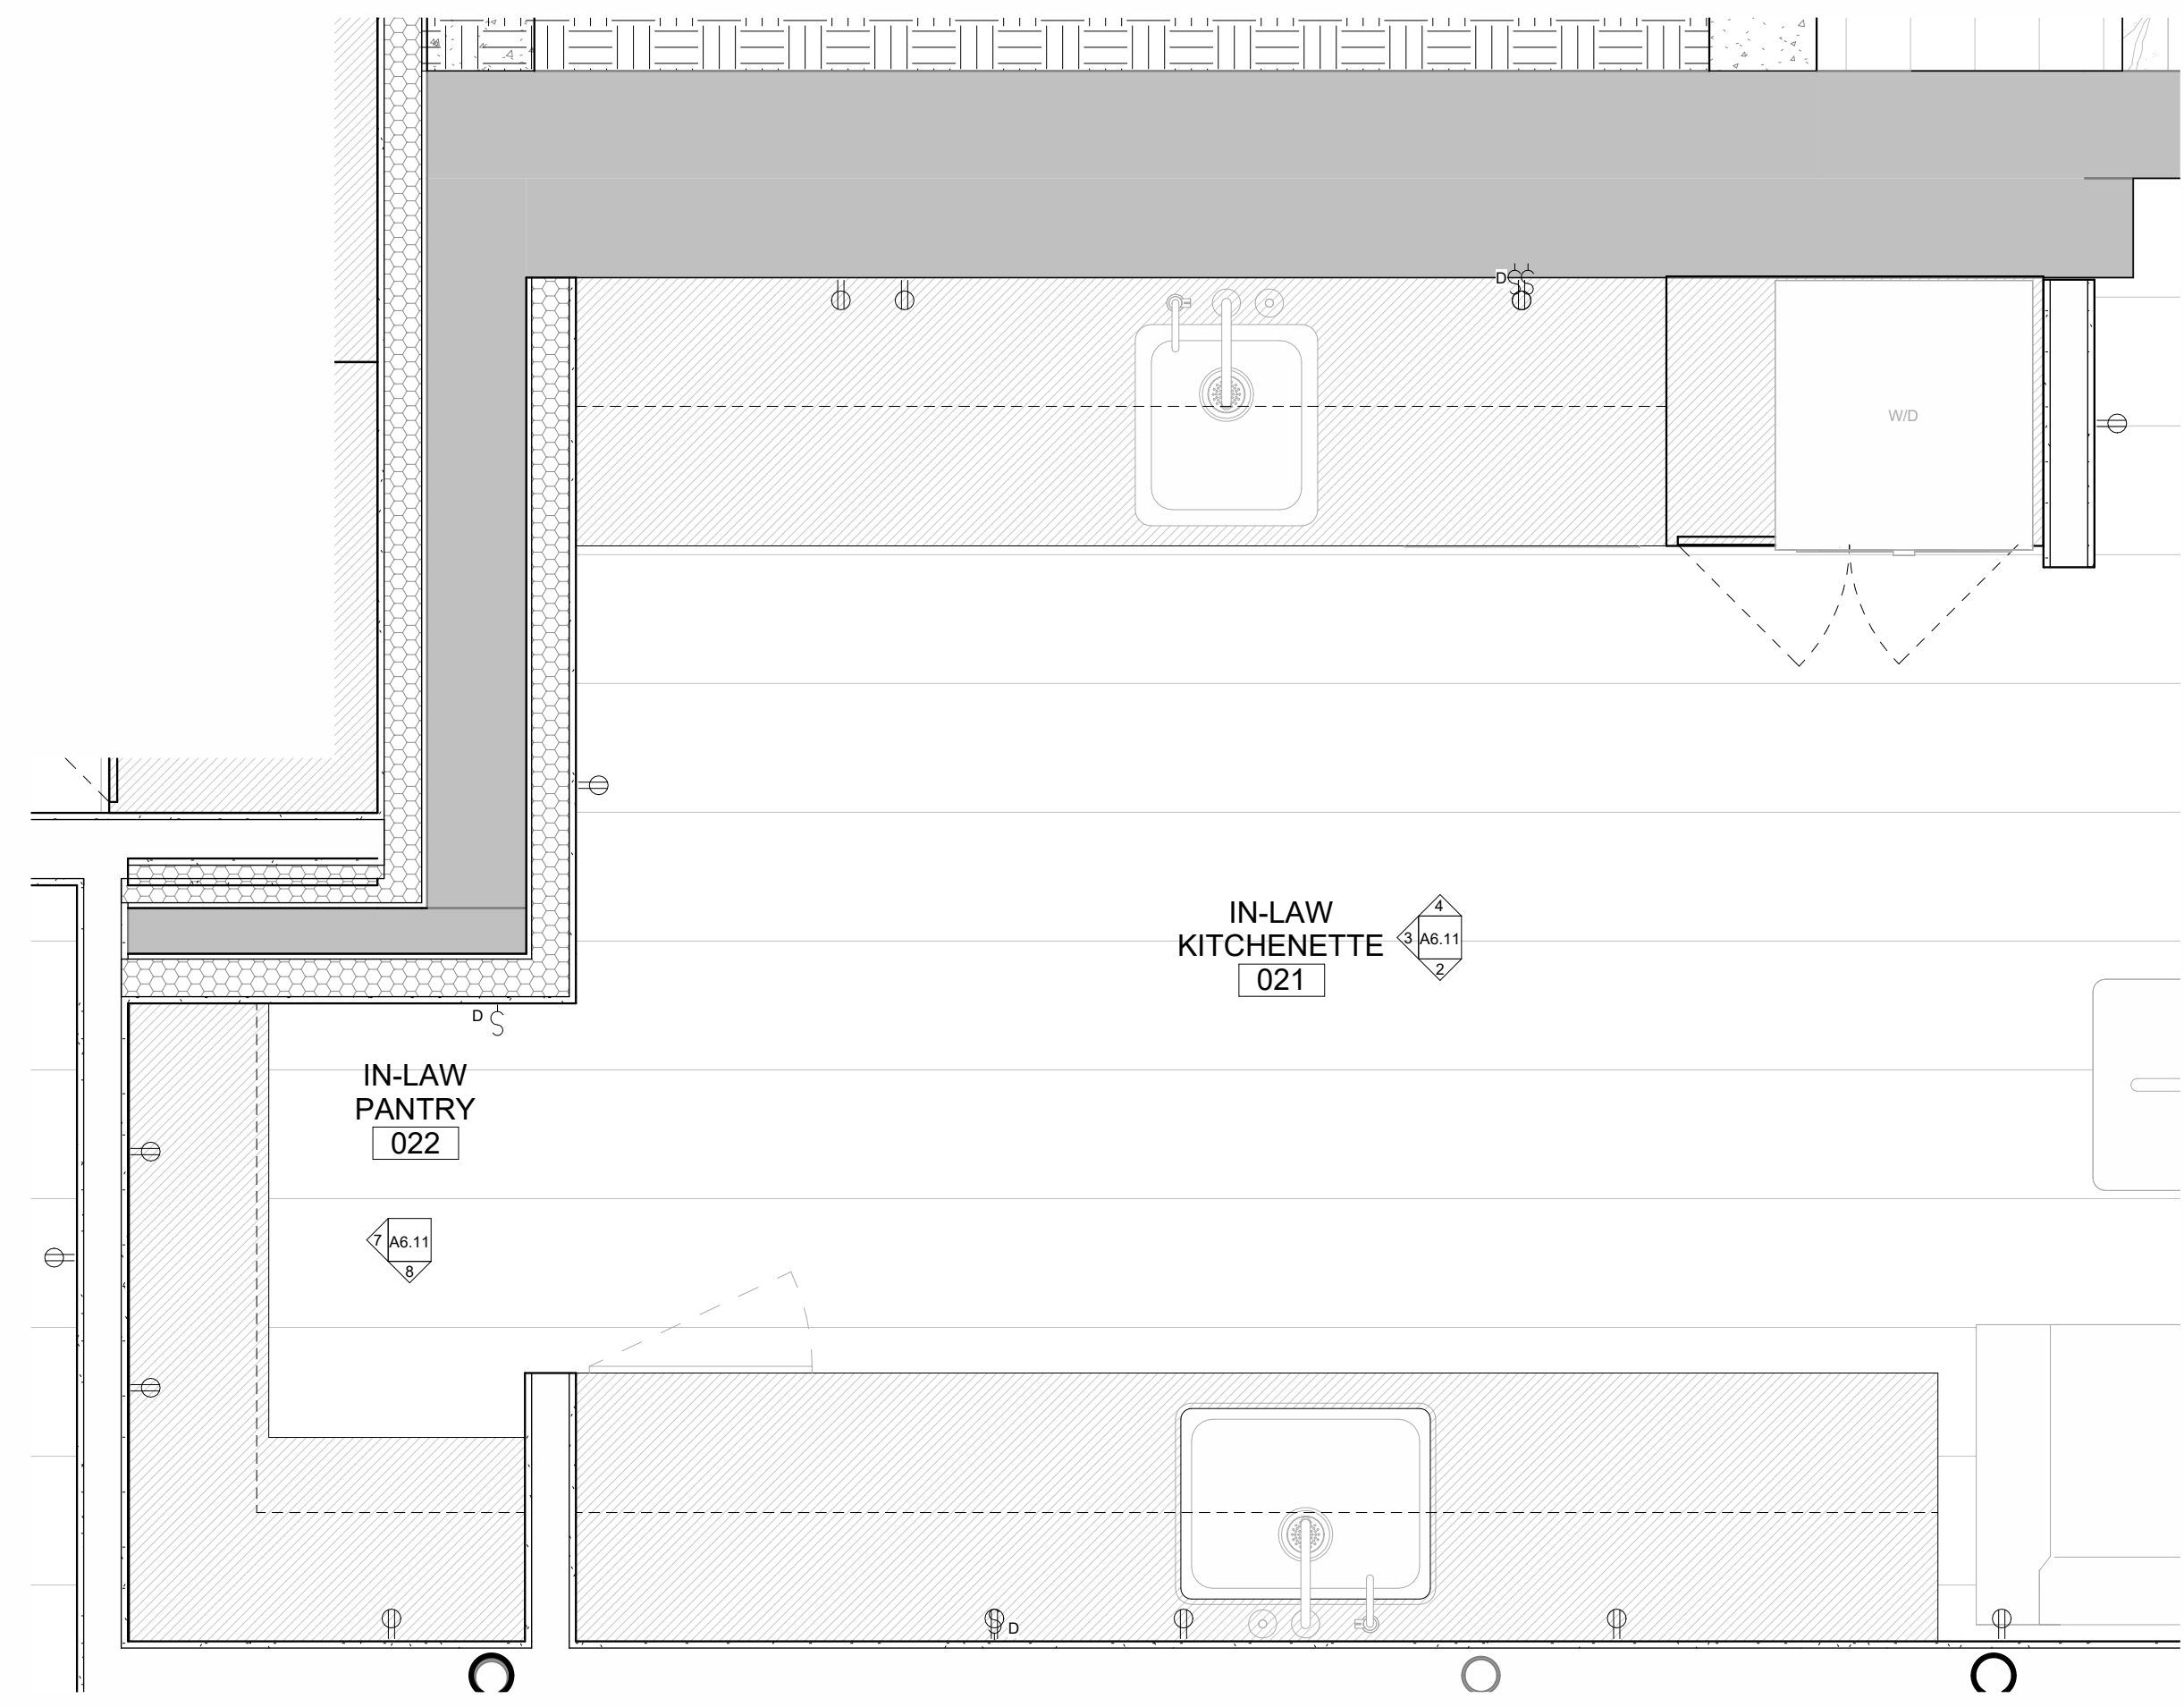

1 021 IN-LAW KITCHEN
 3/4" = 1'-0"

5 021 IN-LAW KITCHEN - ORTHOGRAPHIC VIEW A



6 021 IN-LAW KITCHEN - ORTHOGRAPHIC VIEW B

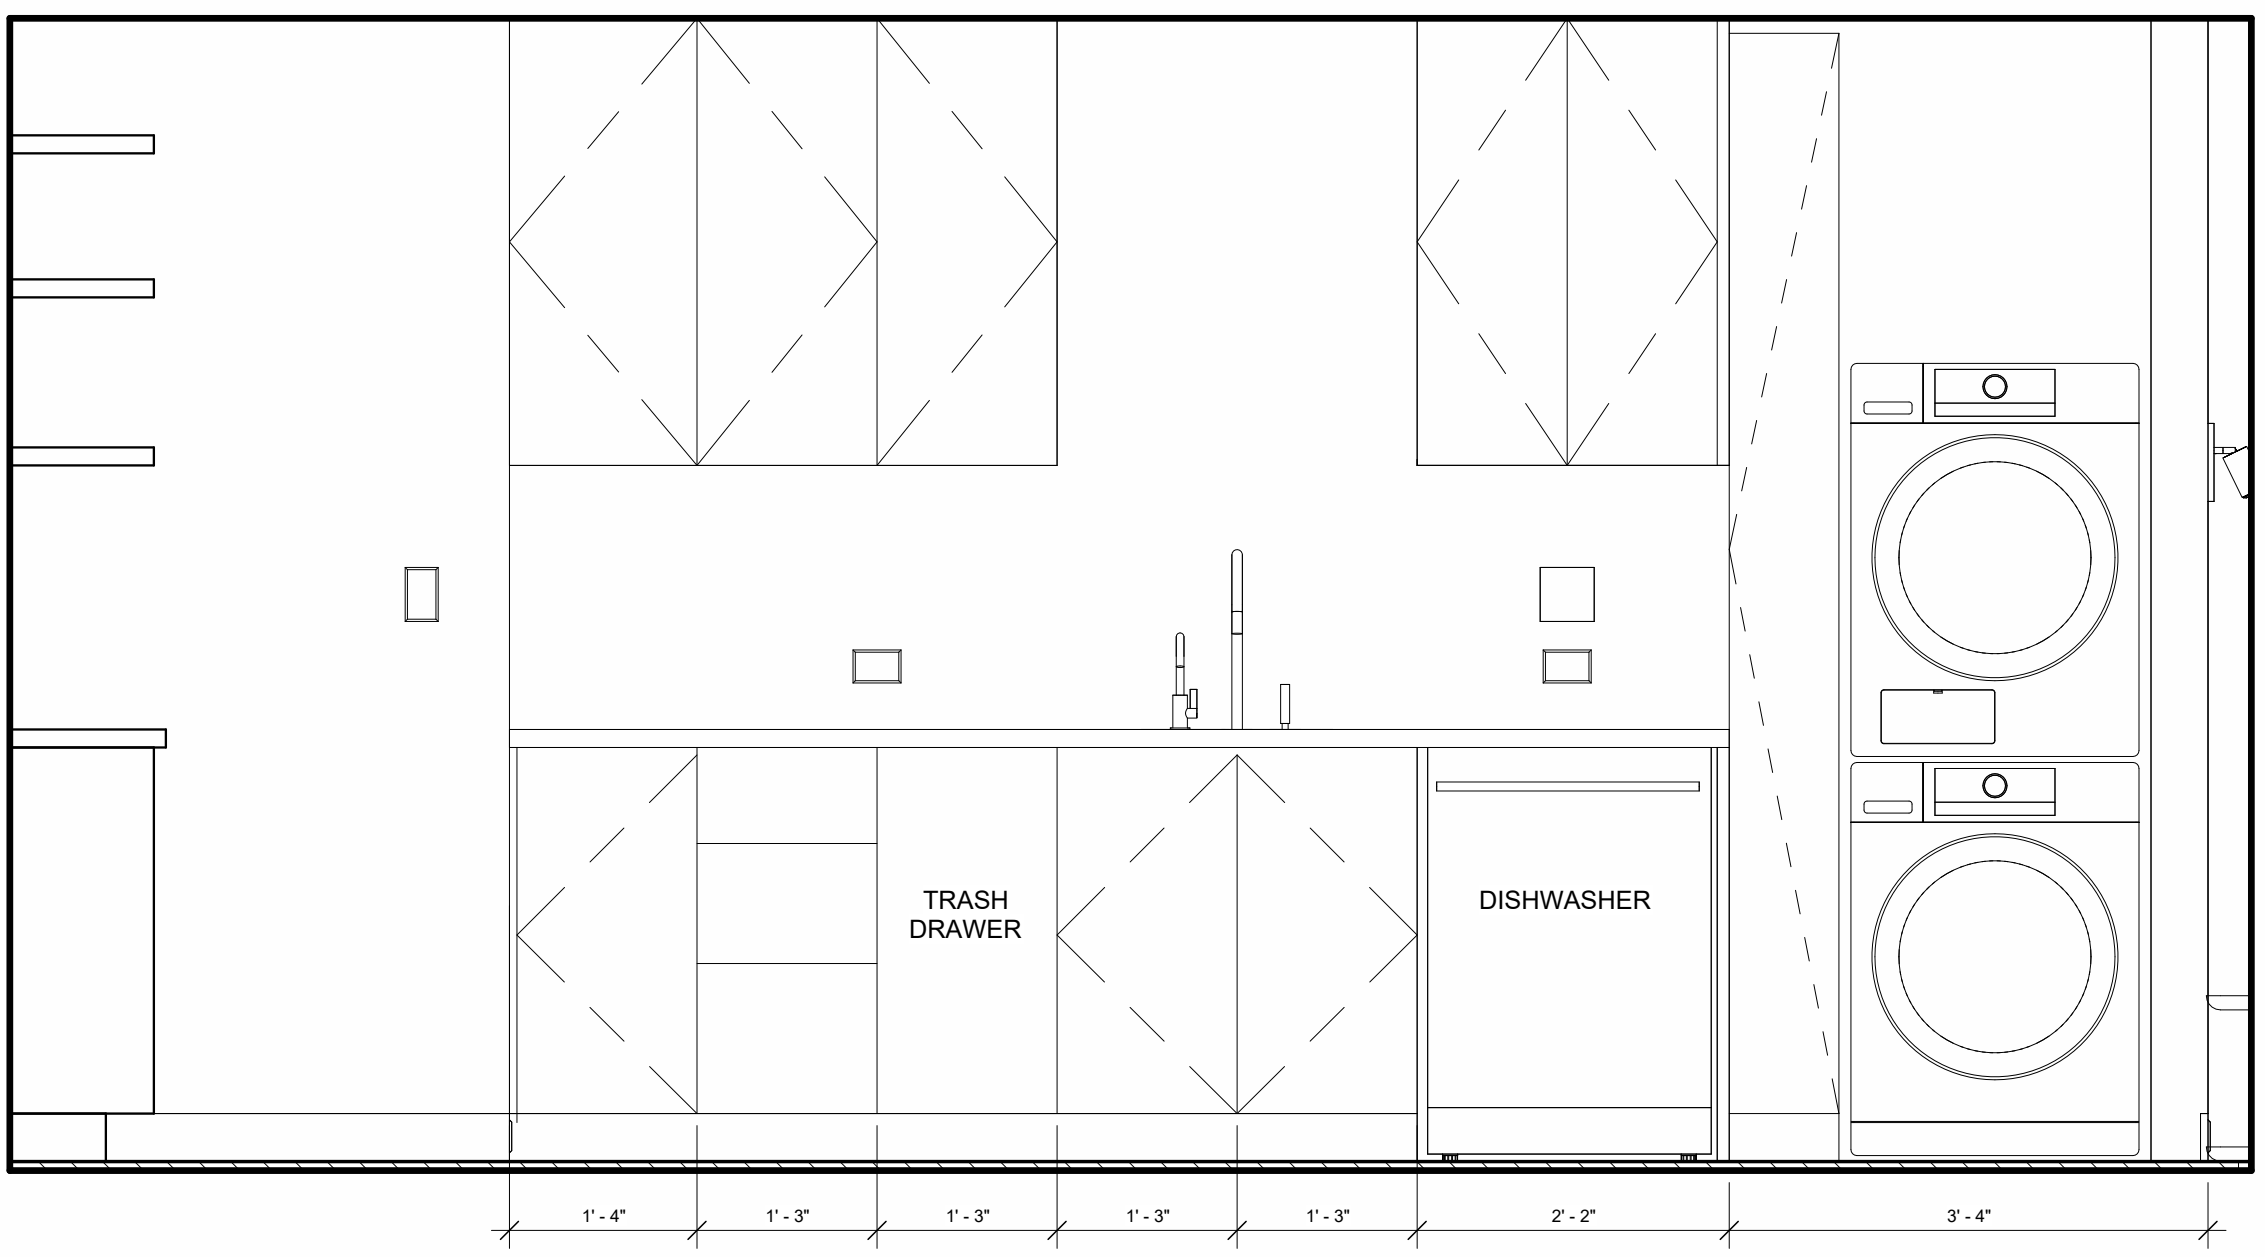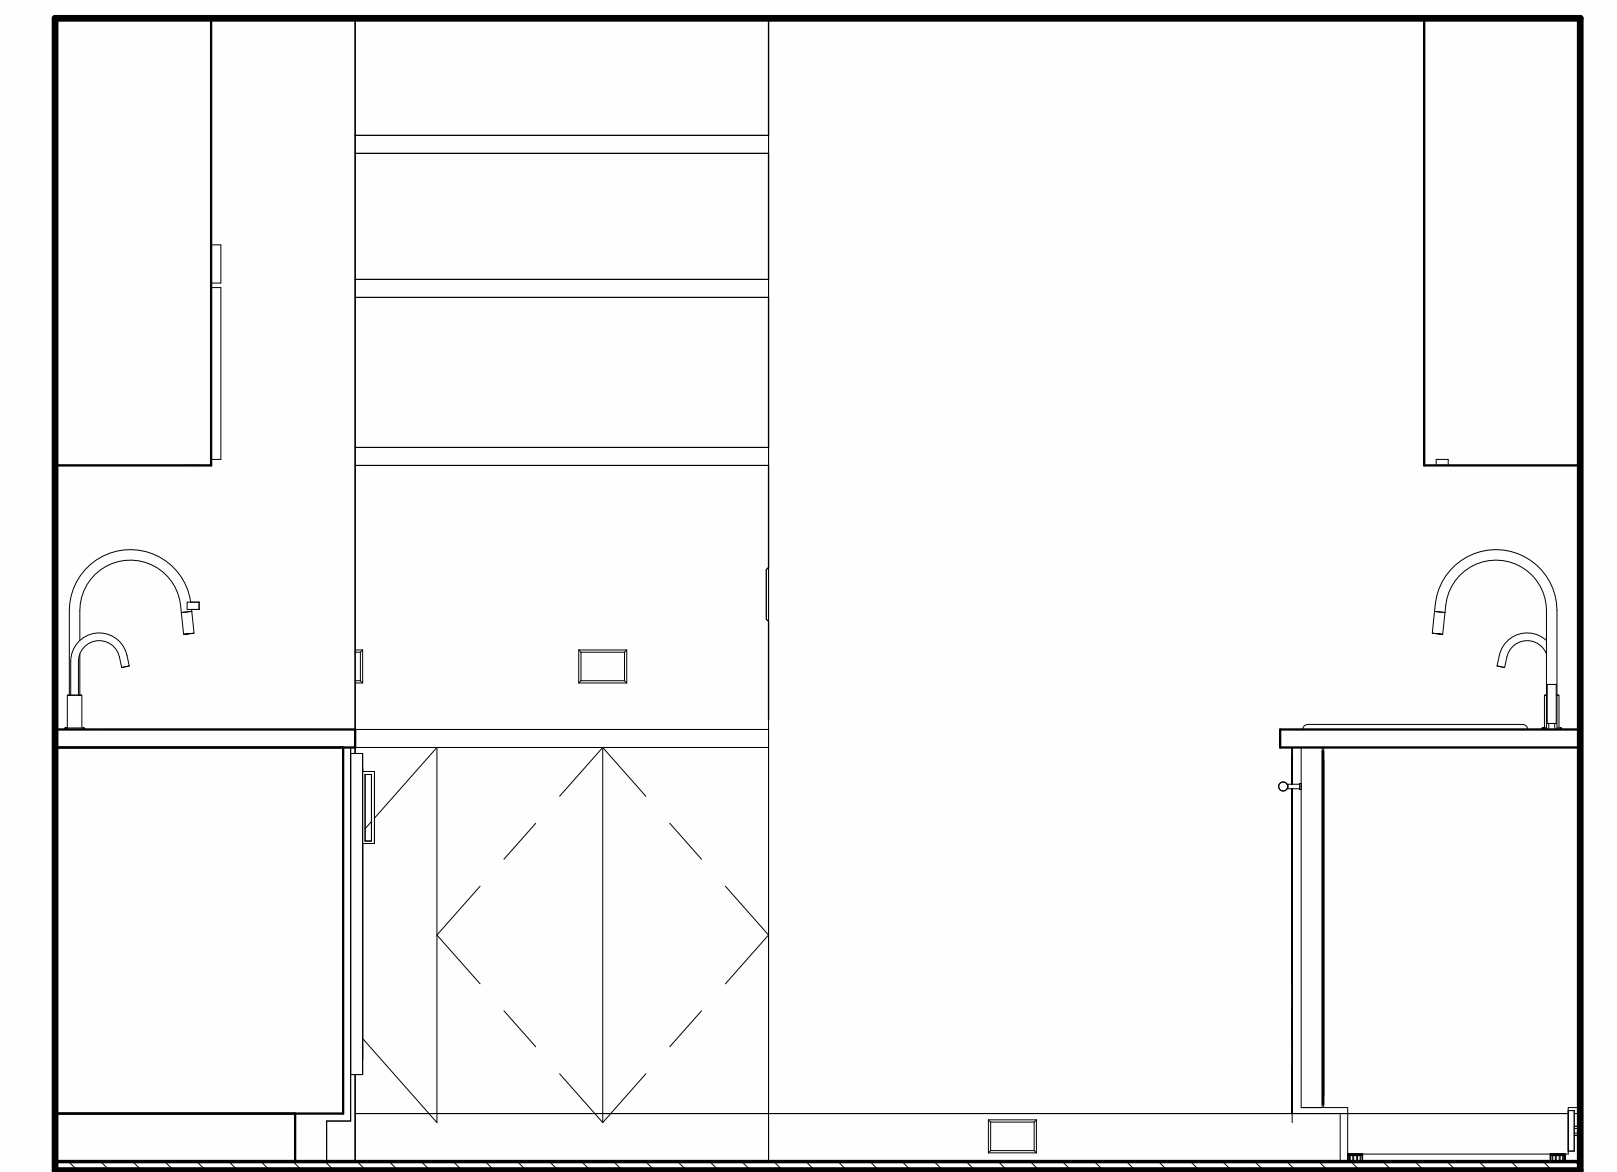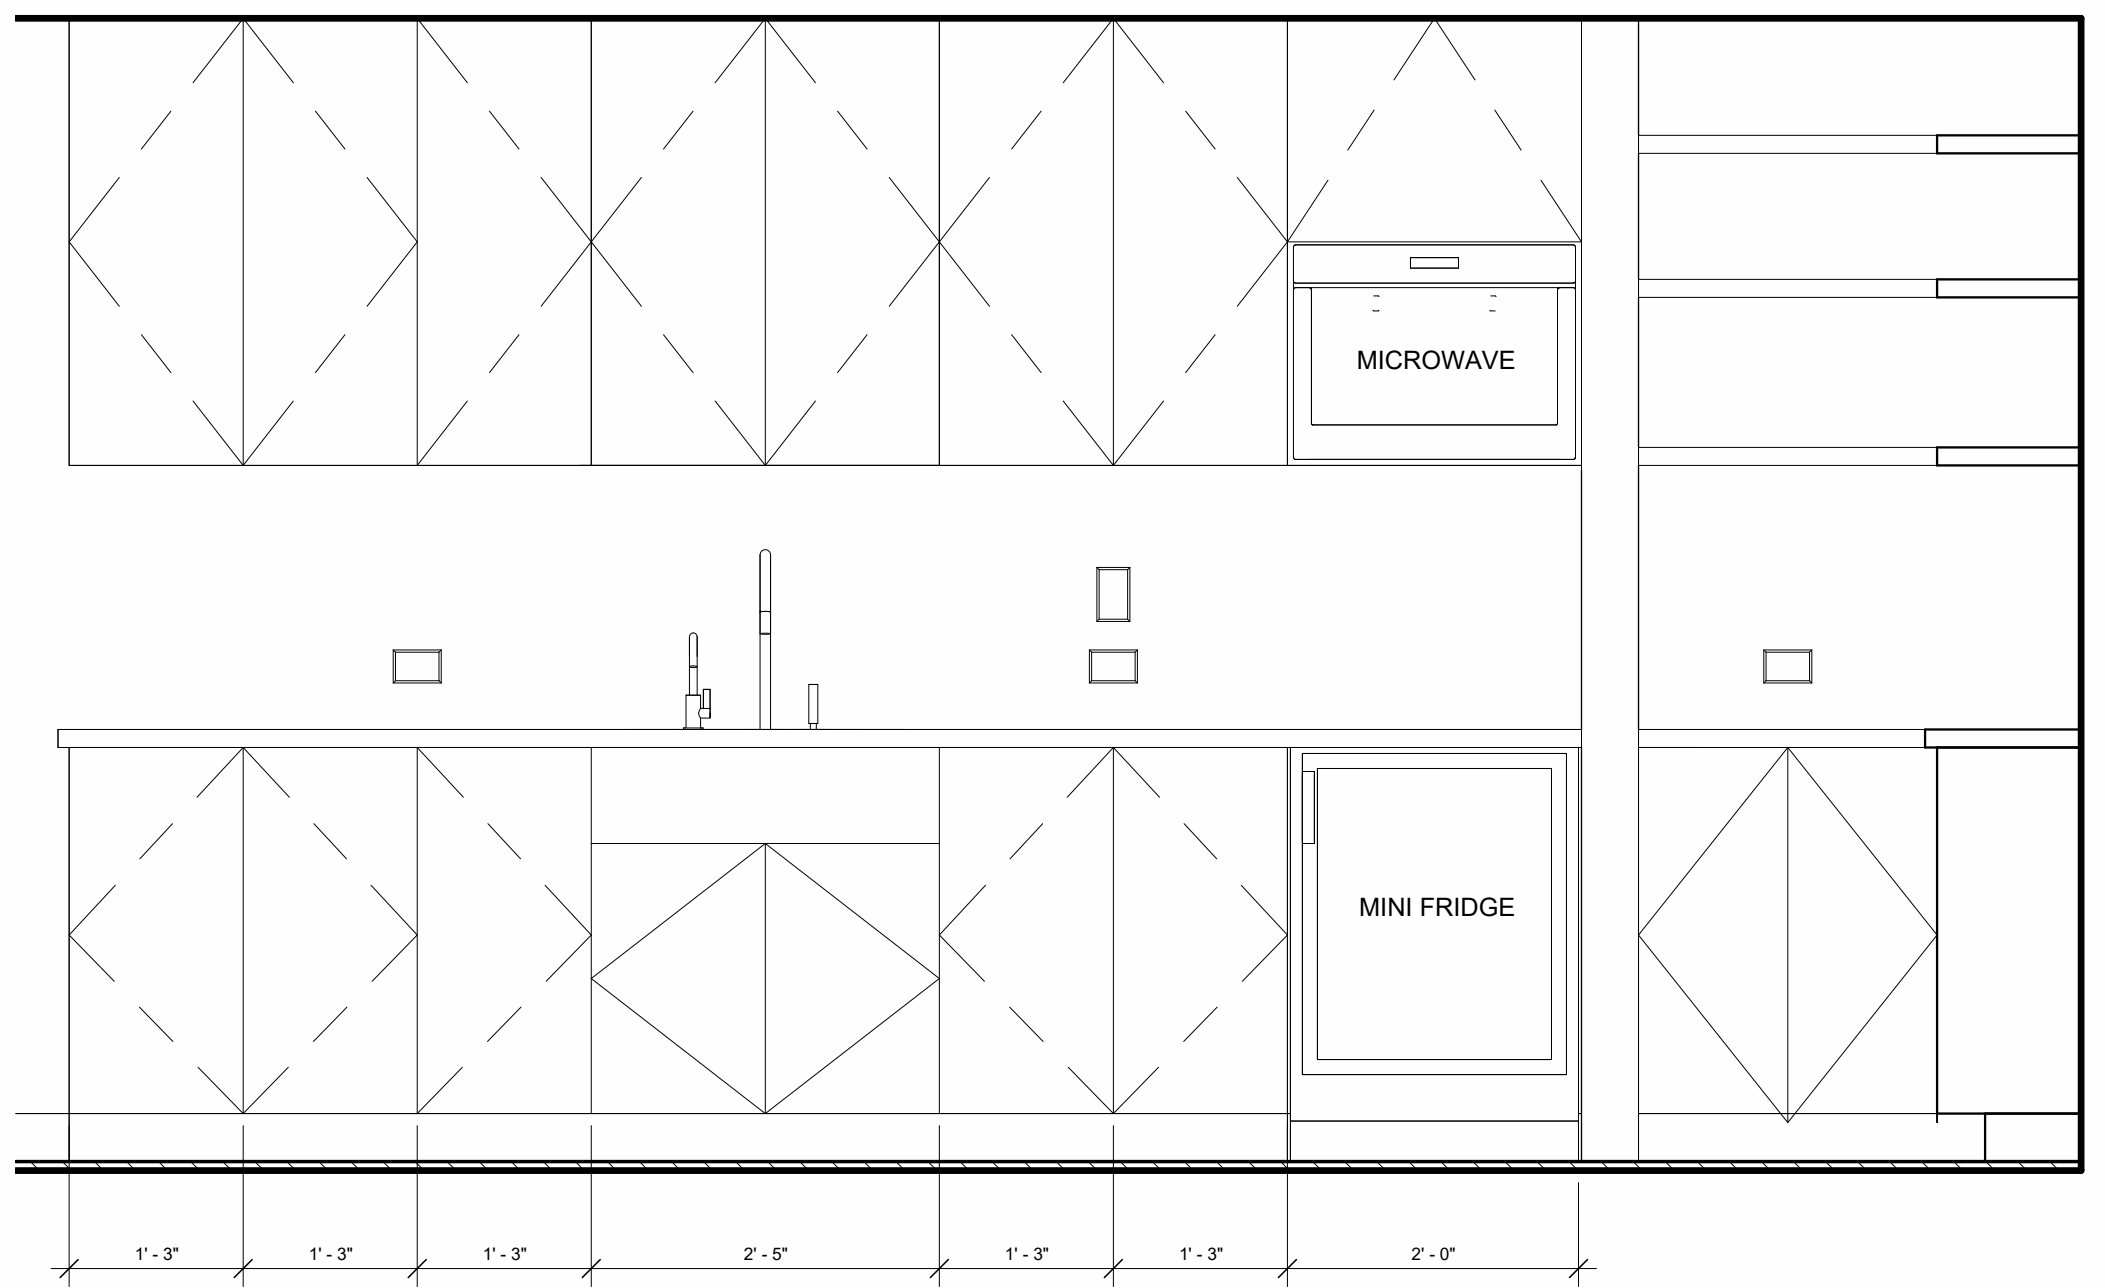

2 021 IN-LAW KITCHEN - SOUTH ELEVATION
 3/4" = 1'-0"

3 021 IN-LAW KITCHEN - WEST ELEVATION
 3/4" = 1'-0"

4 021 IN-LAW KITCHEN - NORTH ELEVATION
 3/4" = 1'-0"

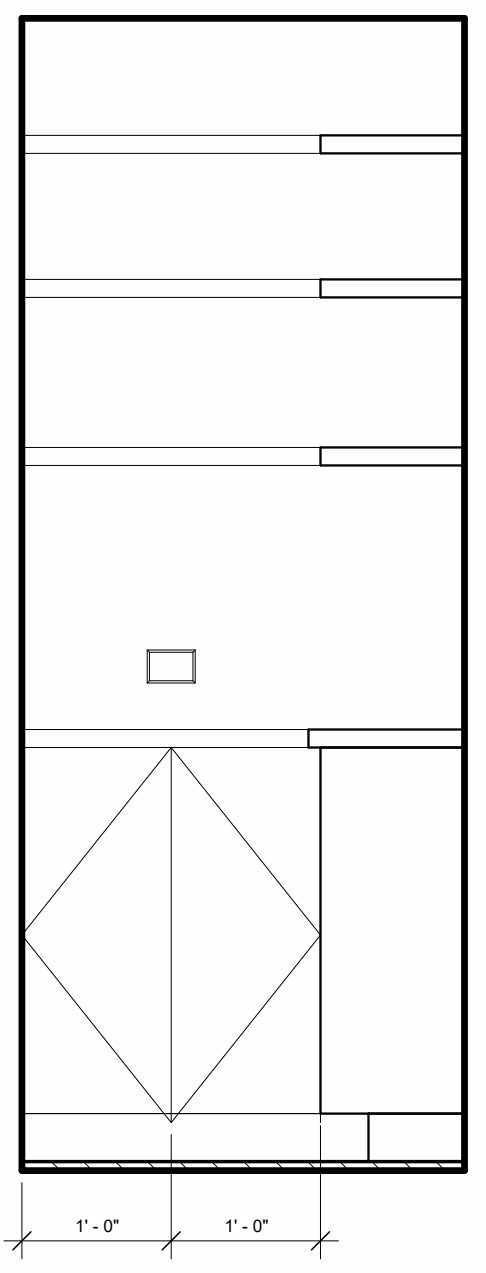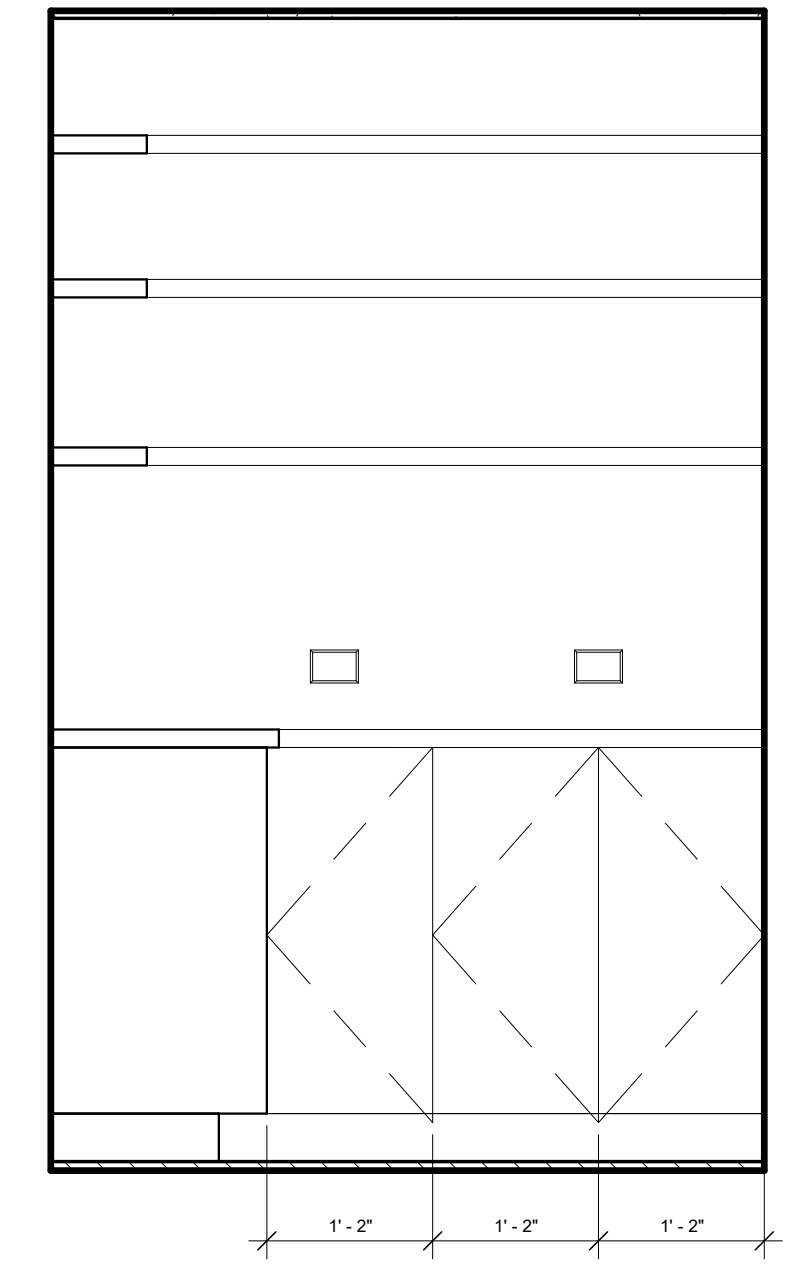

7 022 PANTRY - WEST ELEVATION
 3/4" = 1'-0"


8 022 PANTRY - SOUTH ELEVATION
 3/4" = 1'-0"

REVISION HISTORY		
NO.	DESCRIPTION	DATE


PERMIT REVISION	
DATE:	SEPT 6, 2023
SCALE:	3/4" = 1'-0"
DRAWN BY:	CJ
CHECKED BY:	CR

SHEET TITLE PROJECT #: 40035


ENLARGED INTERIOR PLANS & ELEVATIONS

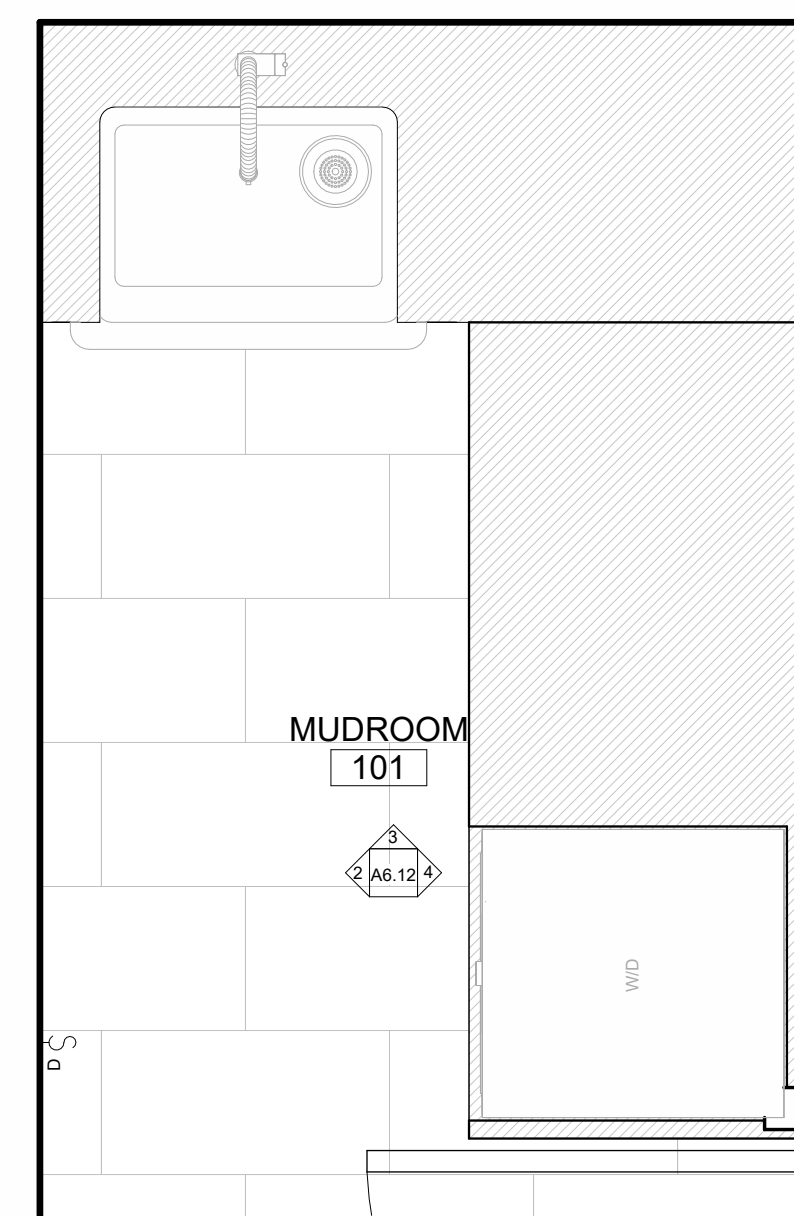


1 101 MUDROOM
 3/4" = 1'-0"

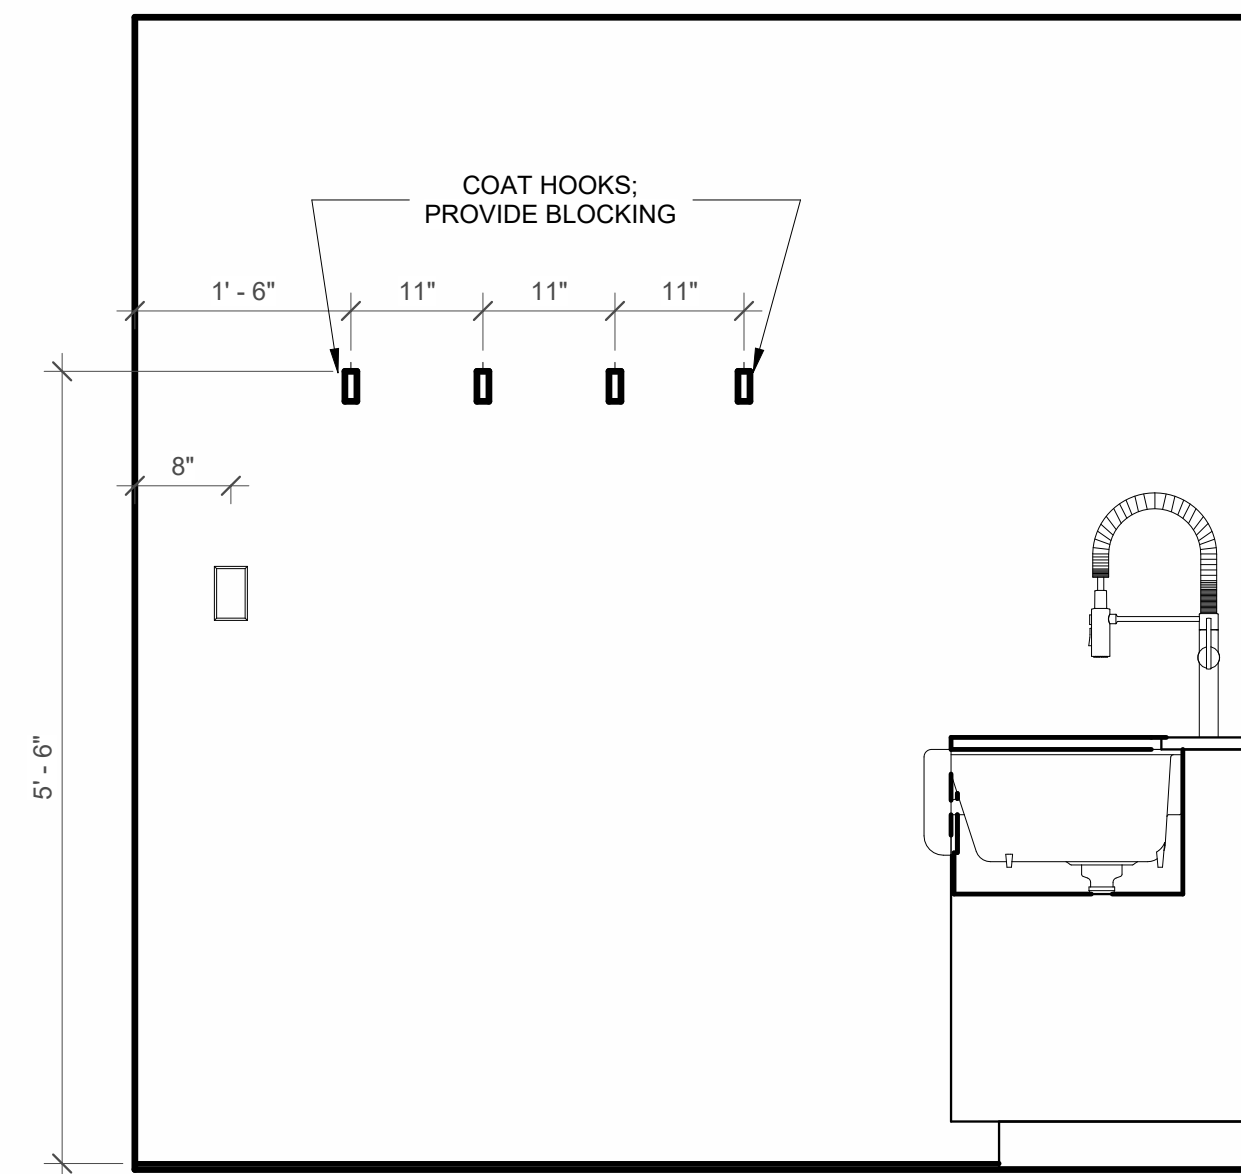


2 101 MUDROOM - WEST ELEVATION
 3/4" = 1'-0"

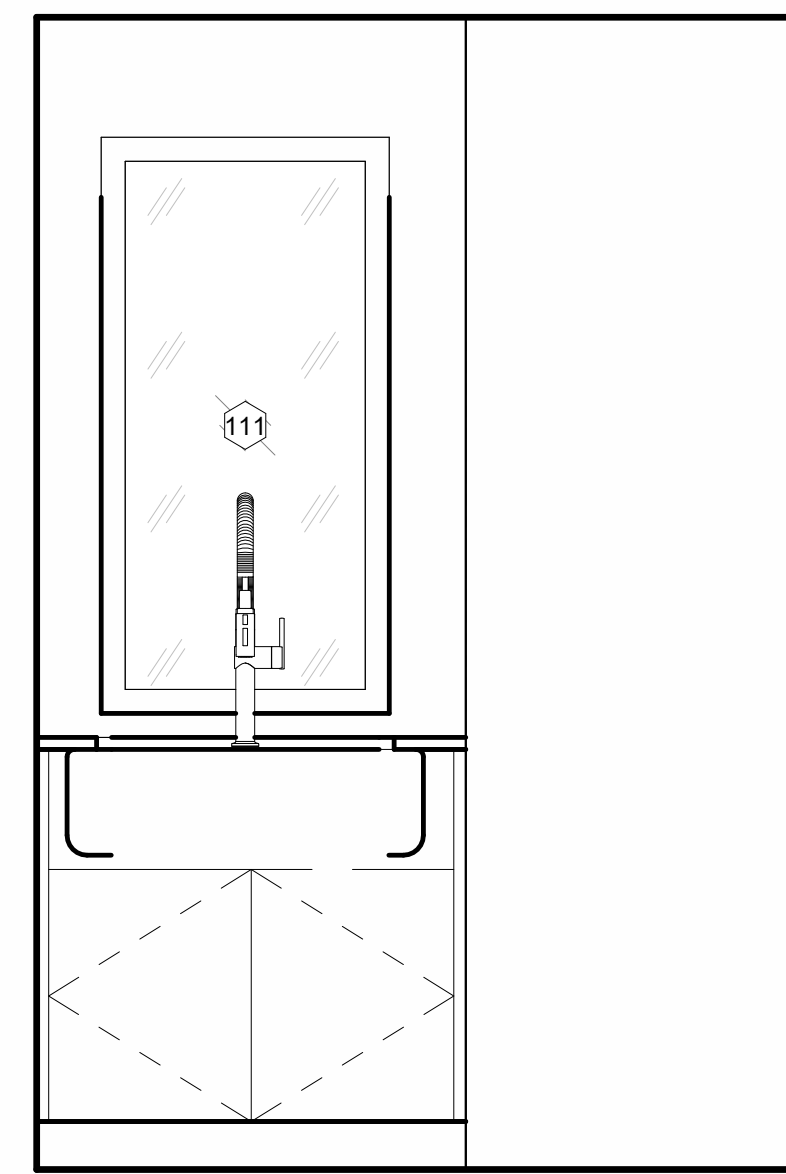


3 101 MUDROOM - NORTH ELEVATION
 3/4" = 1'-0"

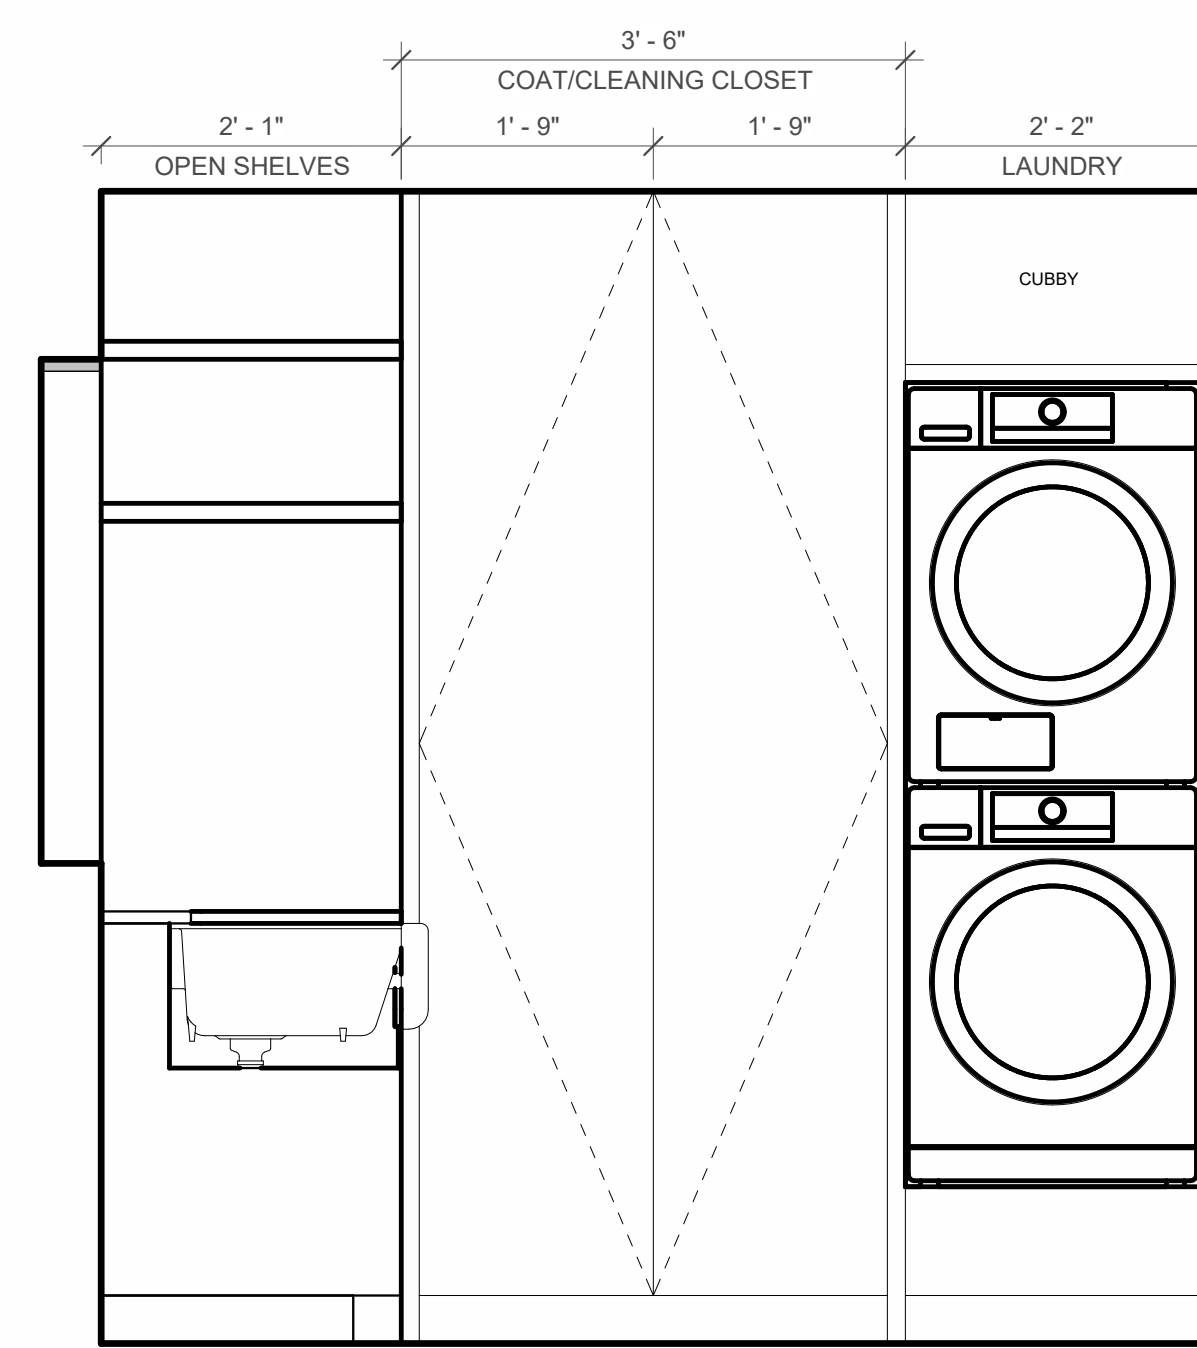


4 101 MUDROOM - EAST ELEVATION
 3/4" = 1'-0"

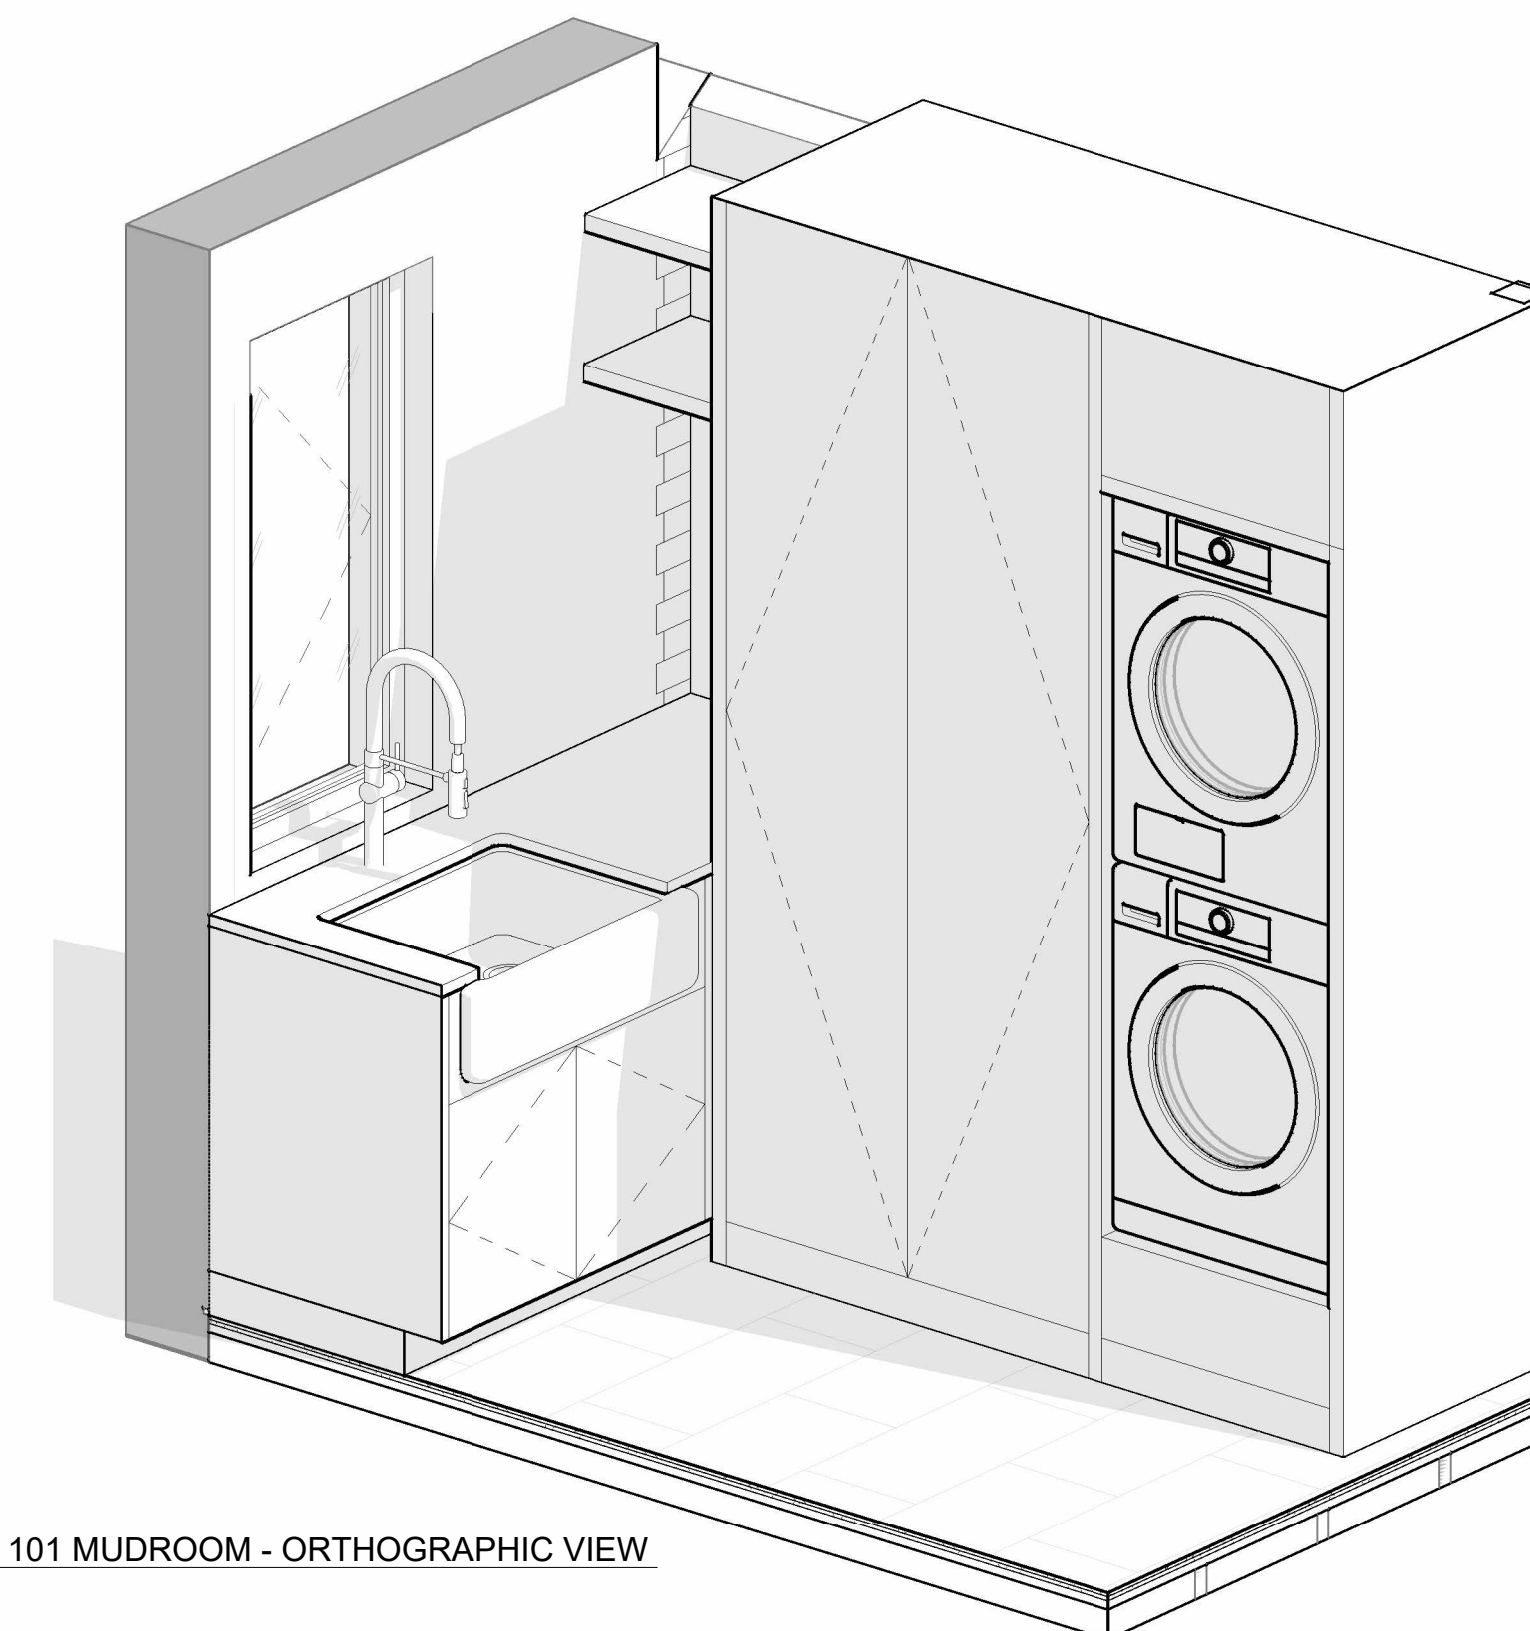


5 101 MUDROOM - ORTHOGRAPHIC VIEW

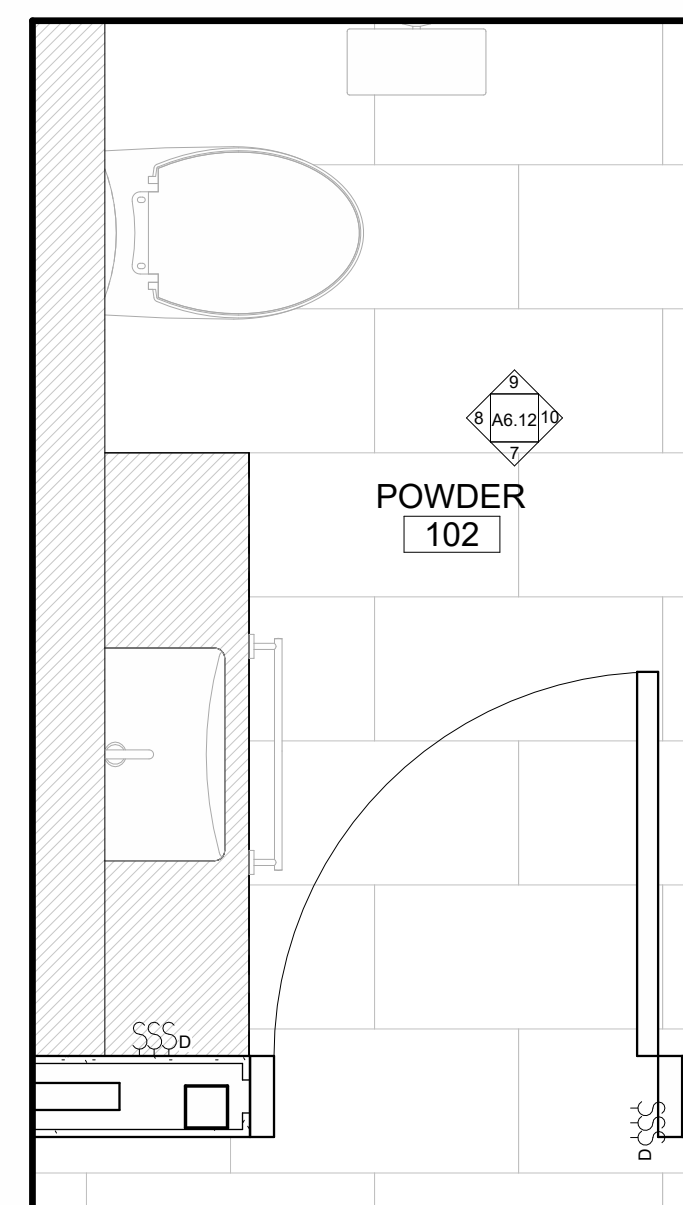


6 102 POWDER
 3/4" = 1'-0"

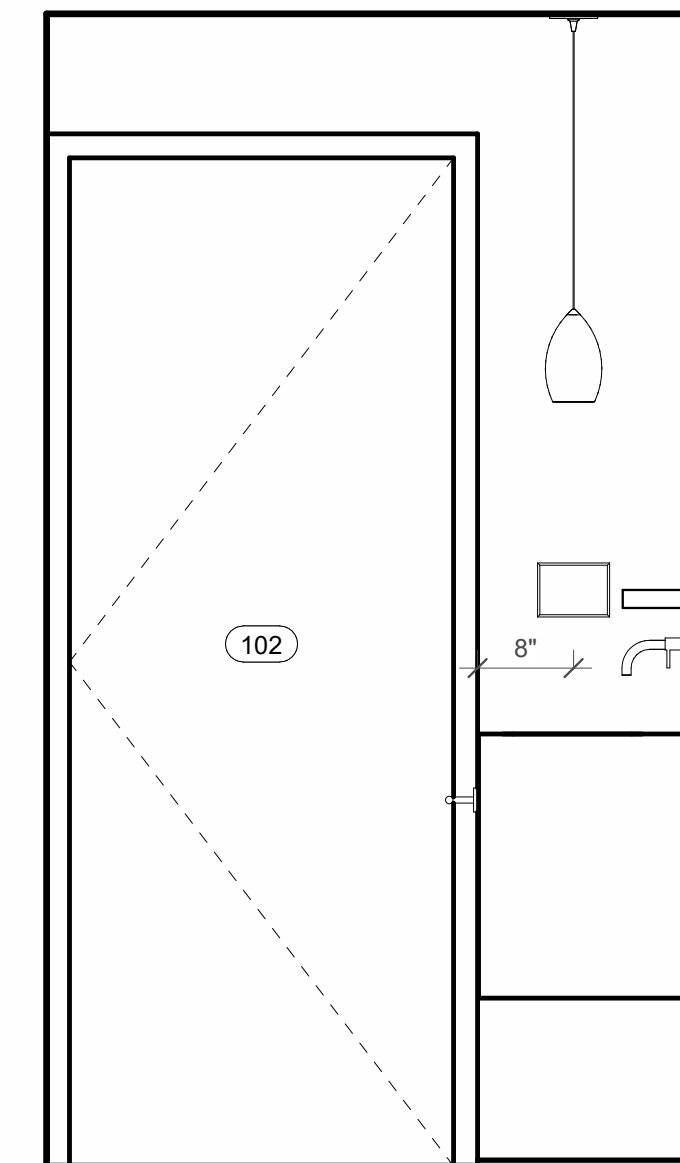


7 102 POWDER ROOM - SOUTH ELEVATION
 3/4" = 1'-0"

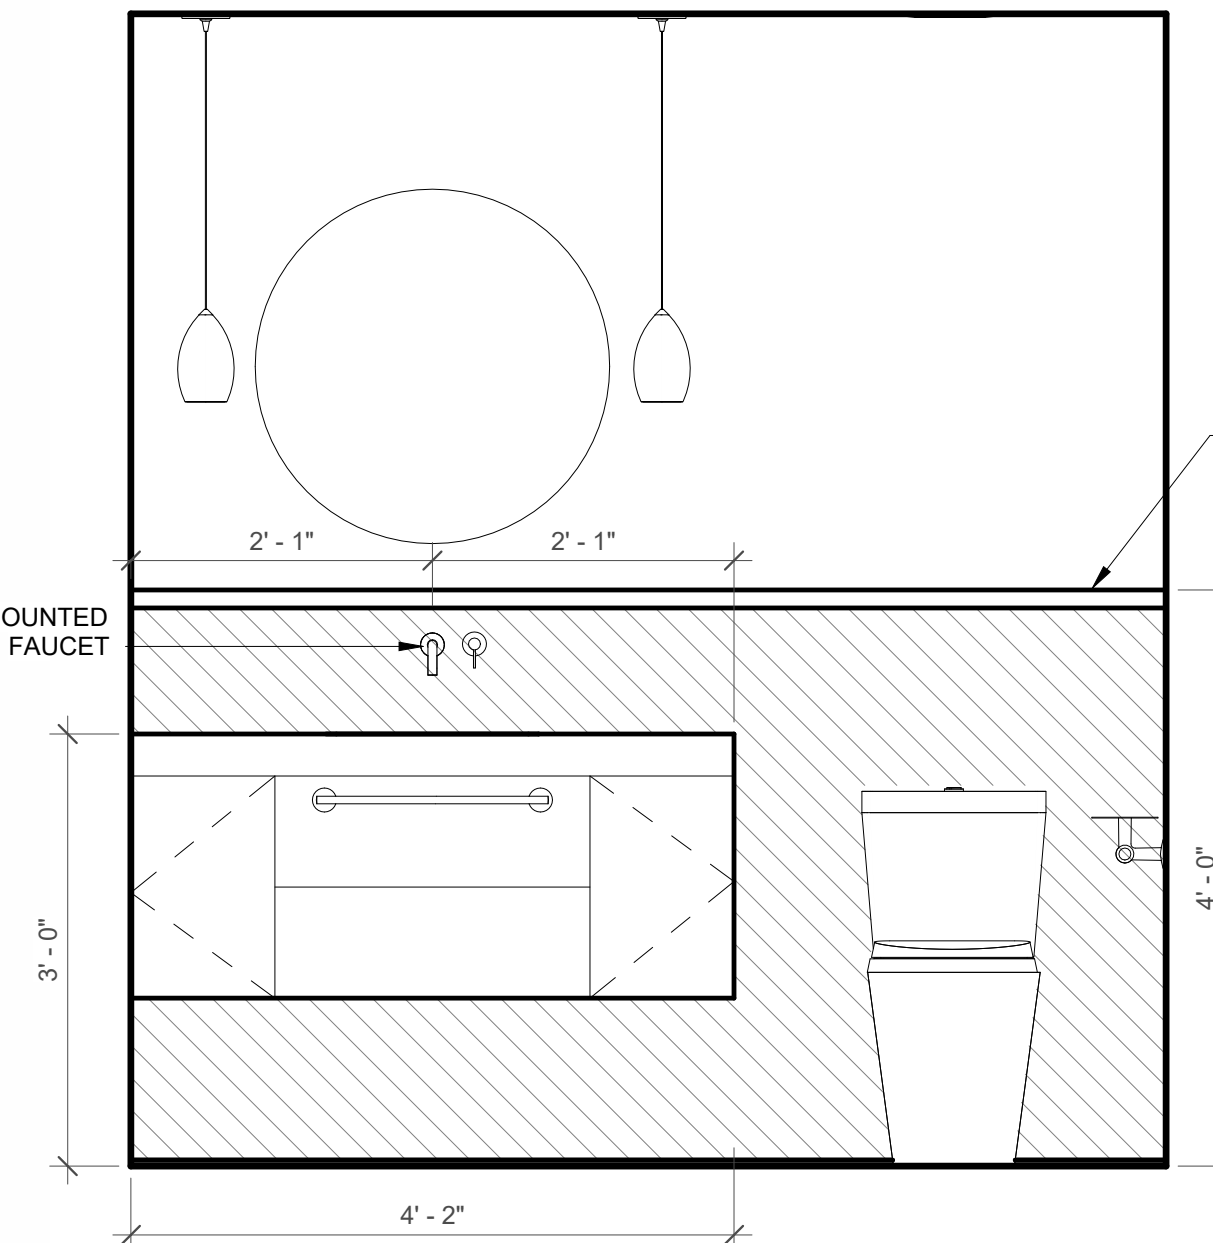

8 102 POWDER ROOM - WEST ELEVATION
 3/4" = 1'-0"

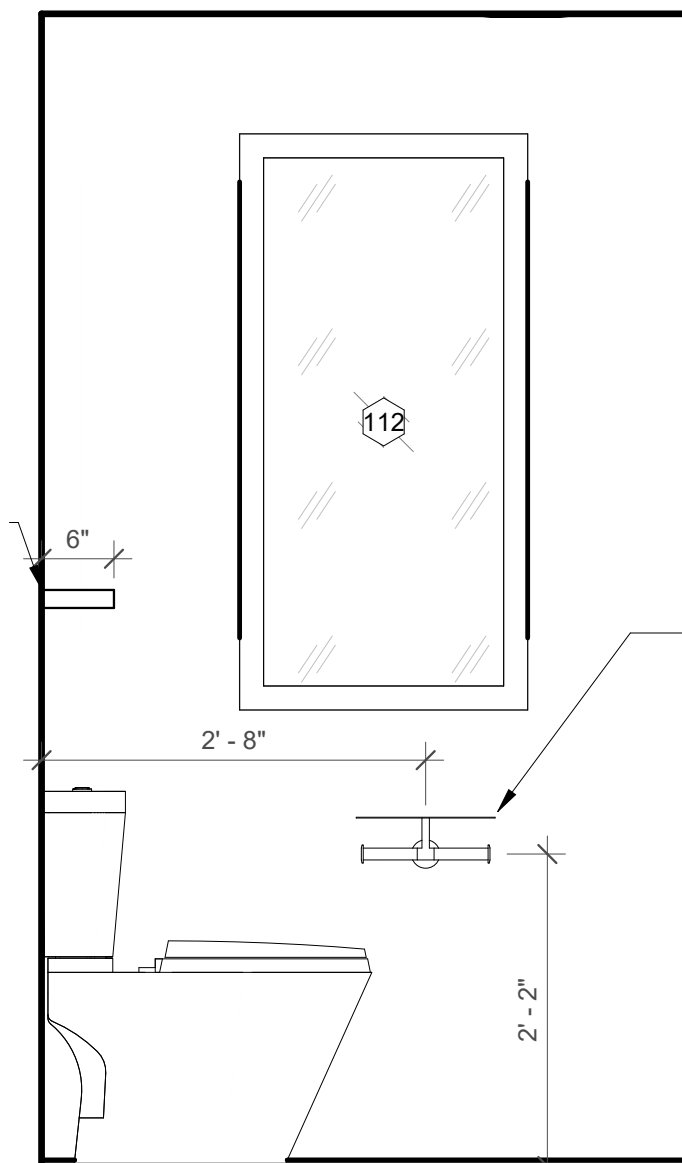


9 102 POWDER ROOM - NORTH ELEVATION
 3/4" = 1'-0"

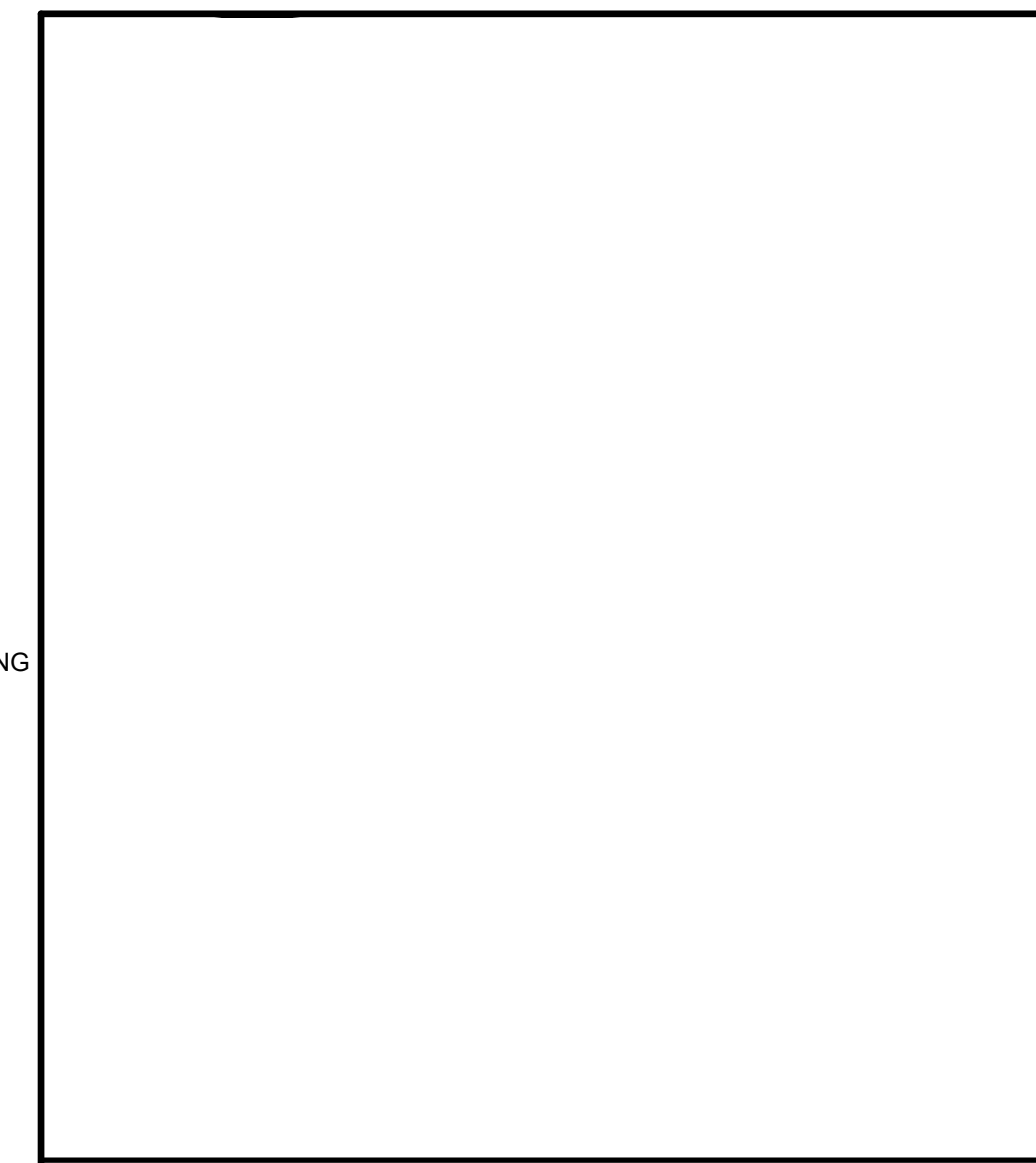


10 102 POWDER ROOM - EAST ELEVATION
 3/4" = 1'-0"




11 102 POWDER ROOM - ORTHOGRAPHIC VIEW

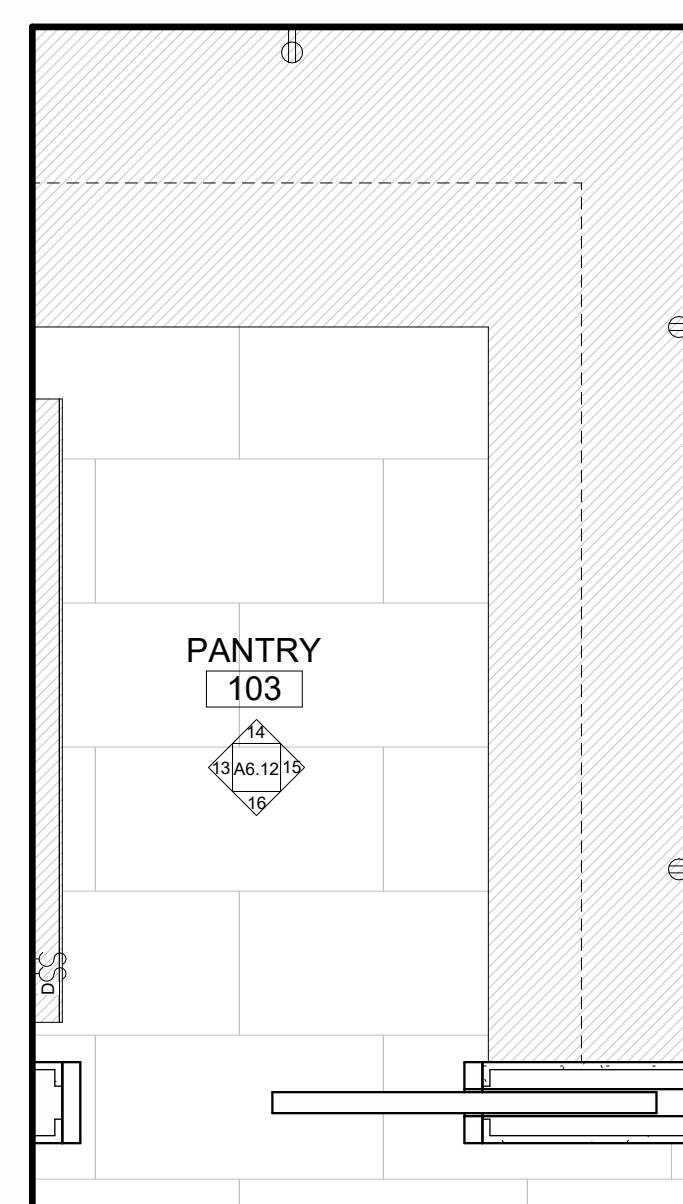


12 103 PANTRY
 3/4" = 1'-0"

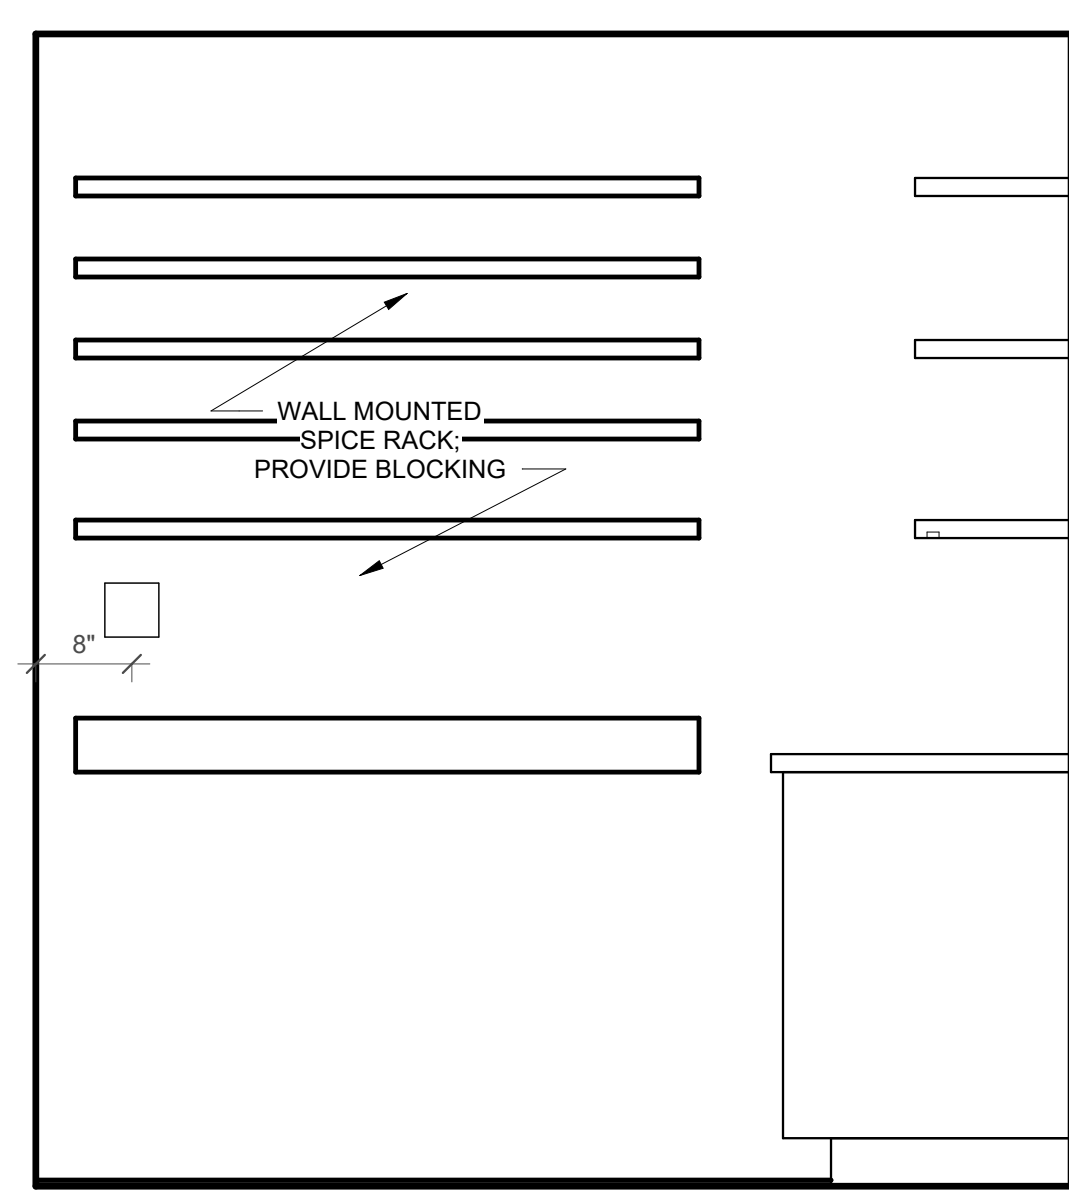


13 103 PANTRY - WEST ELEVATION
 3/4" = 1'-0"

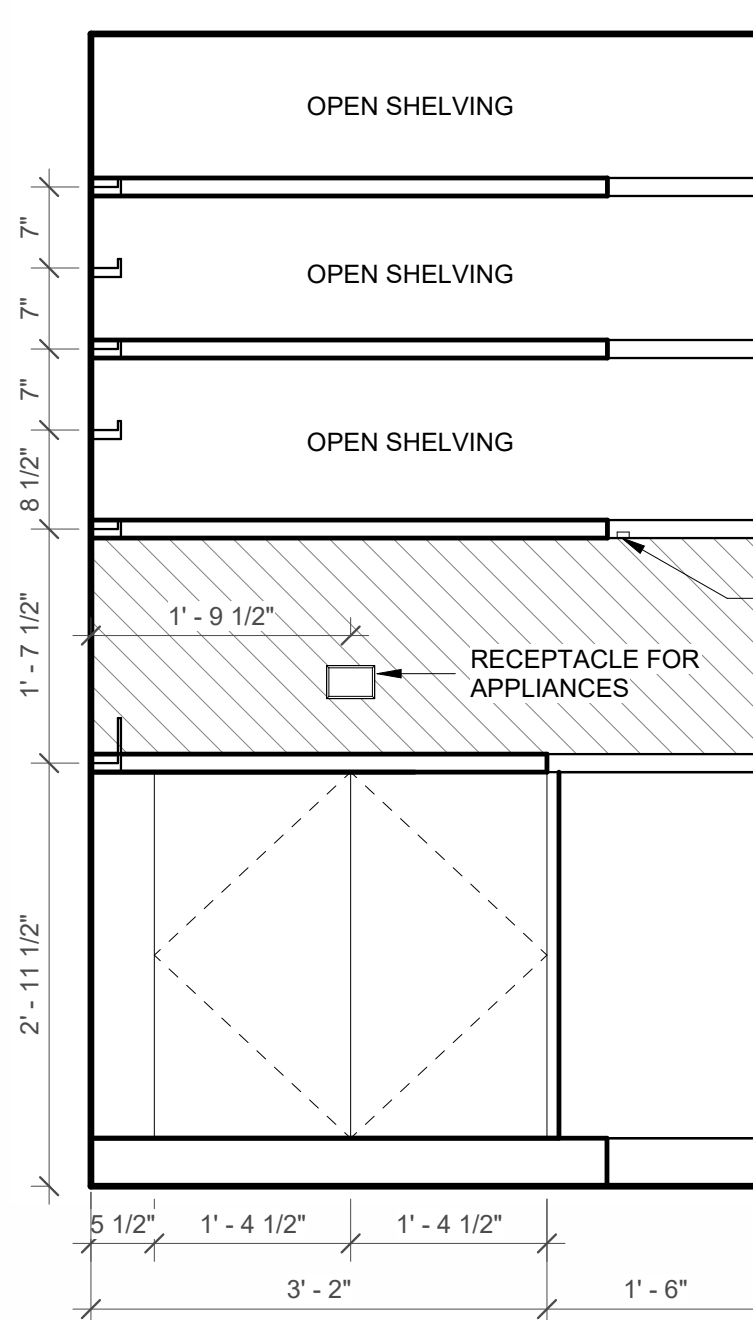


14 103 PANTRY - NORTH ELEVATION
 3/4" = 1'-0"

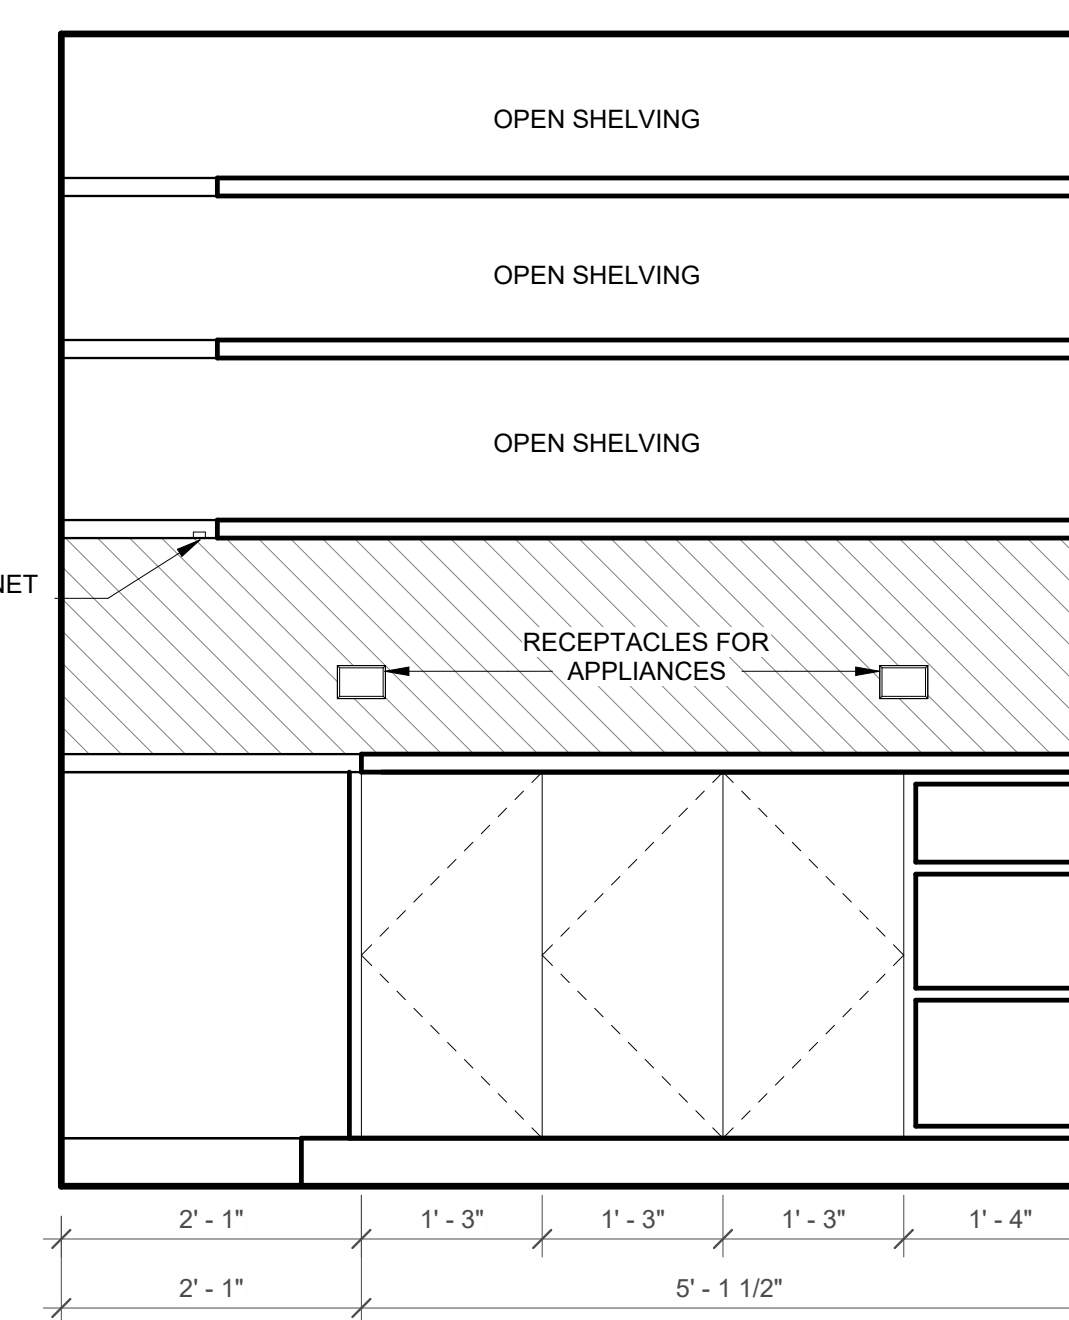

15 103 PANTRY - EAST ELEVATION
 3/4" = 1'-0"

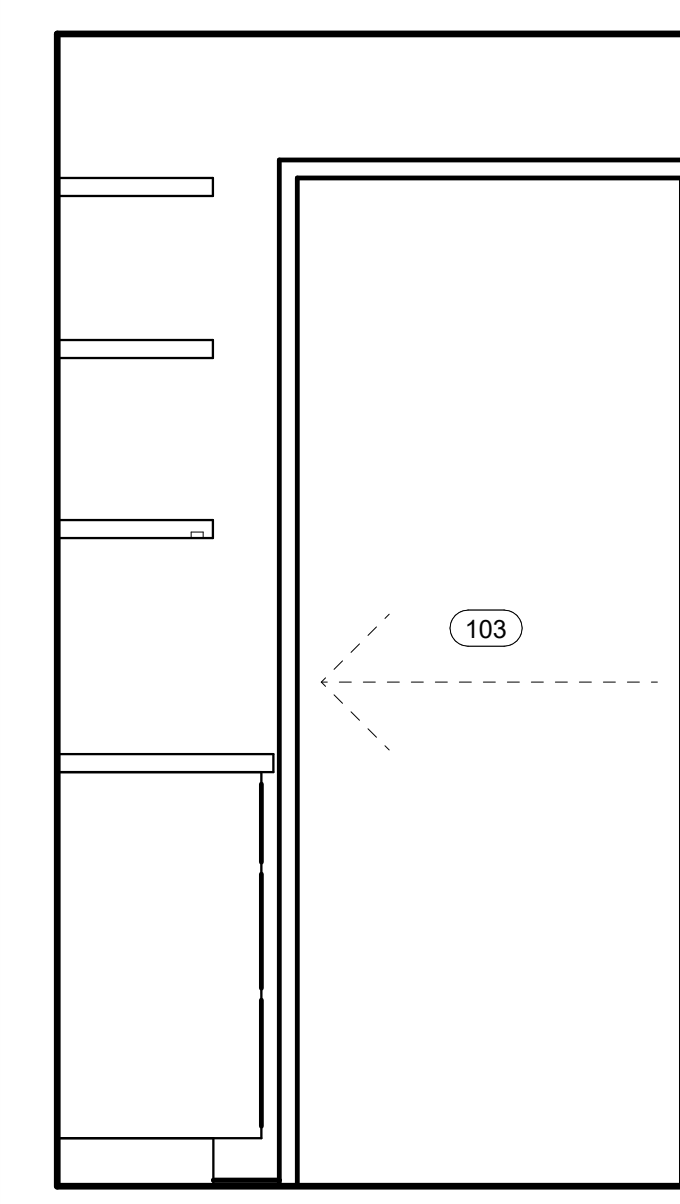



16 103 PANTRY - SOUTH ELEVATION
 3/4" = 1'-0"

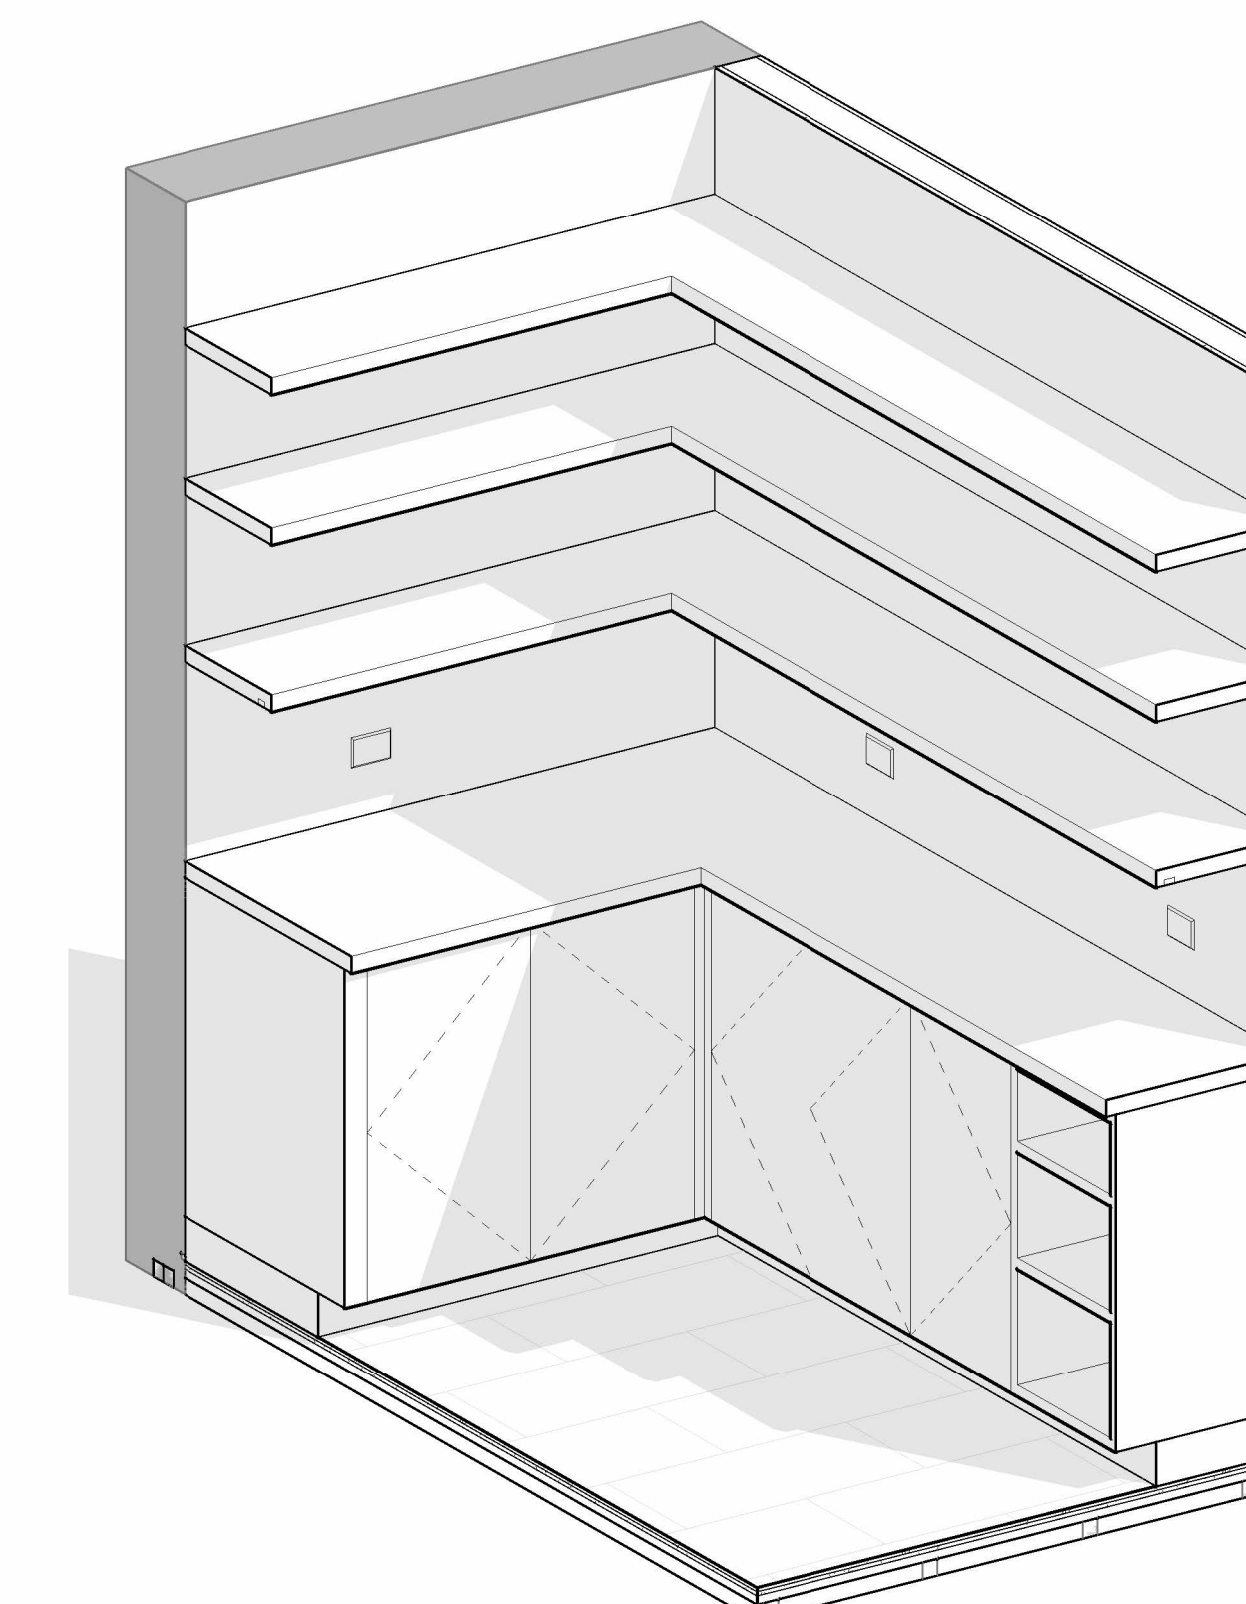


17 103 PANTRY - ORTHOGRAPHIC VIEW

REVISION HISTORY		
NO.	DESCRIPTION	DATE


PERMIT REVISION	
DATE:	AUG 18, 2023
SCALE:	3/4" = 1'-0"
DRAWN BY:	CJ
CHECKED BY:	CR
SHEET TITLE:	PROJECT #: 40035

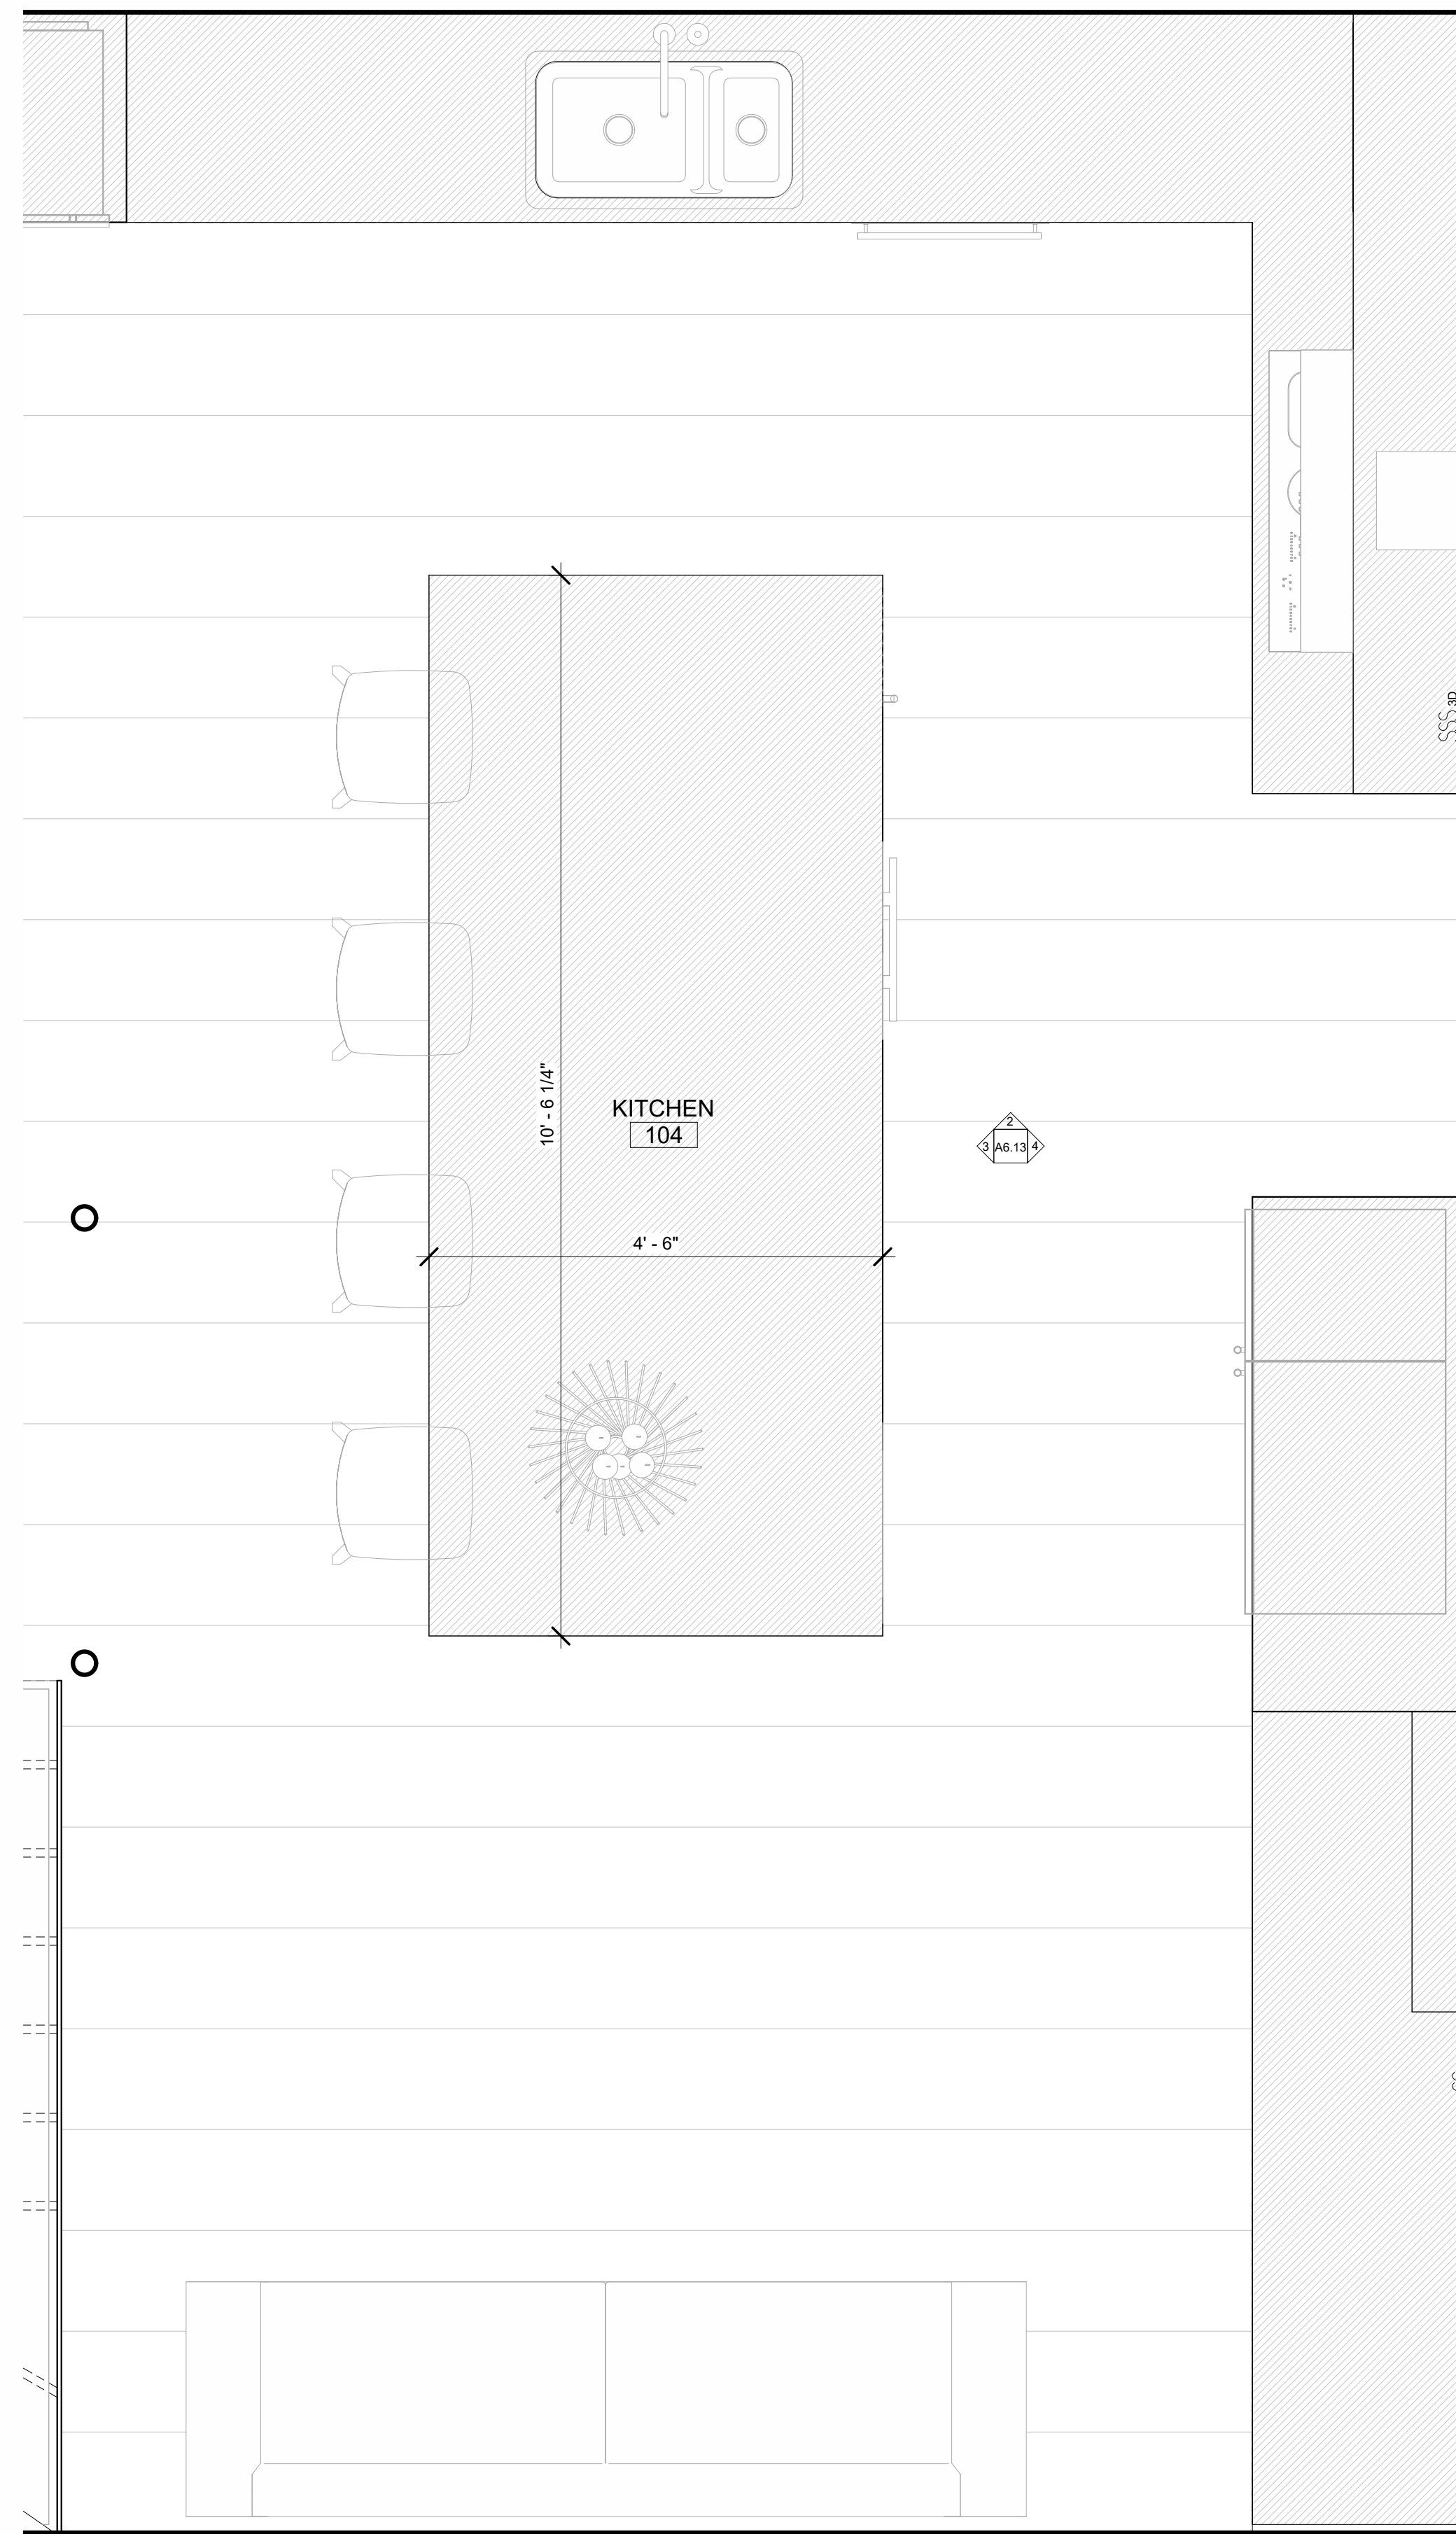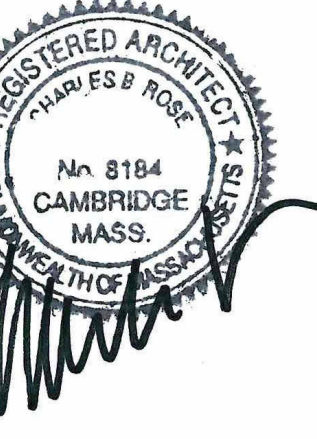


1 104 KITCHEN
 3/4" = 1'-0"

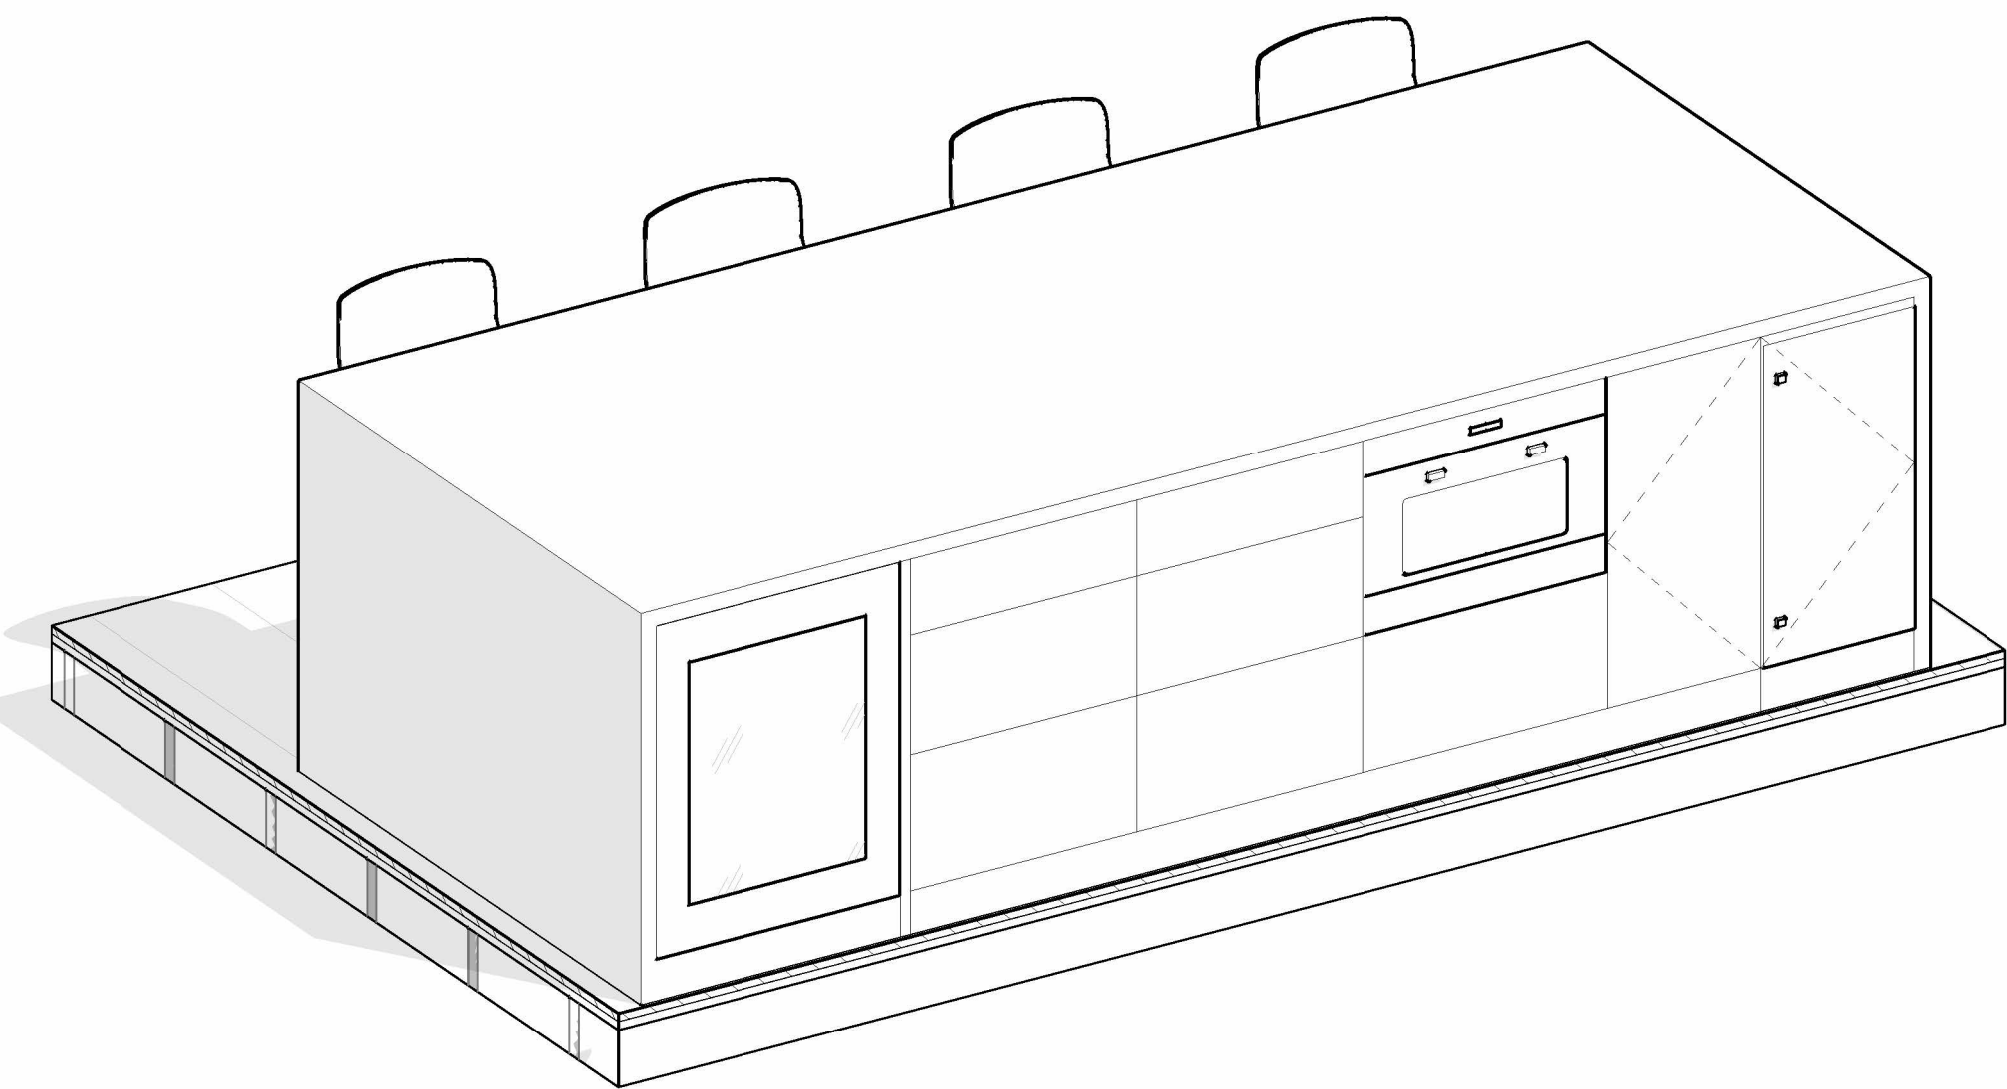


6 104 KITCHEN - ORTHOGRAPHIC VIEW Copy 1

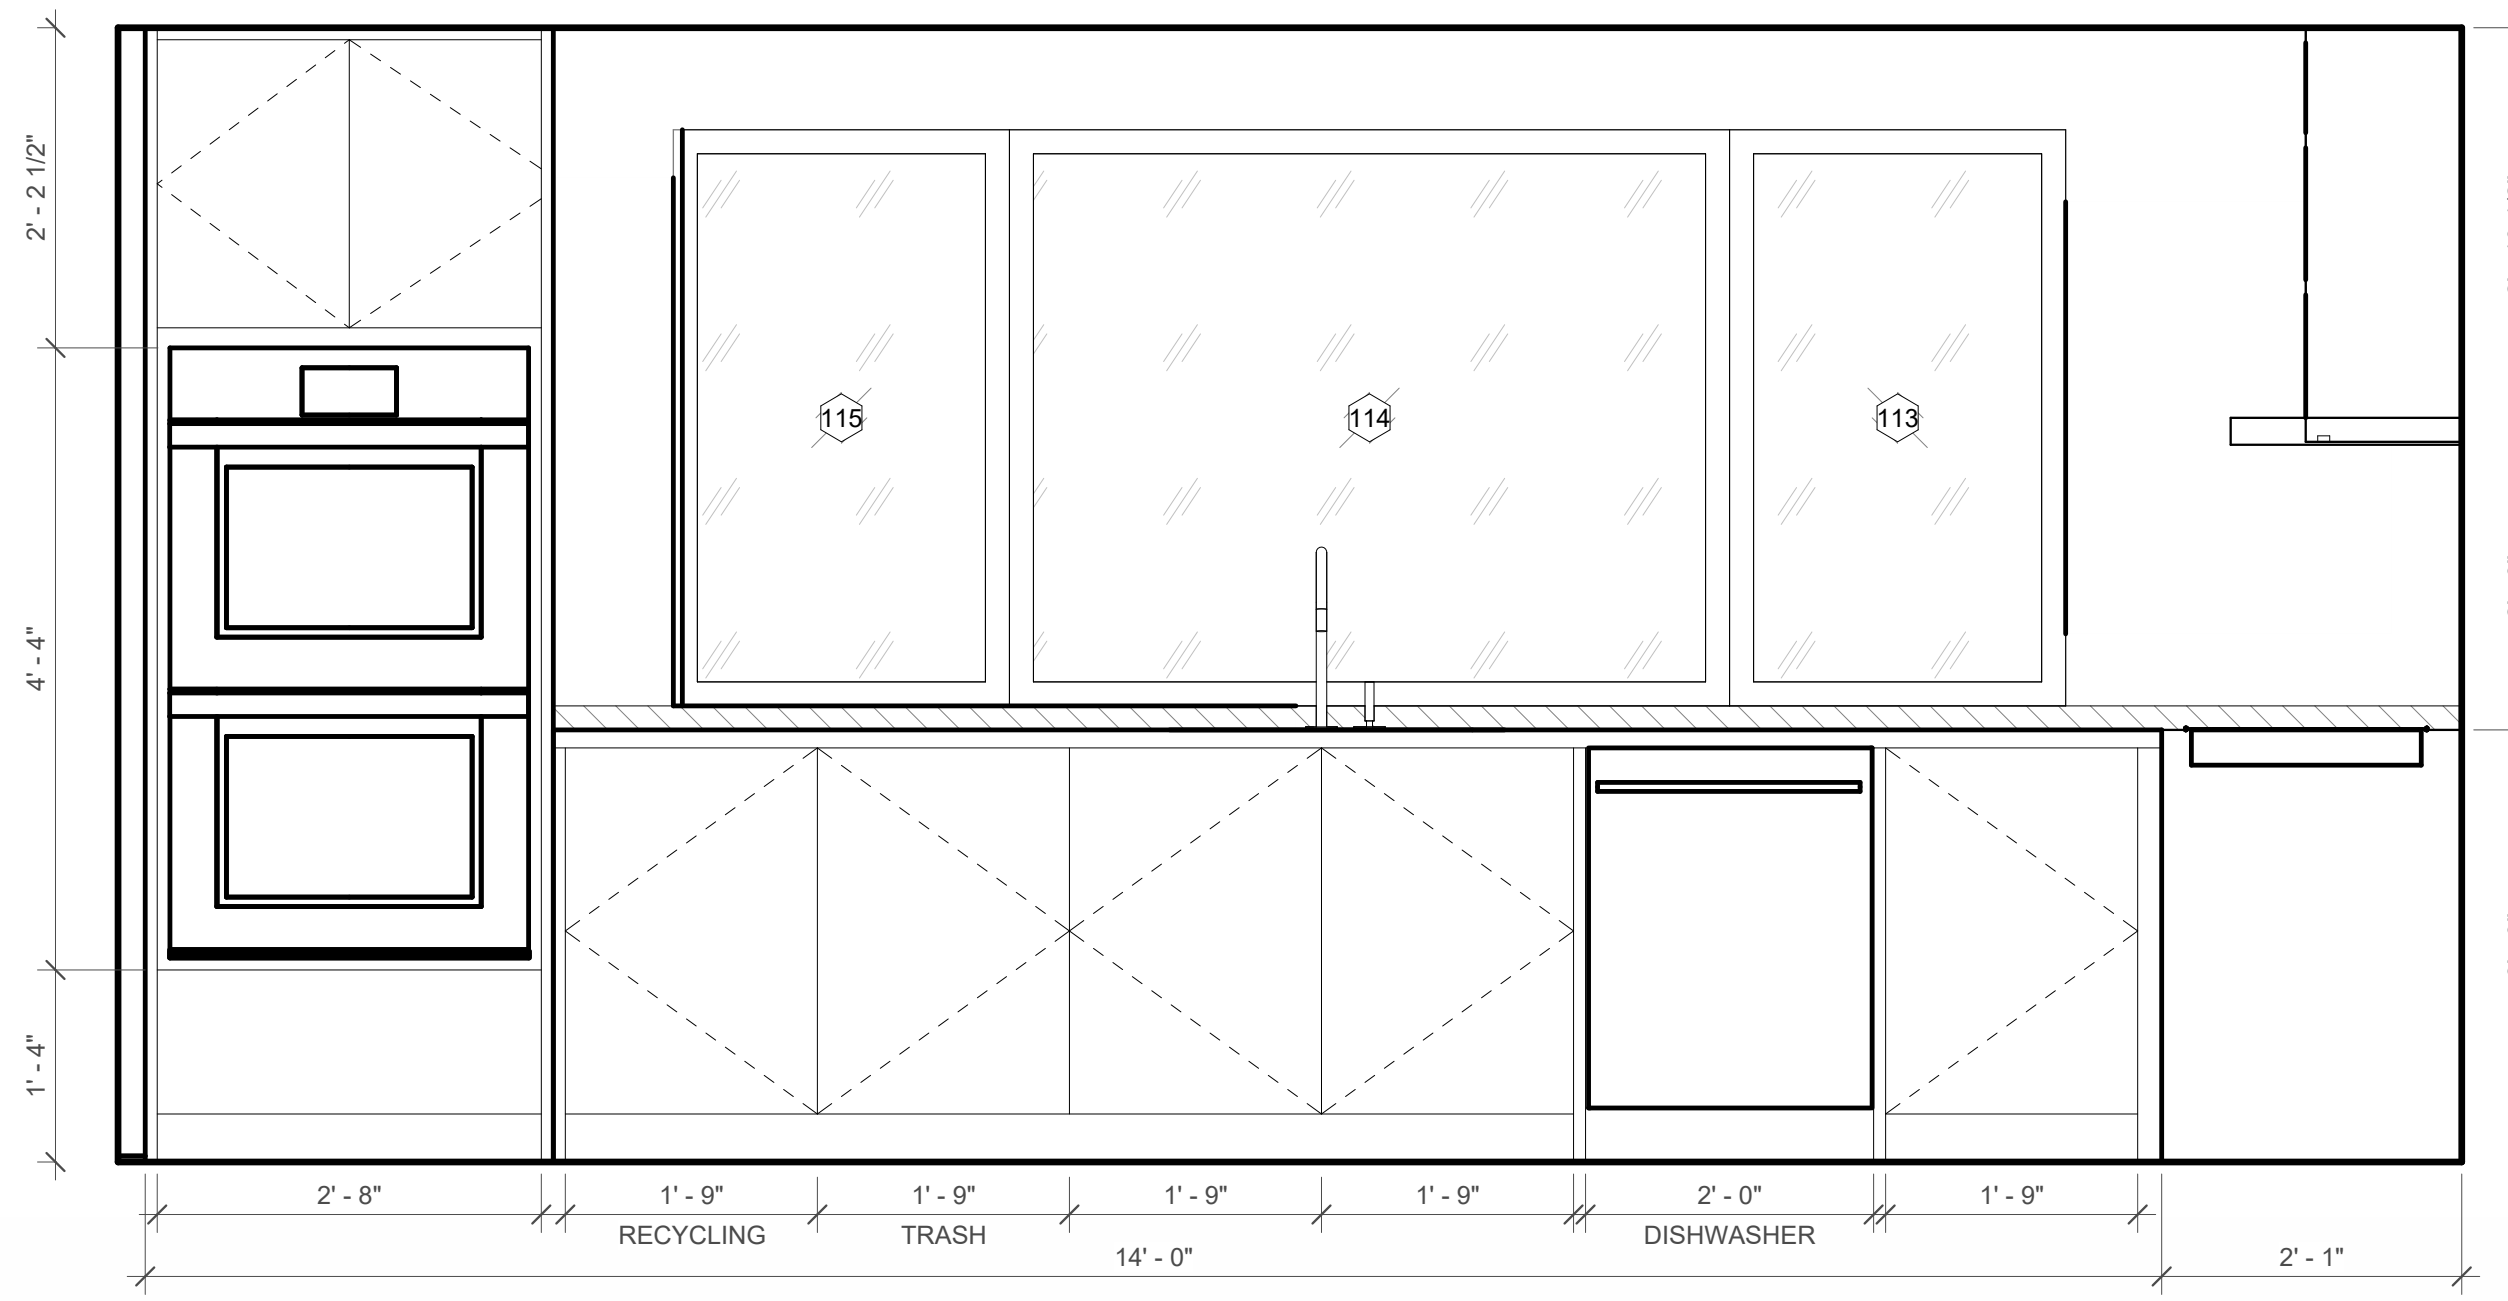


2 104 KITCHEN - NORTH ELEVATION
 3/4" = 1'-0"

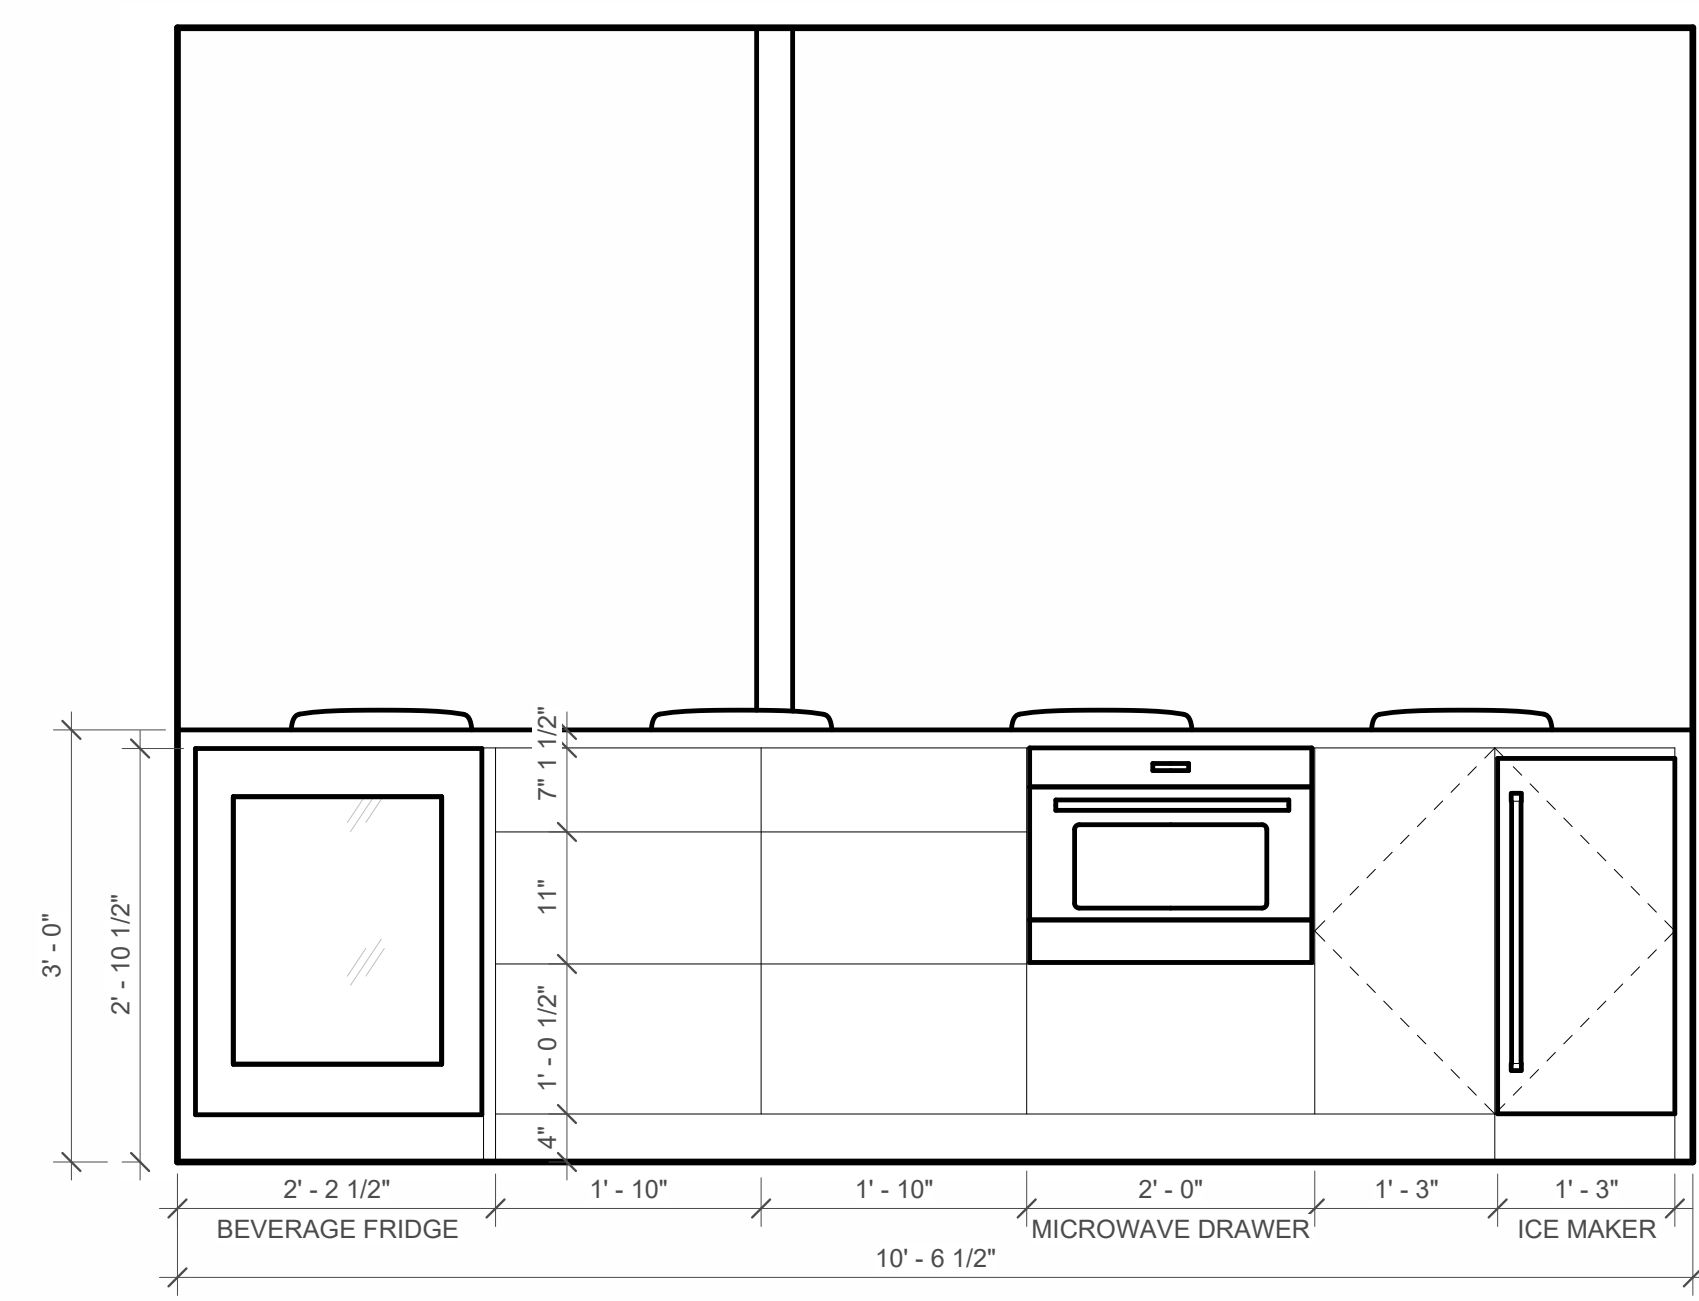

3 104 KITCHEN - WEST ELEVATION
 3/4" = 1'-0"

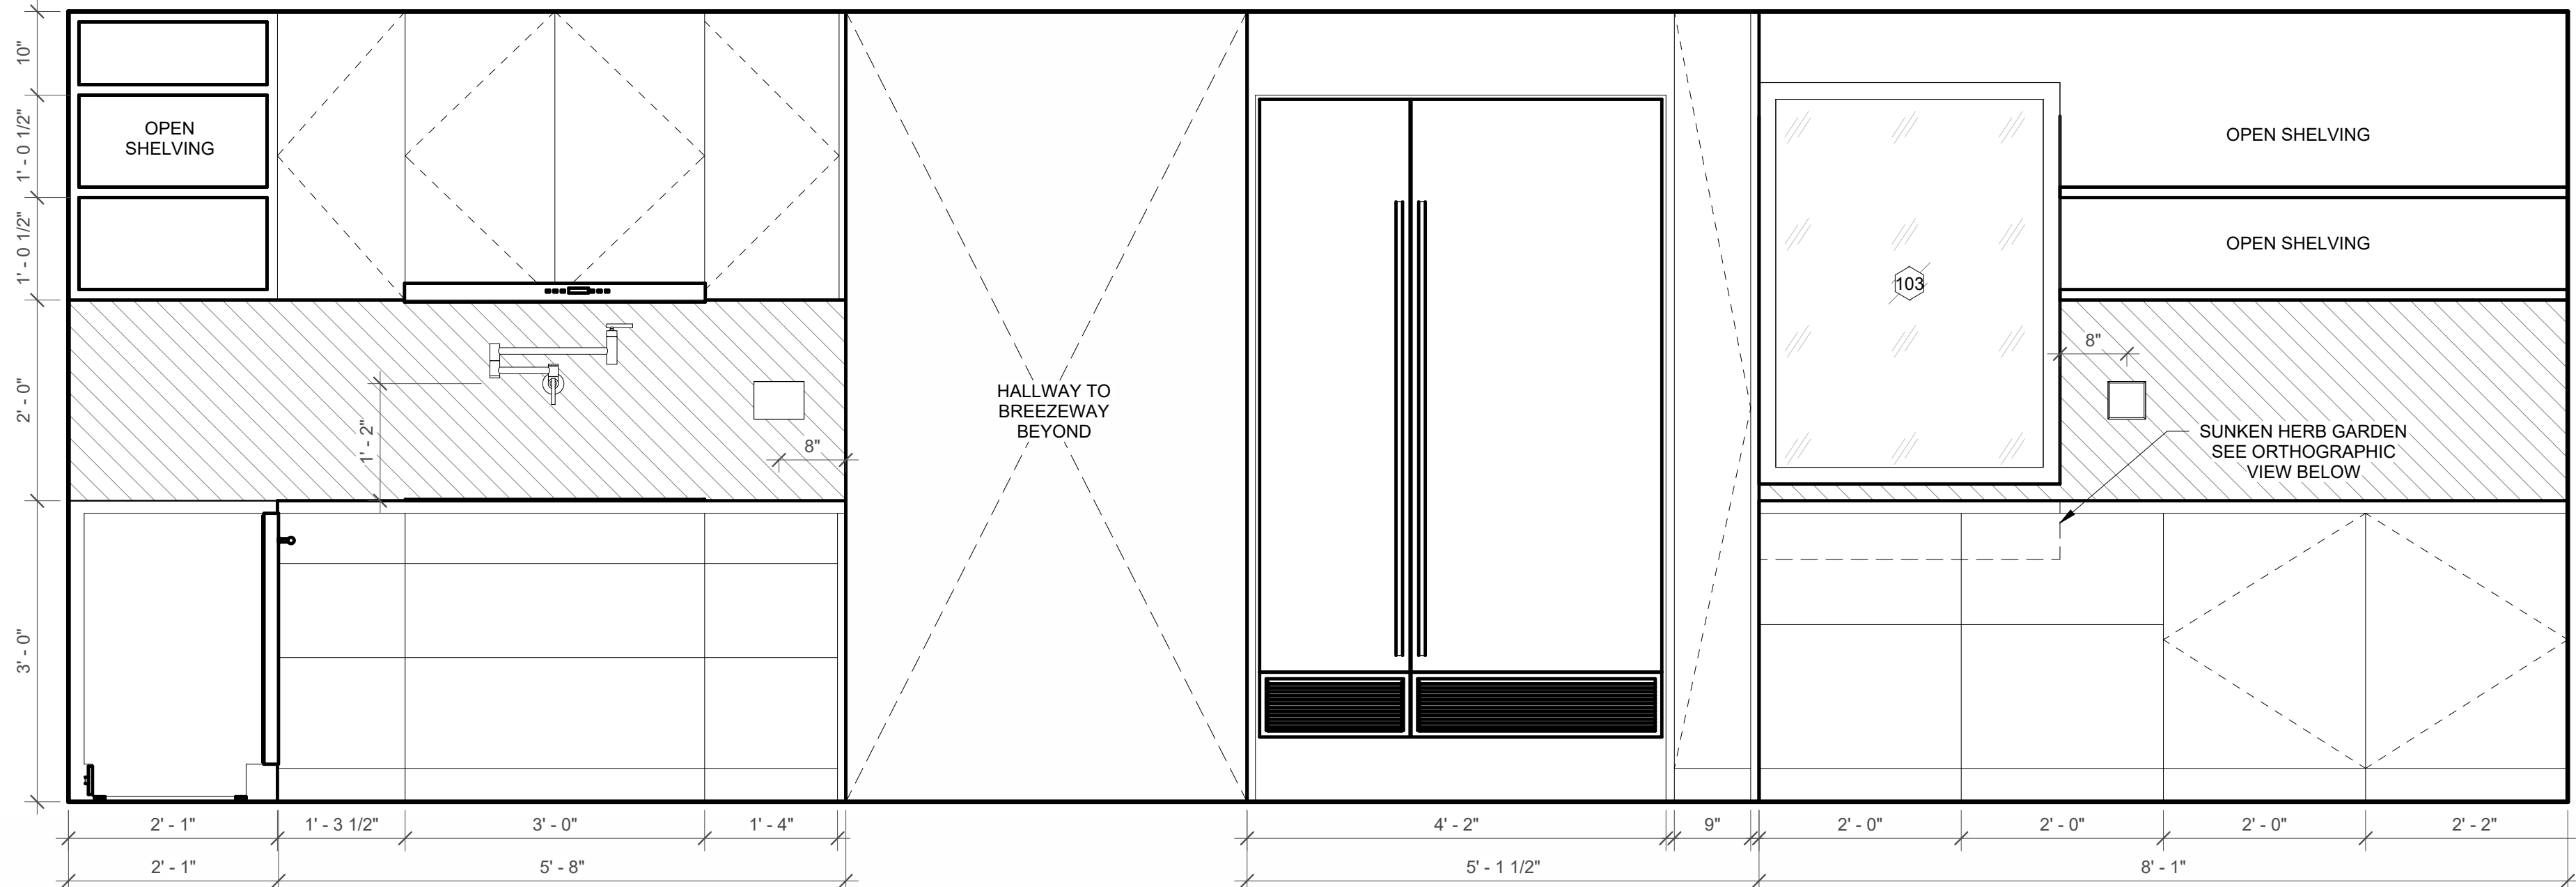

4 104 KITCHEN - EAST ELEVATION
 3/4" = 1'-0"

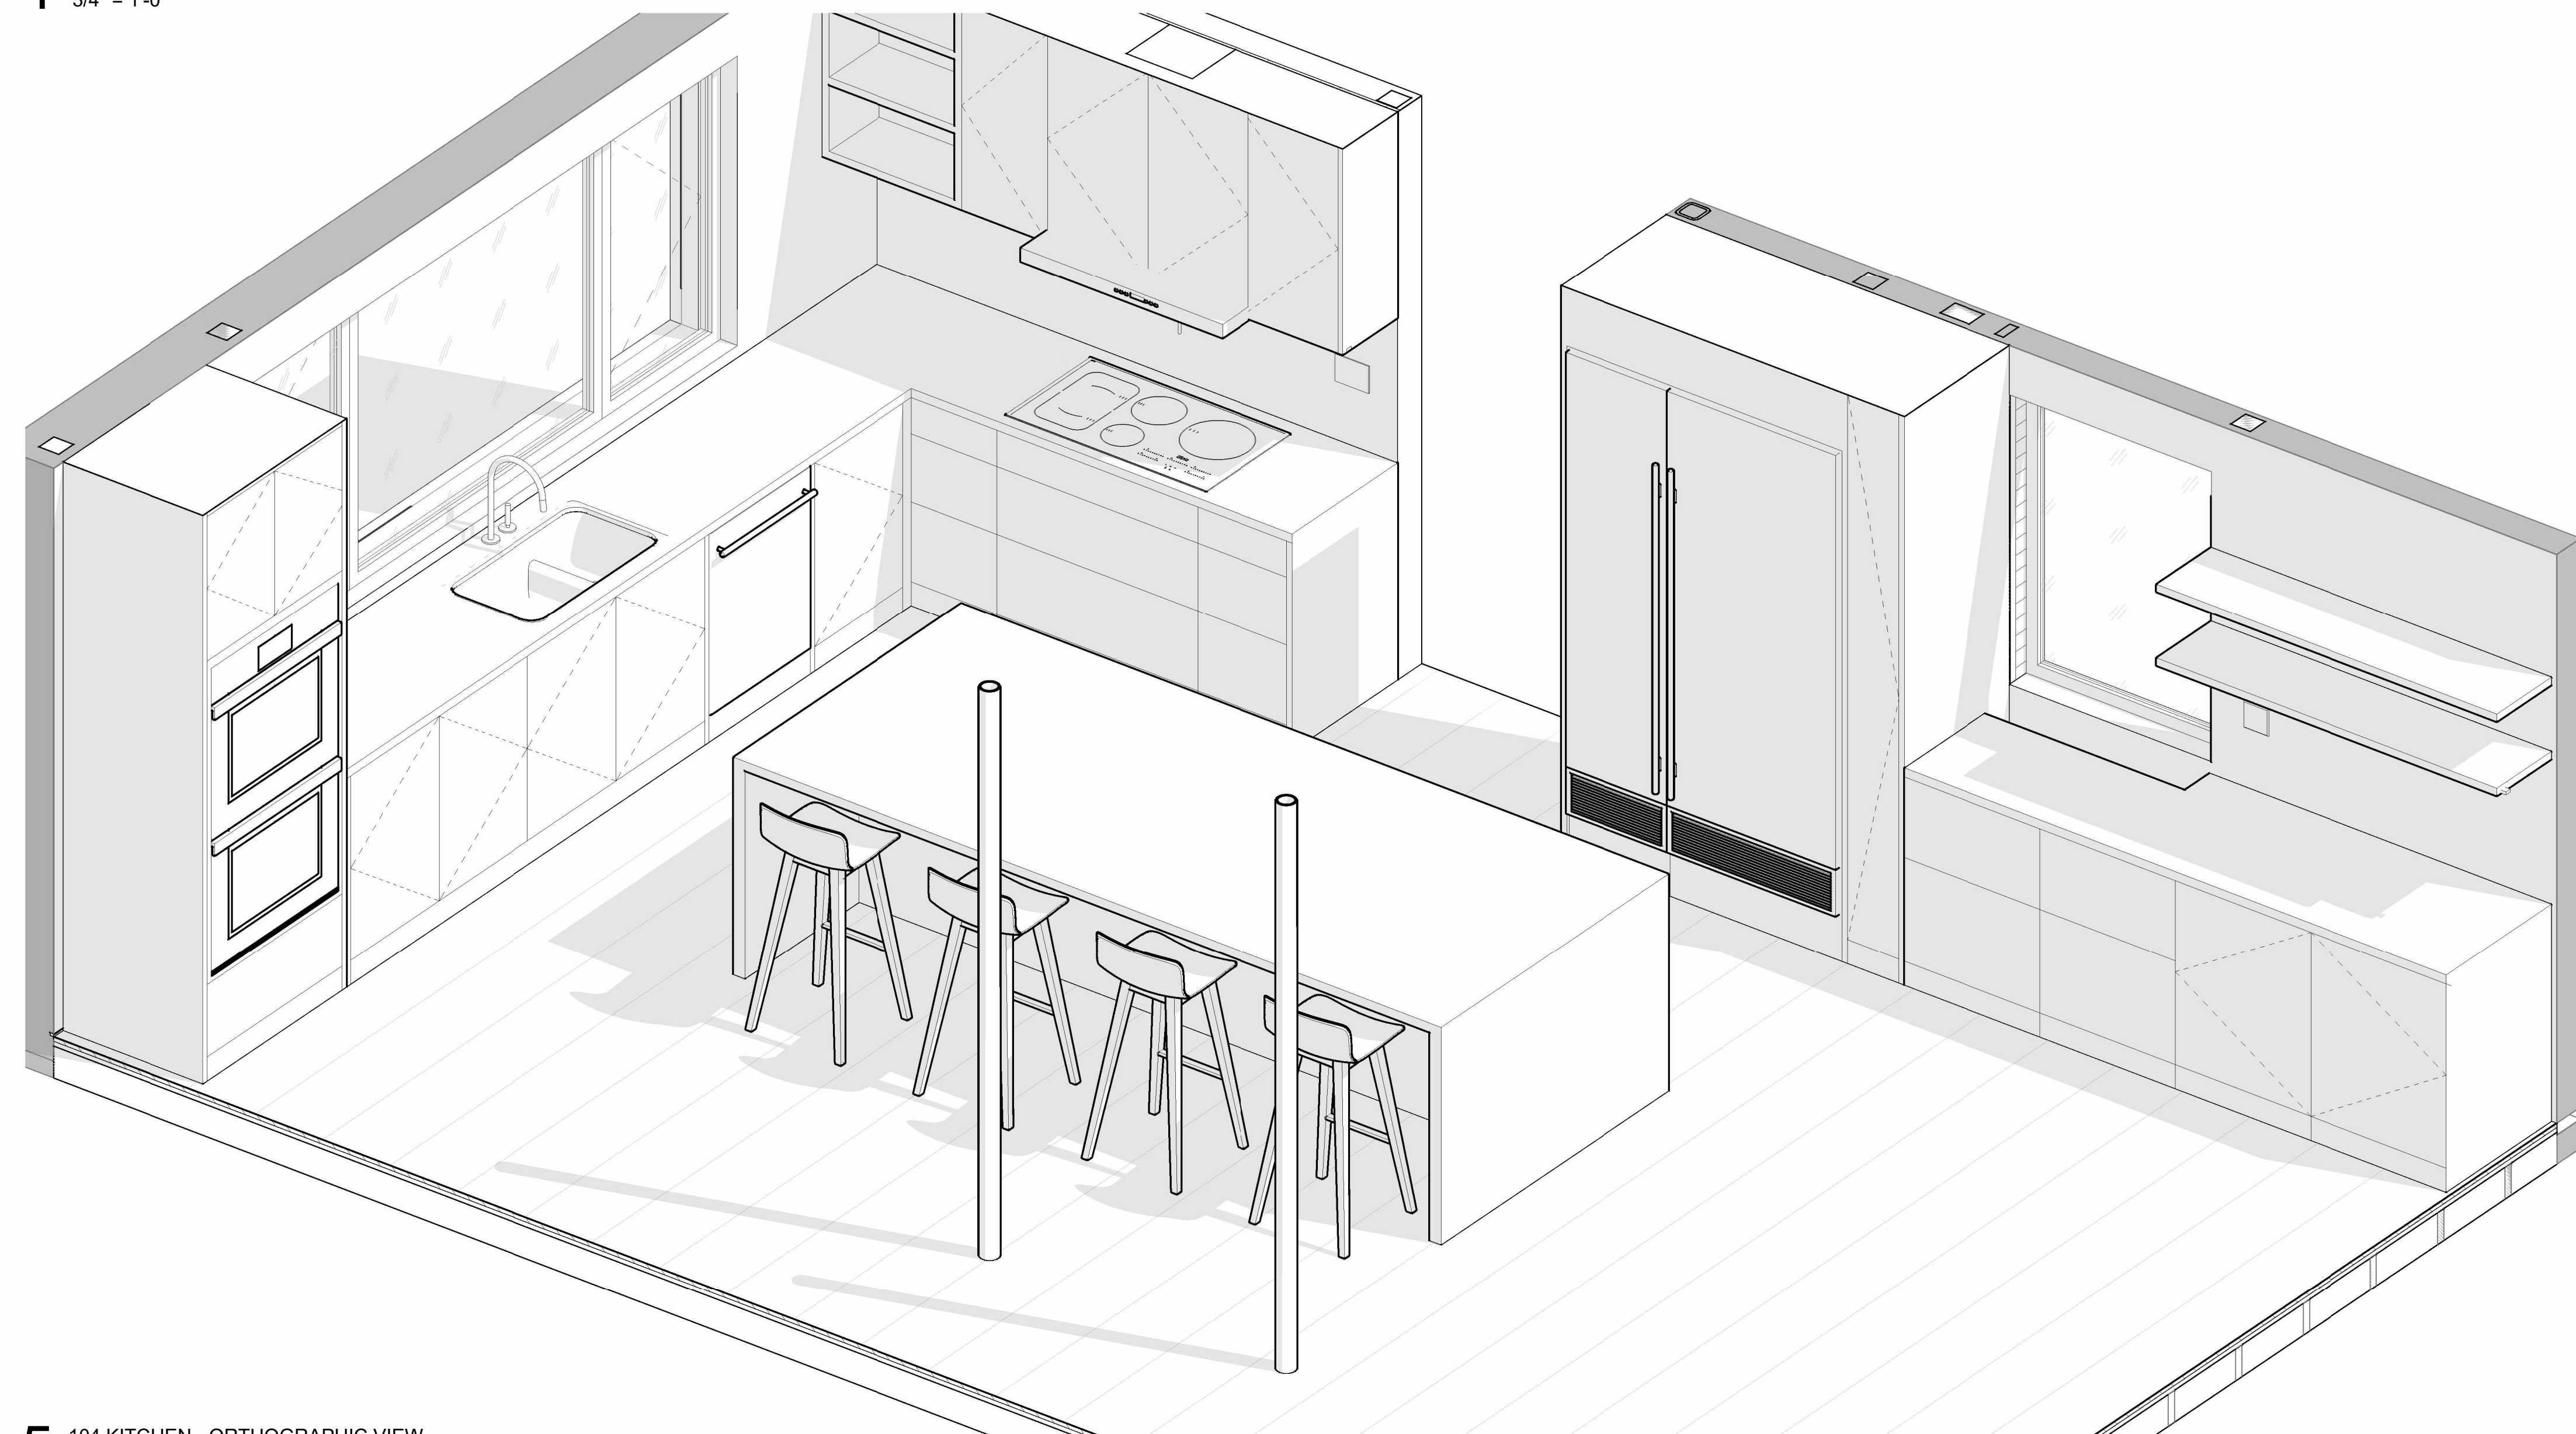

5 104 KITCHEN - ORTHOGRAPHIC VIEW


REVISION HISTORY		
NO.	DESCRIPTION	DATE

PERMIT REVISION


DATE:	AUG 18, 2023
SCALE:	3/4" = 1'-0"
DRAWN BY:	CJ
CHECKED BY:	CR

SHEET TITLE:	PROJECT #:	40035
--------------	------------	-------


ENLARGED
 INTERIOR PLANS &
 ELEVATIONS

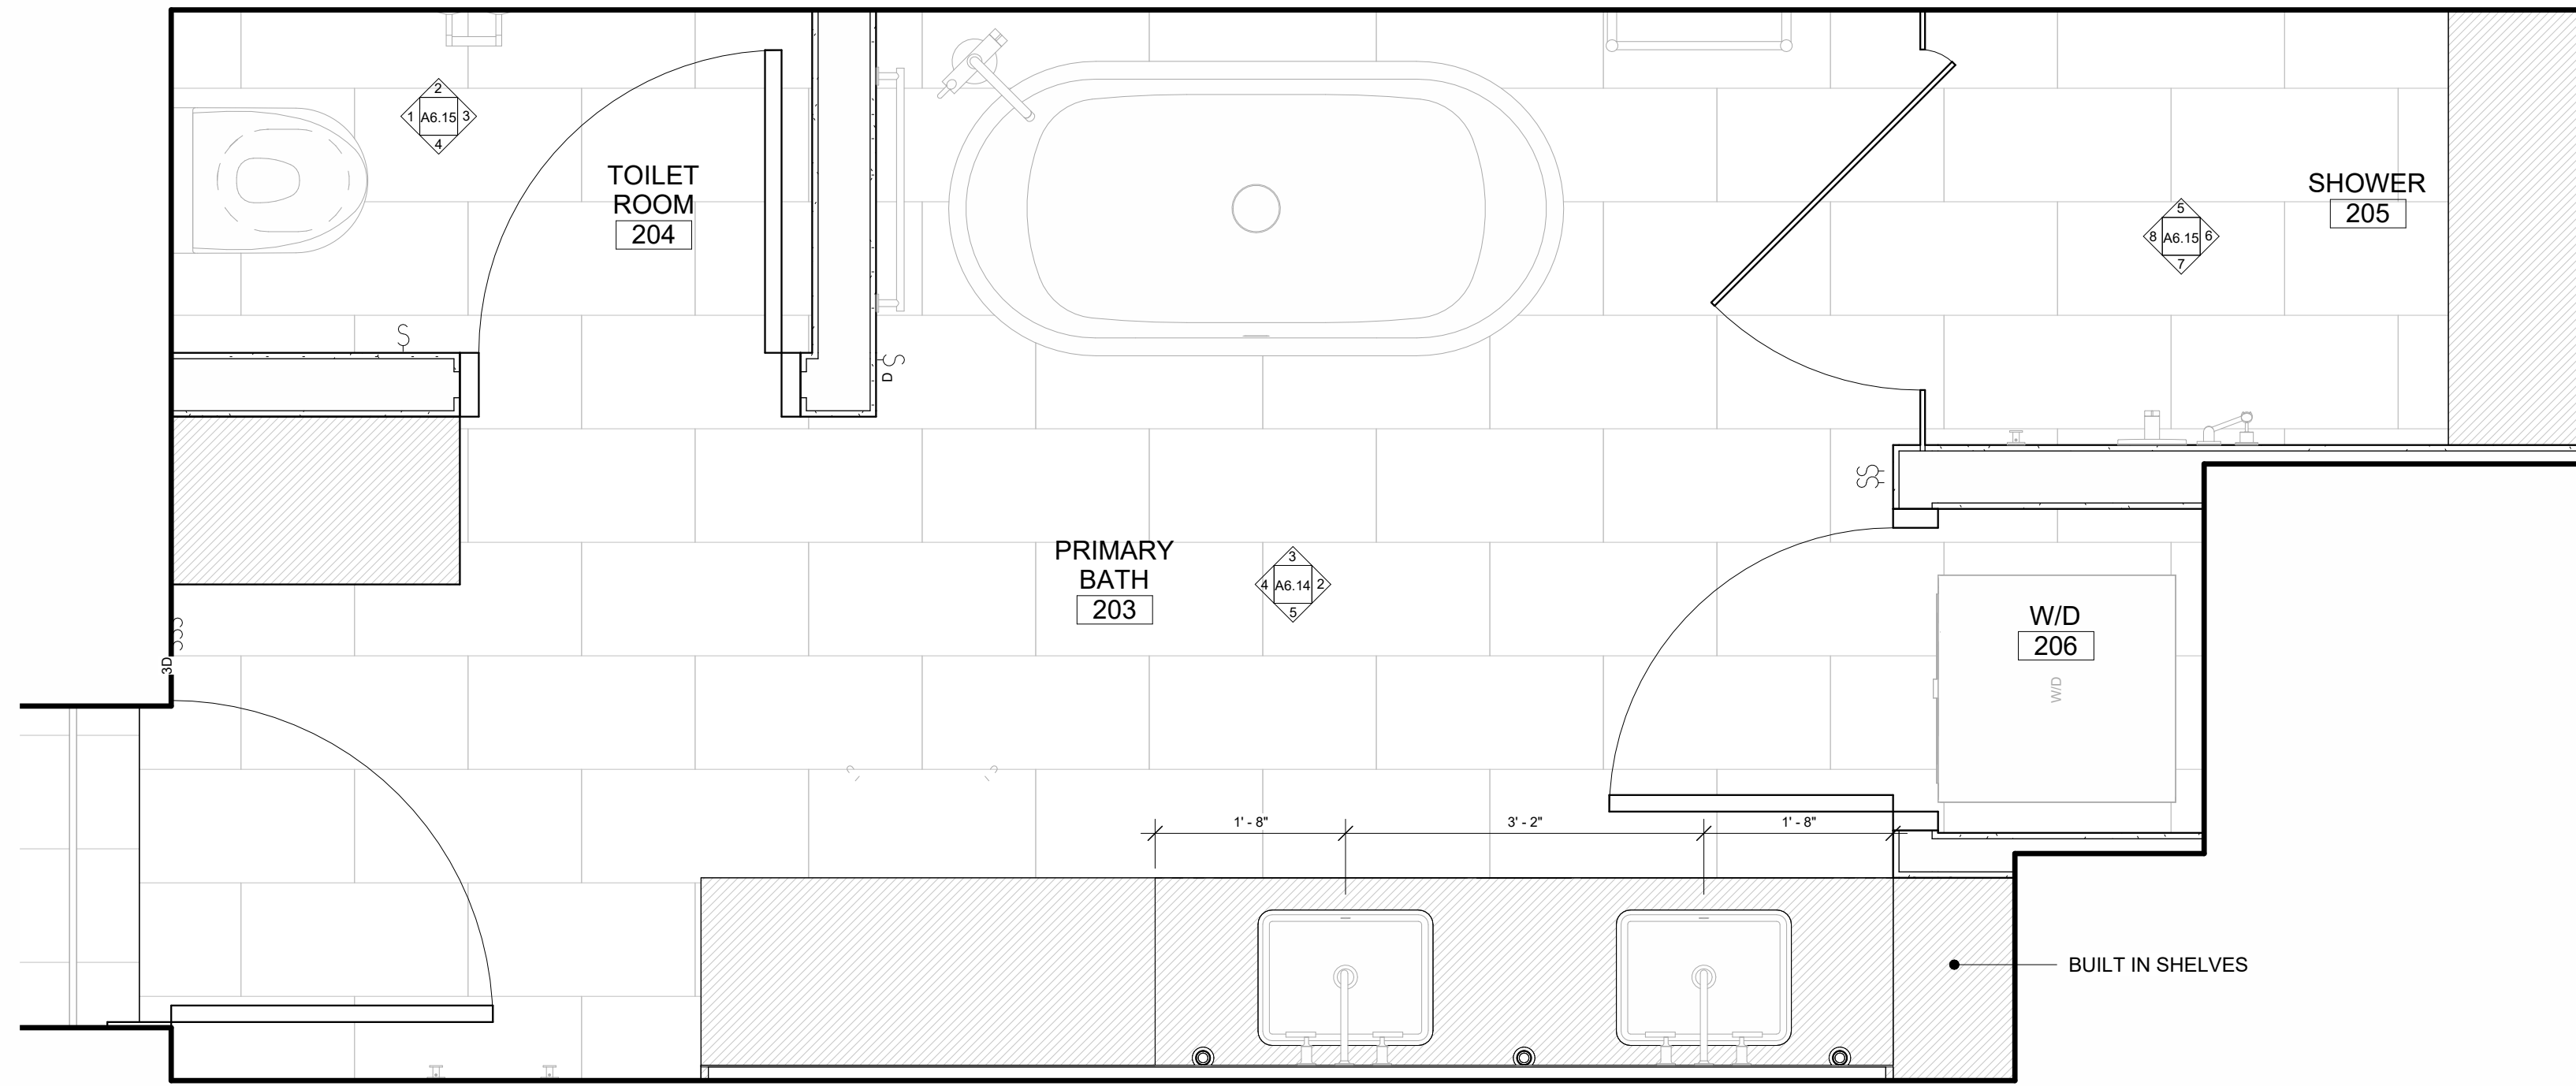


1 203 PRIMARY BATH
 3/4" = 1'-0"

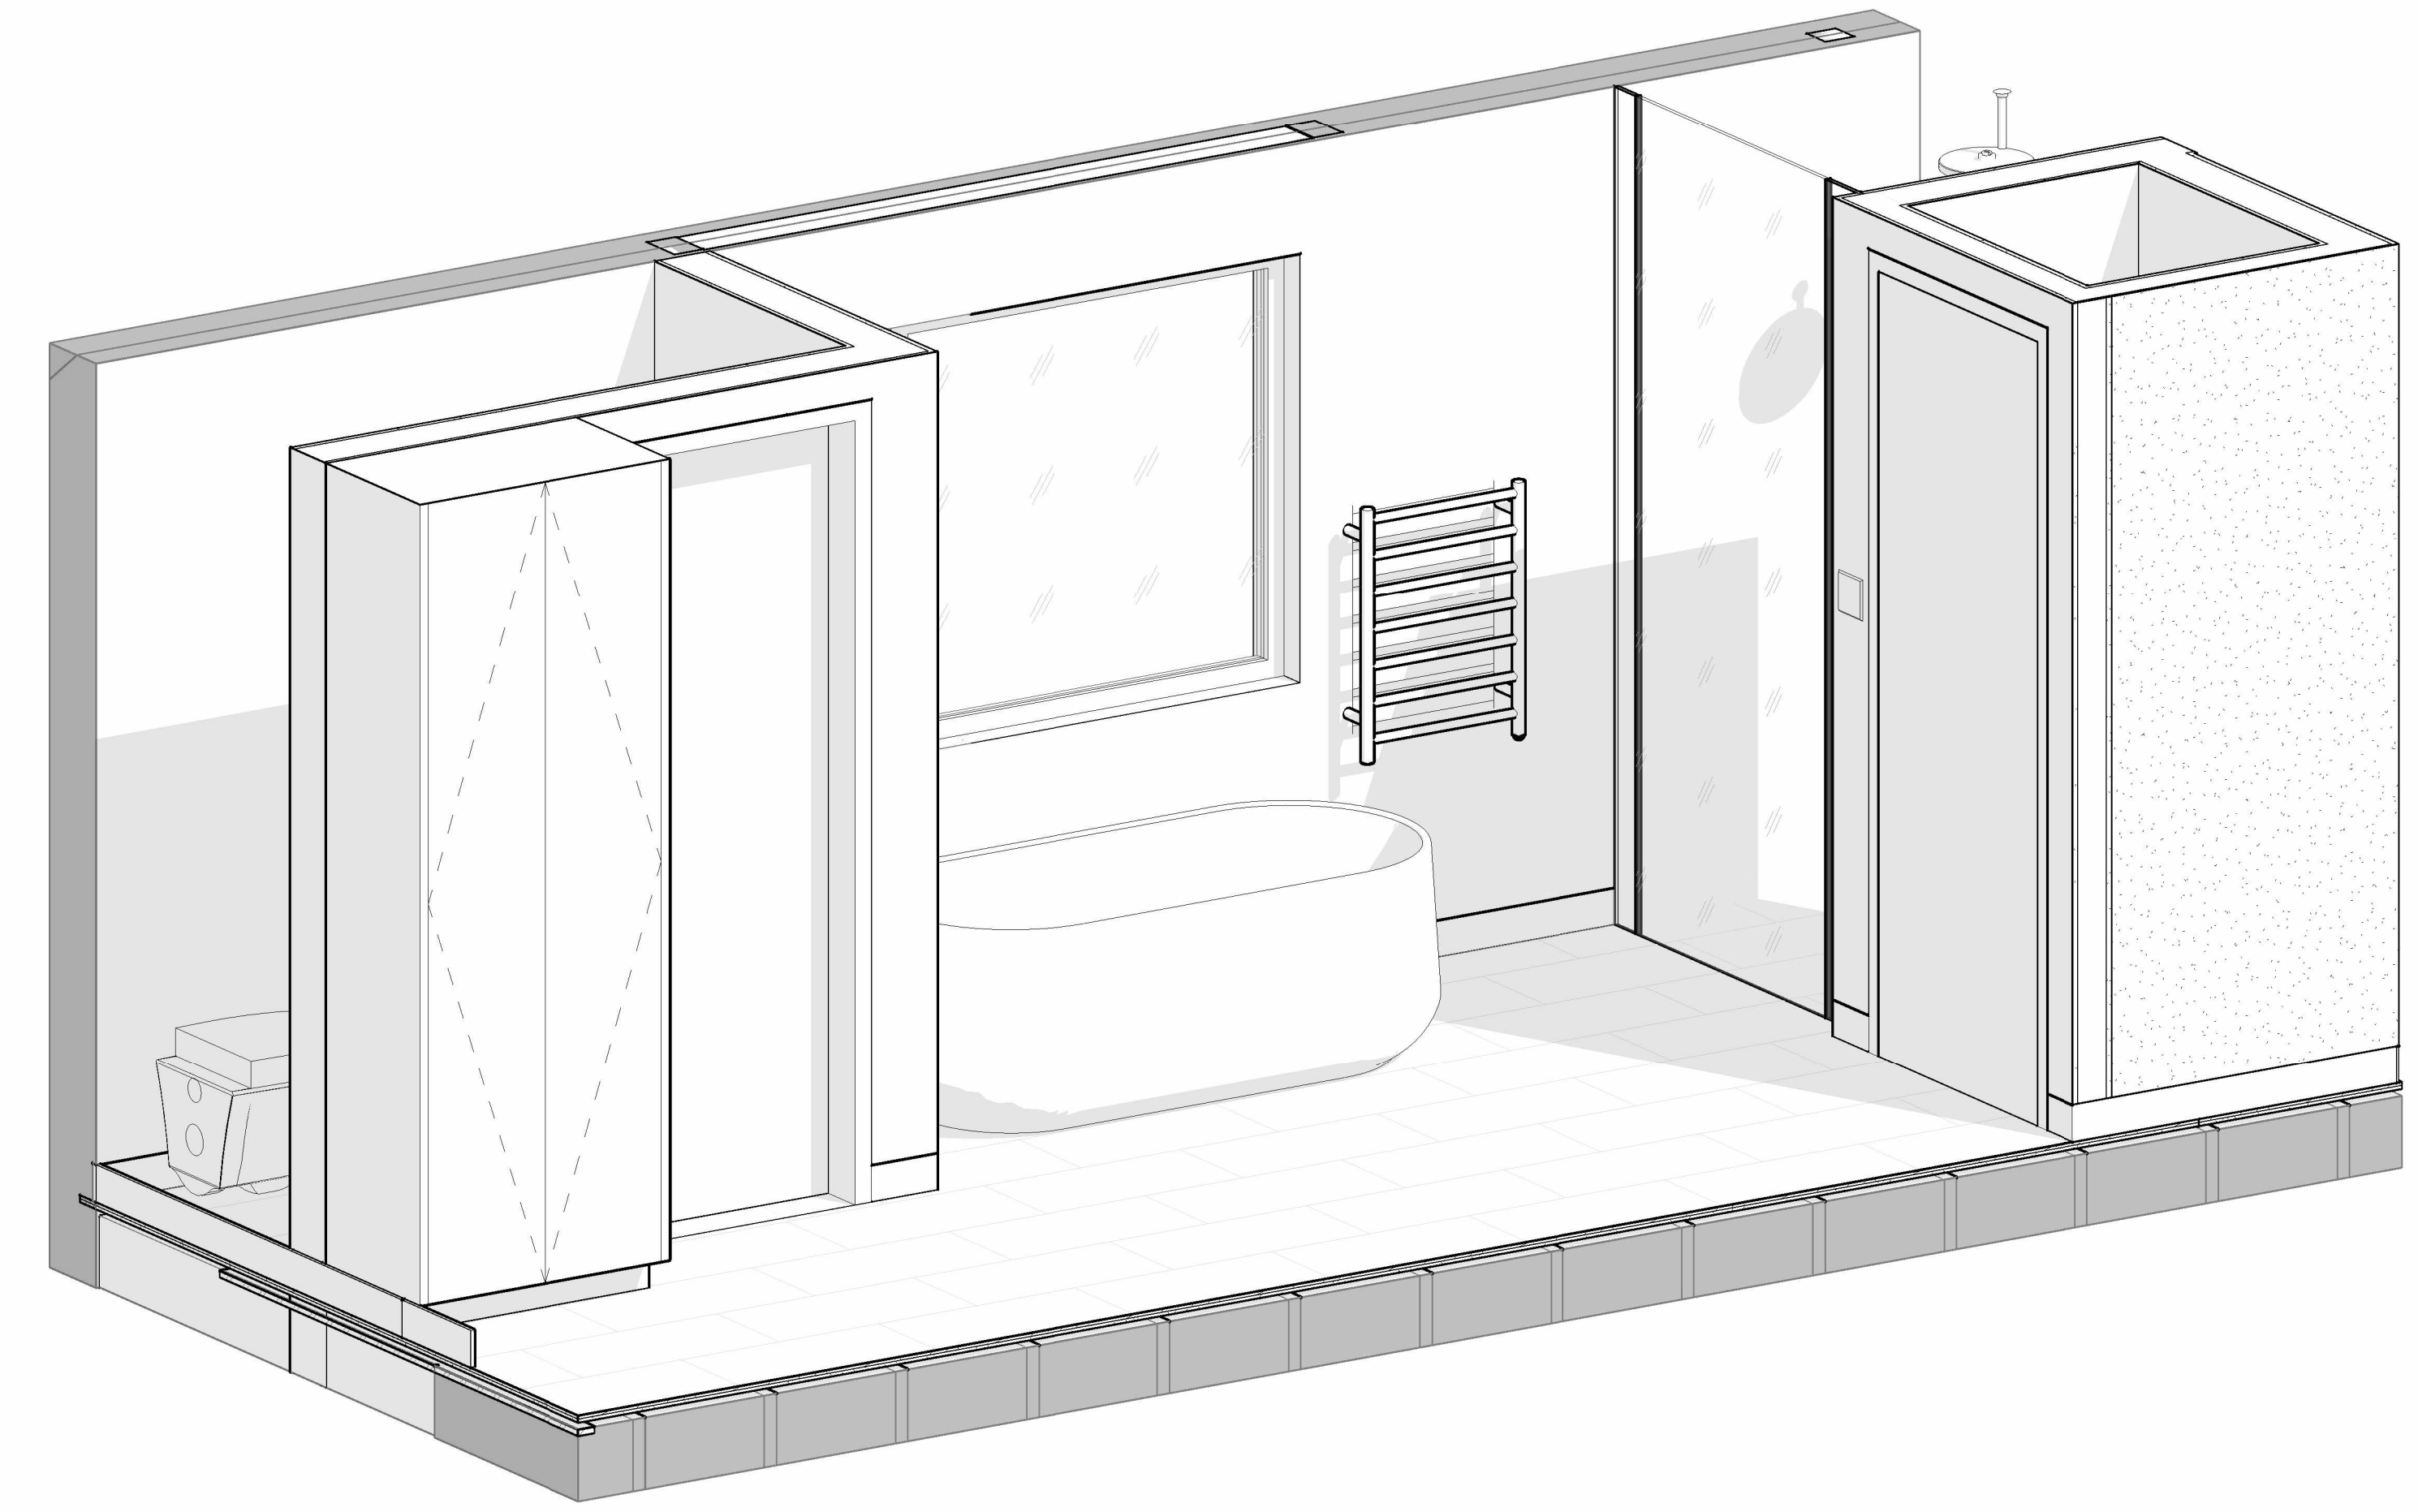


7 203 PRIMARY BATH - ORTHOGRAPHIC VIEW B

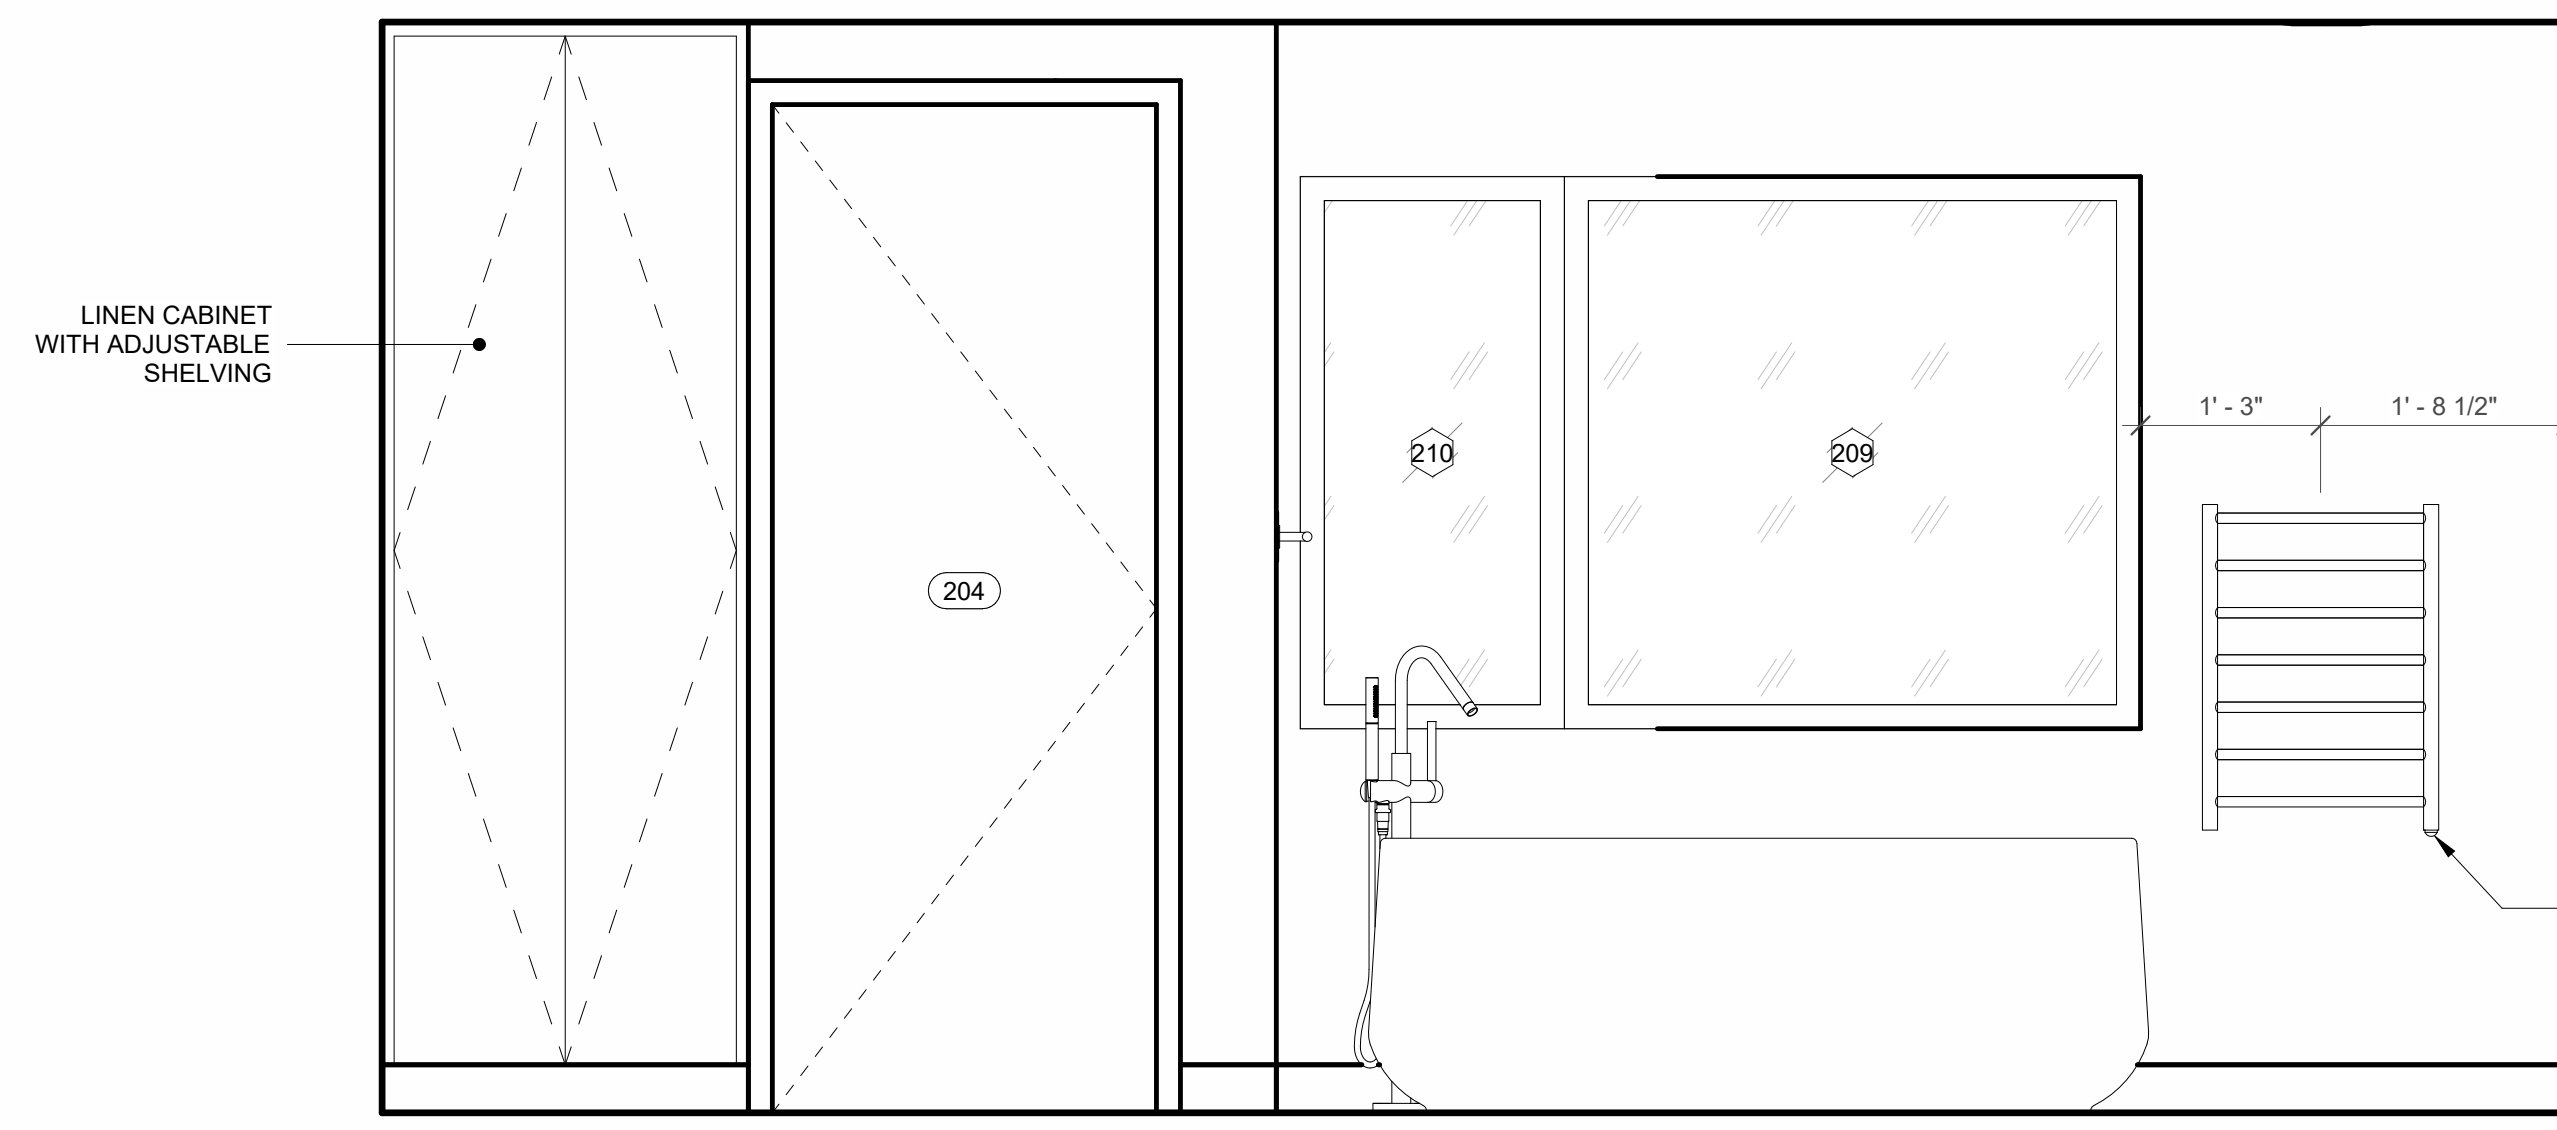


3 203 PRIMARY BATH - NORTH ELEVATION
 3/4" = 1'-0"

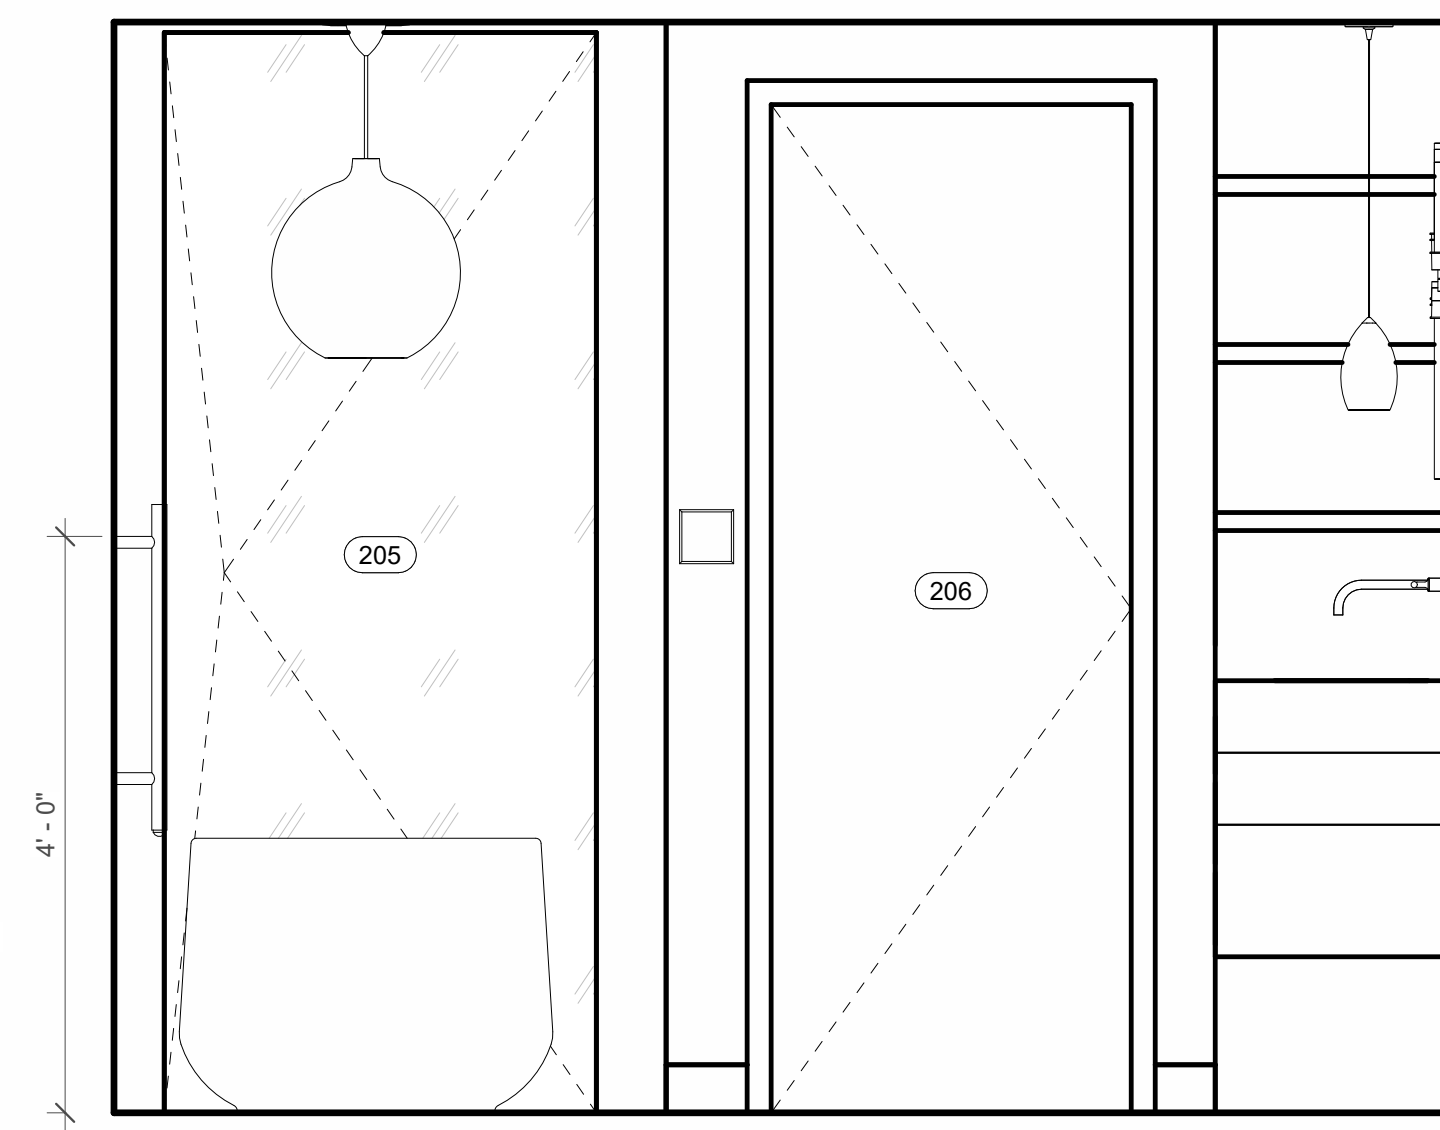


2 203 PRIMARY BATH - EAST ELEVATION
 3/4" = 1'-0"

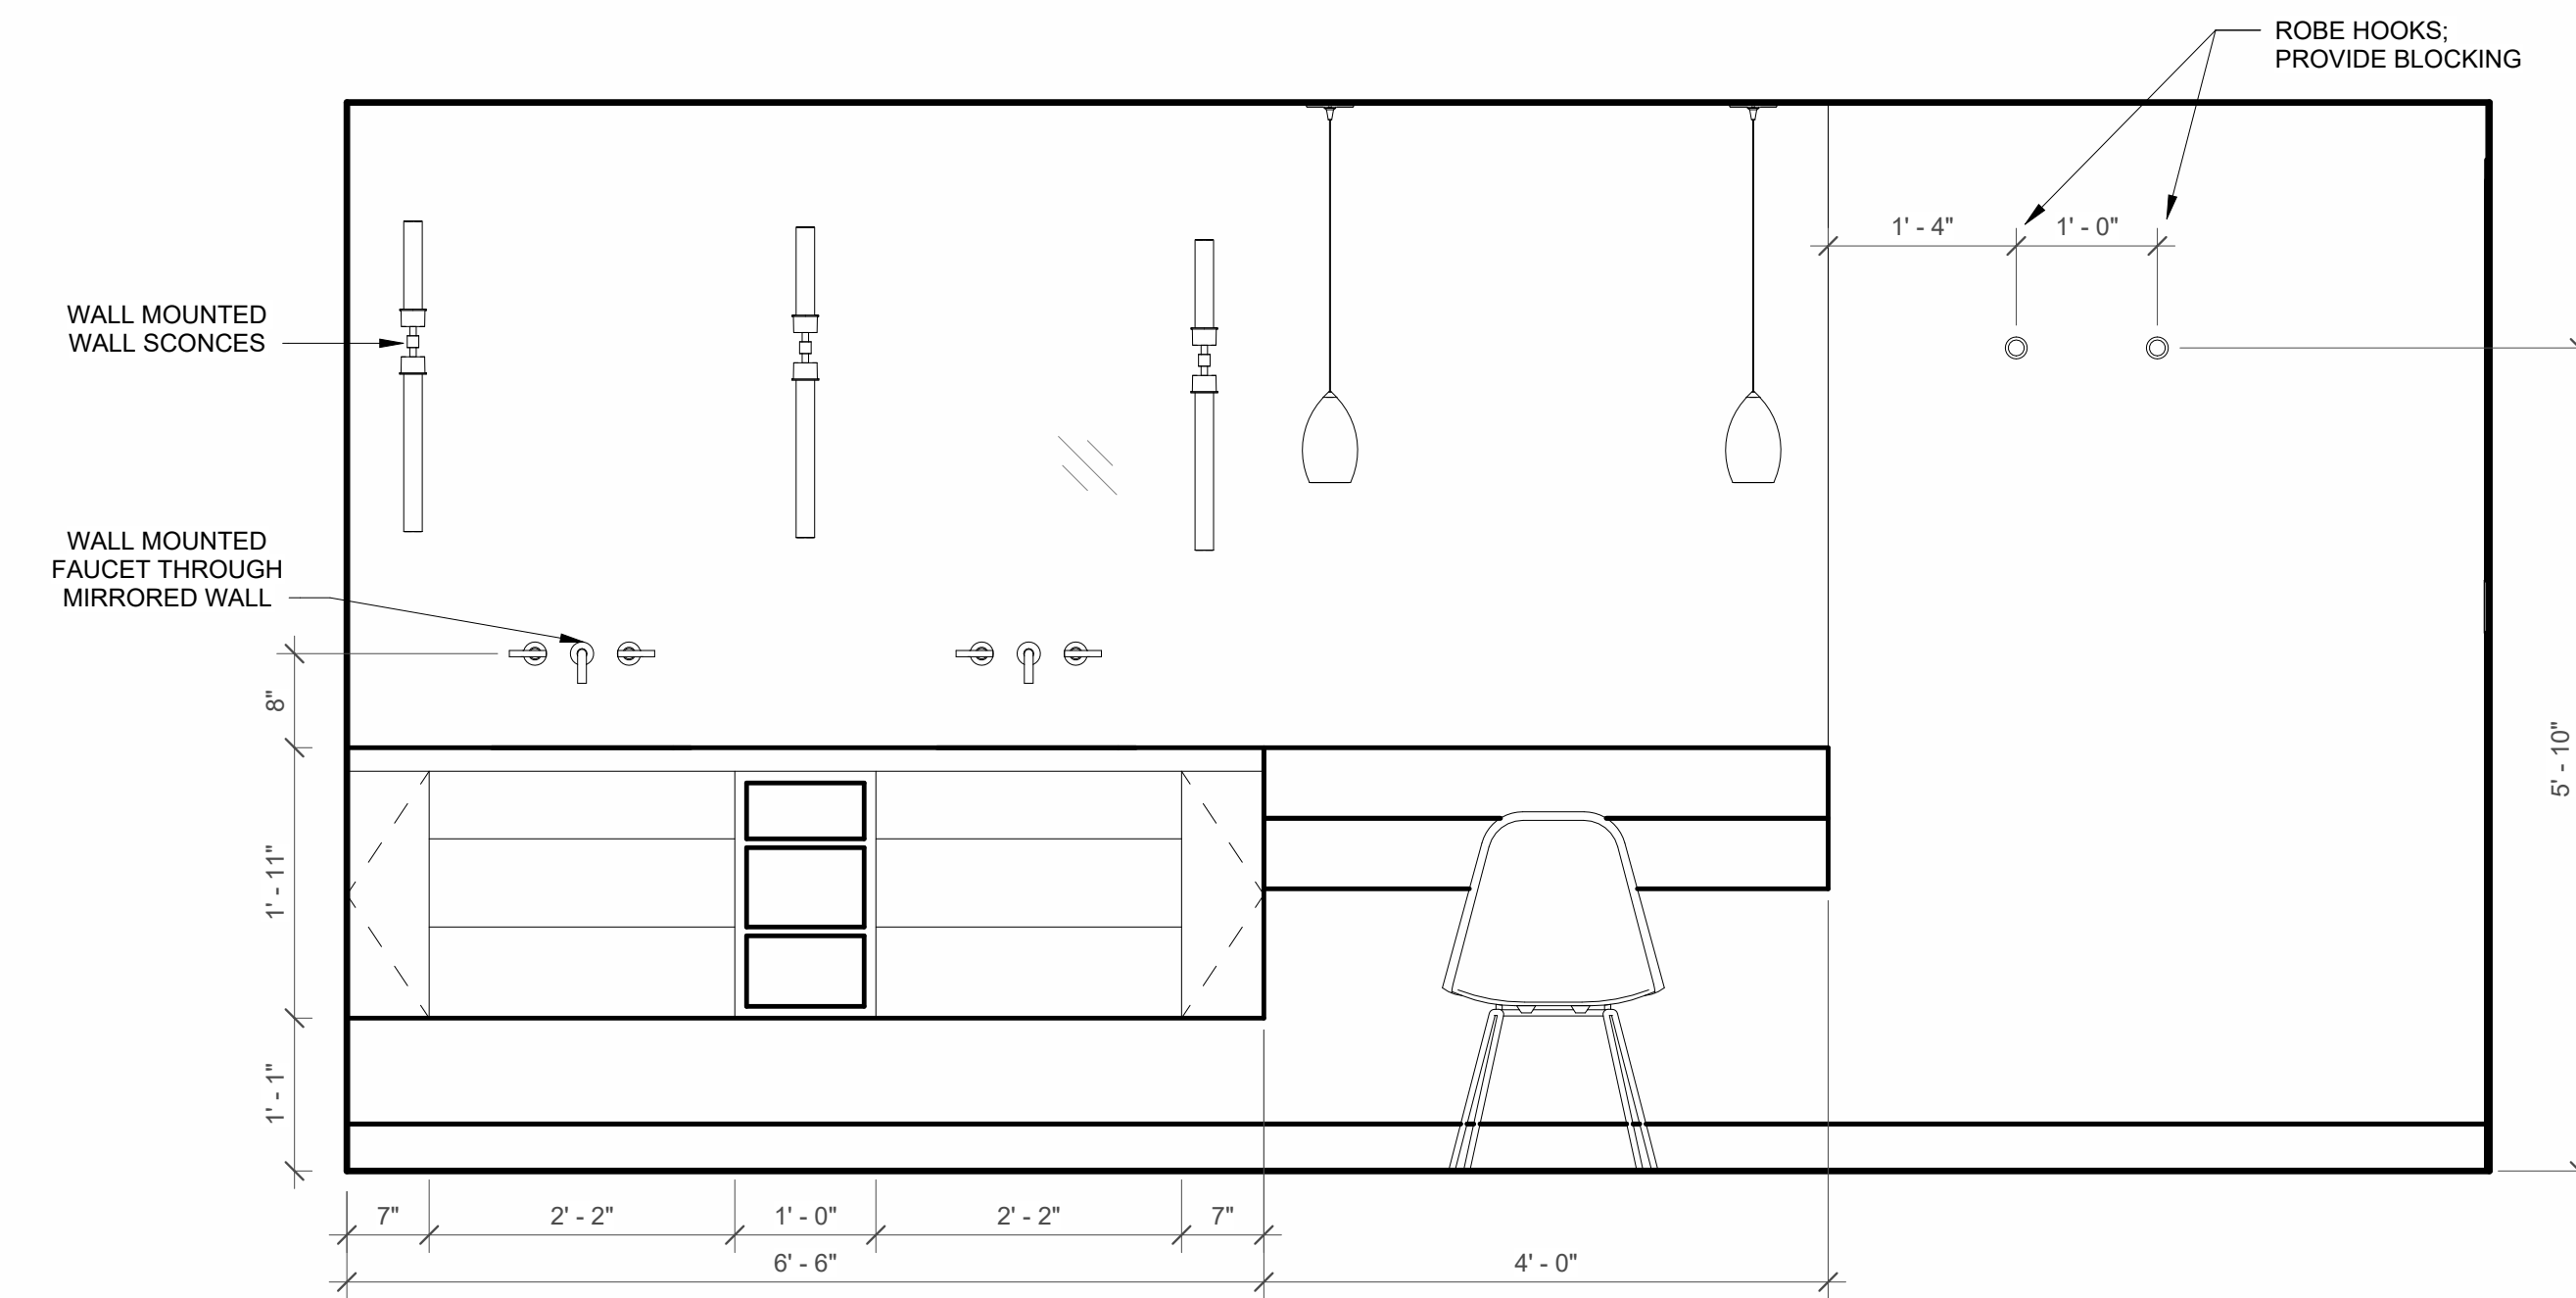

5 203 PRIMARY BATH - SOUTH ELEVATION
 3/4" = 1'-0"

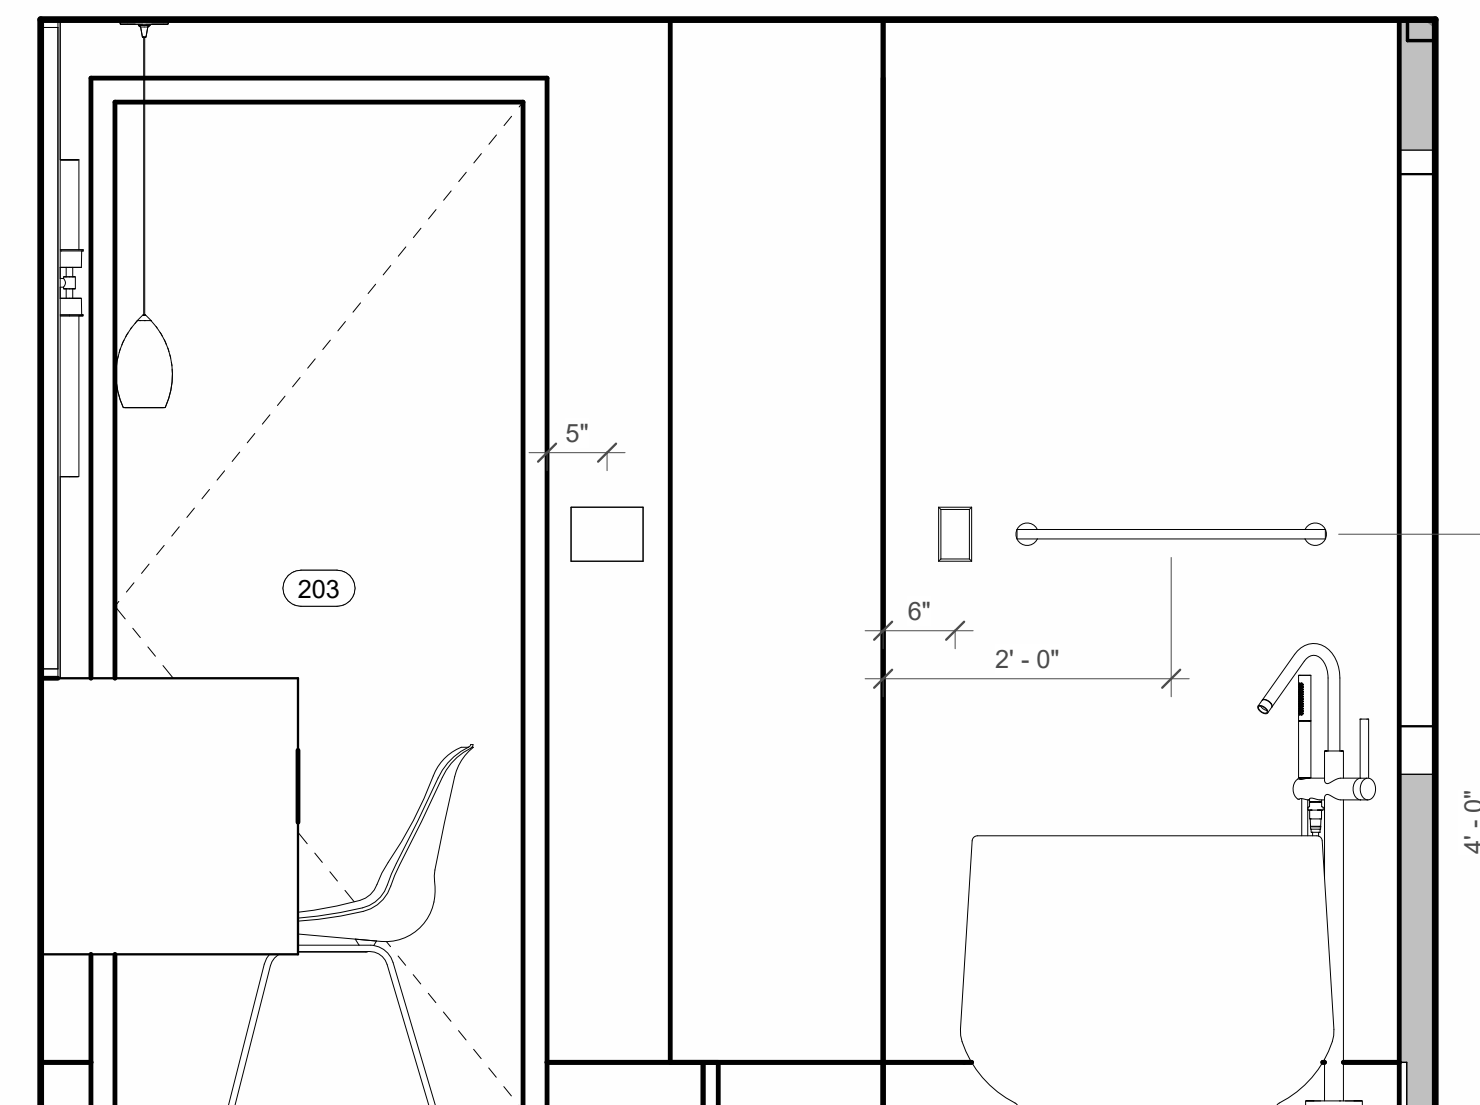

4 203 PRIMARY BATH - WEST ELEVATION
 3/4" = 1'-0"

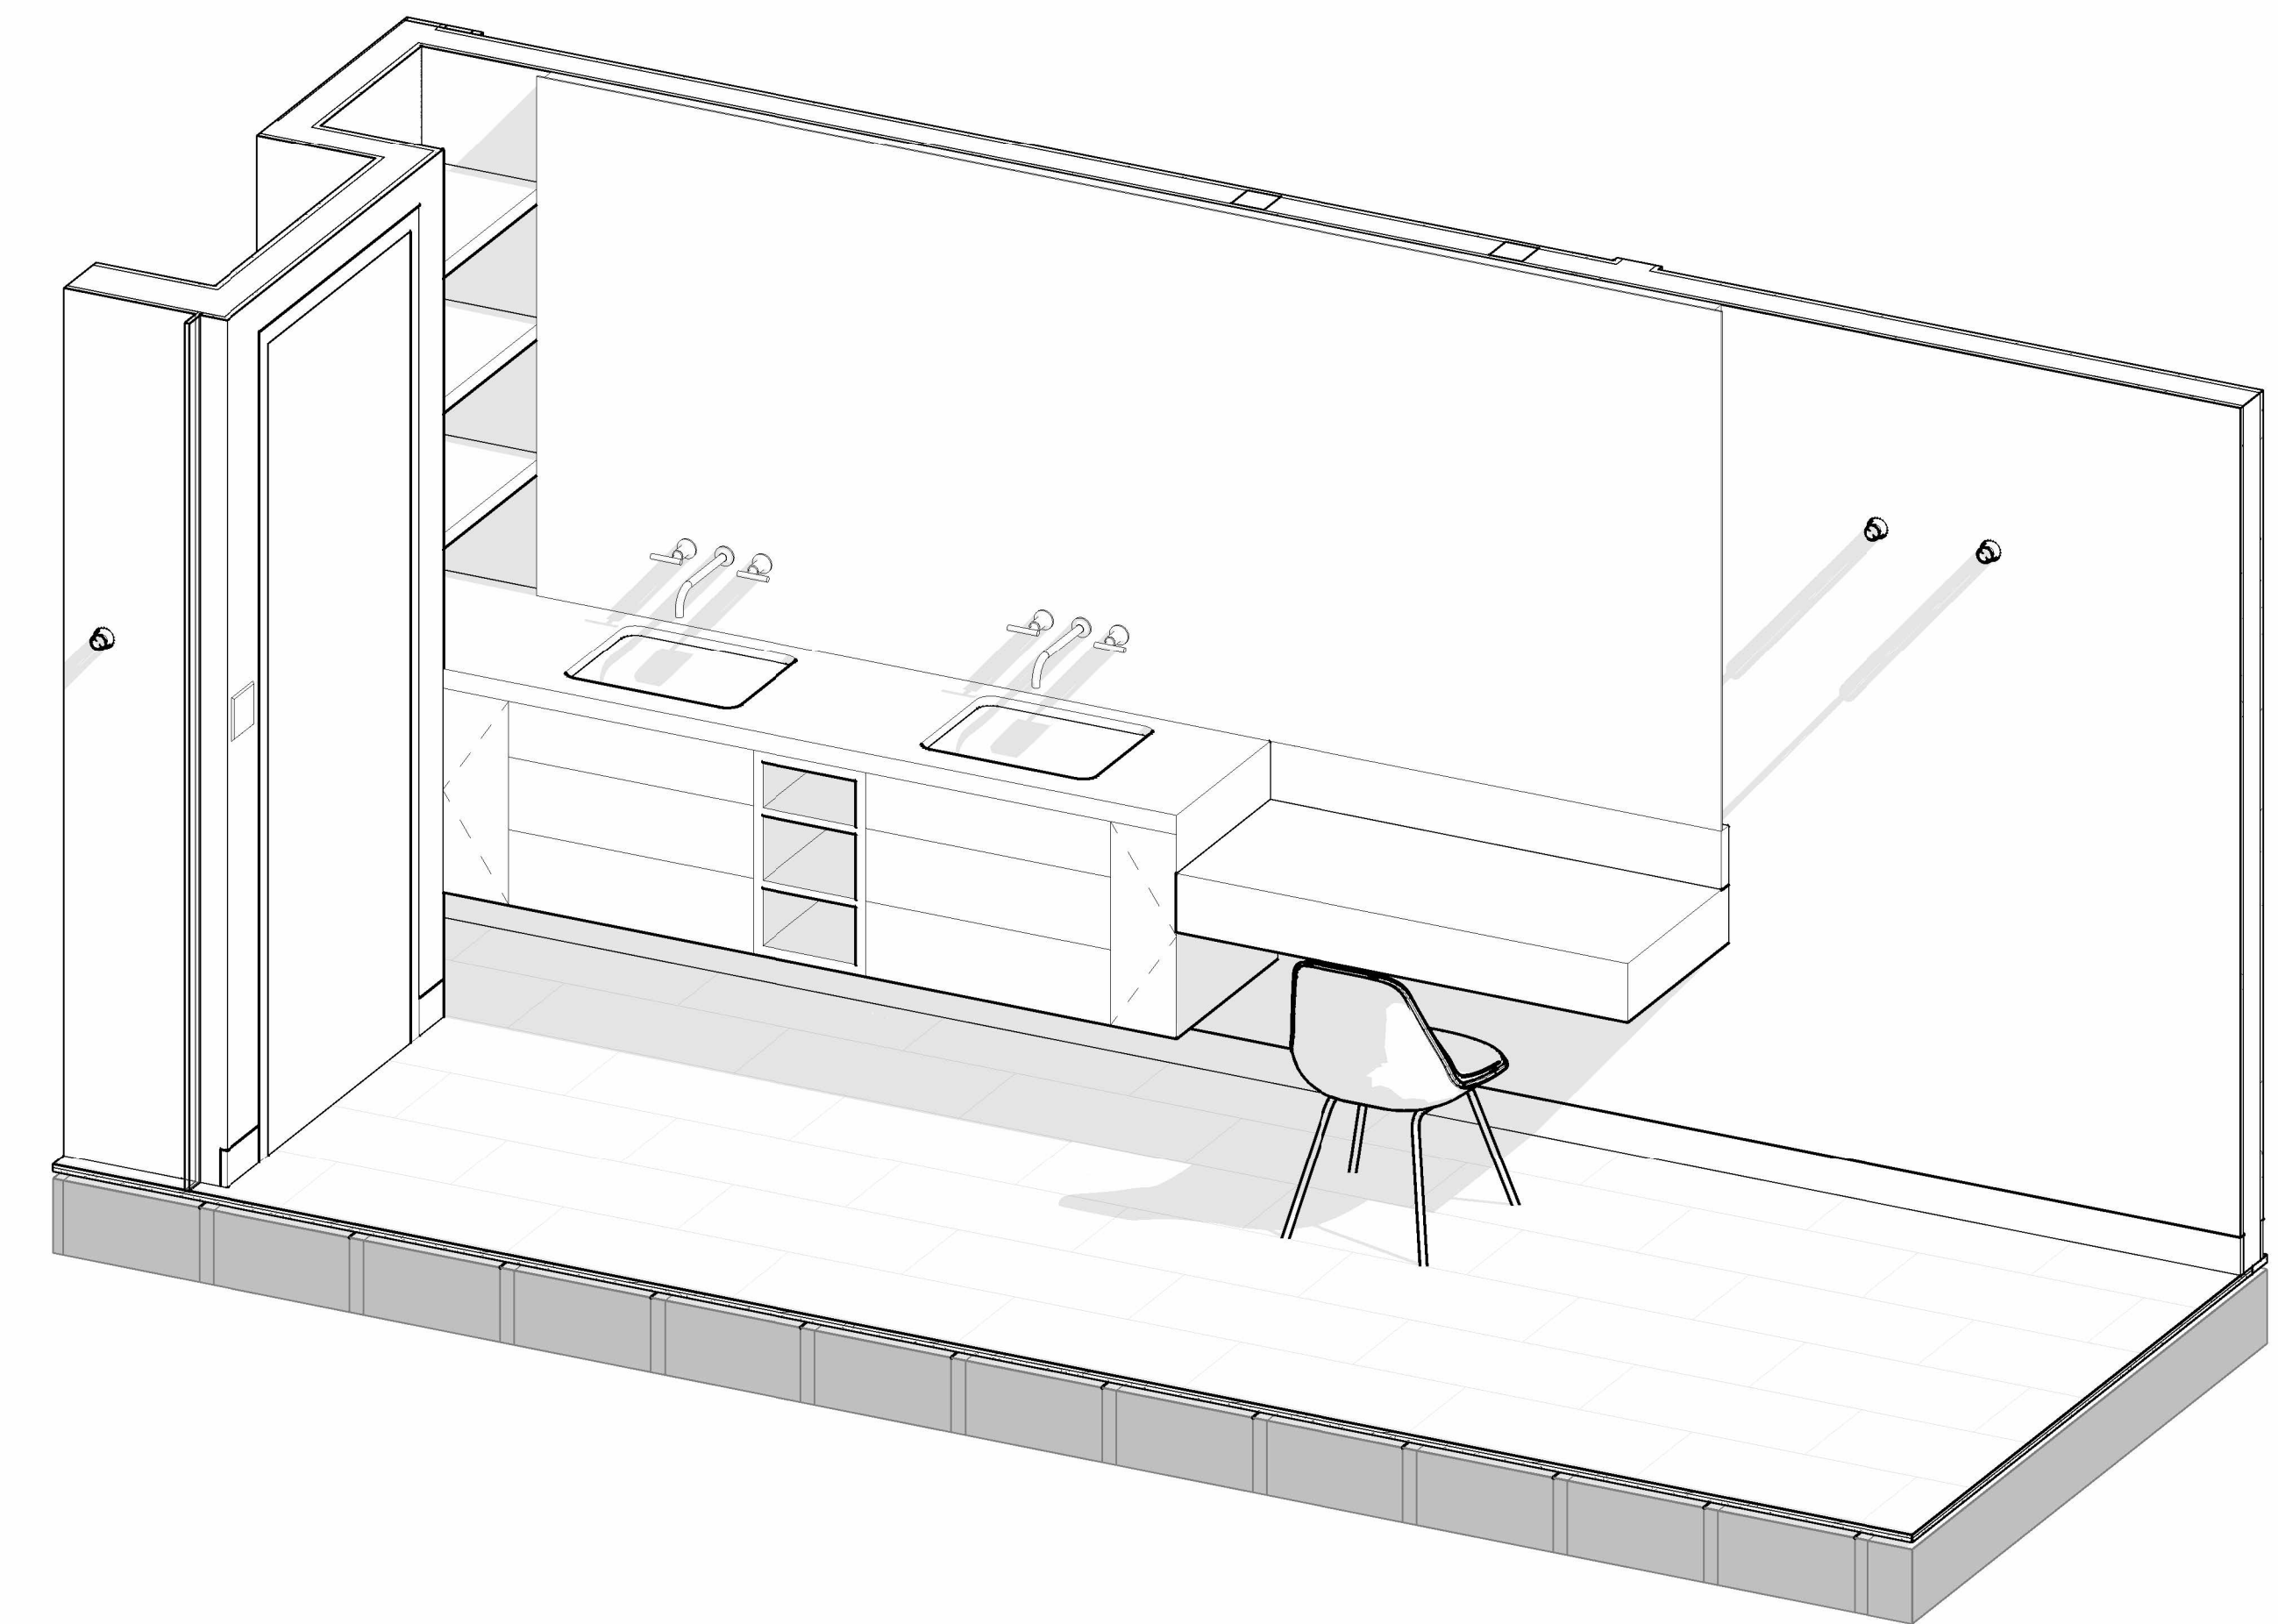

6 203 PRIMARY BATH - ORTHOGRAPHIC VIEW A

REVISION HISTORY		
NO.	DESCRIPTION	DATE

PERMIT REVISION

DATE:	AUG 18, 2023
SCALE:	3/4" = 1'-0"
DRAWN BY:	CJ
CHECKED BY:	CR

SHEET TITLE:	PROJECT #:	40035
--------------	------------	-------


ENLARGED INTERIOR PLANS & ELEVATIONS

CONSULTANT


CERTIFICATION




BAIRD RESIDENCE
 16 WOODLAND ROAD
 JAMAICA PLAIN, BOSTON, MA 02130

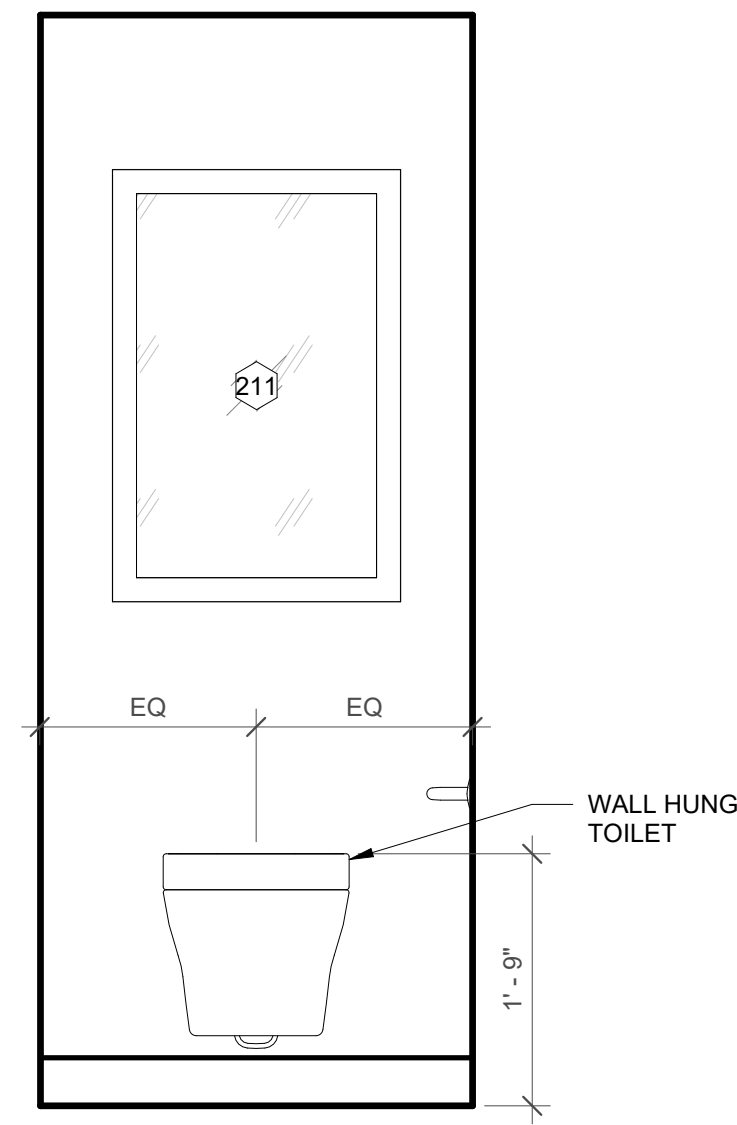


1 204 TOILET ROOM - WEST ELEVATION
 3/4" = 1'-0"

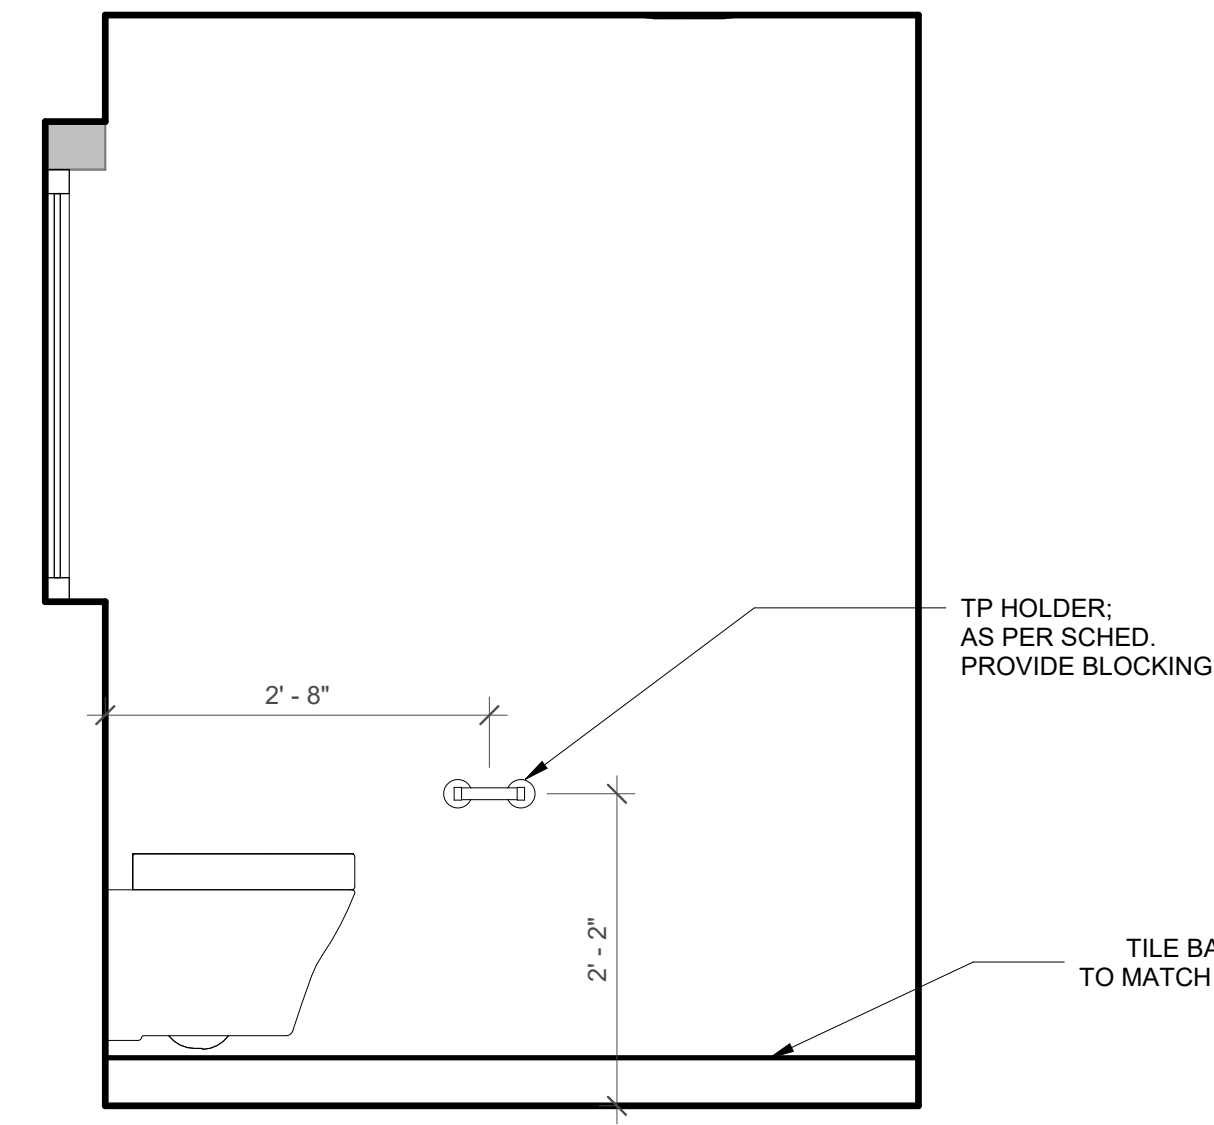


2 204 TOILET ROOM - NORTH ELEVATION
 3/4" = 1'-0"

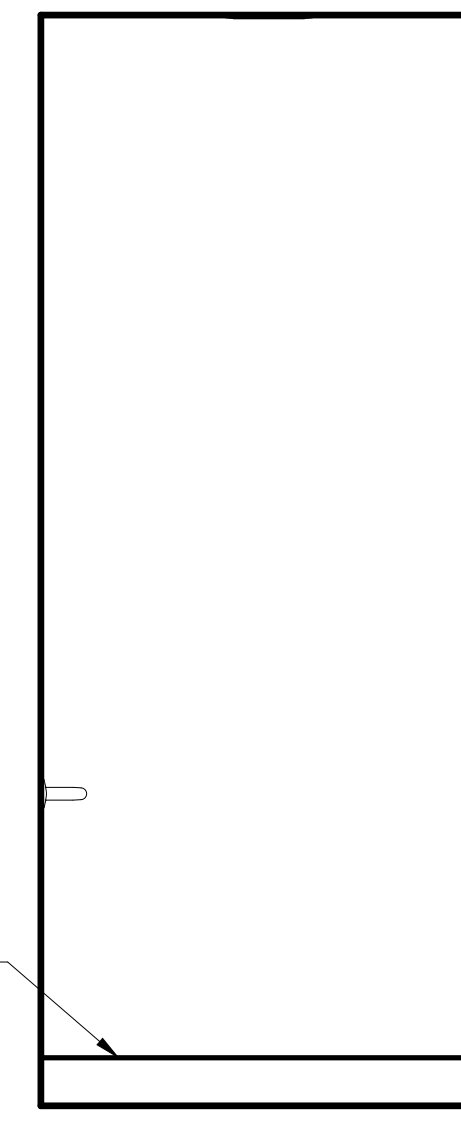


3 204 TOILET ROOM - EAST ELEVATION
 3/4" = 1'-0"

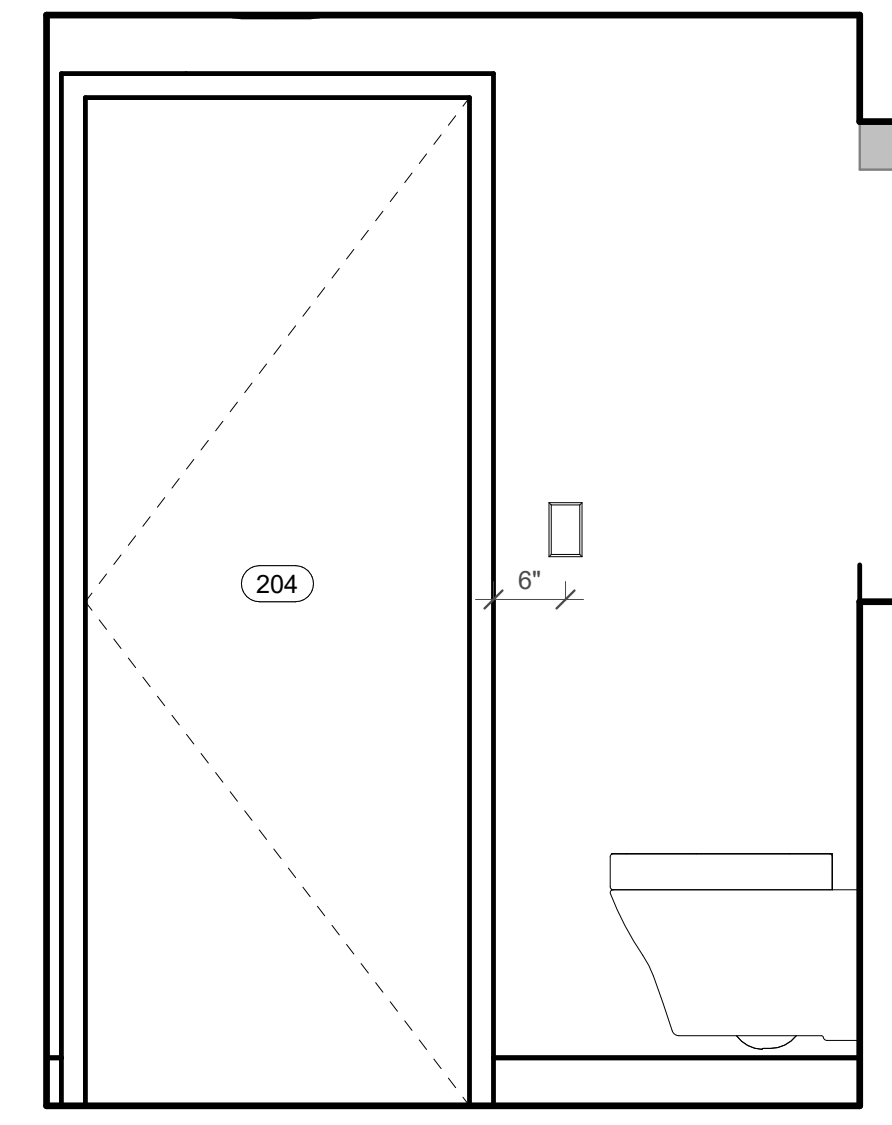


4 204 TOILET ROOM - SOUTH ELEVATION
 3/4" = 1'-0"

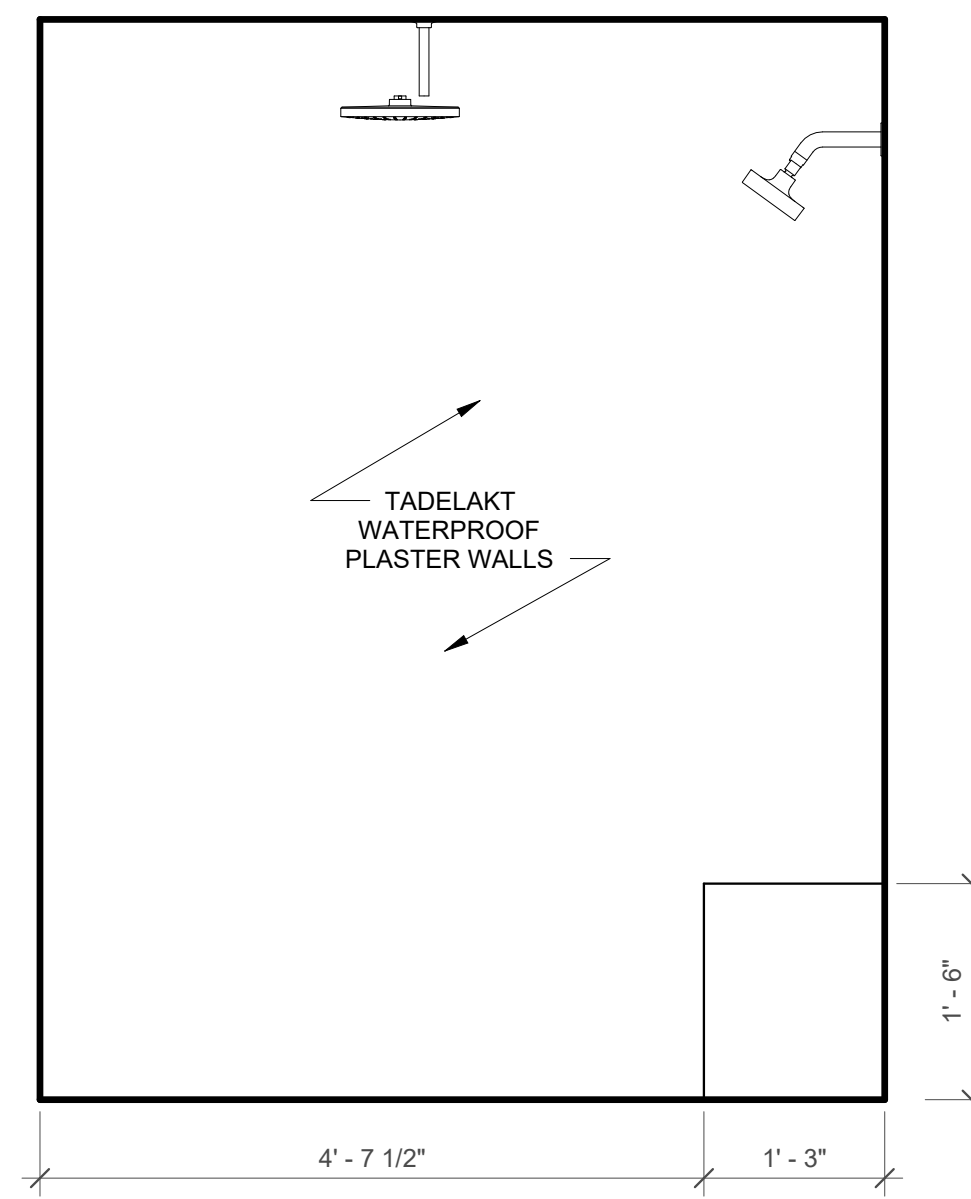


5 205 PRIMARY SHOWER - NORTH ELEVATION
 3/4" = 1'-0"

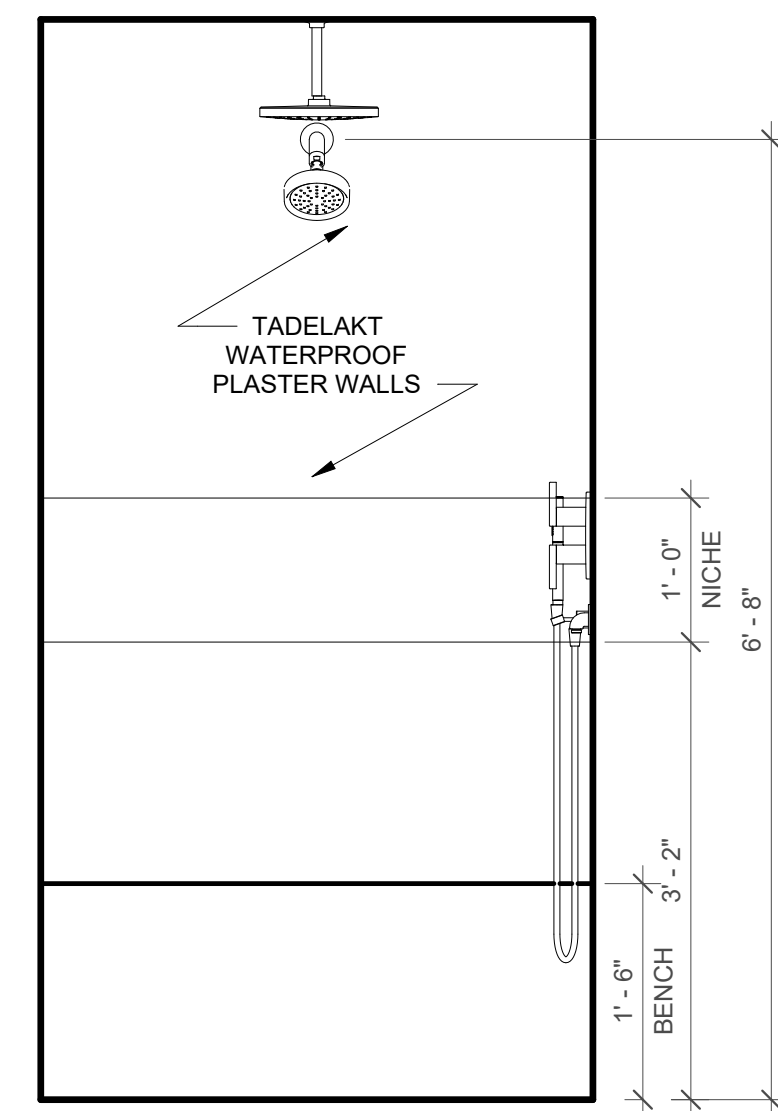

6 205 PRIMARY SHOWER - EAST ELEVATION
 3/4" = 1'-0"

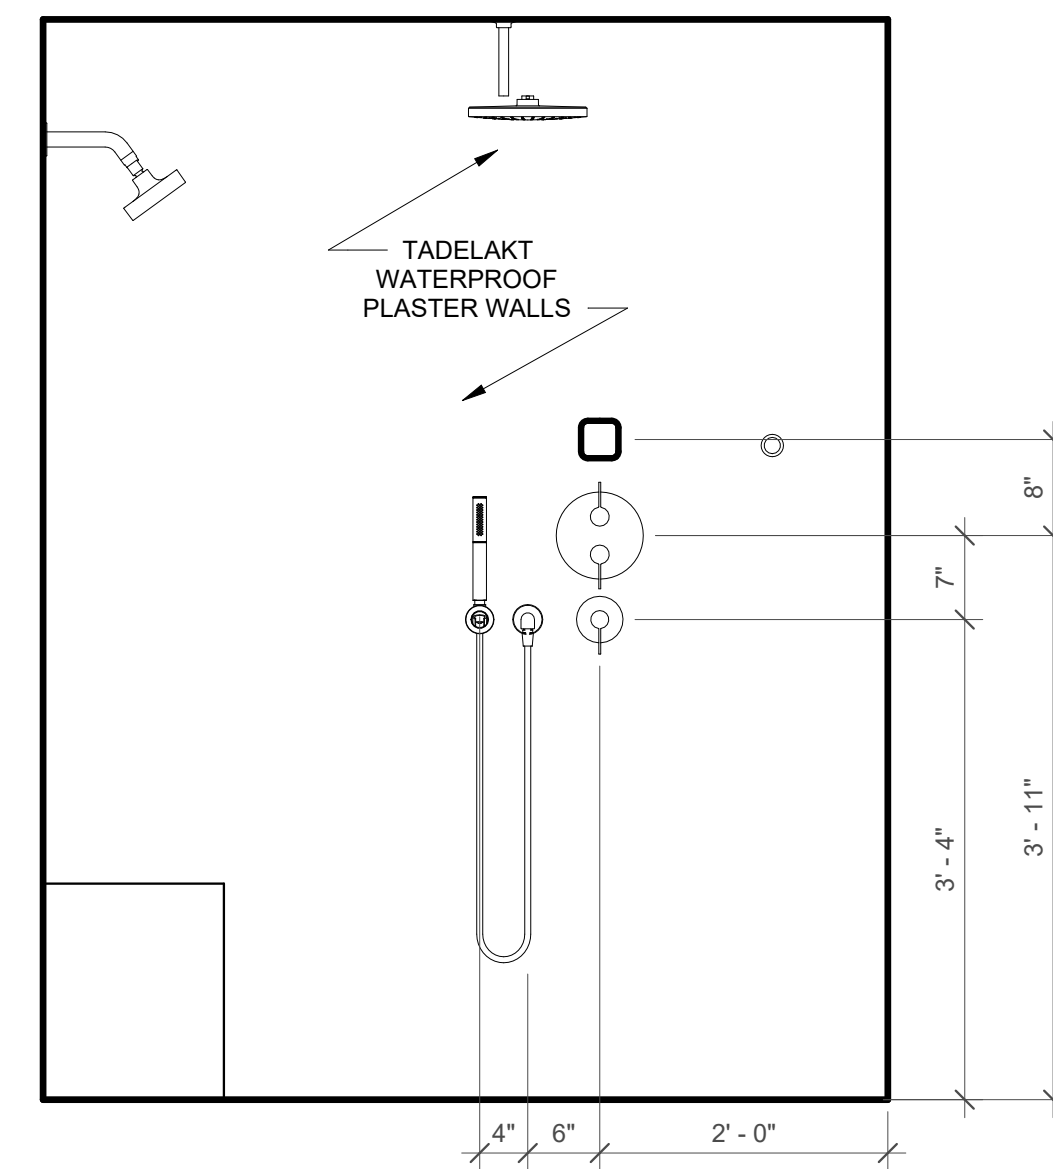

7 205 PRIMARY SHOWER - SOUTH ELEVATION
 3/4" = 1'-0"

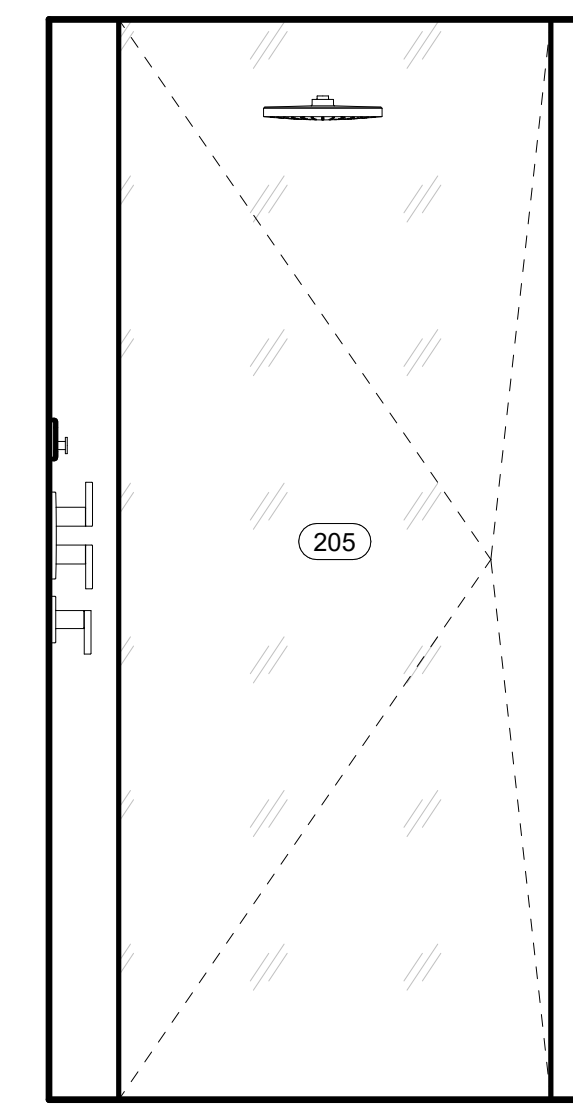

8 205 PRIMARY SHOWER - WEST ELEVATION
 3/4" = 1'-0"



REVISION HISTORY
 NO. DESCRIPTION DATE

PERMIT REVISION


DATE: AUG 18, 2023
 SCALE: 3/4" = 1'-0"
 DRAWN BY: CJ
 CHECKED BY: CR

SHEET TITLE PROJECT #: 40035


ENLARGED
 INTERIOR PLANS &
 ELEVATIONS

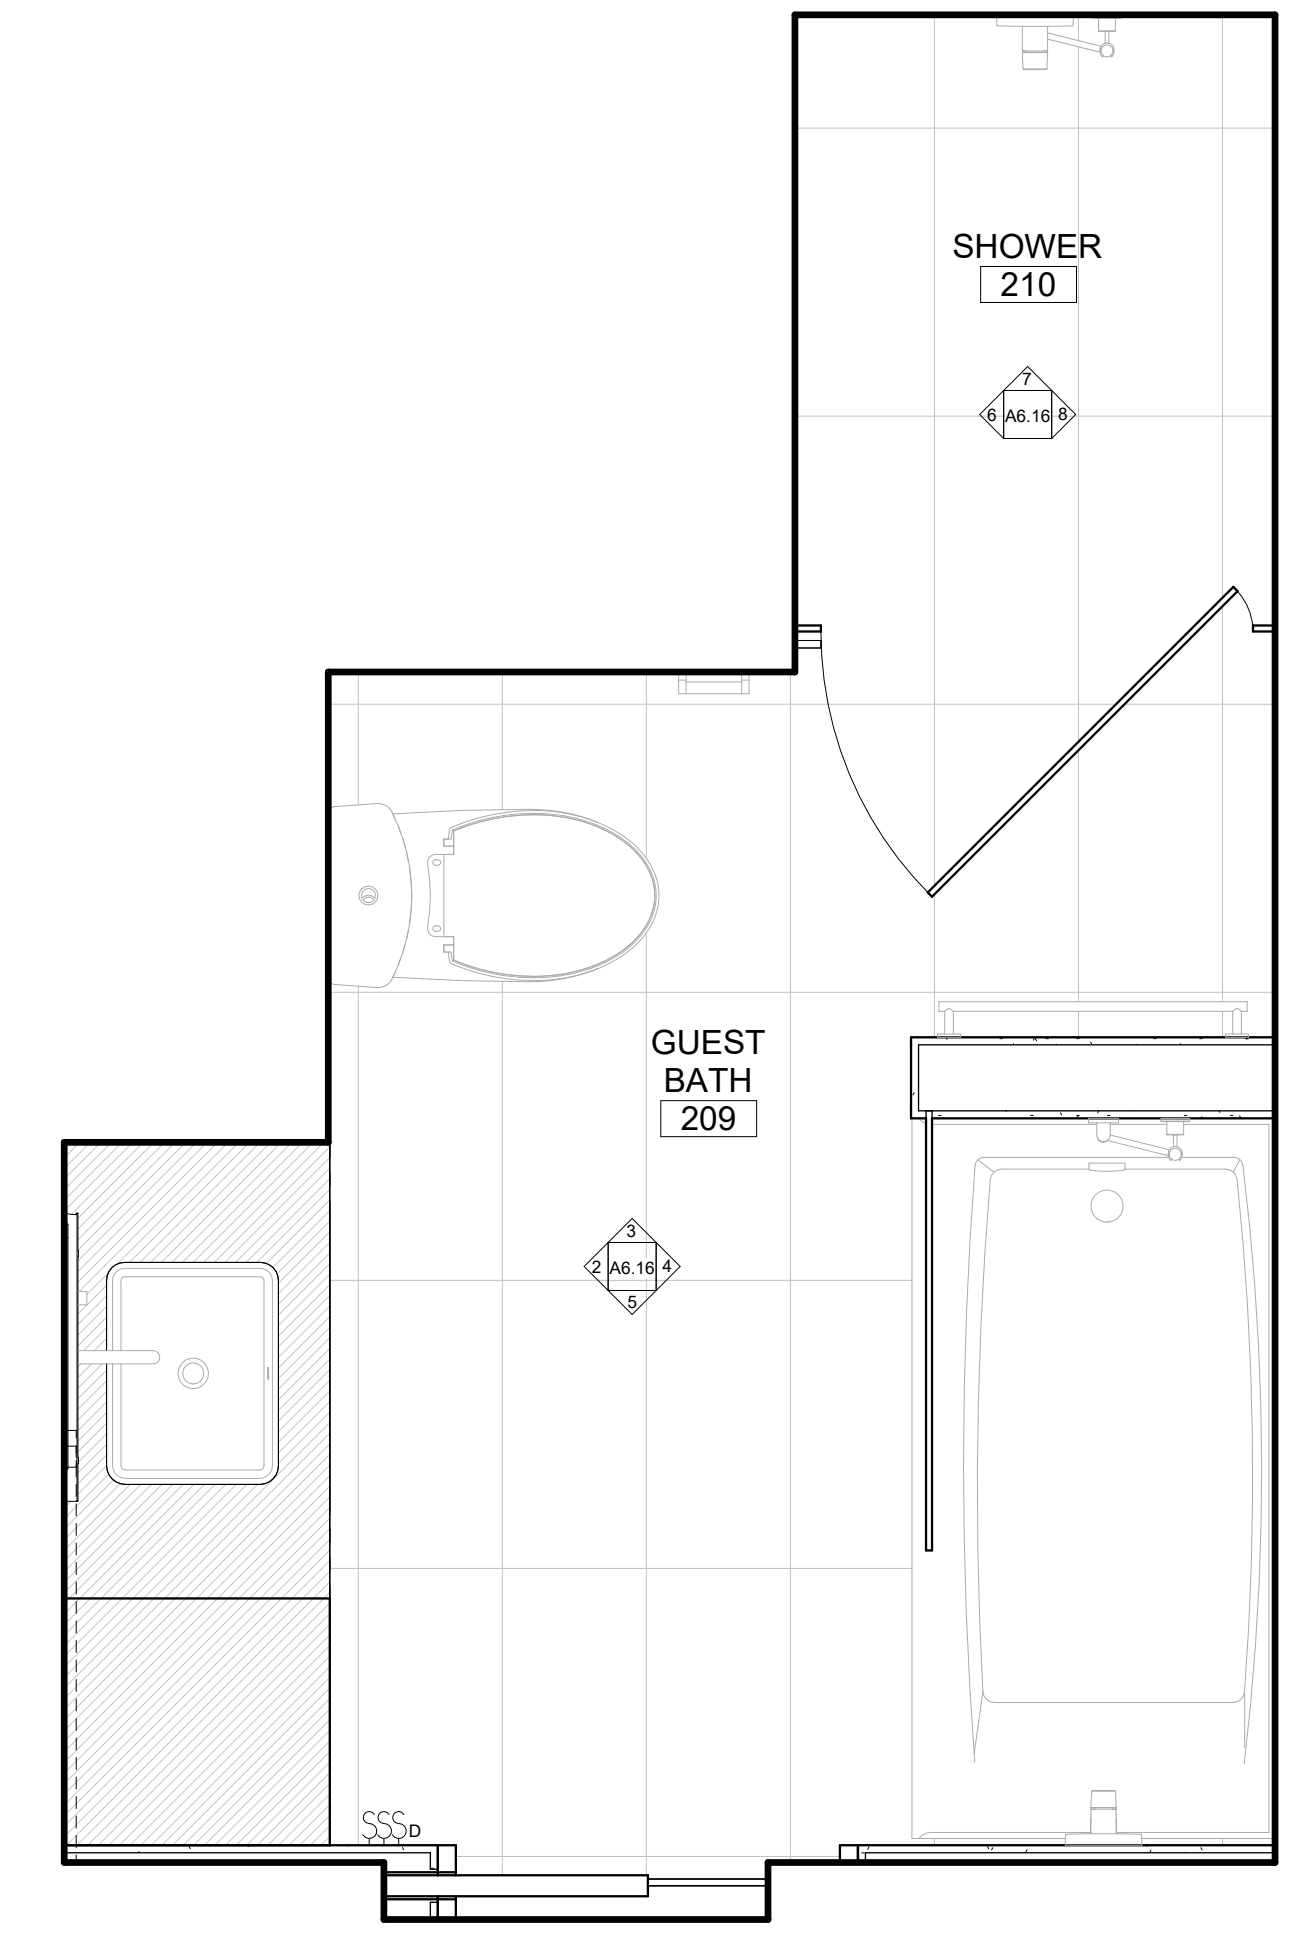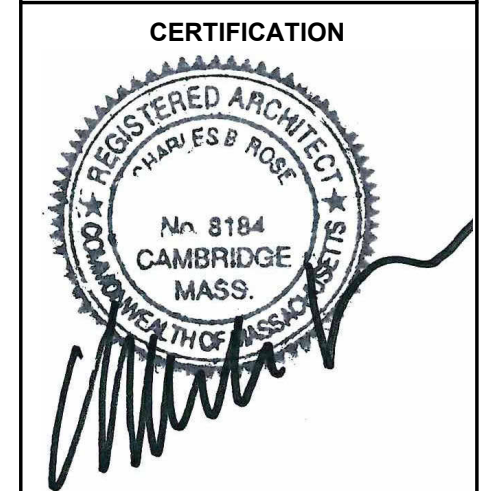


1 209 GUEST BATH
 3/4" = 1'-0"

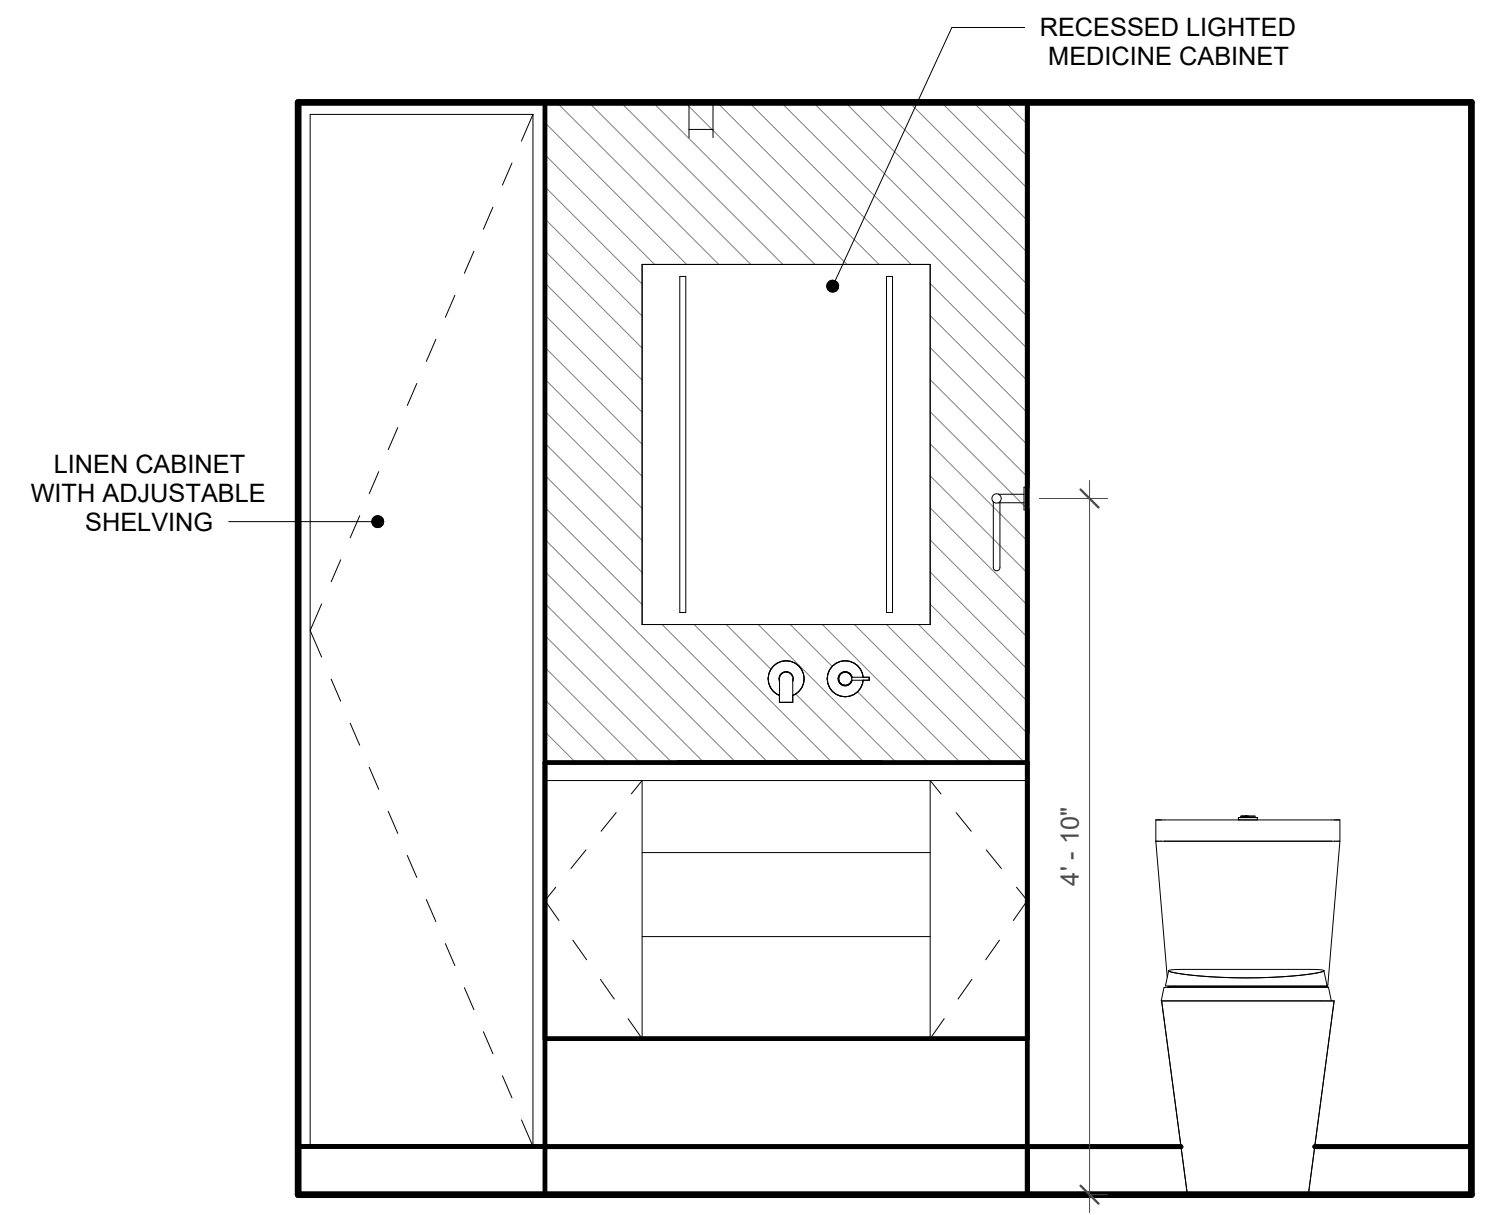


2 209 GUEST BATH - WEST ELEVATION
 3/4" = 1'-0"

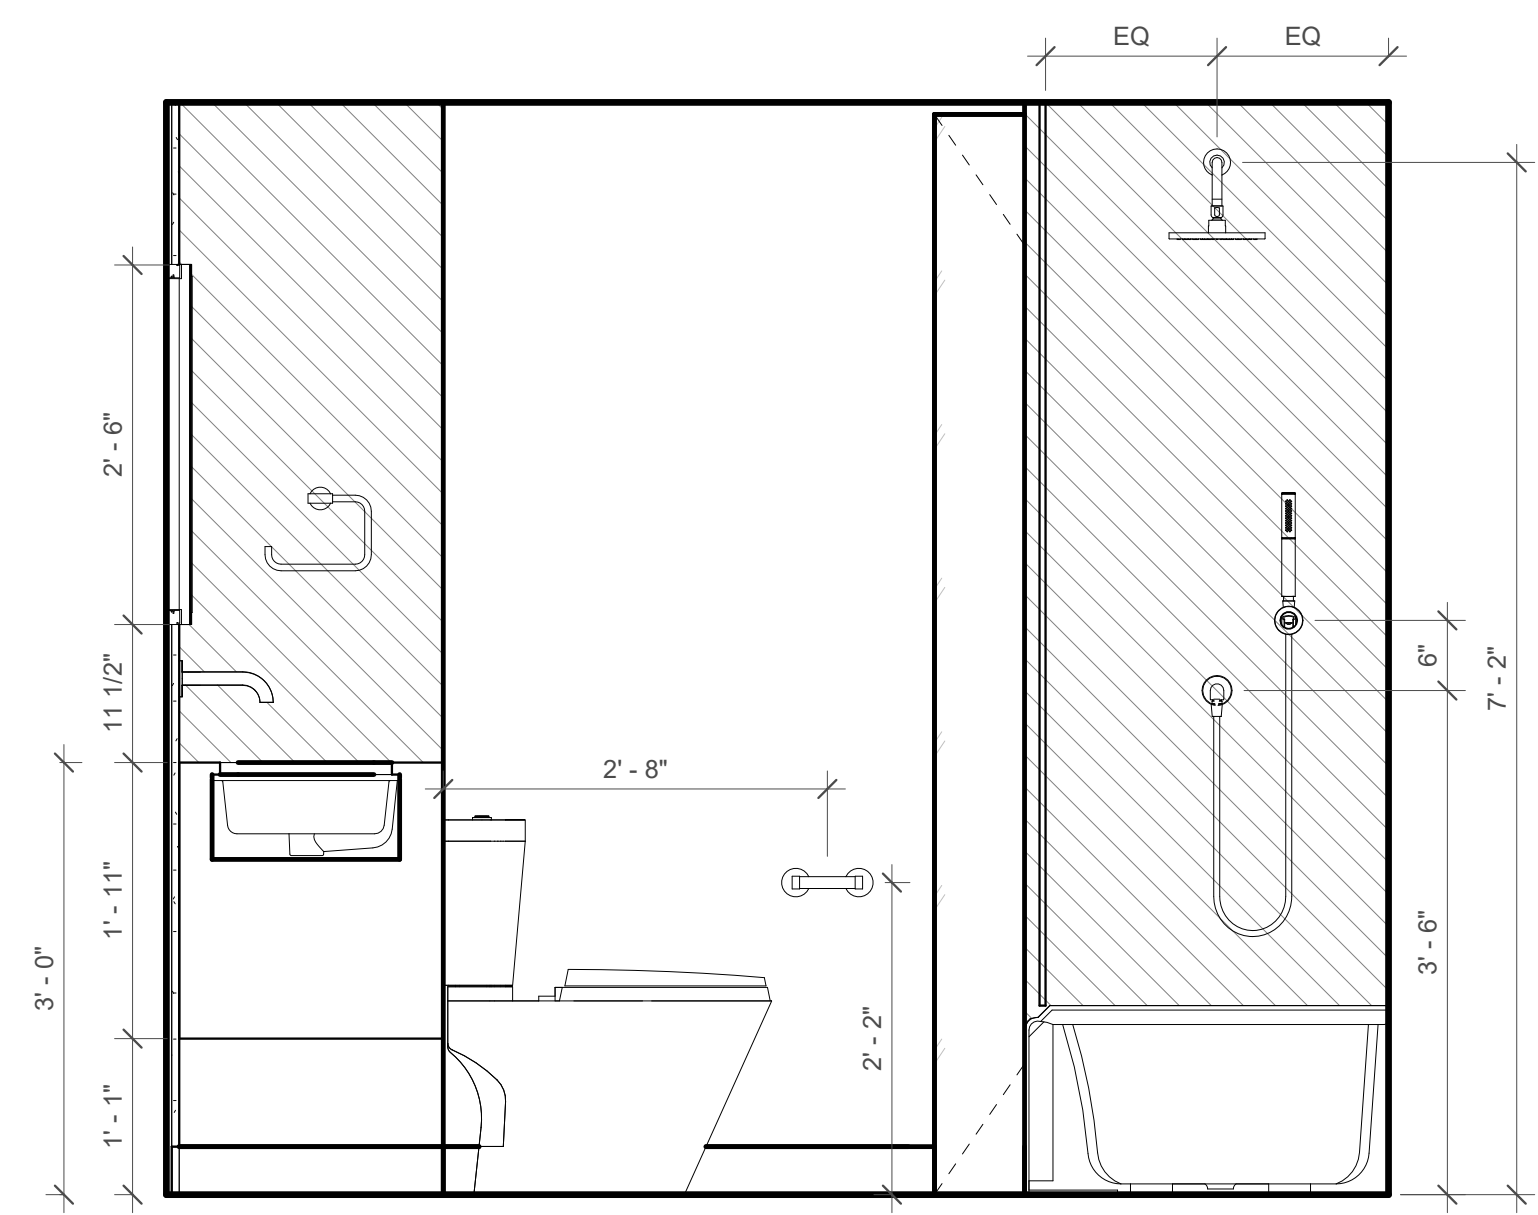


3 209 GUEST BATH - NORTH ELEVATION
 3/4" = 1'-0"

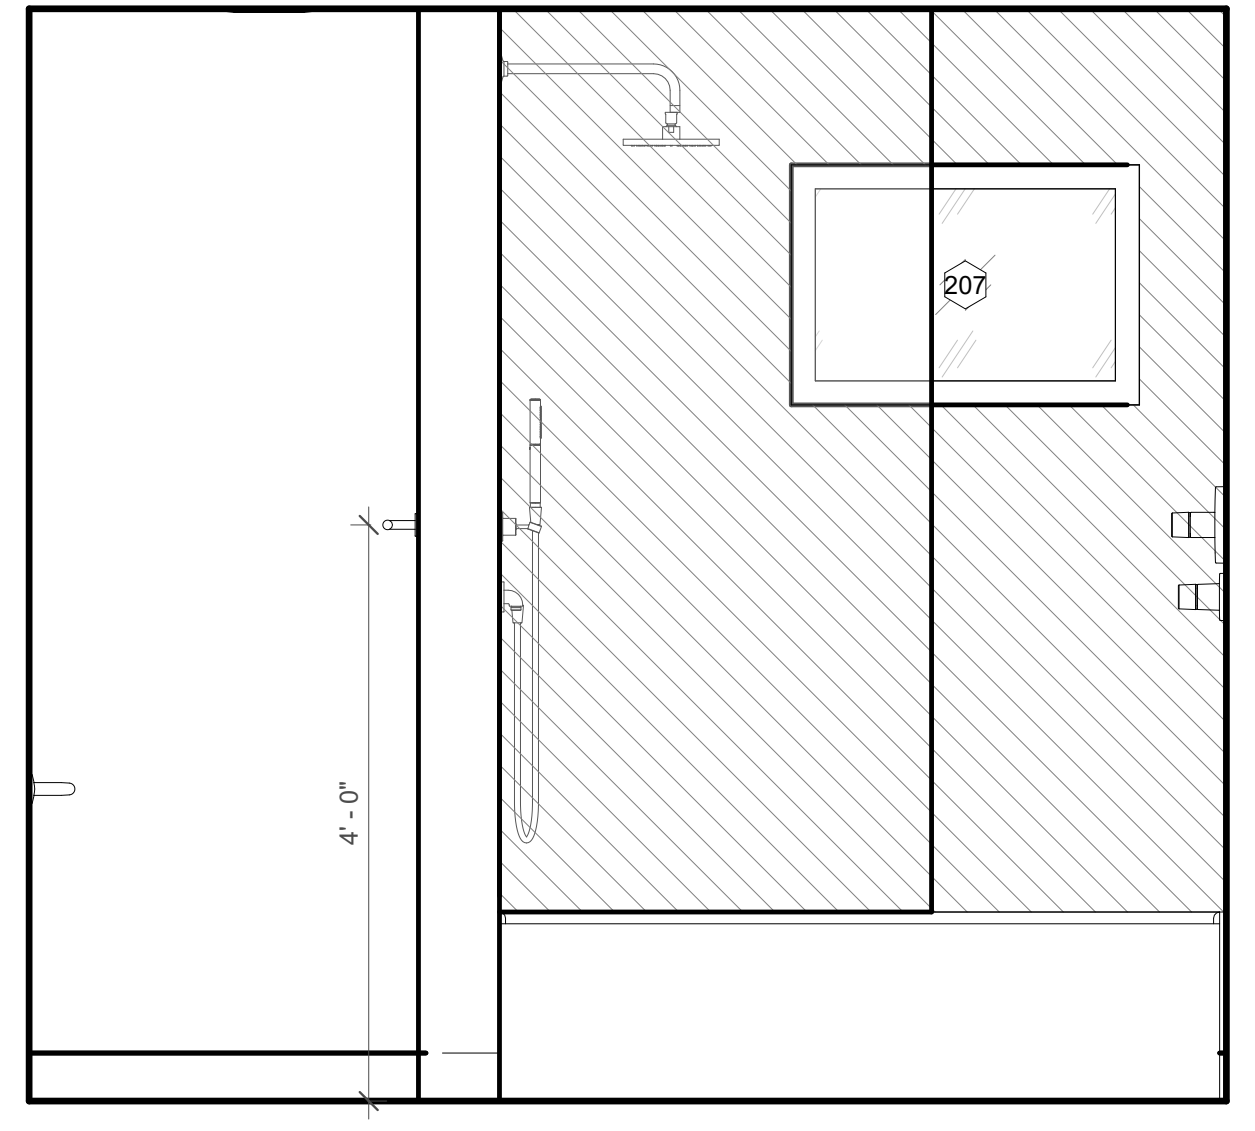


4 209 GUEST BATH - EAST ELEVATION
 3/4" = 1'-0"

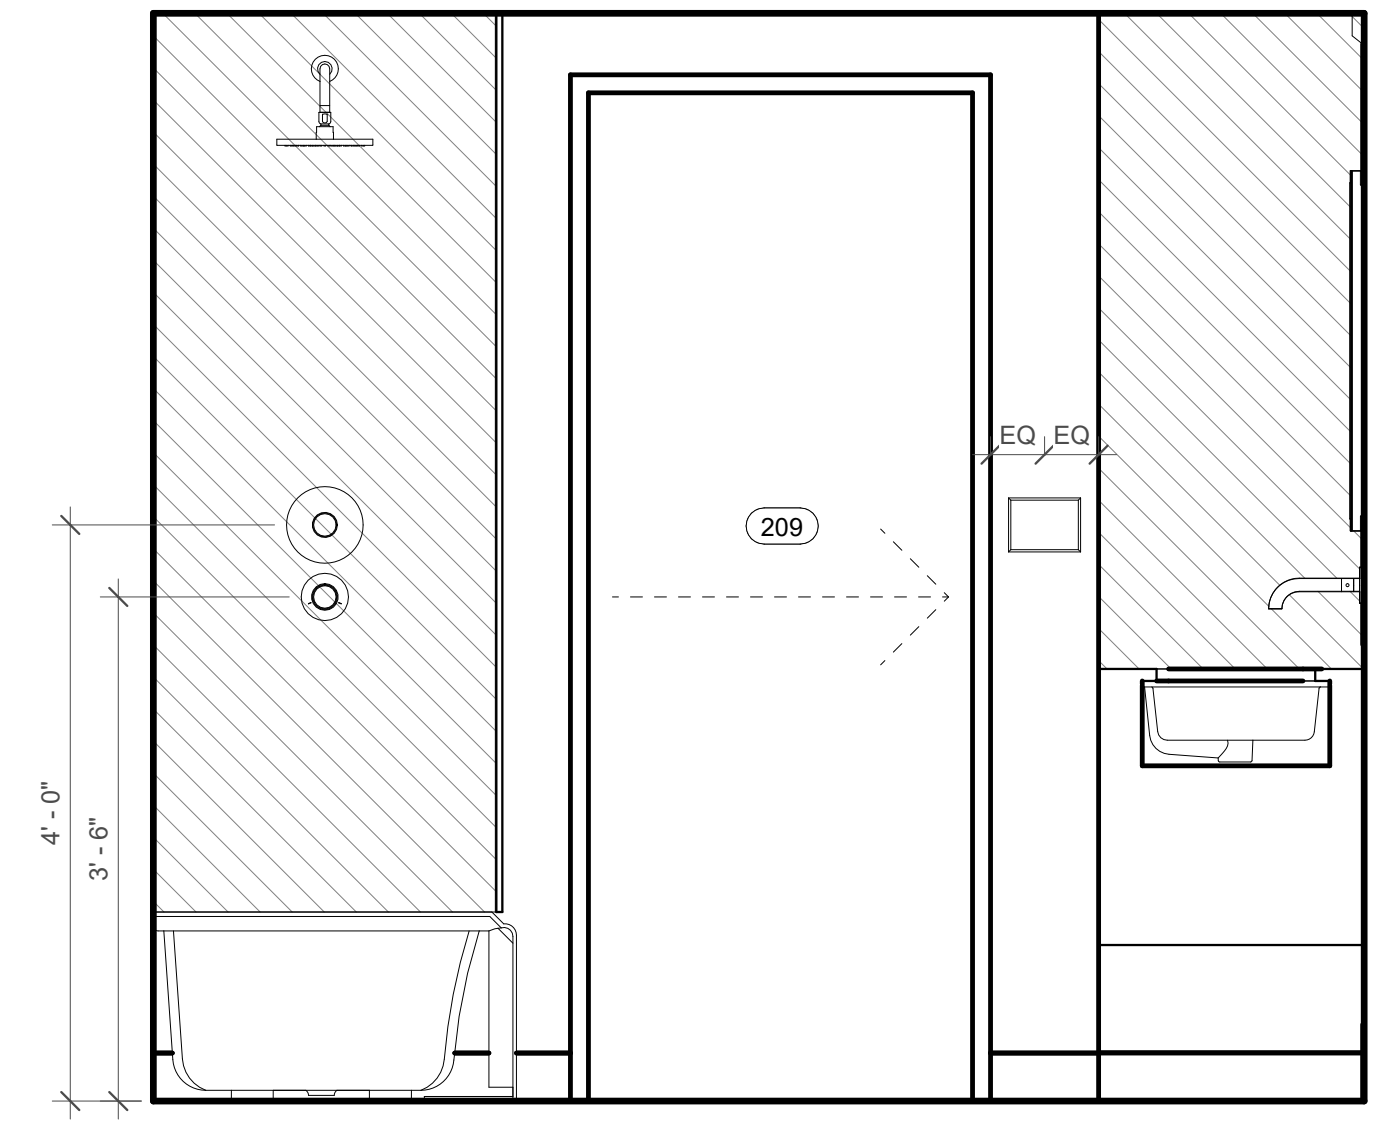


5 209 GUEST BATH - SOUTH ELEVATION
 3/4" = 1'-0"

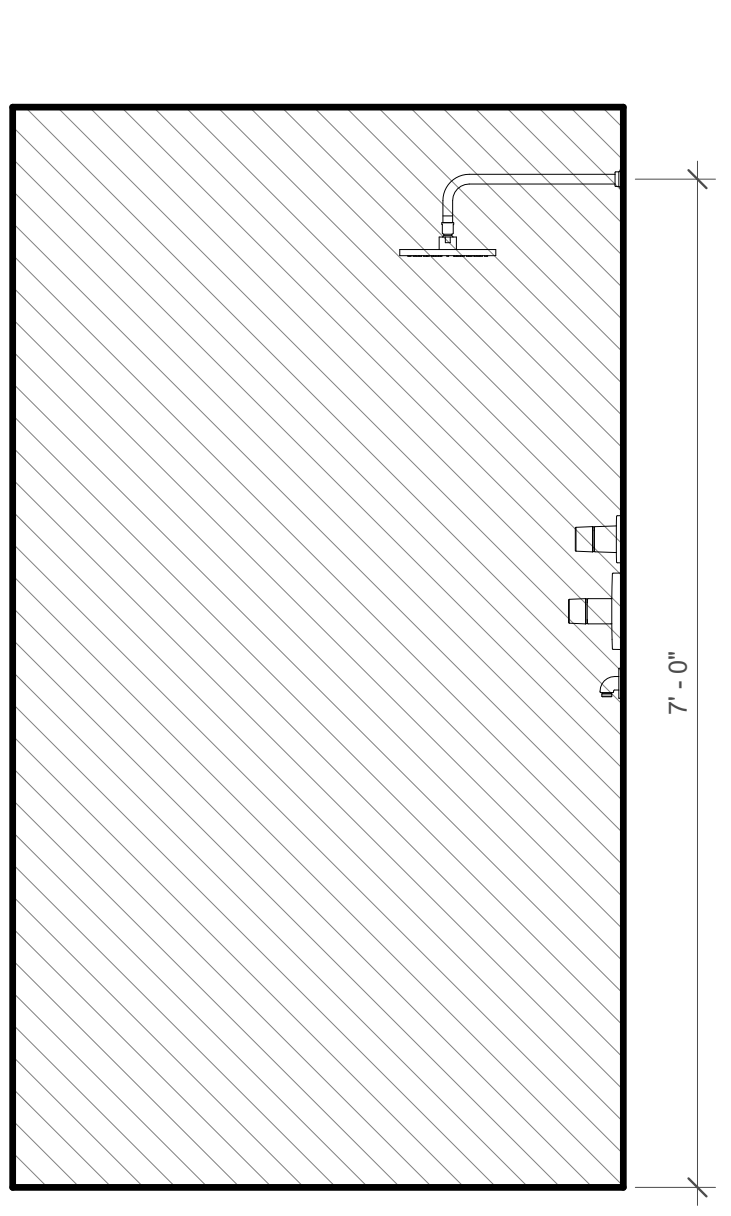

6 210 SHOWER - WEST
 3/4" = 1'-0"

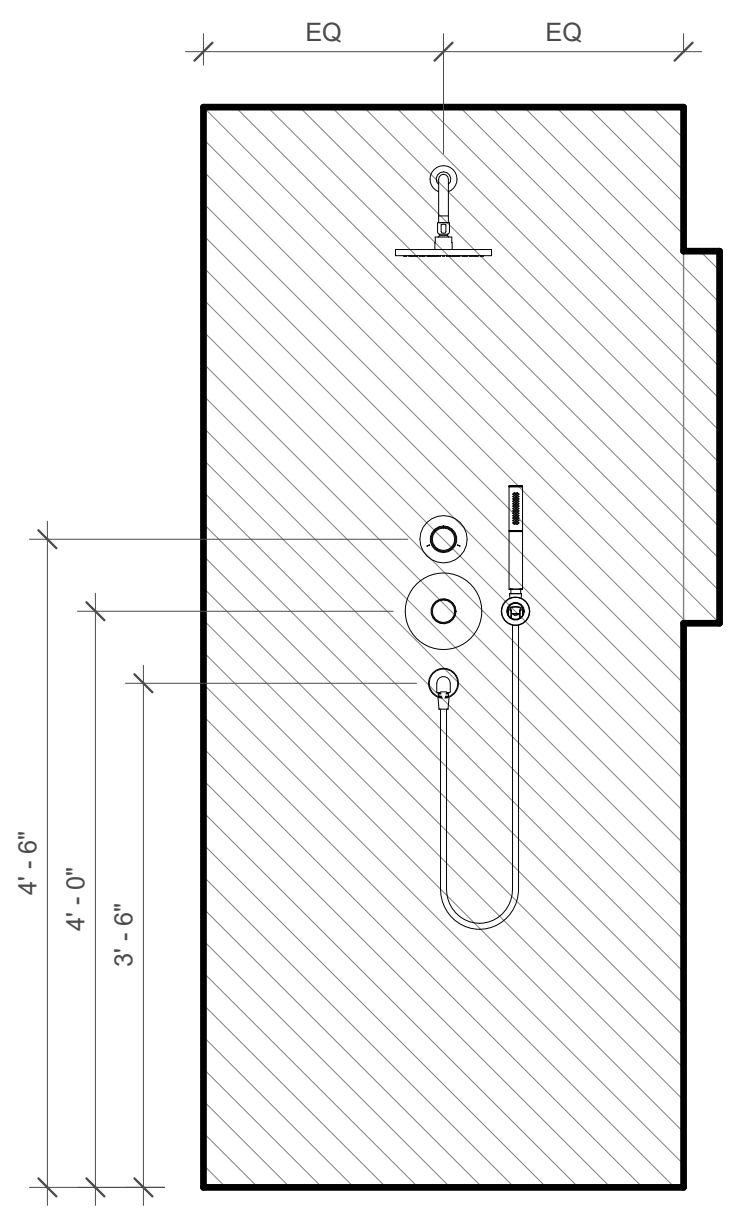

7 210 SHOWER - NORTH
 3/4" = 1'-0"

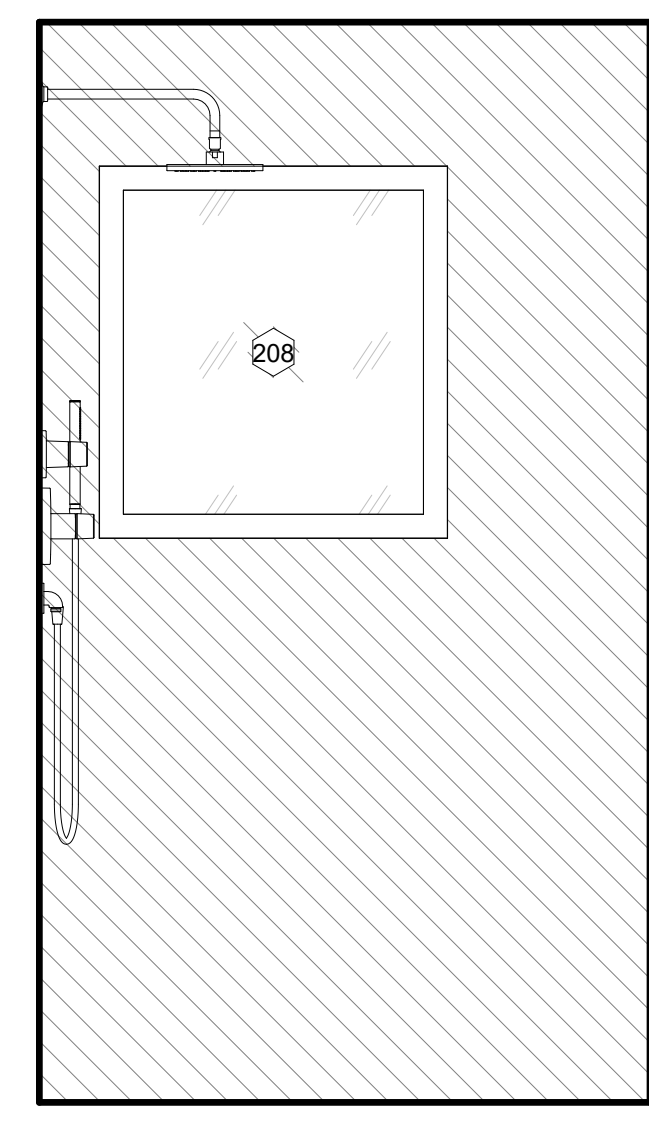


8 210 SHOWER - EAST
 3/4" = 1'-0"

REVISION HISTORY		
NO.	DESCRIPTION	DATE


PERMIT REVISION	
DATE:	AUG 18, 2023
SCALE:	3/4" = 1'-0"
DRAWN BY:	CJ
CHECKED BY:	Checker

SHEET TITLE PROJECT #: 40035


ENLARGED INTERIOR PLANS & ELEVATIONS

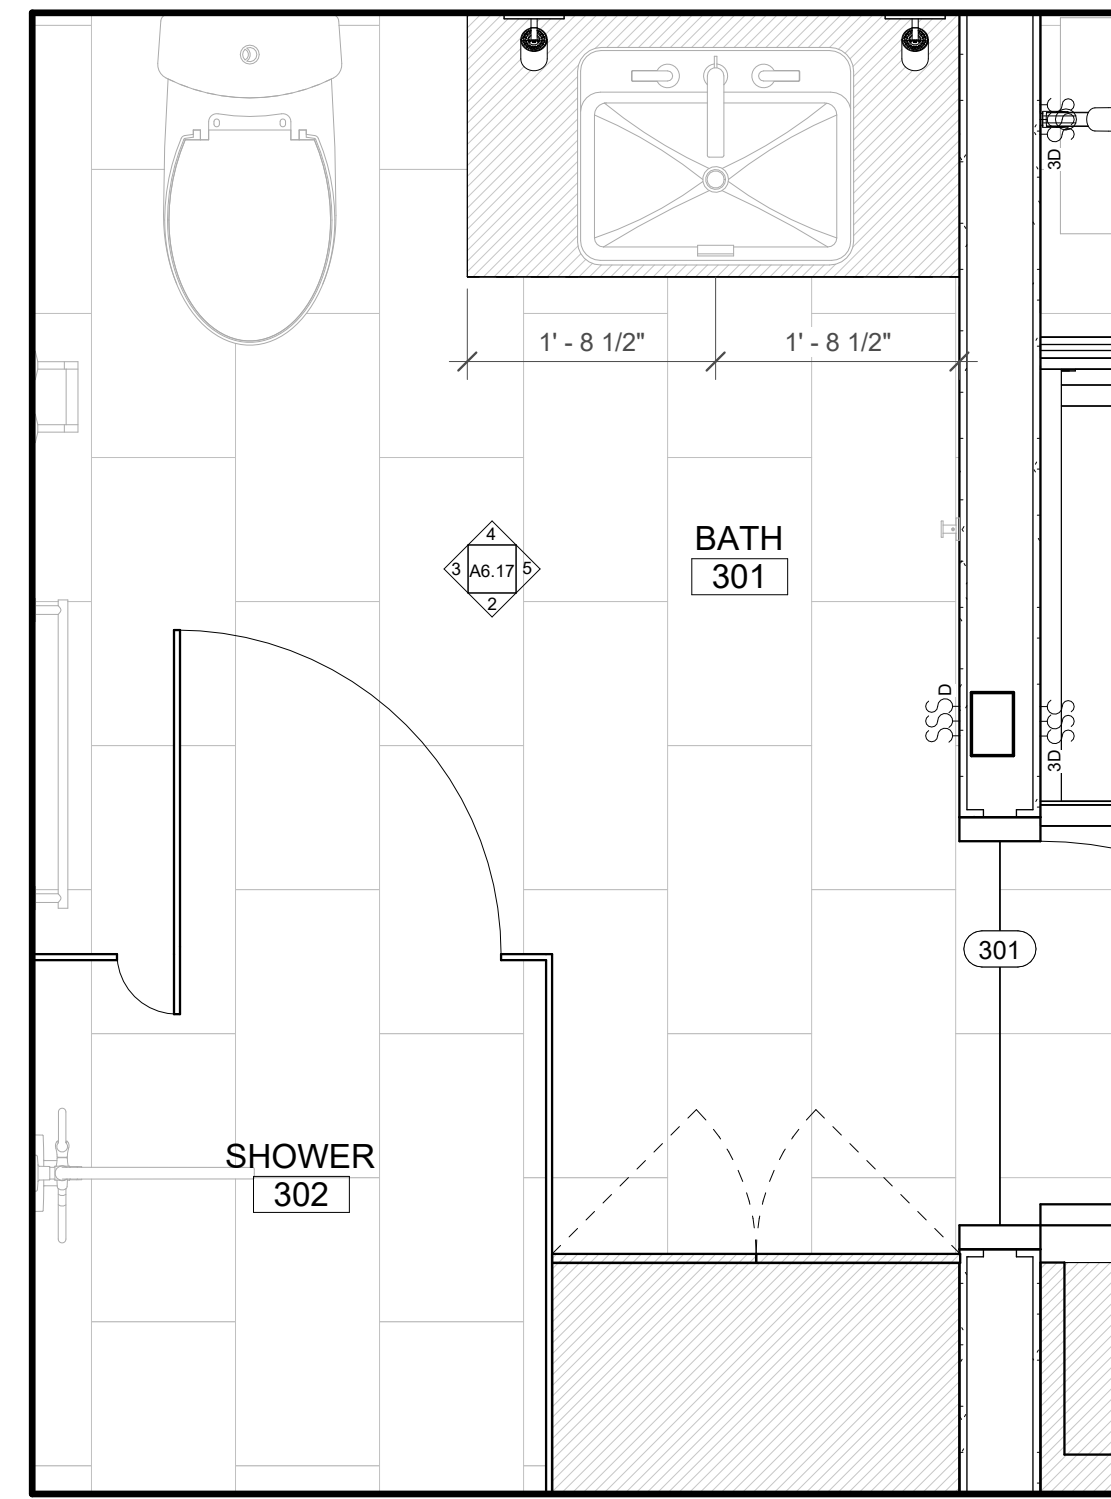


1 301 BATH
3/4" = 1'-0"

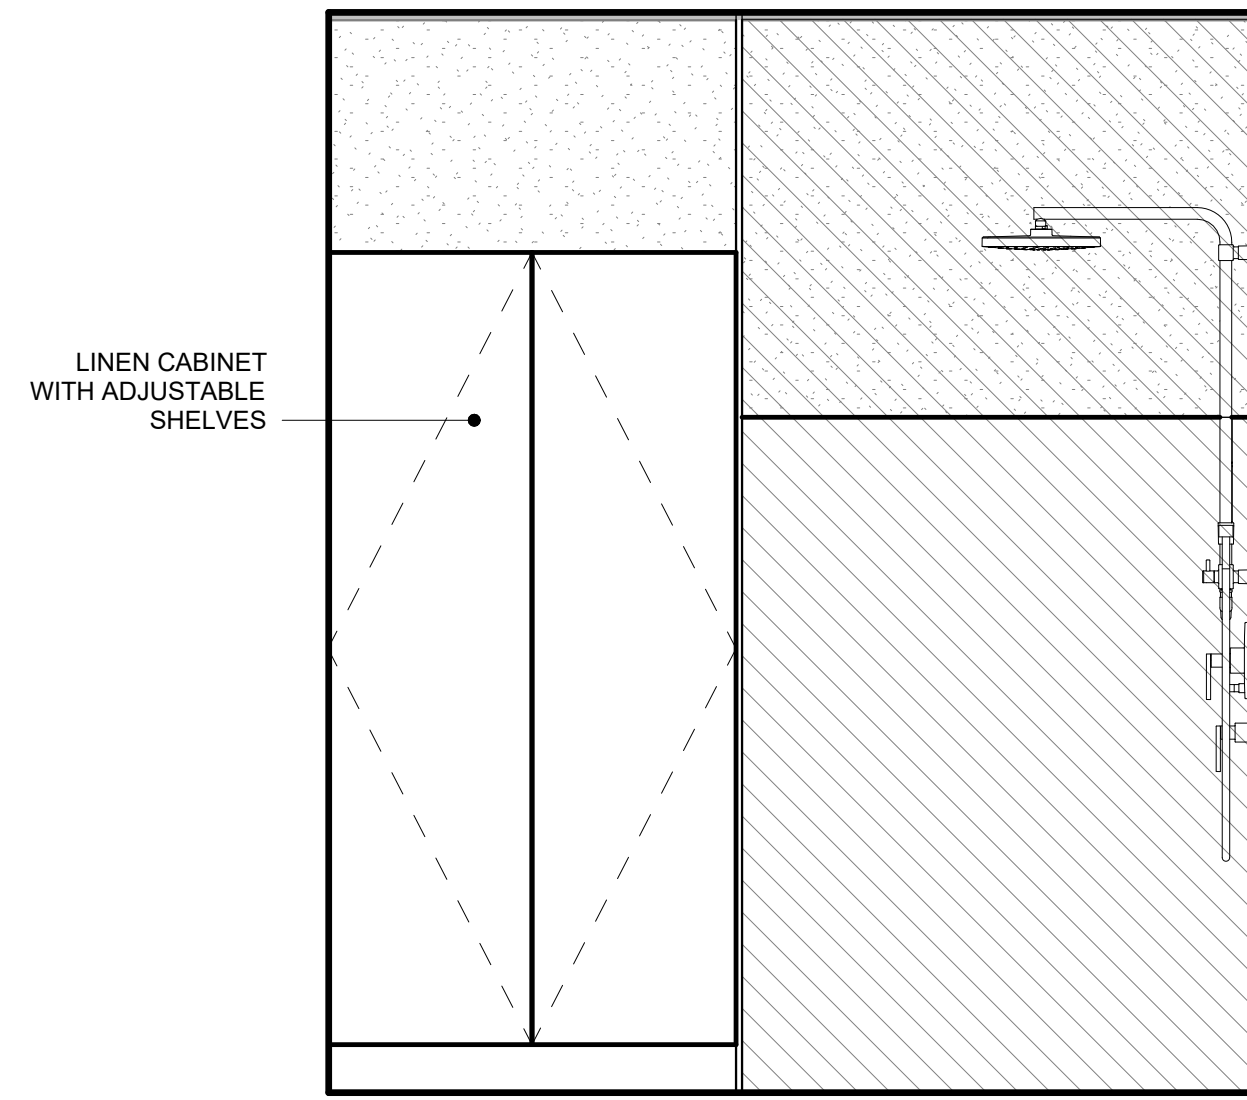


2 301 BATH - SOUTH ELEVATION
3/4" = 1'-0"

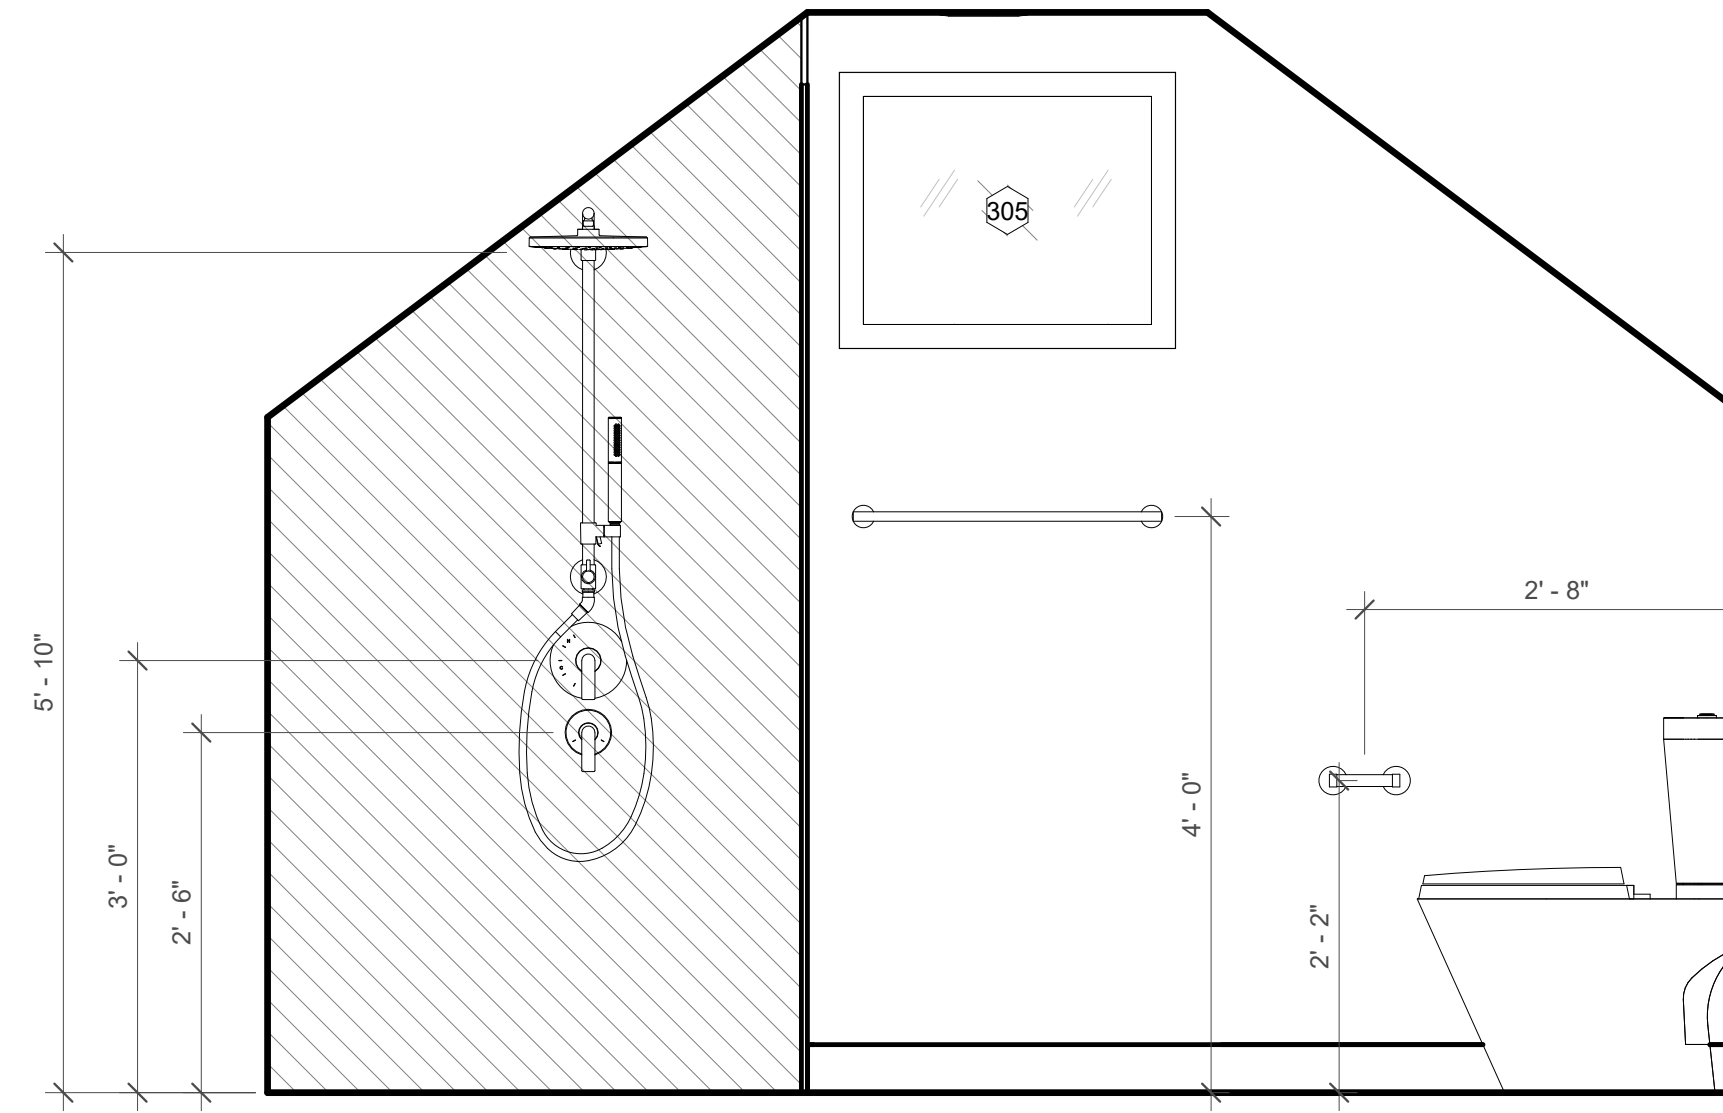


3 301 BATH - WEST ELEVATION
3/4" = 1'-0"

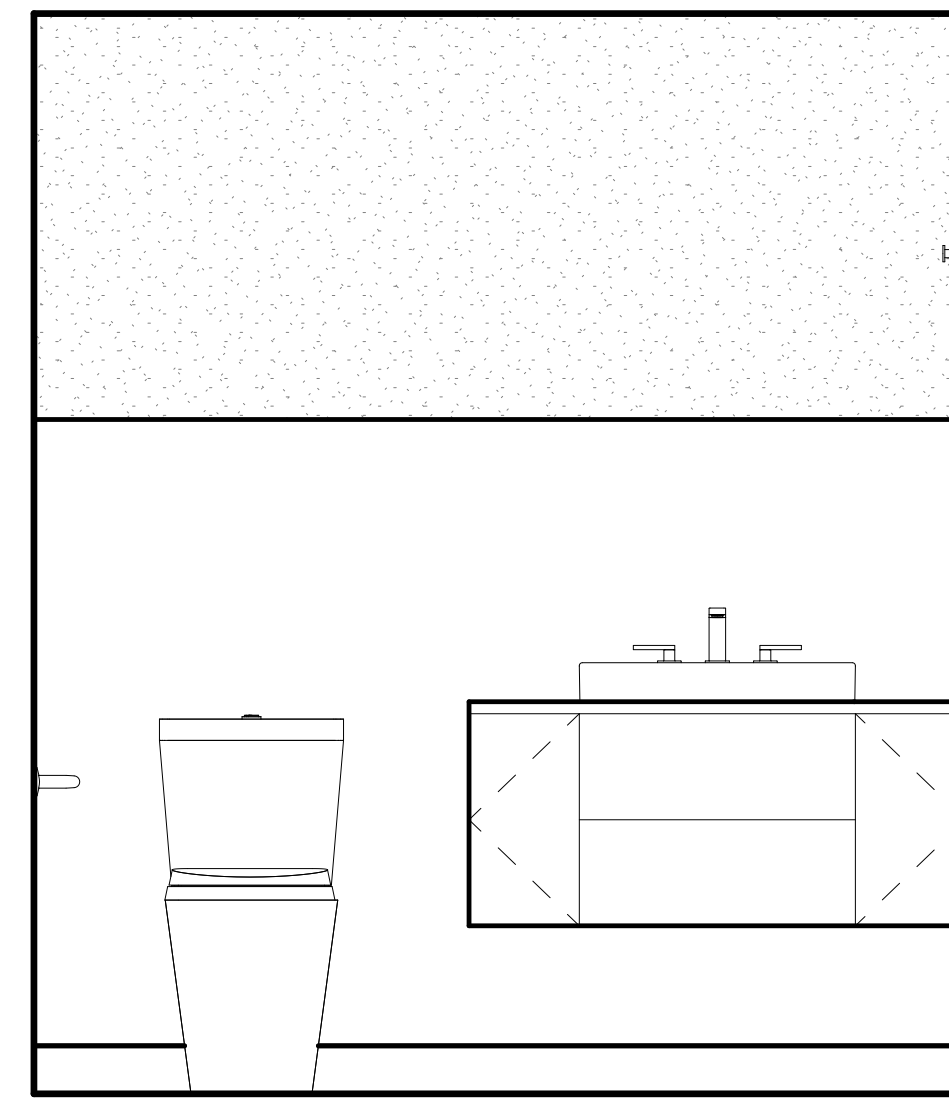

4 301 BATH - NORTH ELEVATION
3/4" = 1'-0"

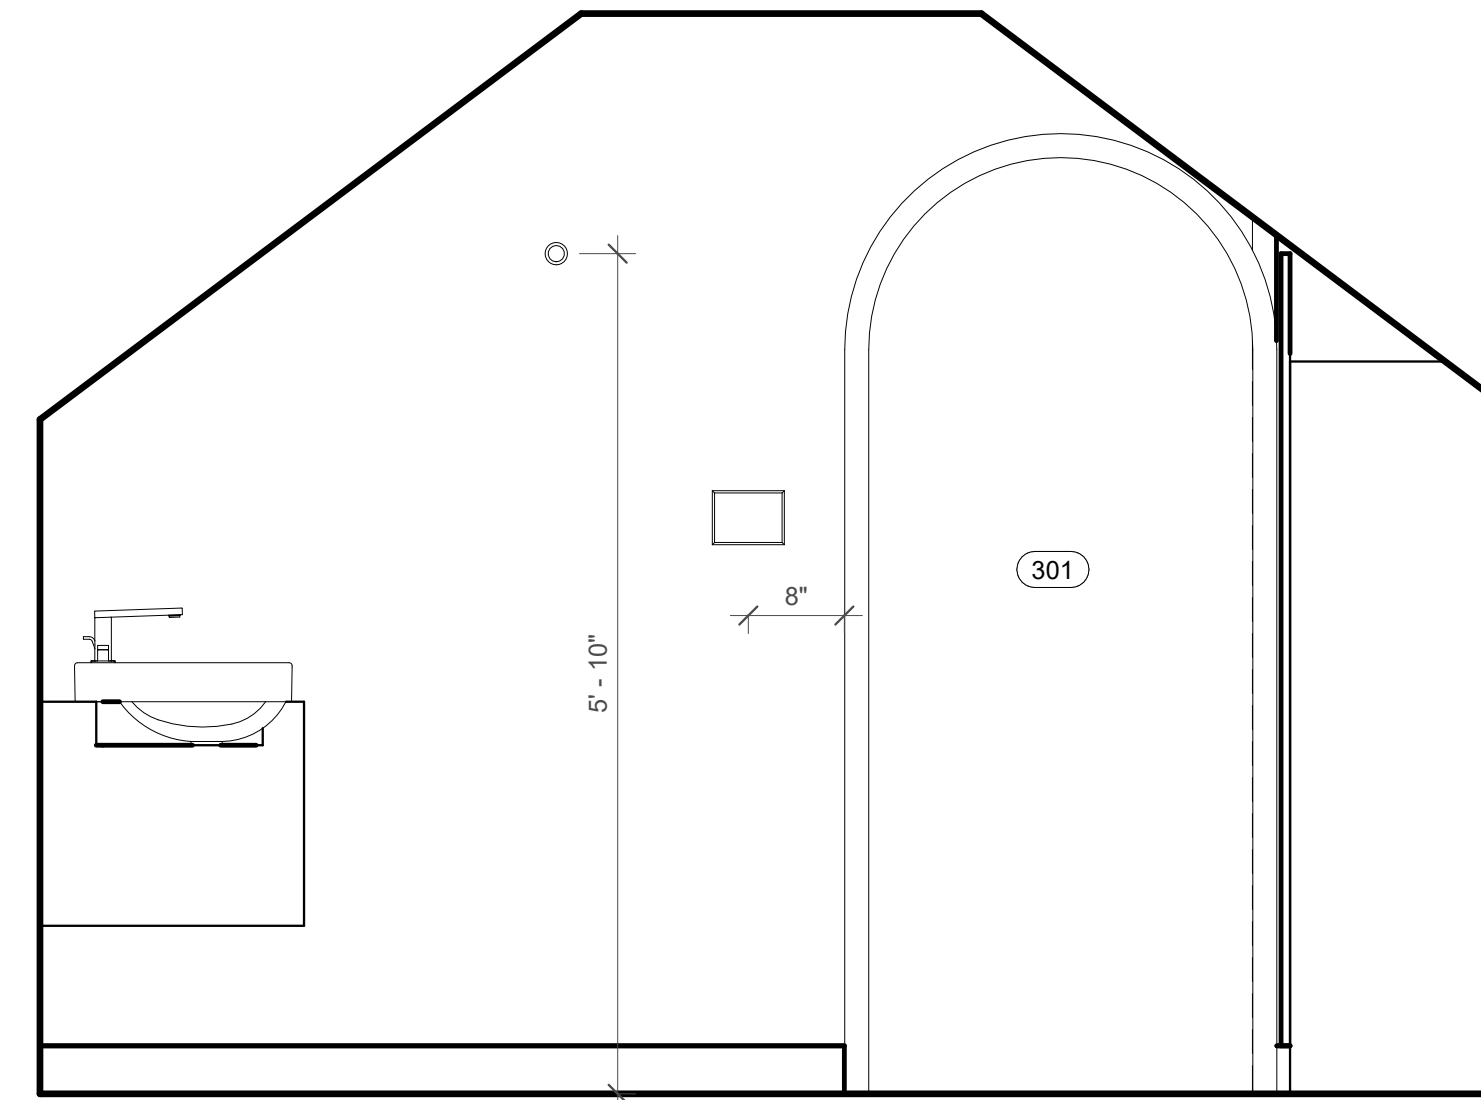

5 301 BATH - EAST ELEVATION
3/4" = 1'-0"

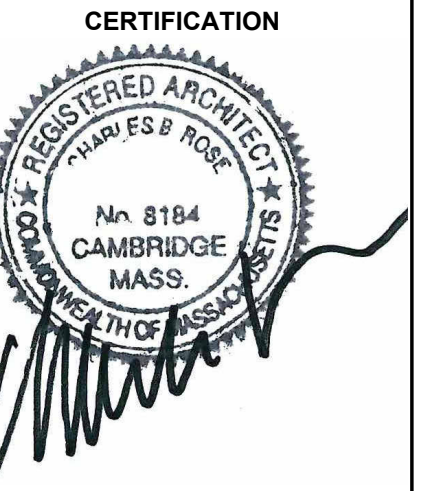



REVISION HISTORY		
NO.	DESCRIPTION	DATE

PERMIT REVISION


DATE:	AUG 18, 2023
SCALE:	3/4" = 1'-0"
DRAWN BY:	CJ
CHECKED BY:	Checker

SHEET TITLE	PROJECT #
-------------	-----------


ENLARGED
INTERIOR PLANS &
ELEVATIONS

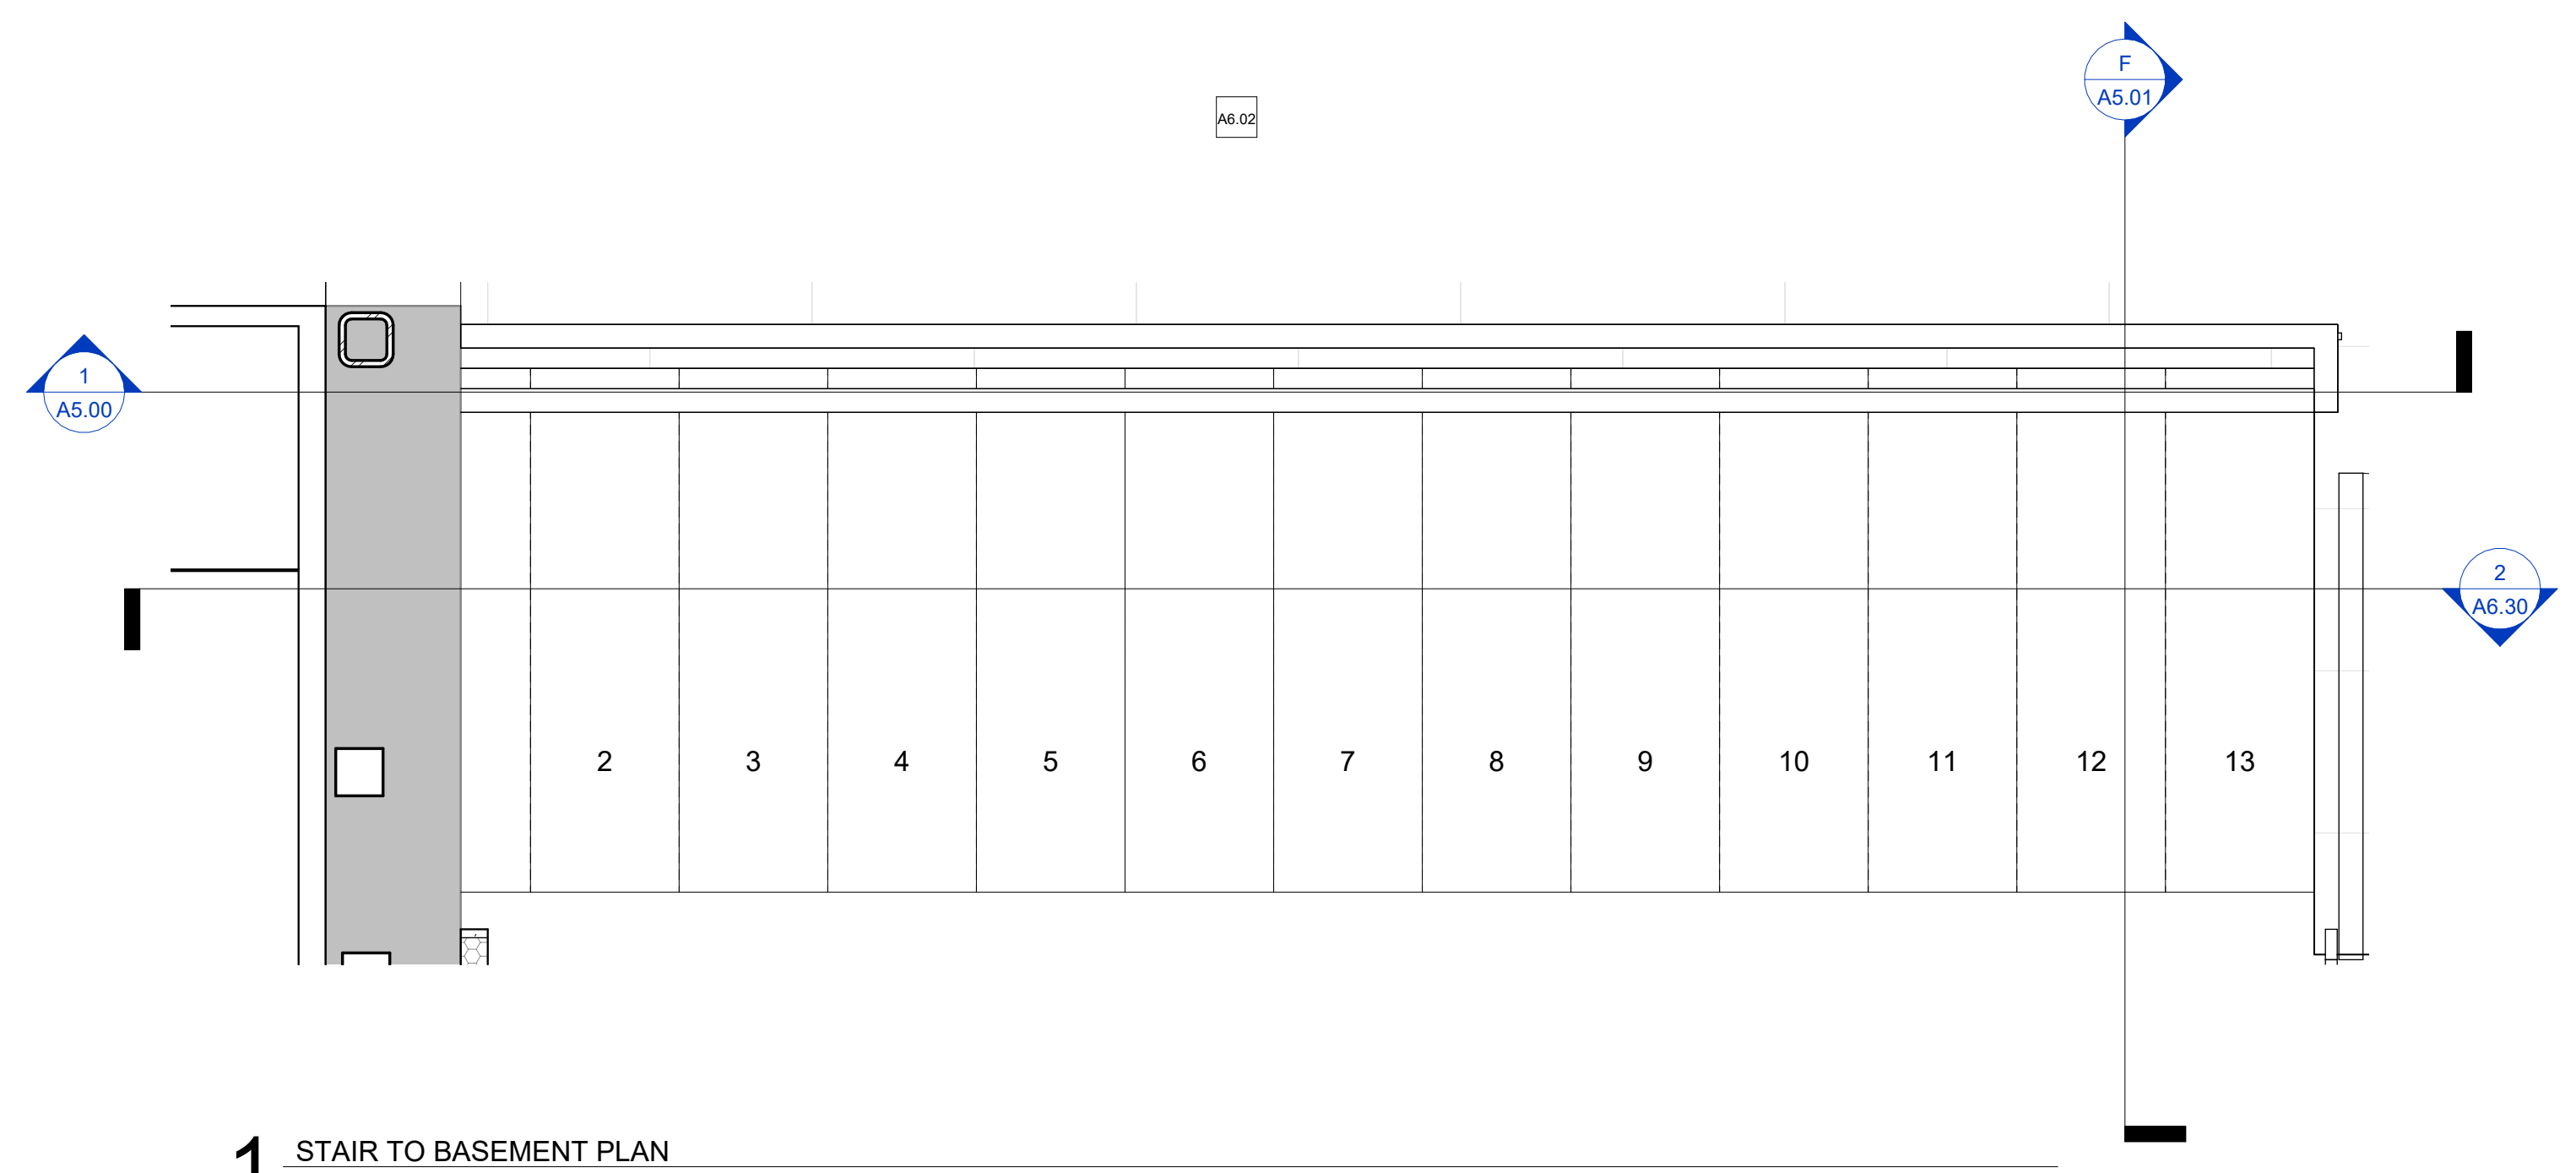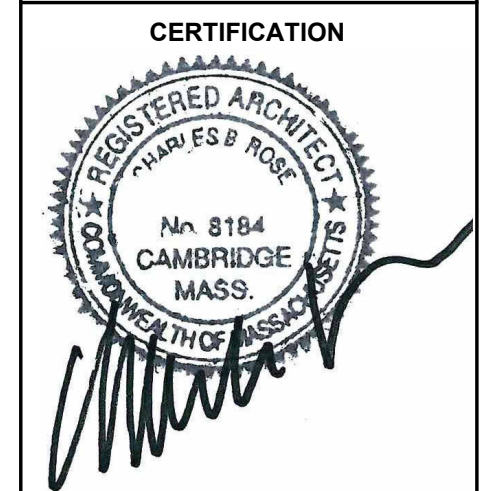


1 STAIR TO BASEMENT PLAN
 1" = 1'-0"

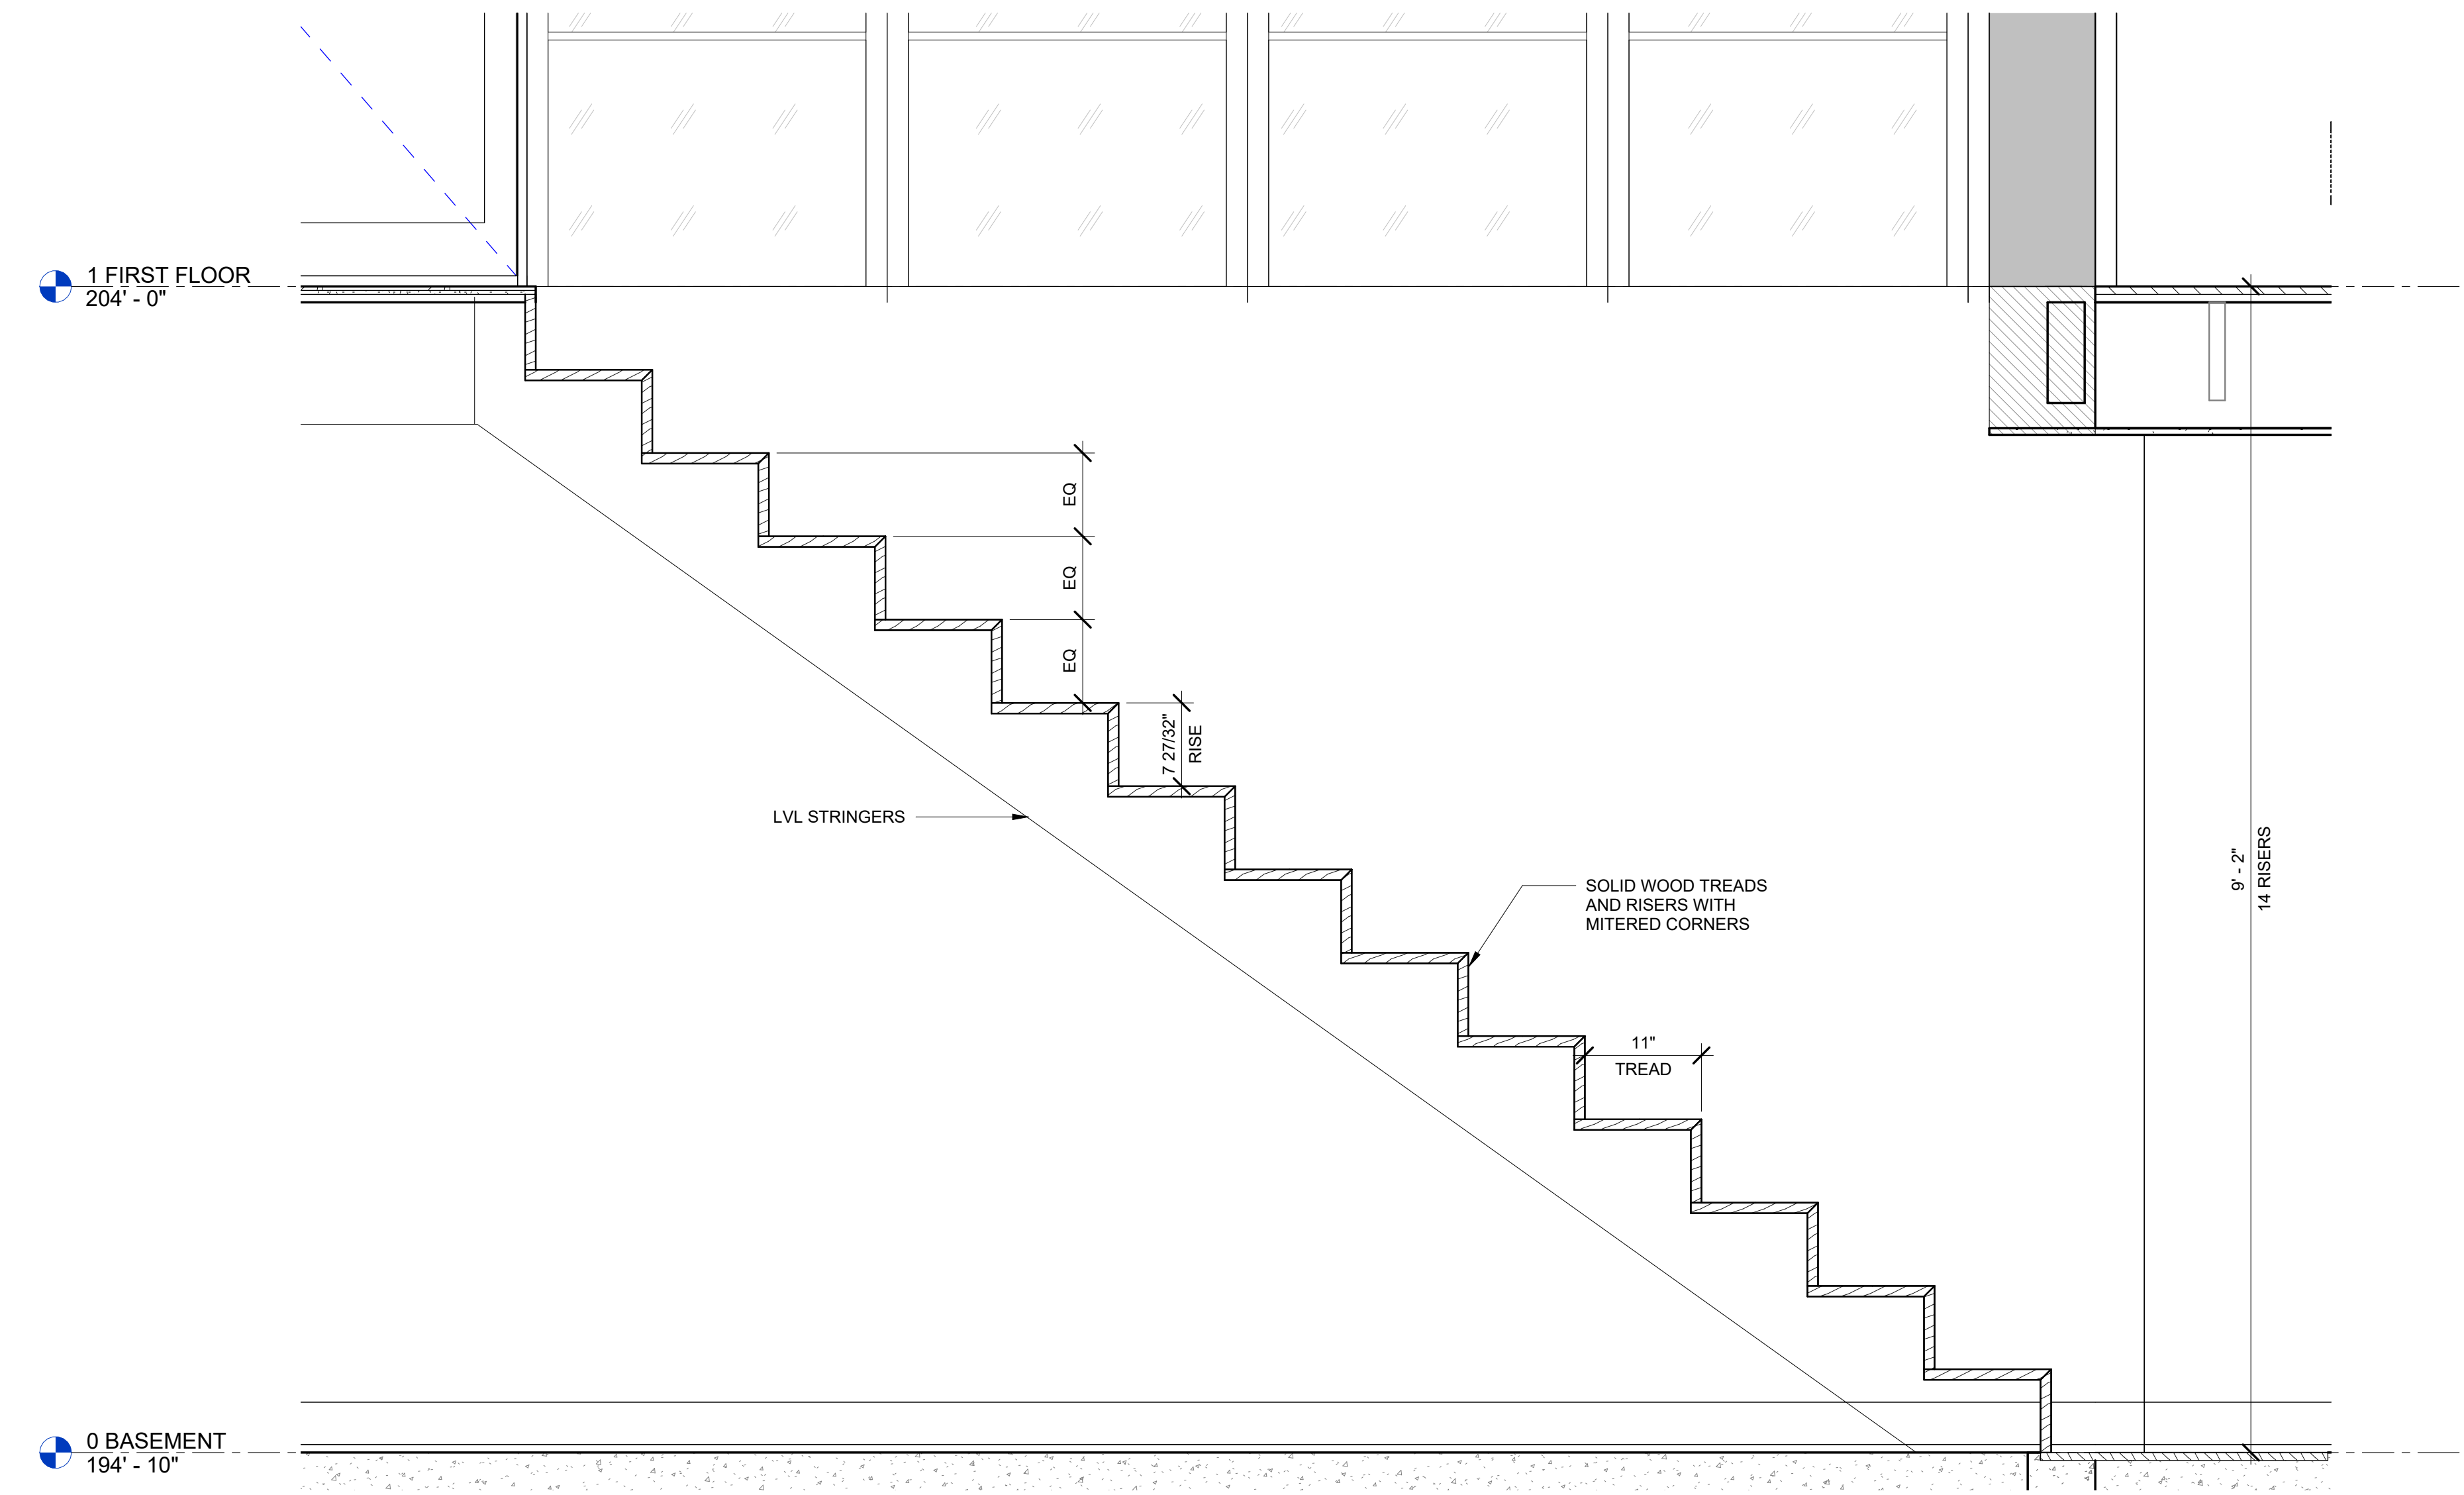


2 STAIR TO BASEMENT - SECTION FACING SOUTH
 1" = 1'-0"

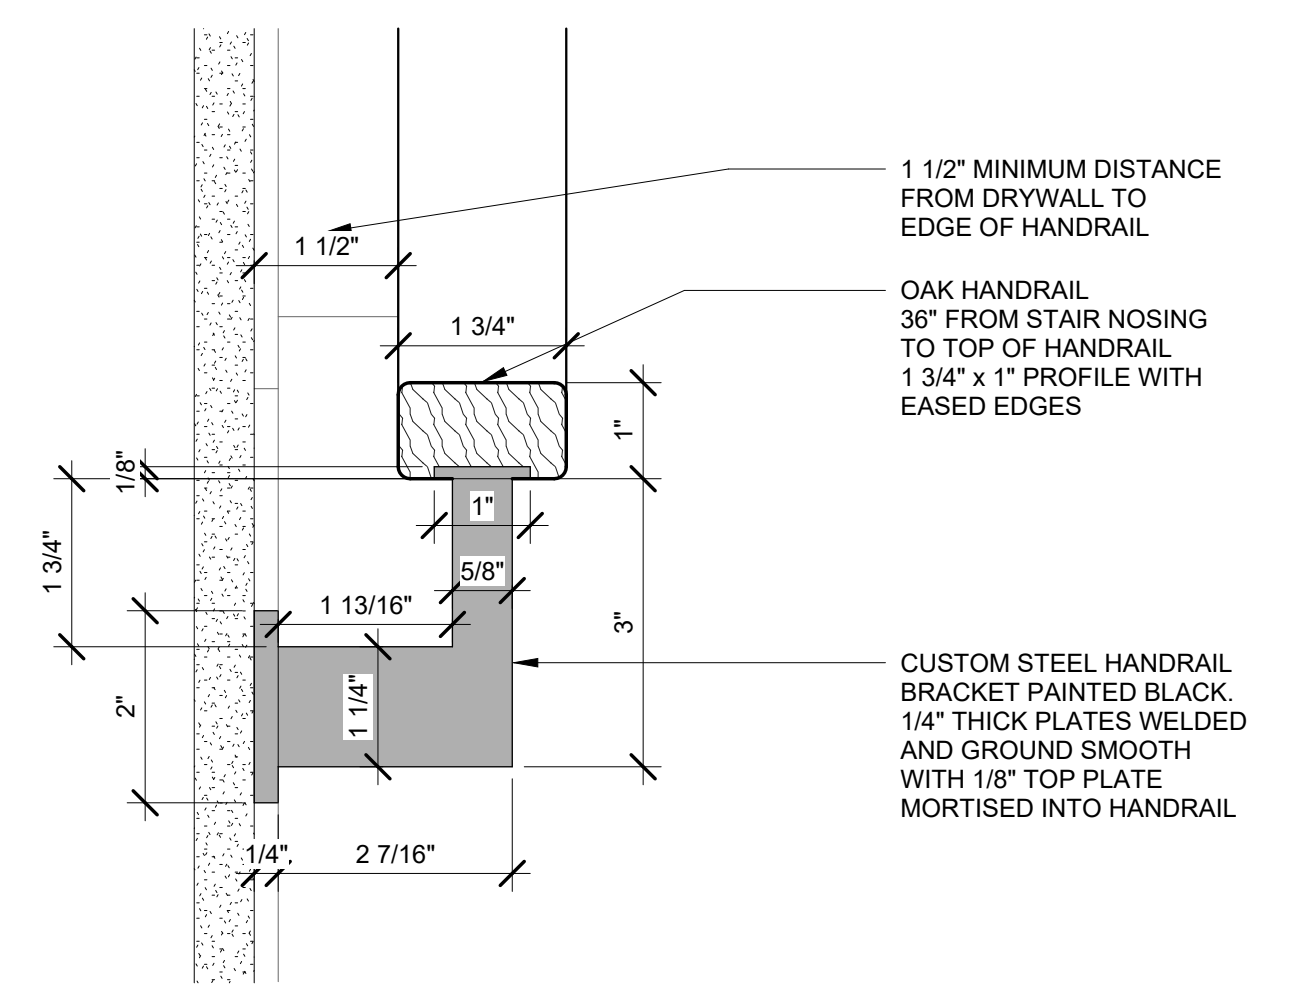


8 OAK HANDRAIL WITH STEEL BRACKET - SECTION
 6" = 1'-0"

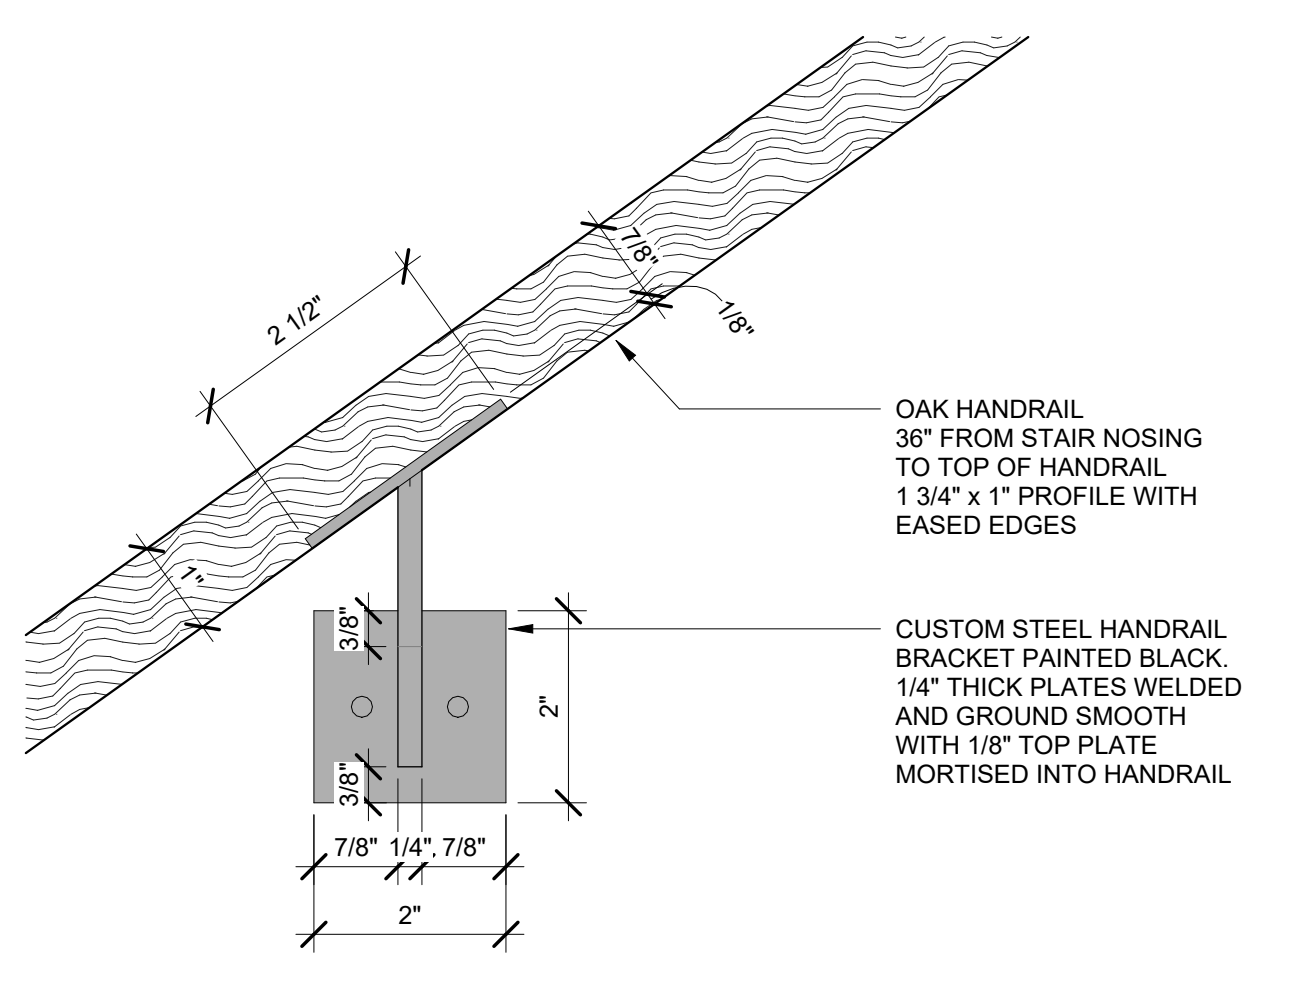


9 OAK HANDRAIL WITH STEEL BRACKET - ELEVATION
 6" = 1'-0"

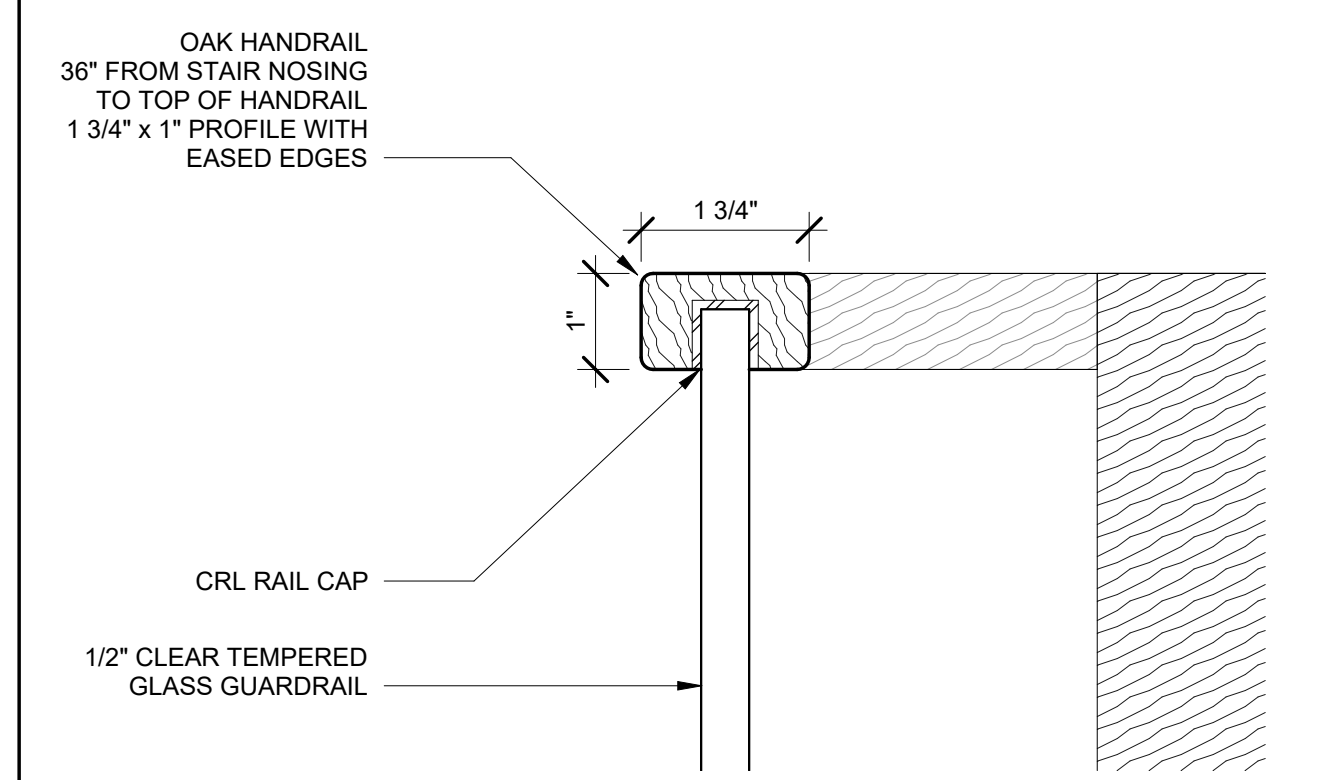


6 TRANSVERSE SECTION F - Callout 1
 6" = 1'-0"

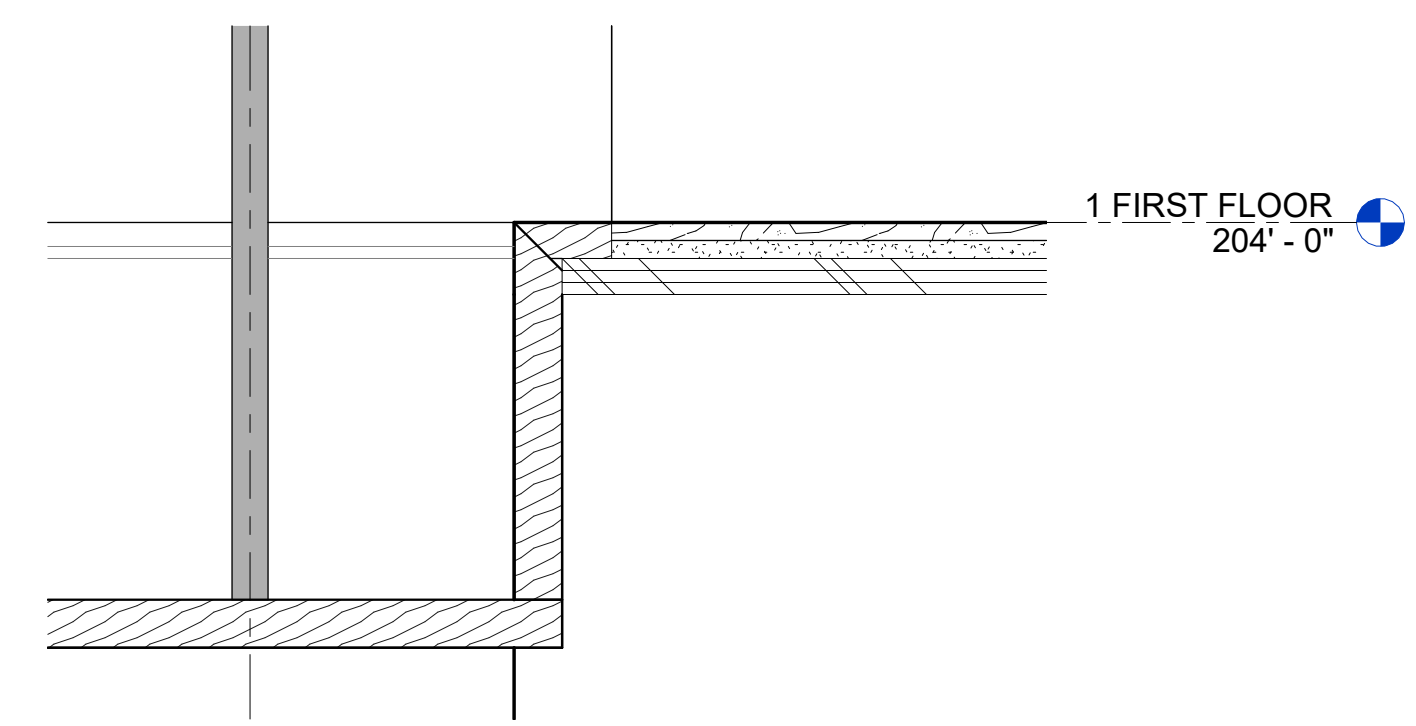

5 Detail 0
 3" = 1'-0"

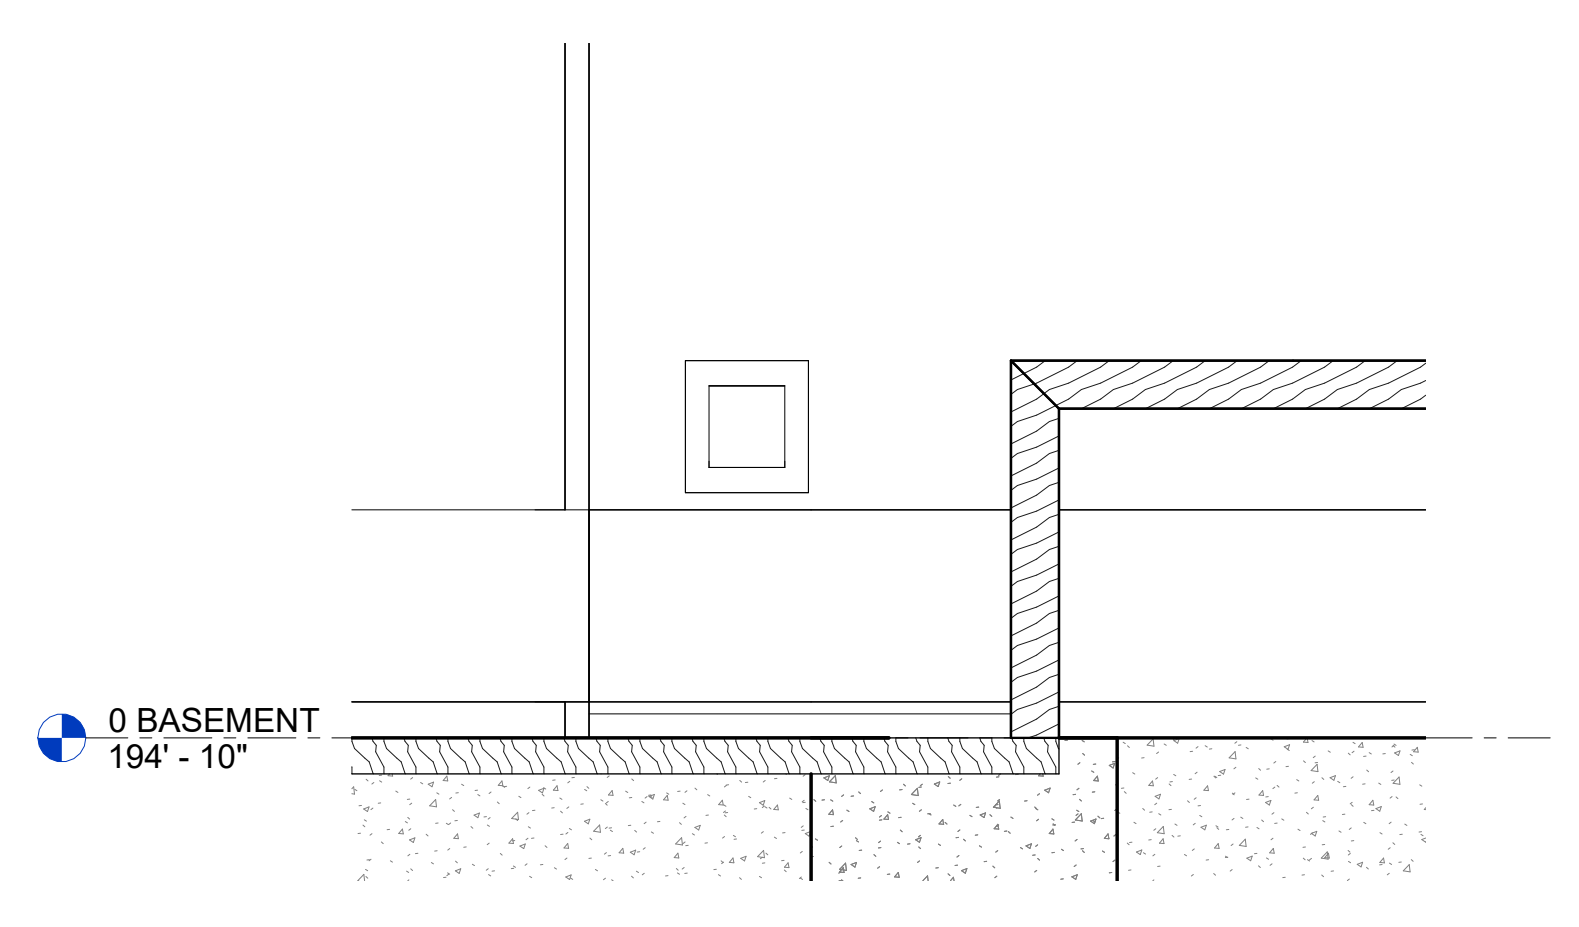



7 Detail 1
 3" = 1'-0"

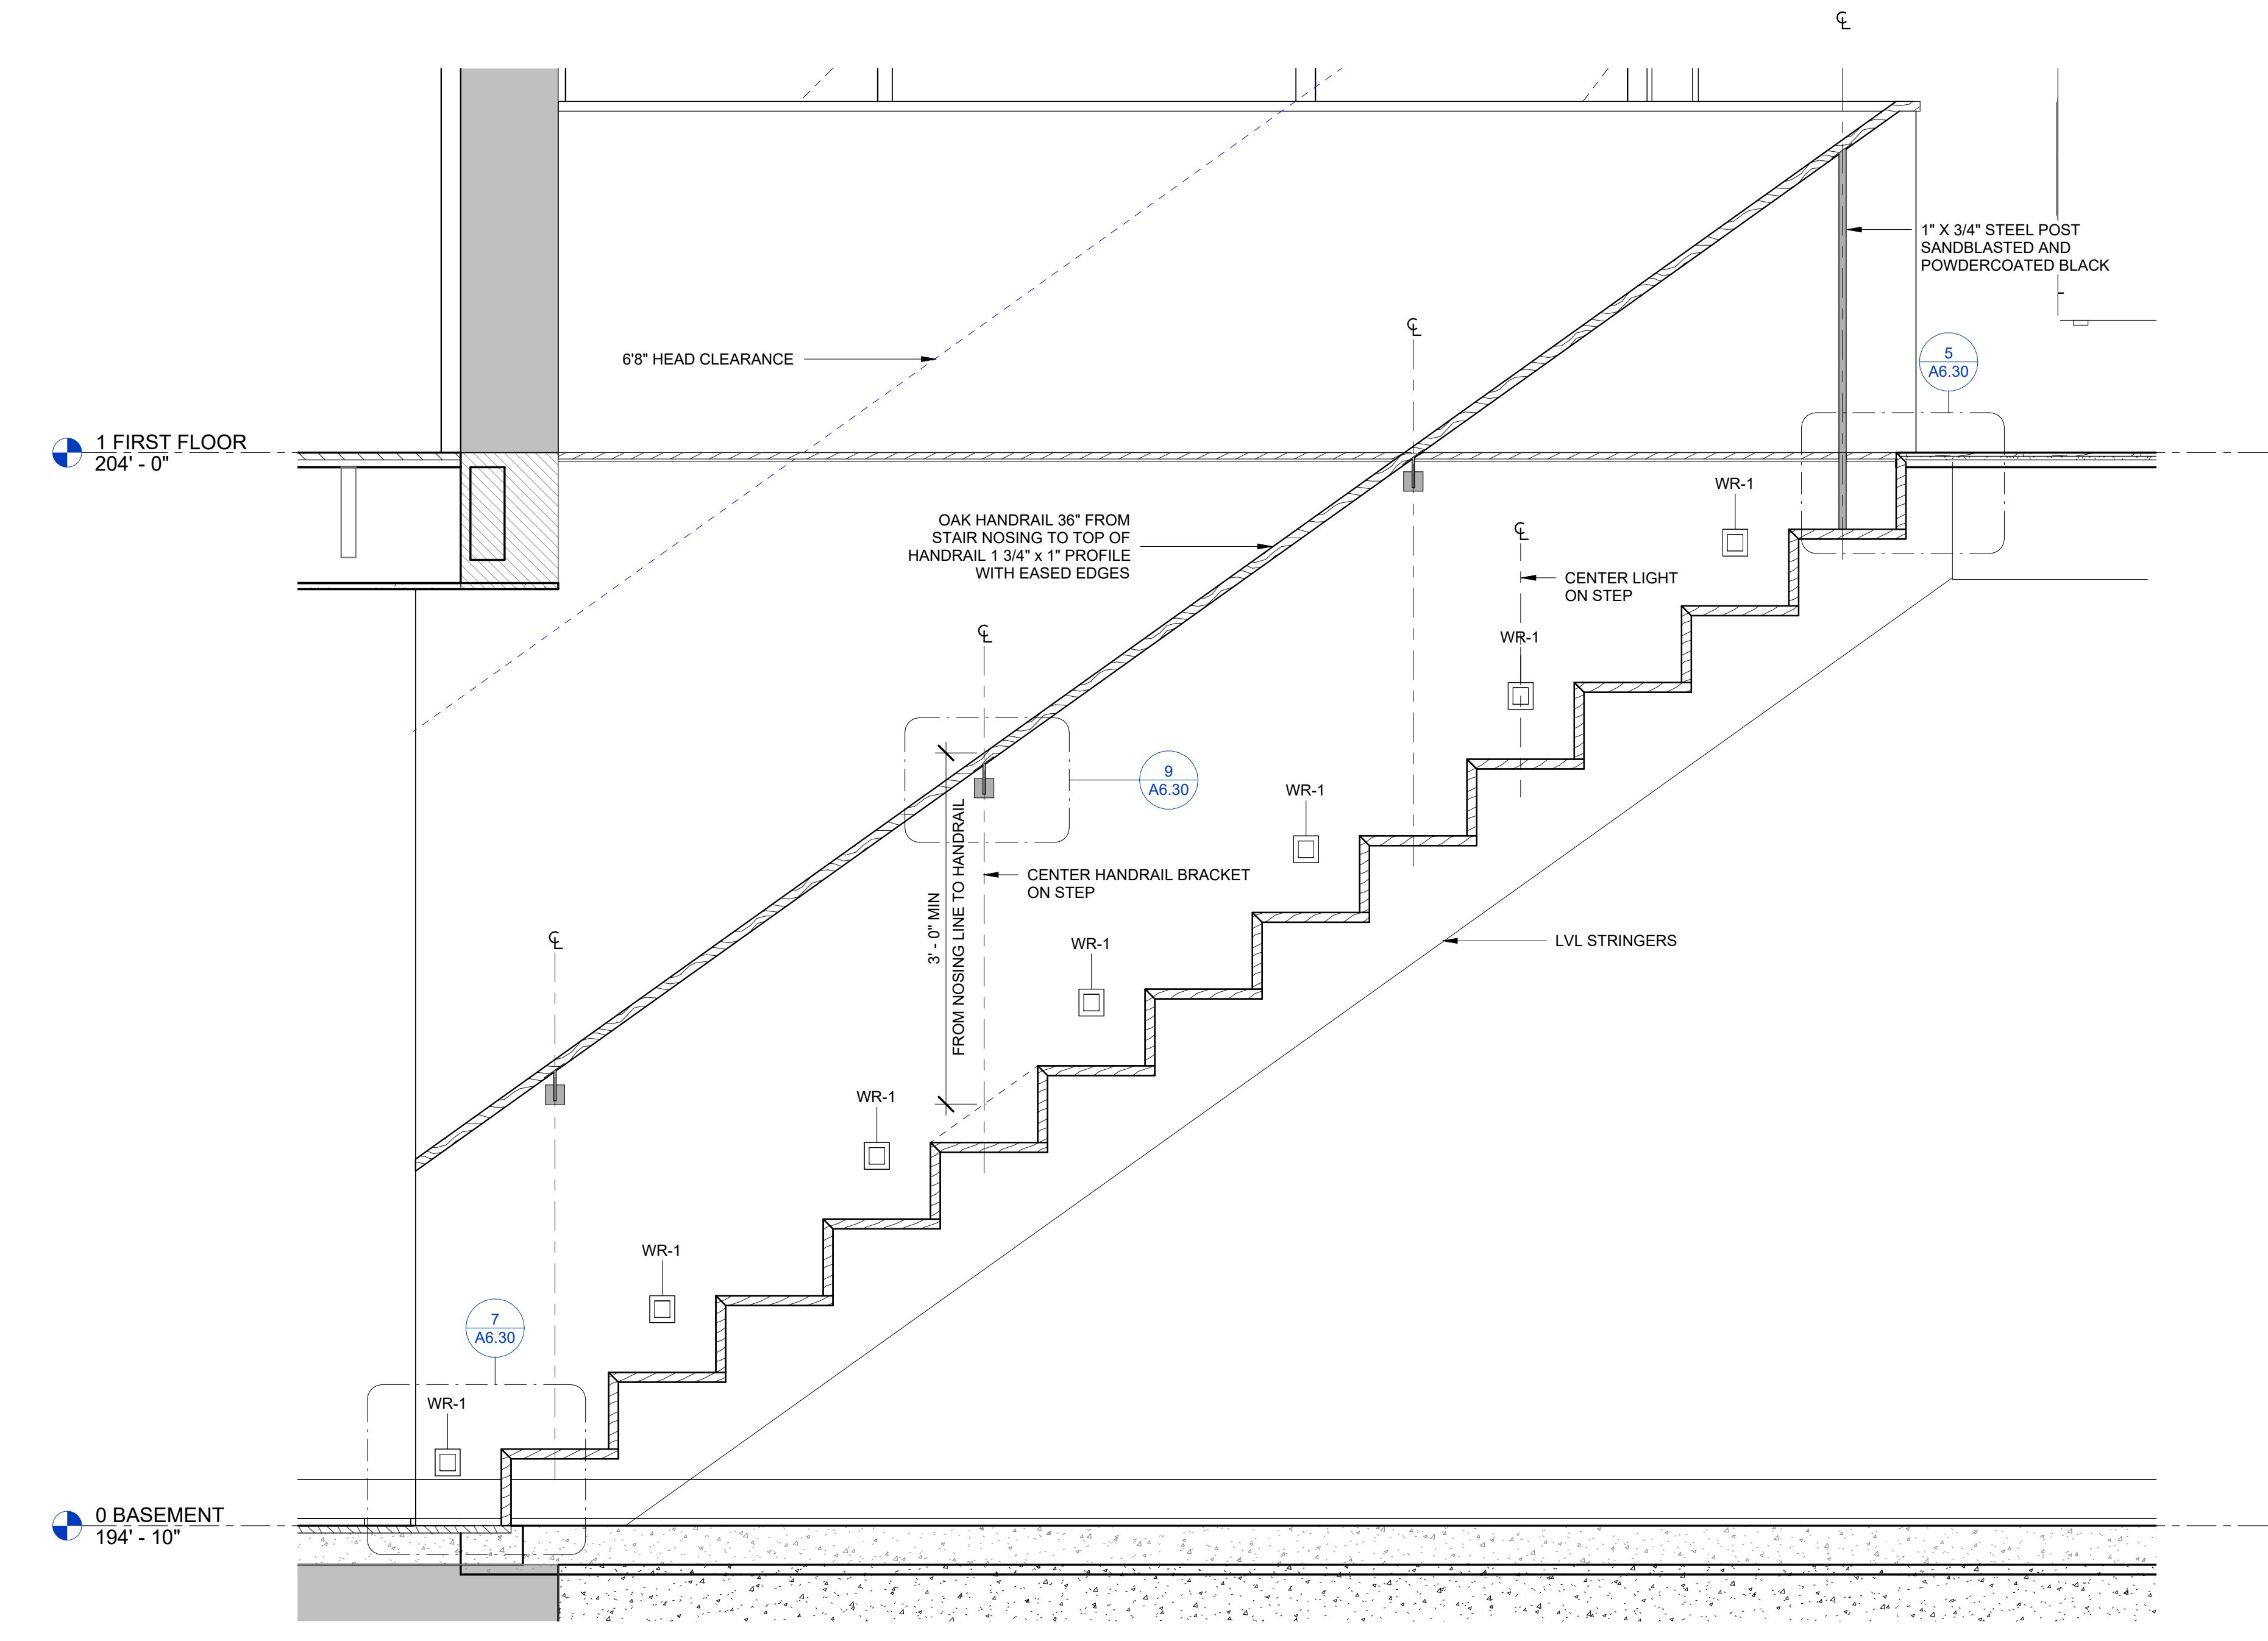


3 STAIR TO BASEMENT - SECTION FACING NORTH
 1" = 1'-0"

REVISION HISTORY		
NO.	DESCRIPTION	DATE


PERMIT REVISION	
DATE	PROJECT #
AUG 18, 2023	40035
SCALE: As indicated	
DRAWN BY: CJ	
CHECKED BY: CR	

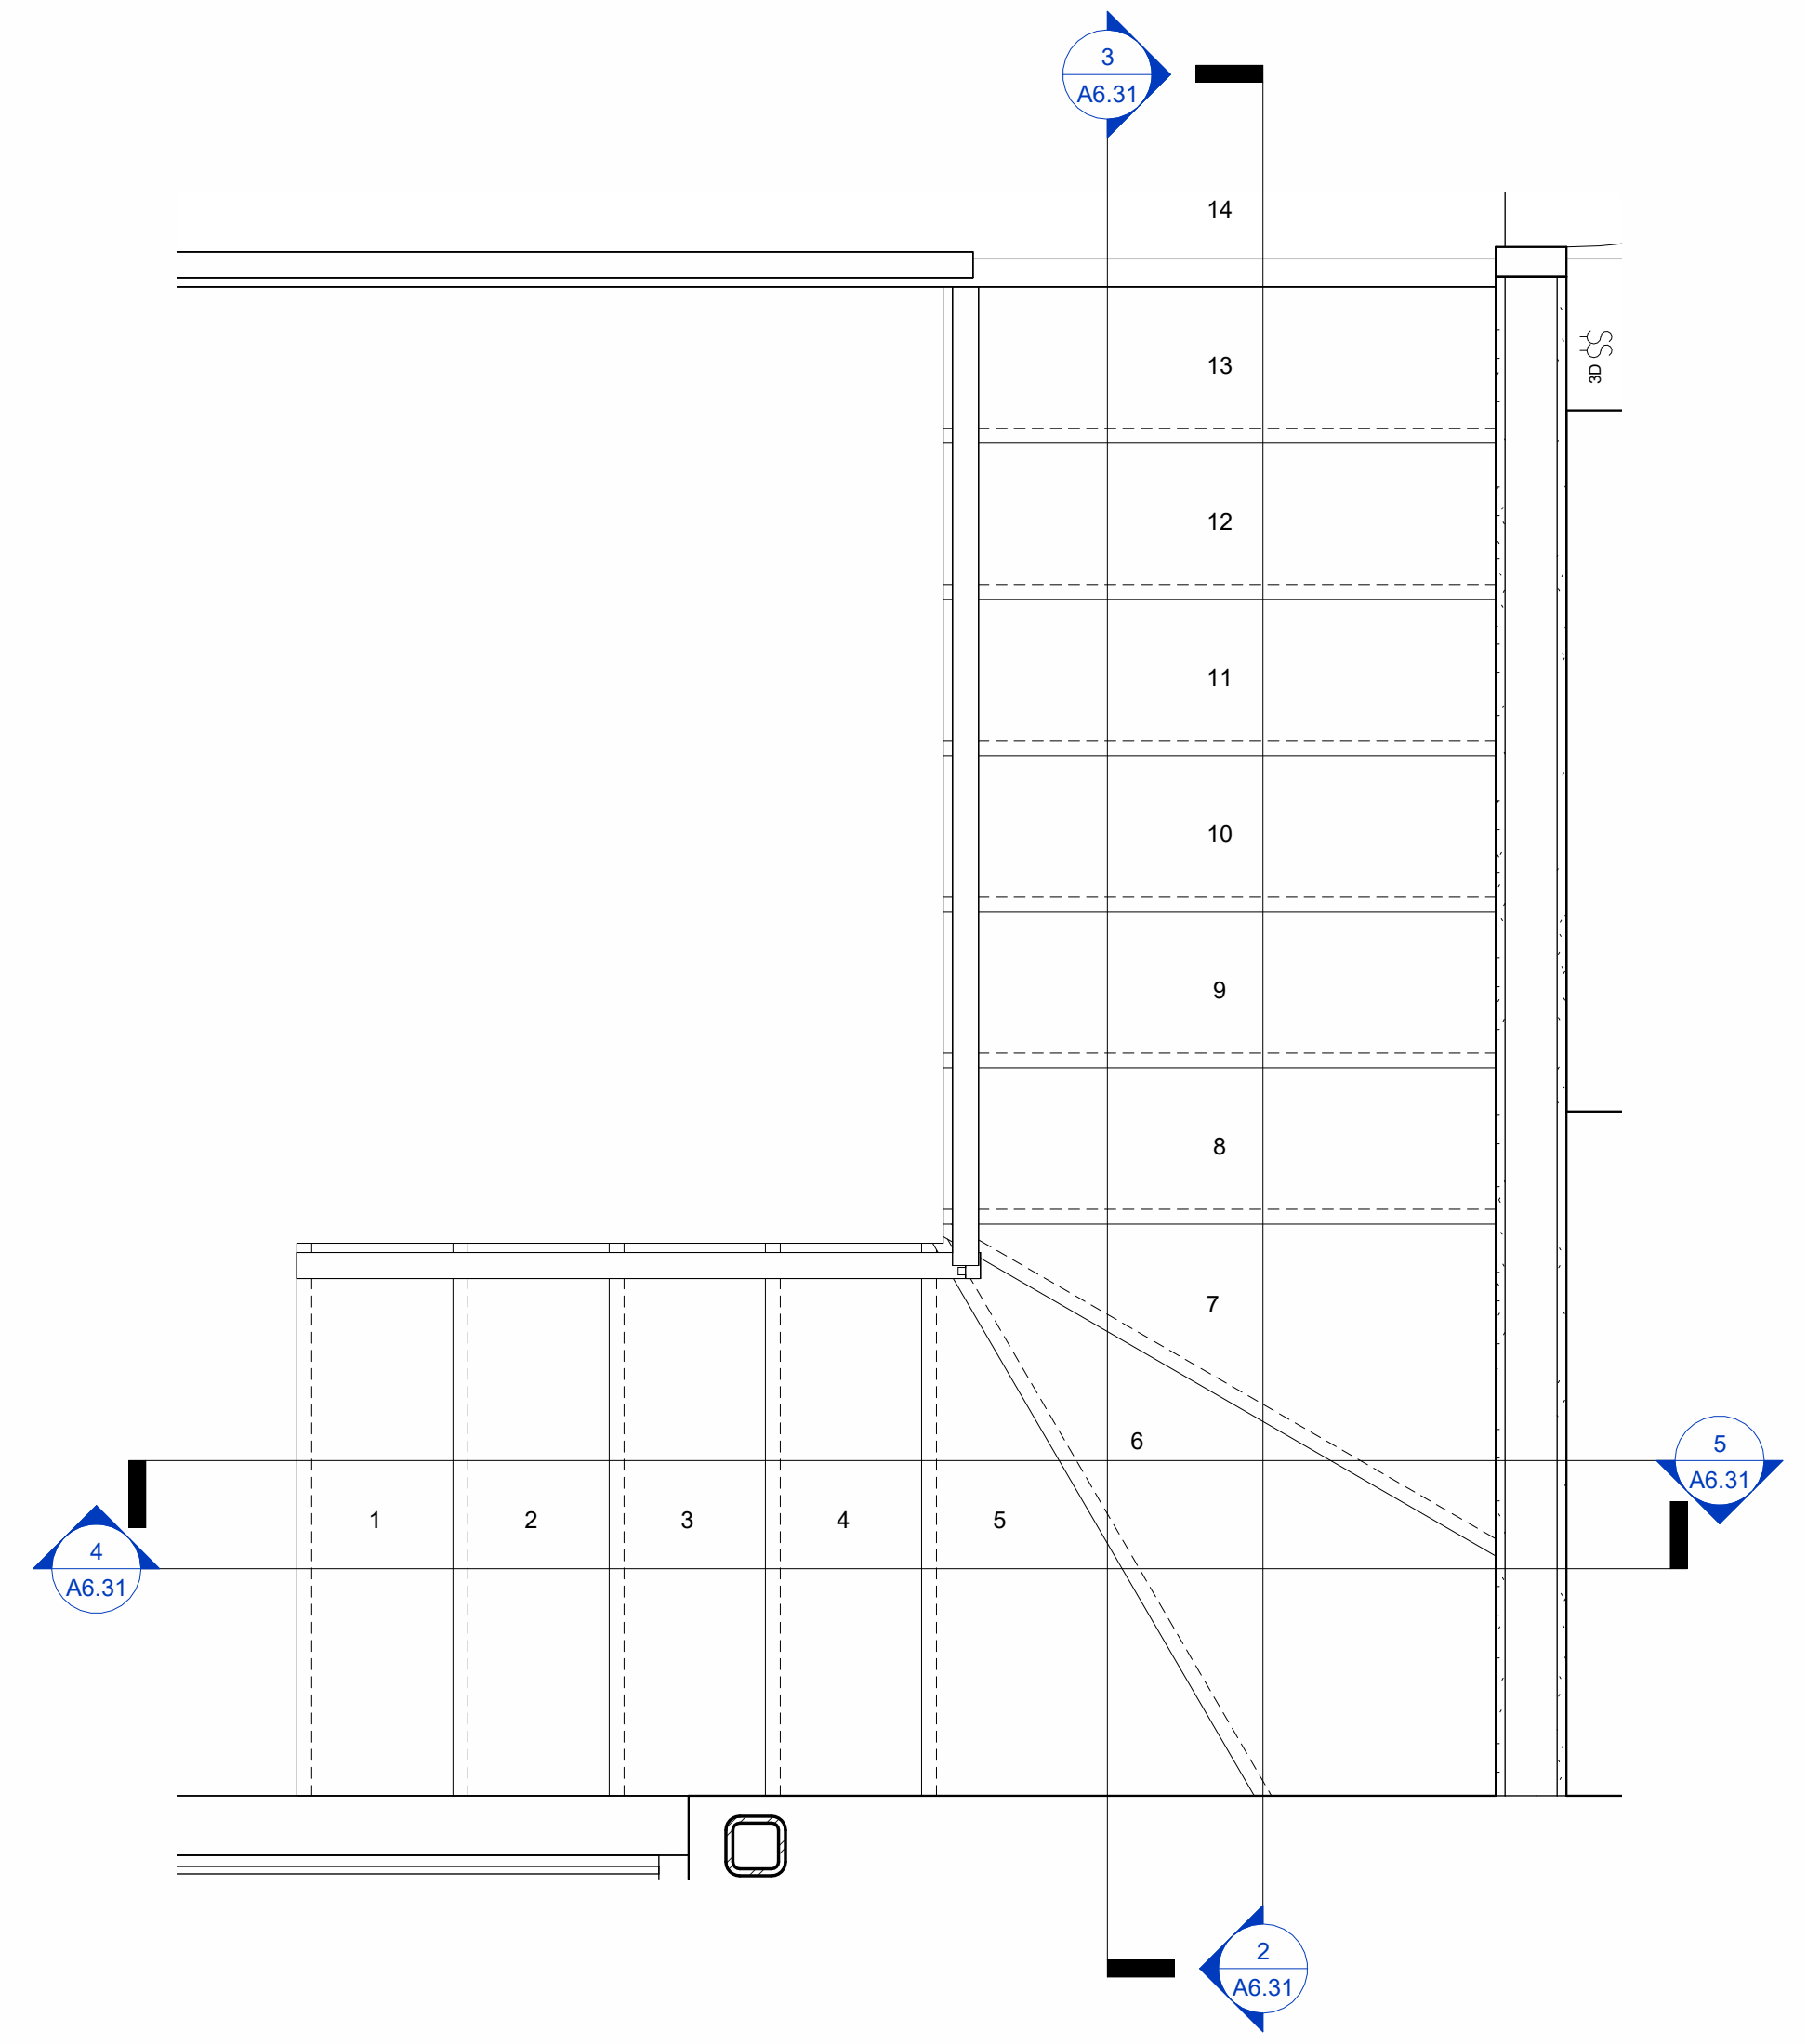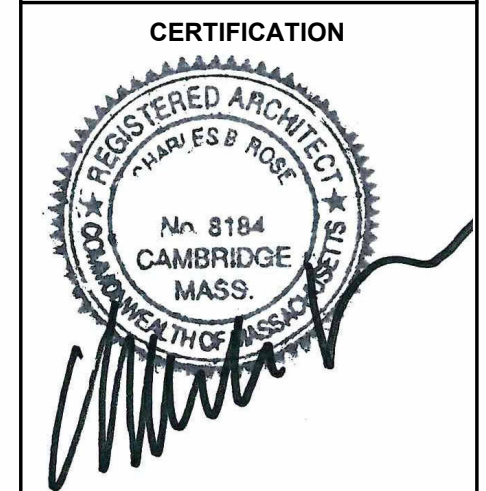


1 STAIR TO SECOND FLOOR PLAN
 1" = 1'-0"

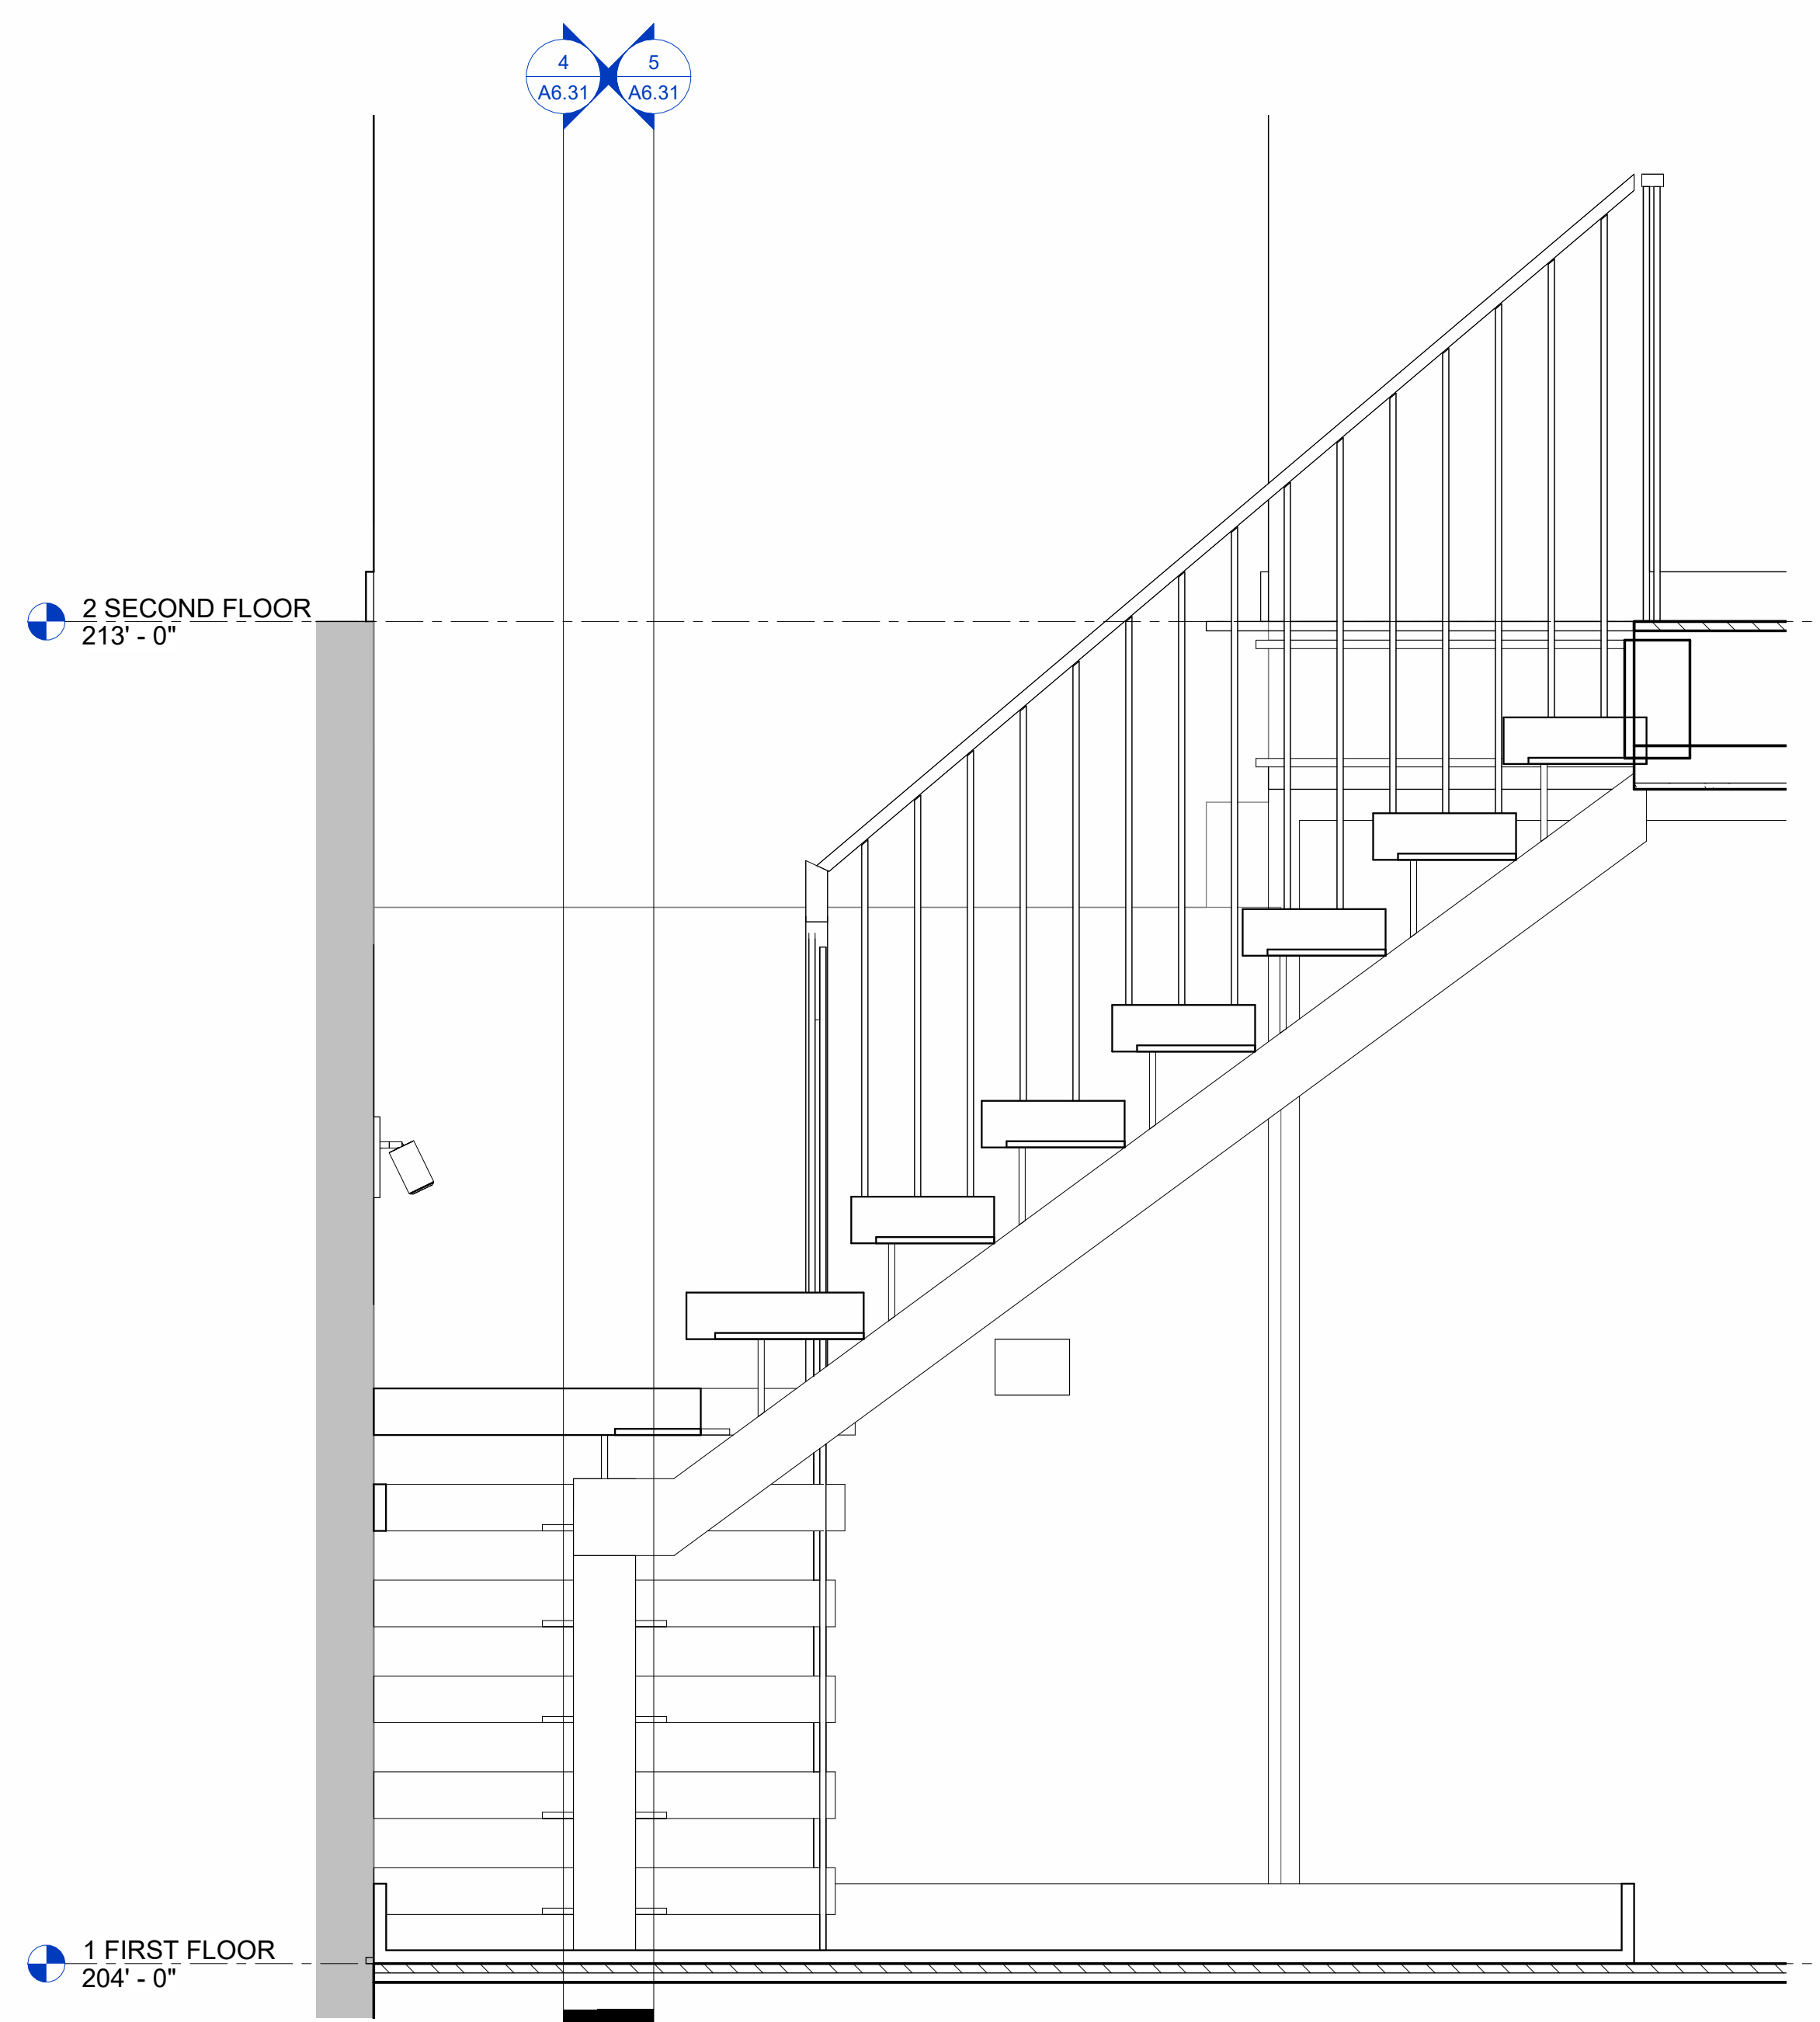


2 MAIN STAIR - NORTH SOUTH SECTION FACING WEST
 1" = 1'-0"

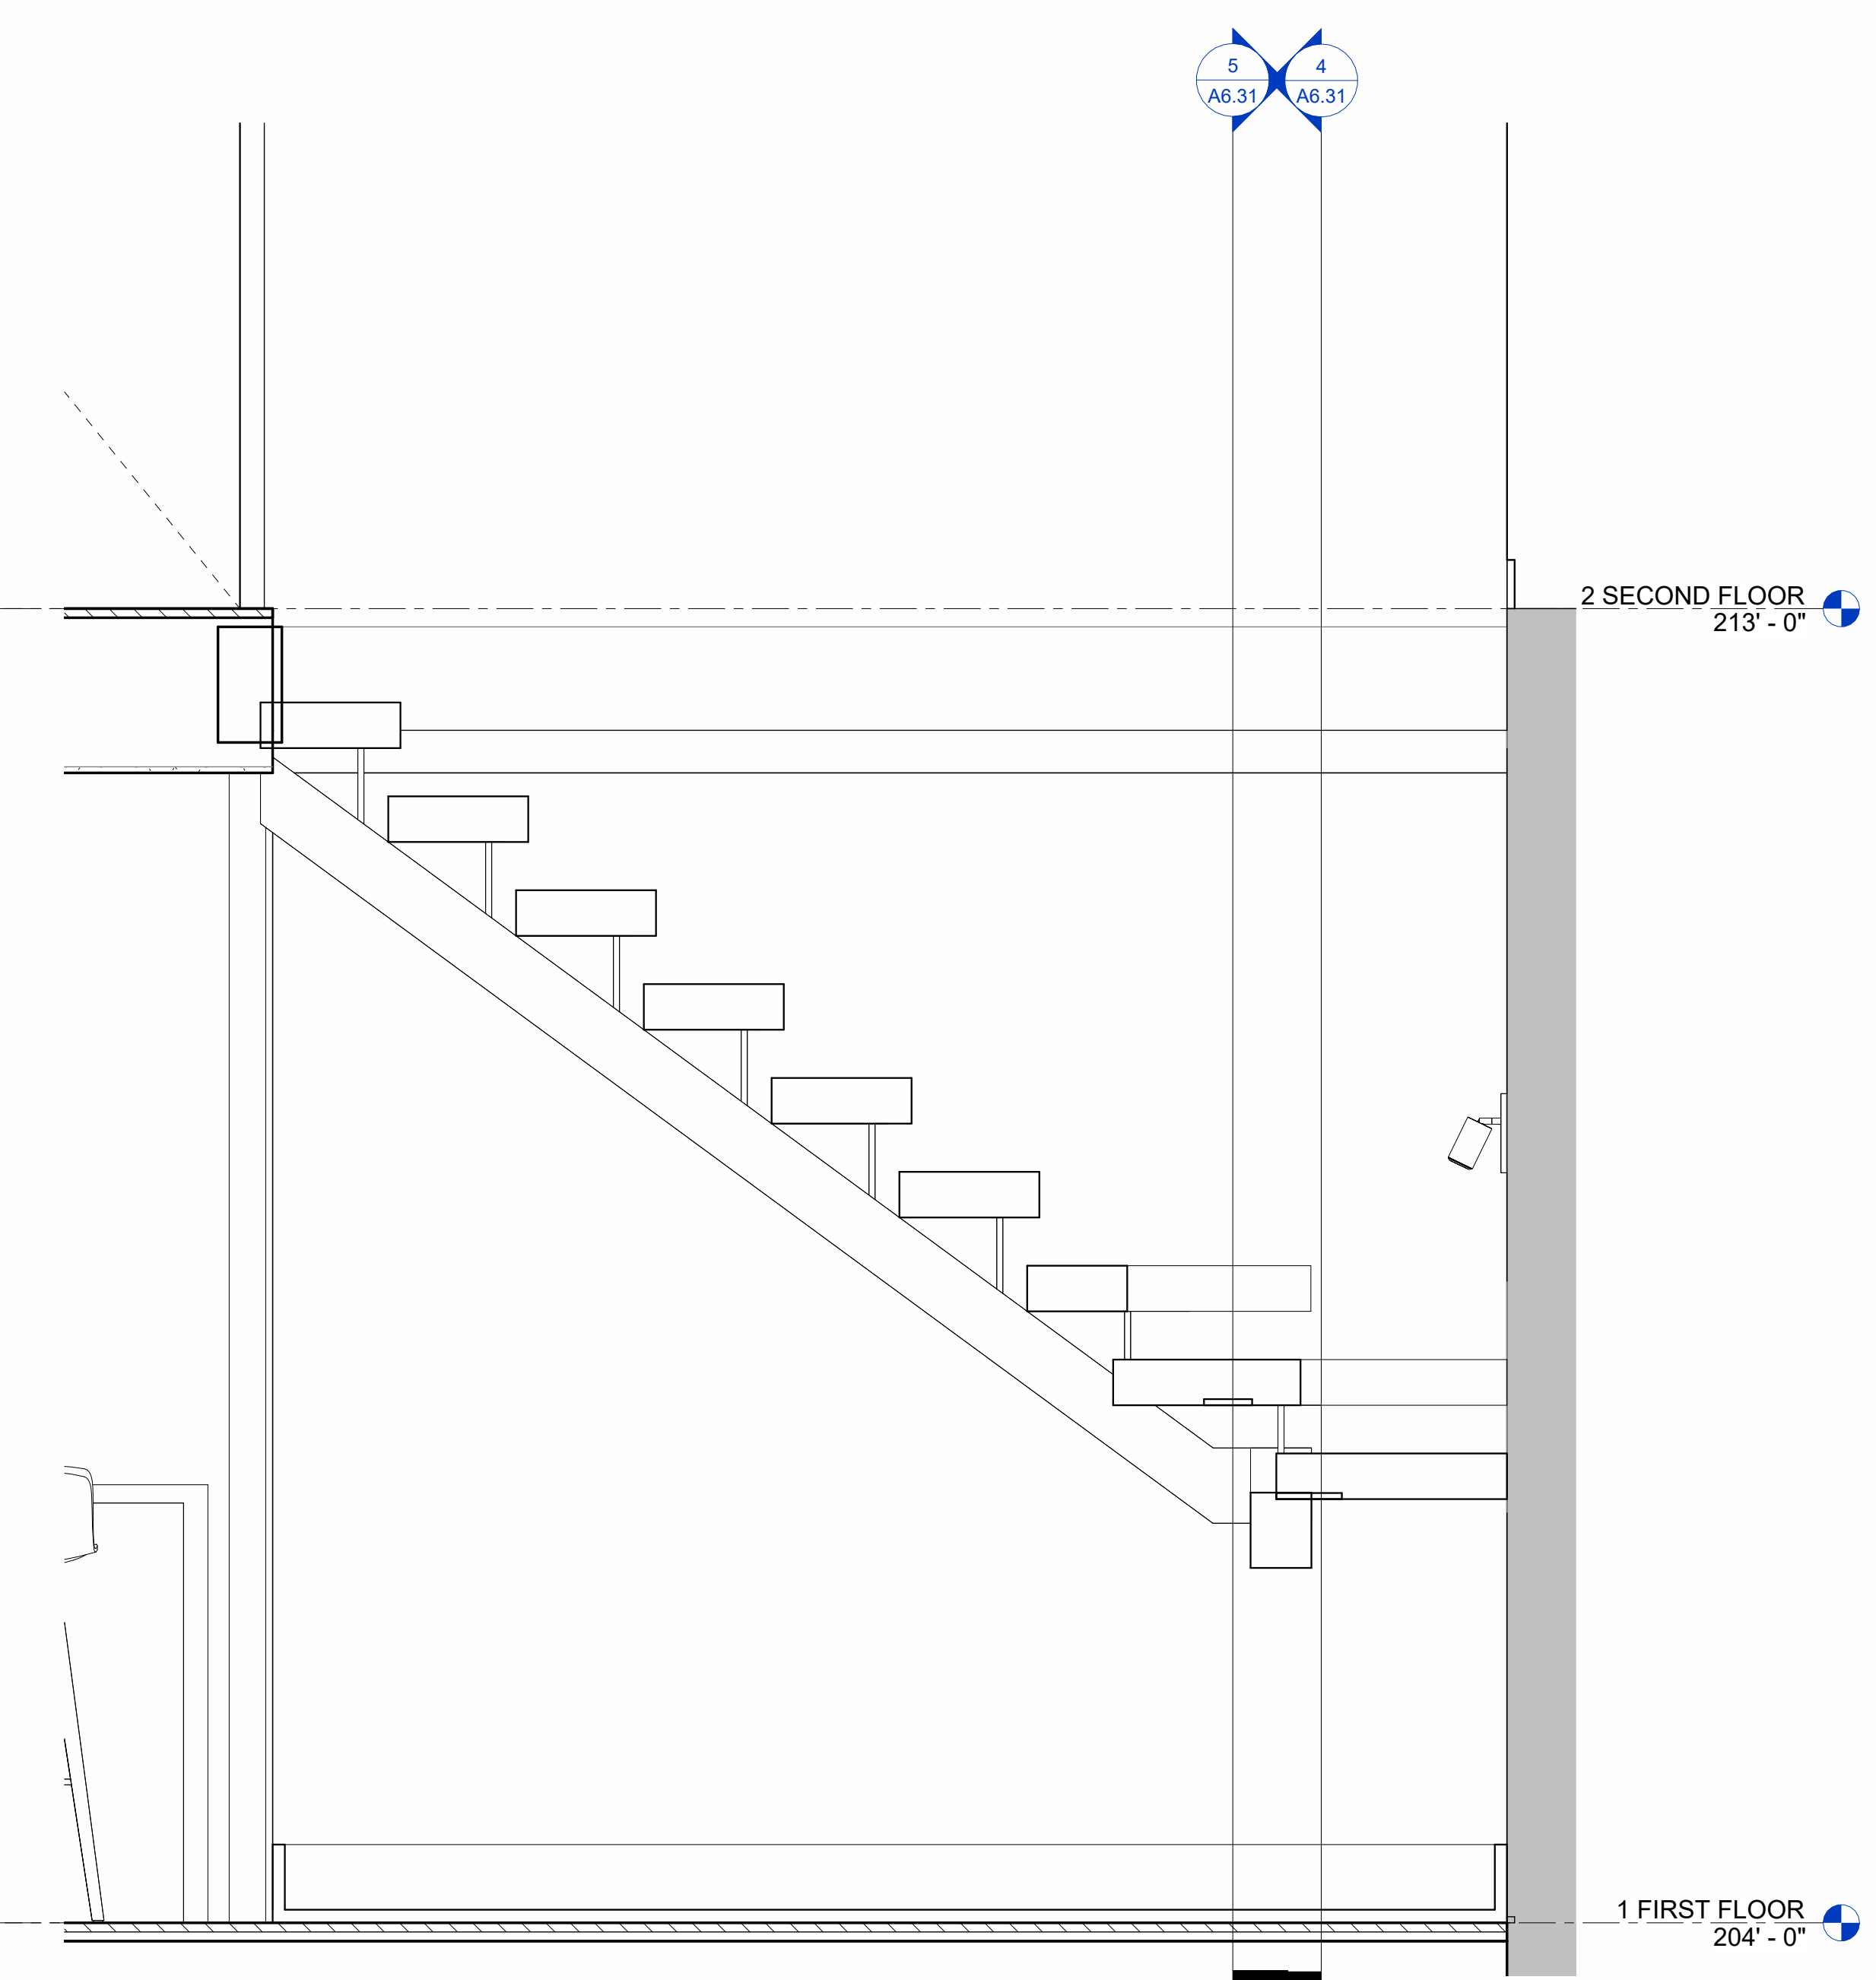


3 MAIN STAIR - NORTH SOUTH SECTION FACING EAST
 1" = 1'-0"

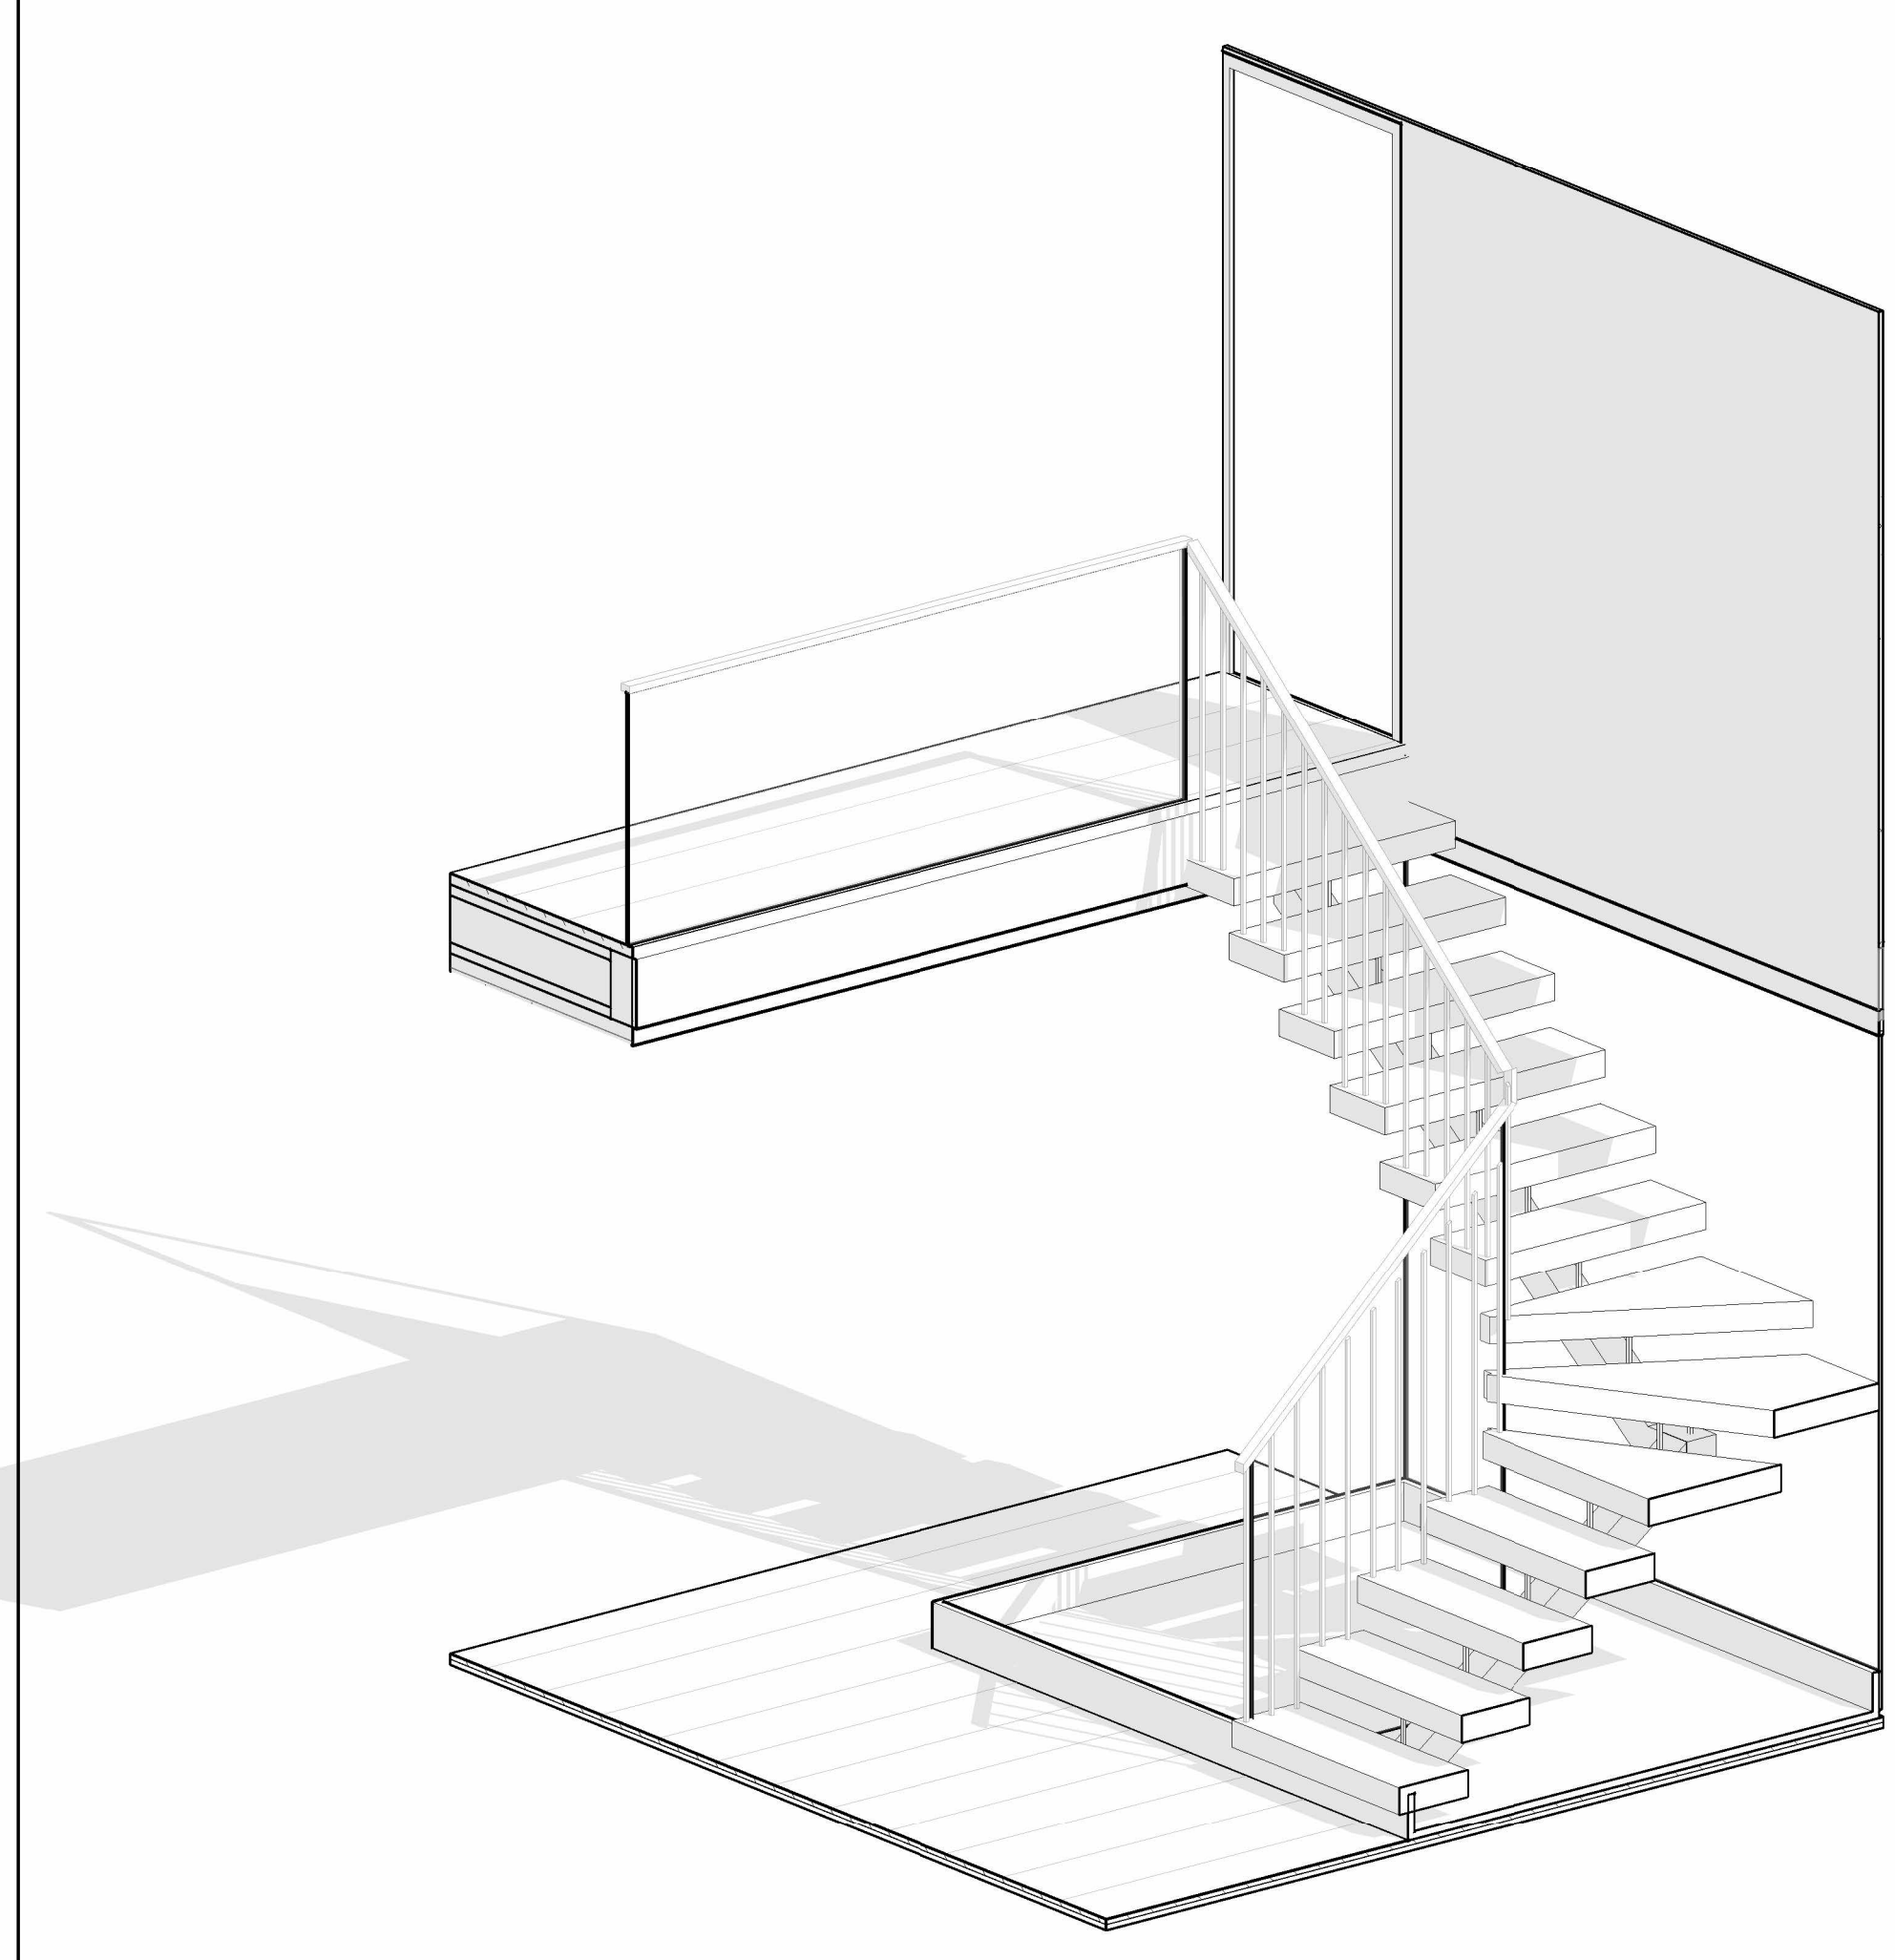

6 Entry Stair 3D

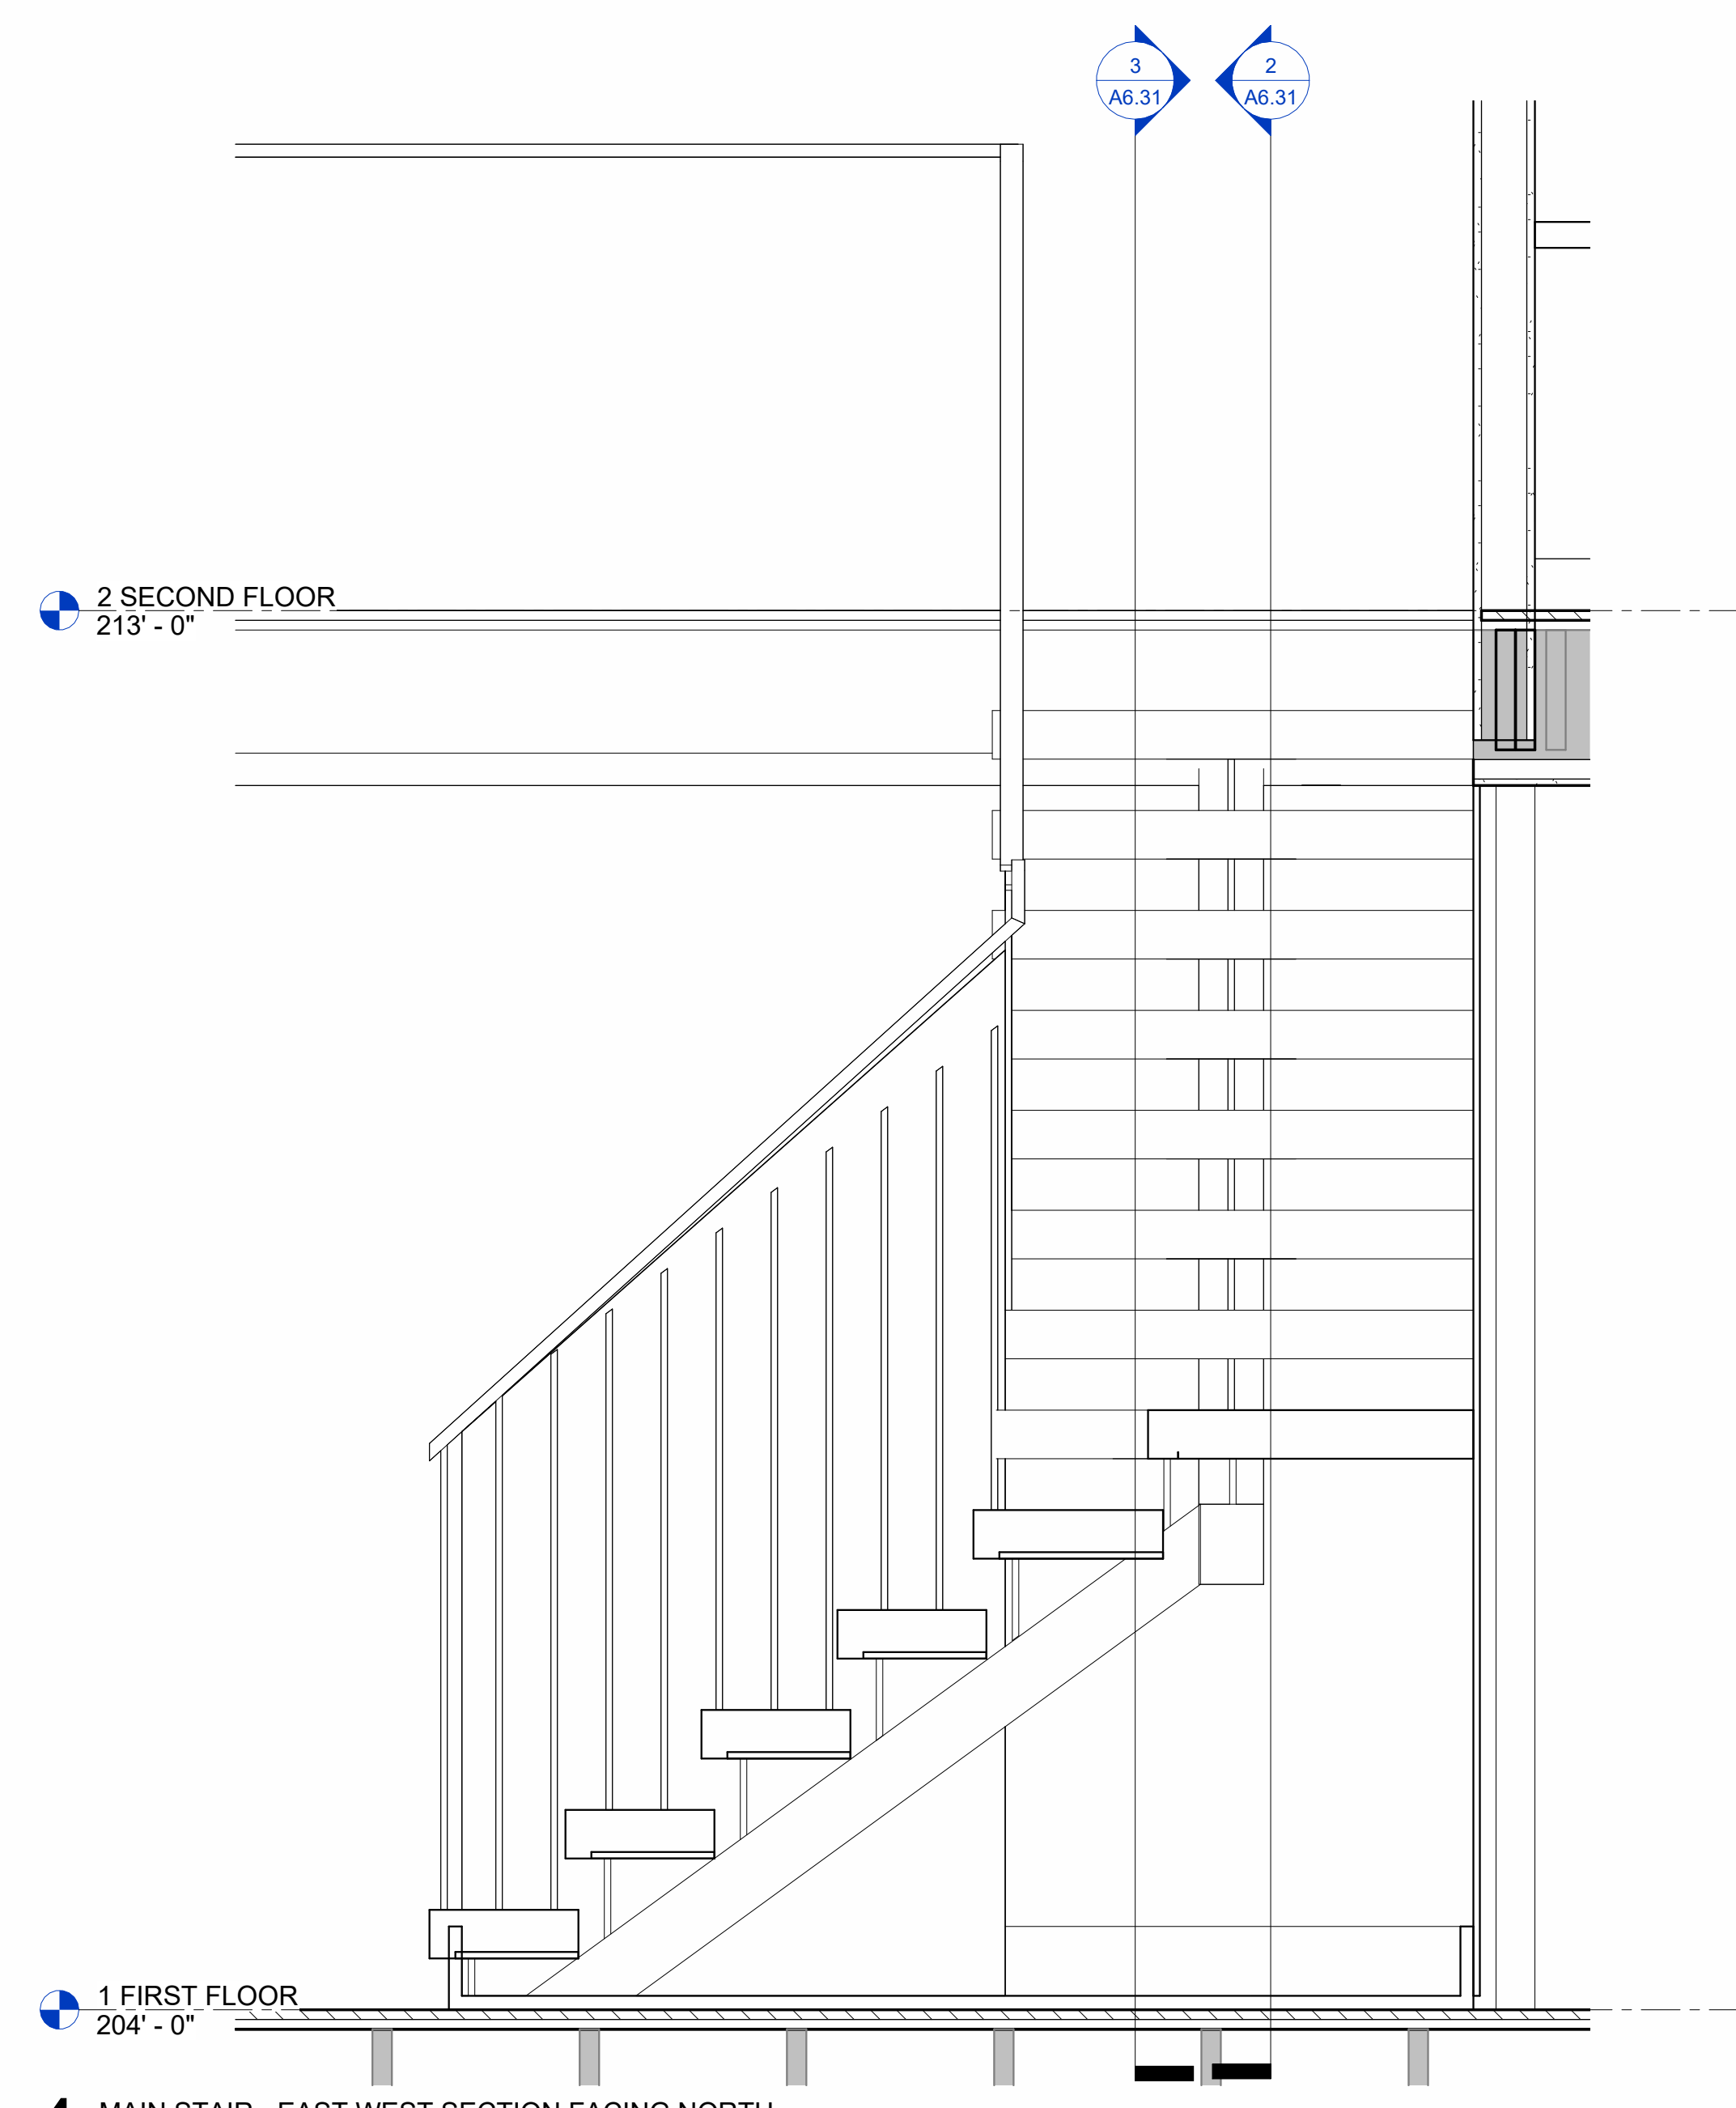

4 MAIN STAIR - EAST WEST SECTION FACING NORTH
 1" = 1'-0"

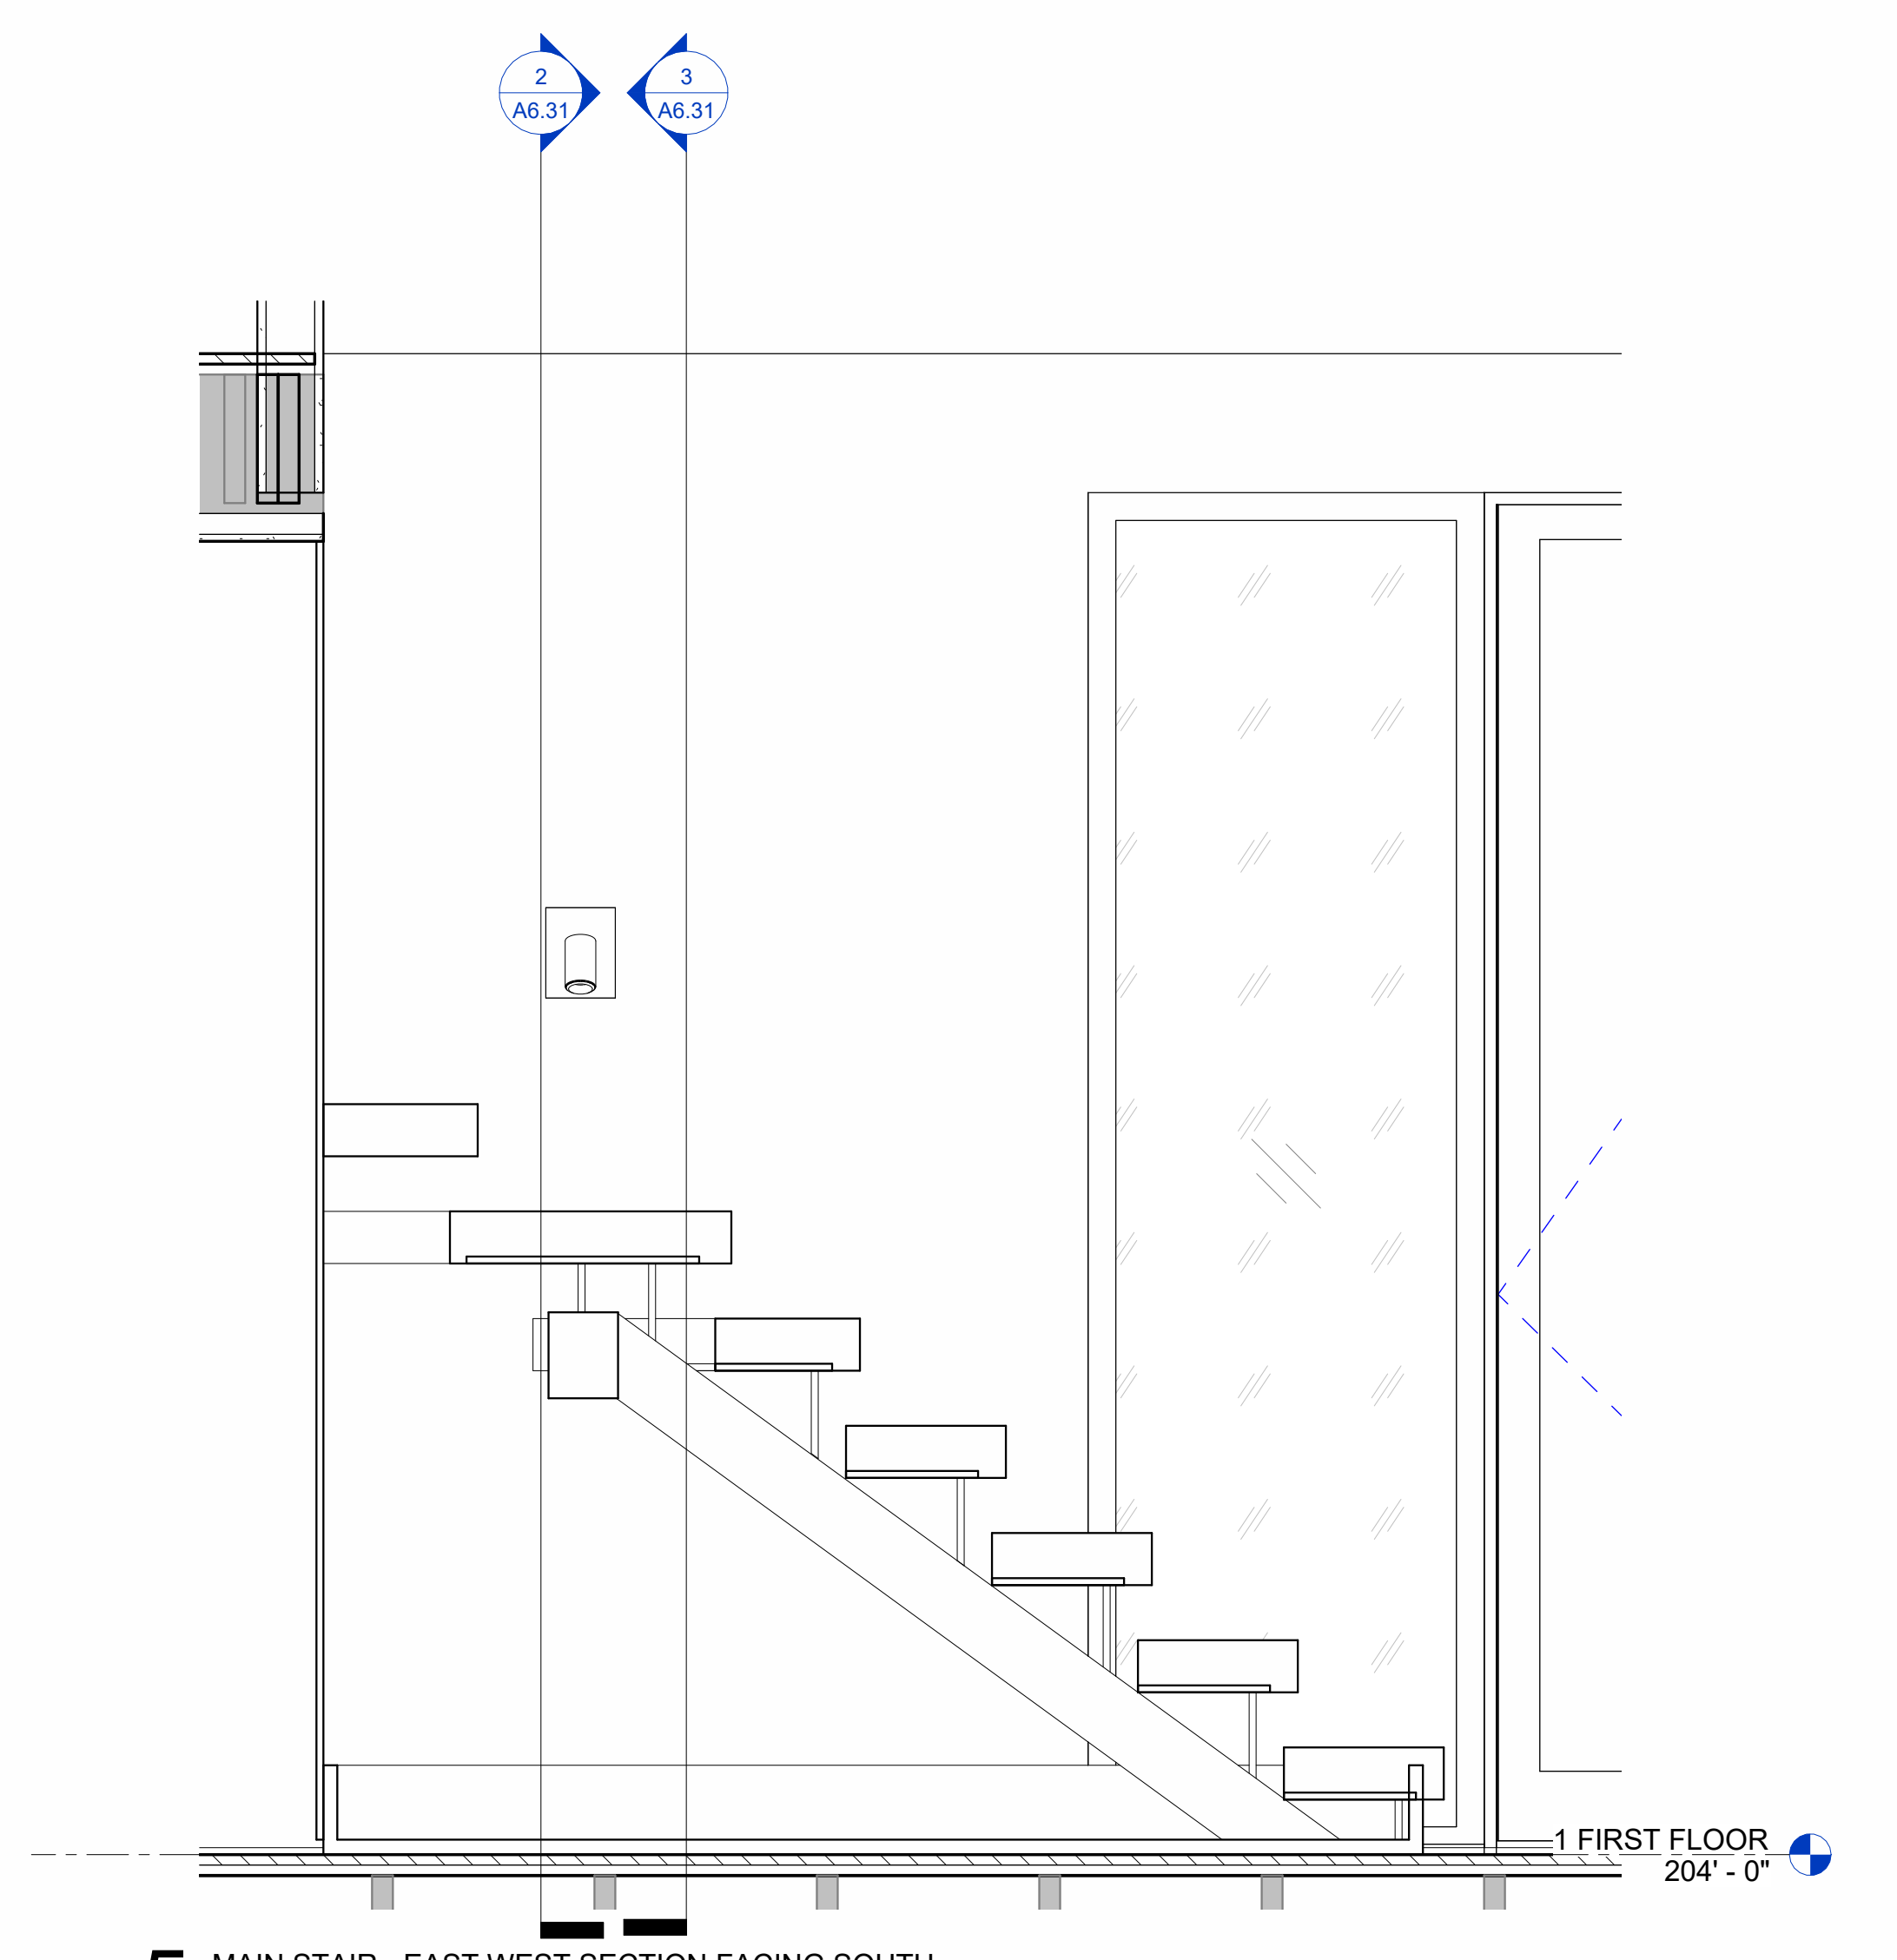

5 MAIN STAIR - EAST WEST SECTION FACING SOUTH
 1" = 1'-0"


REVISION HISTORY		
NO.	DESCRIPTION	DATE

PERMIT REVISION


DATE:	AUG 18, 2023
SCALE:	1" = 1'-0"
DRAWN BY:	CJ
CHECKED BY:	CR

SHEET TITLE PROJECT #: 40035


INTERIOR STAIR DETAILS

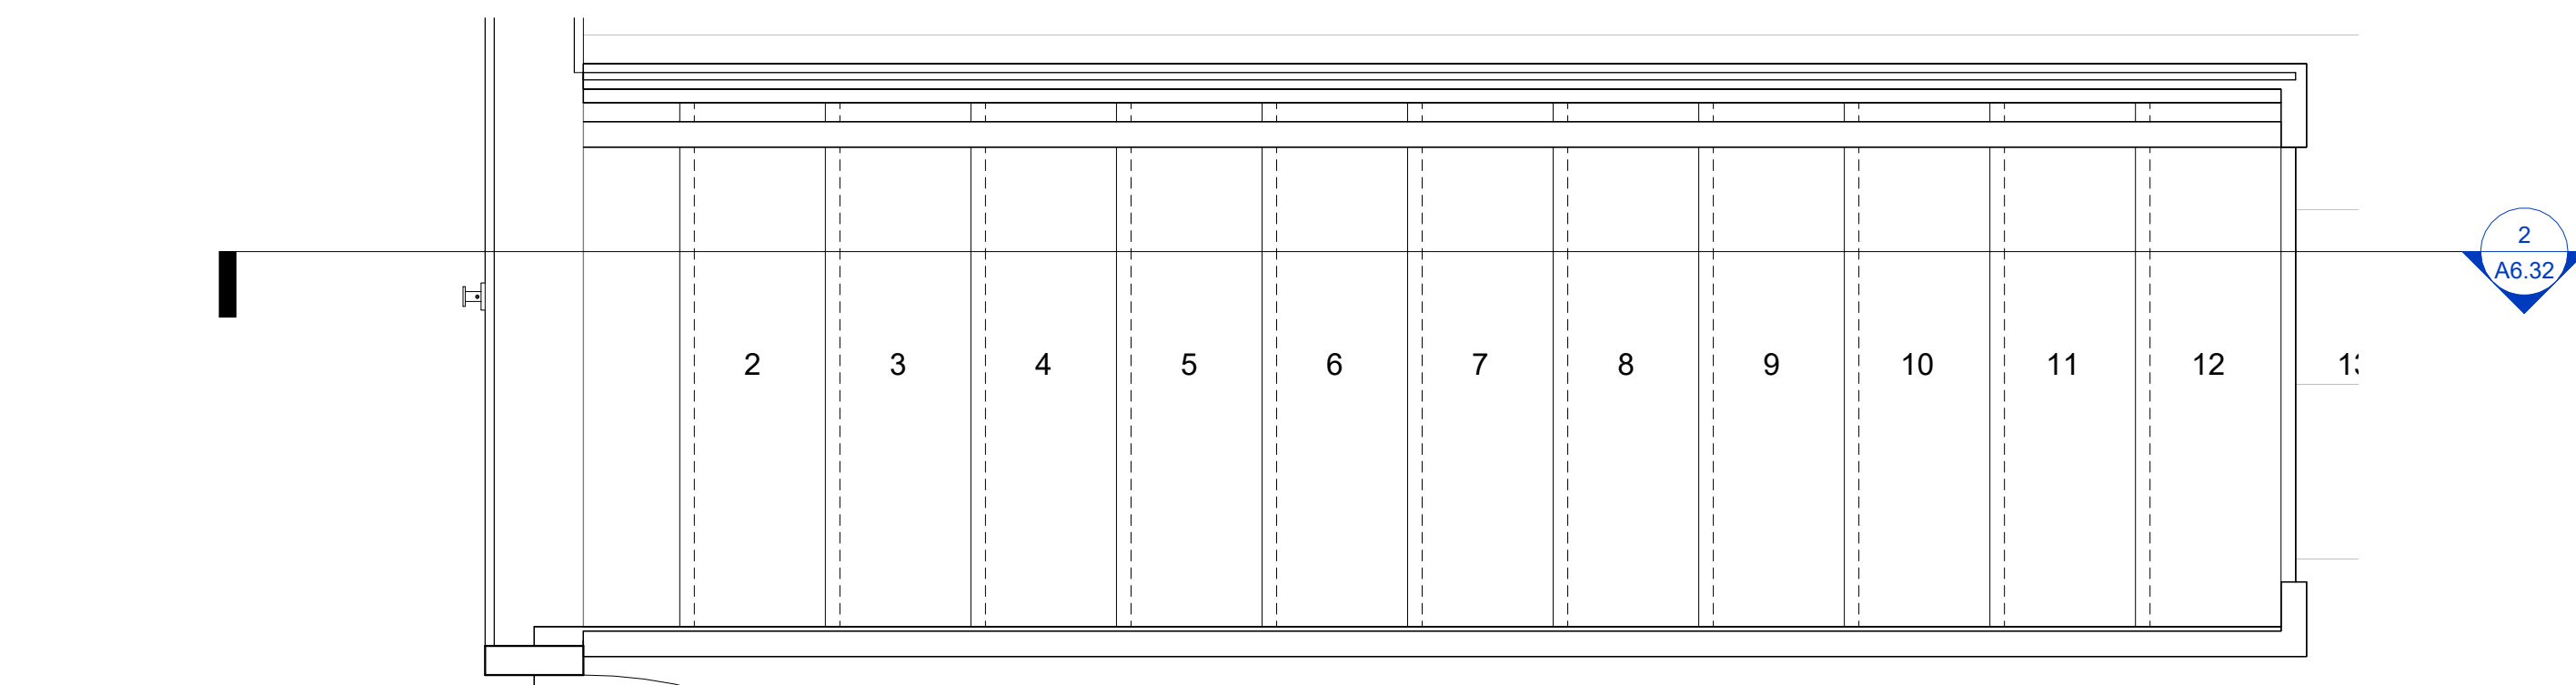

1 STAIR TO THIRD FLOOR PLAN
 1" = 1'-0"

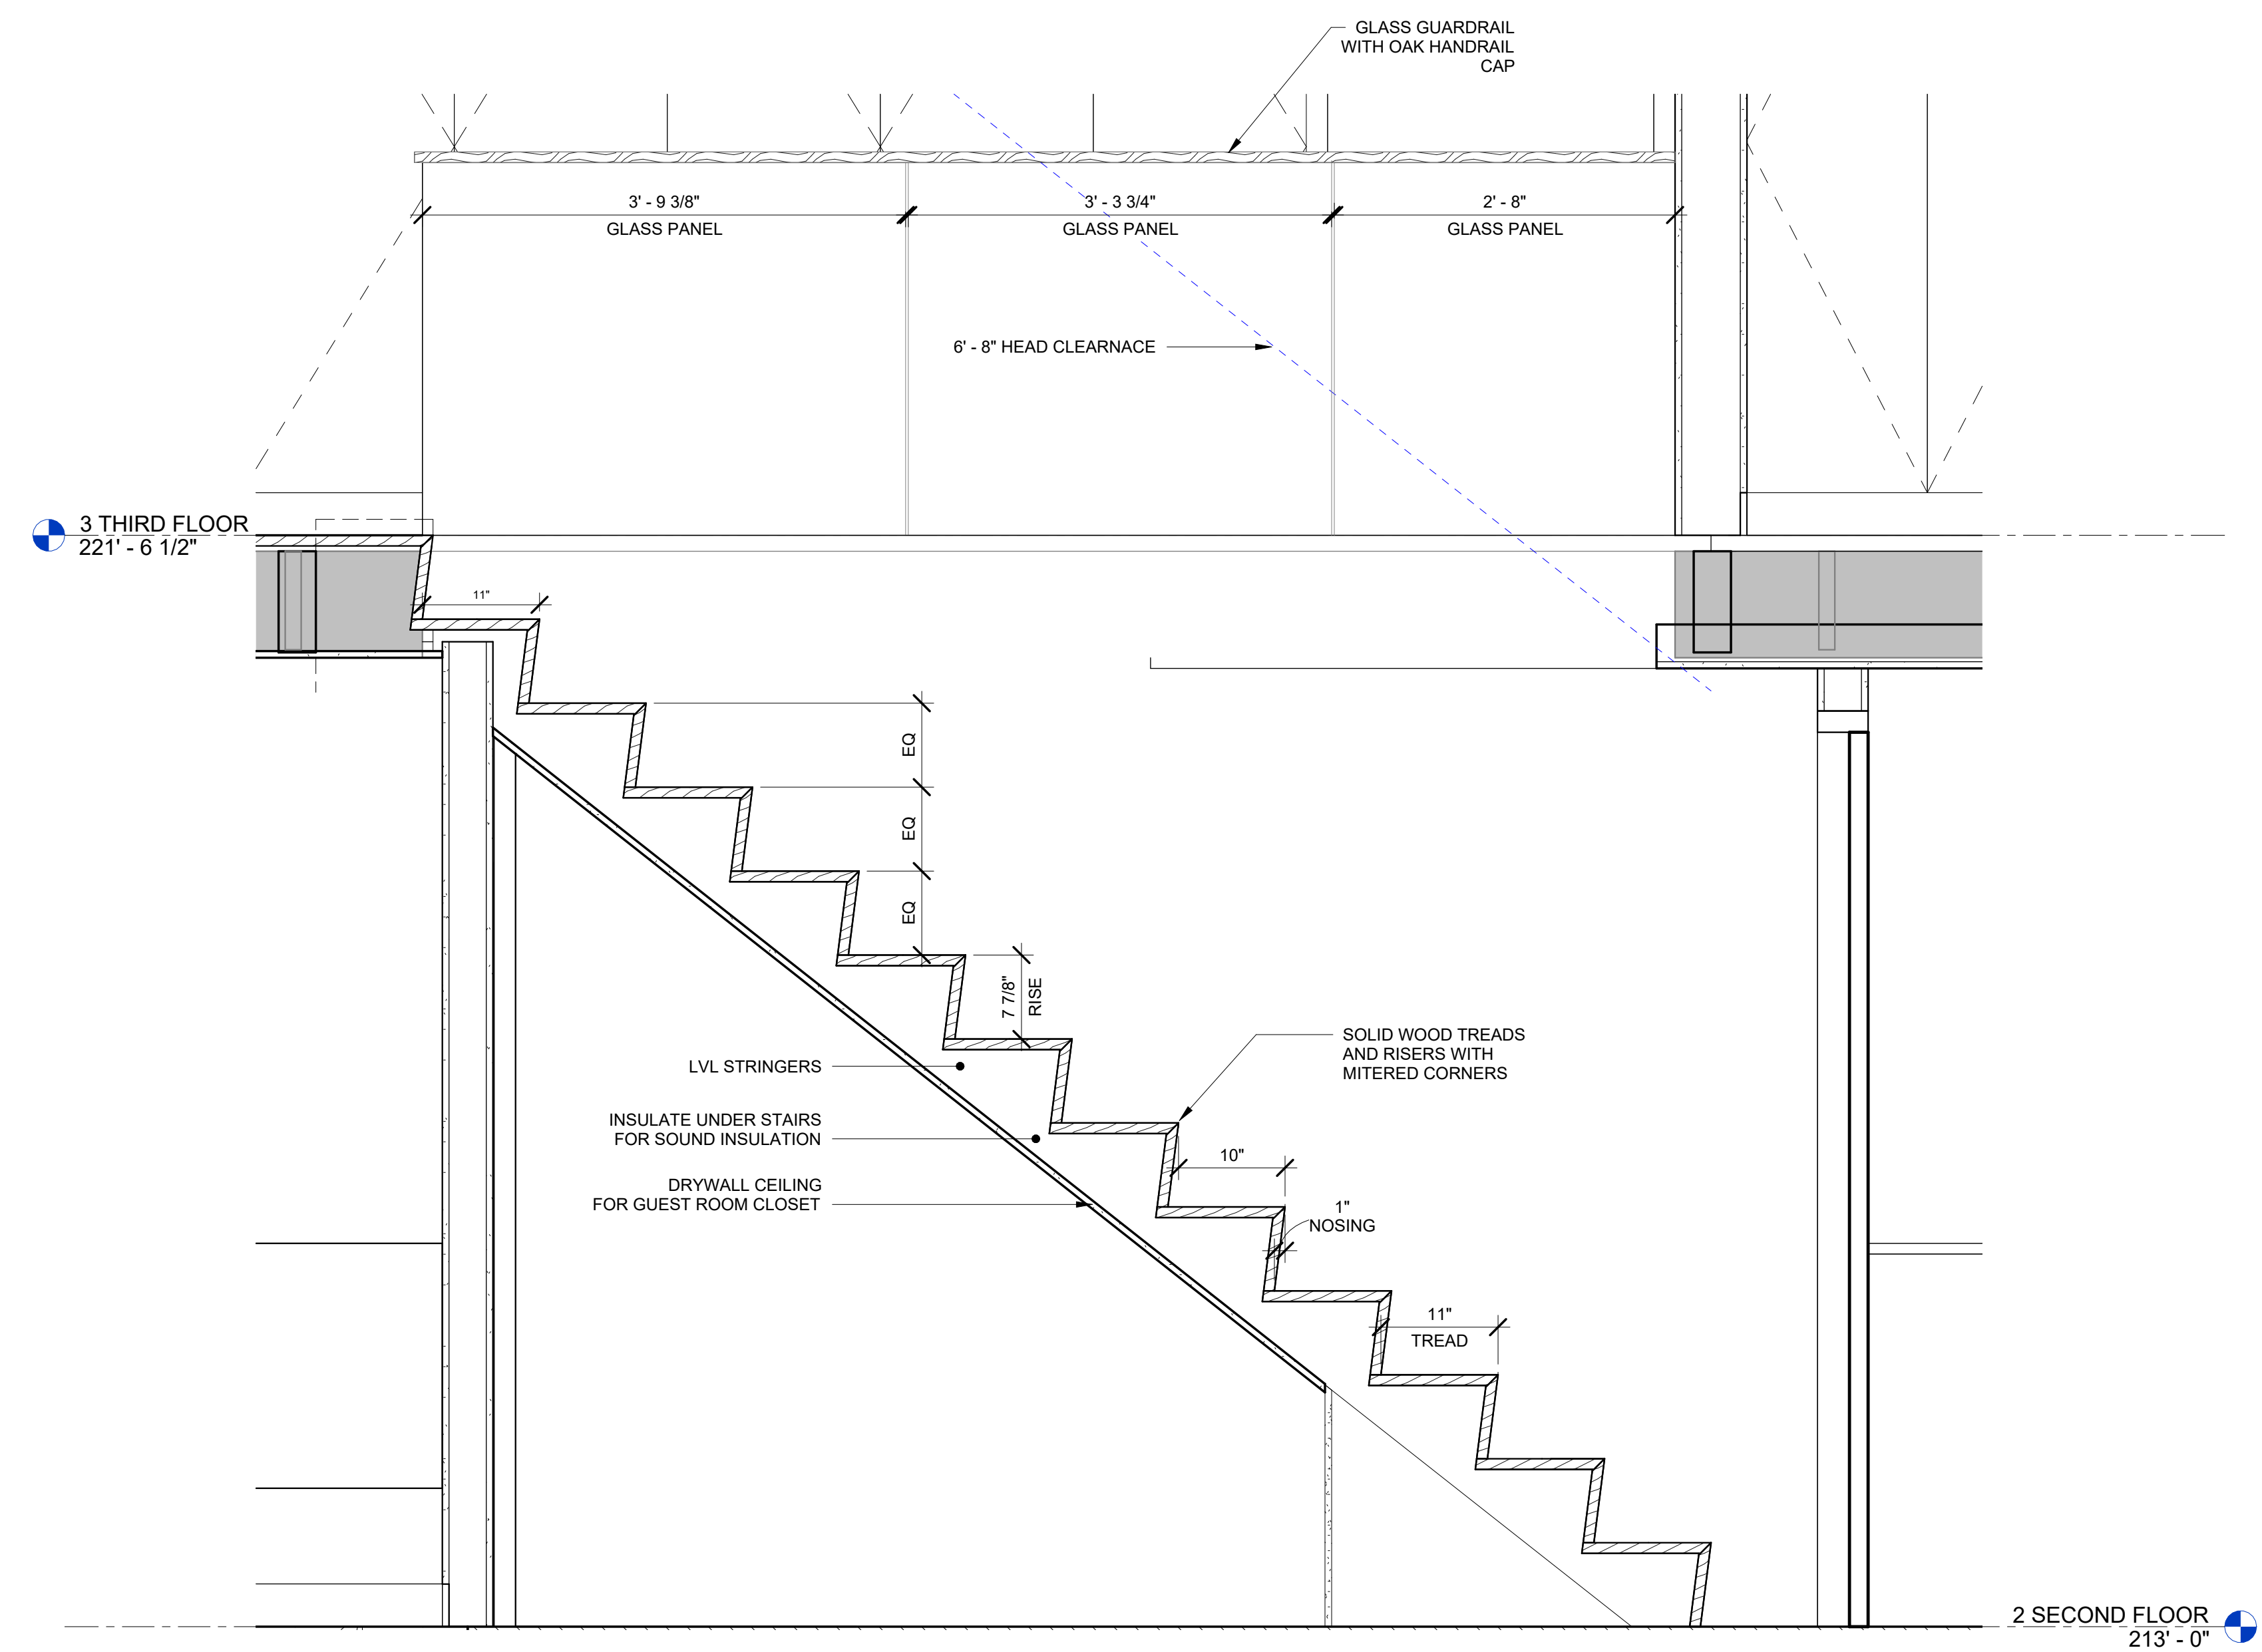

2 STAIR TO THIRD FLOOR - SECTION FACING SOUTH
 1" = 1'-0"

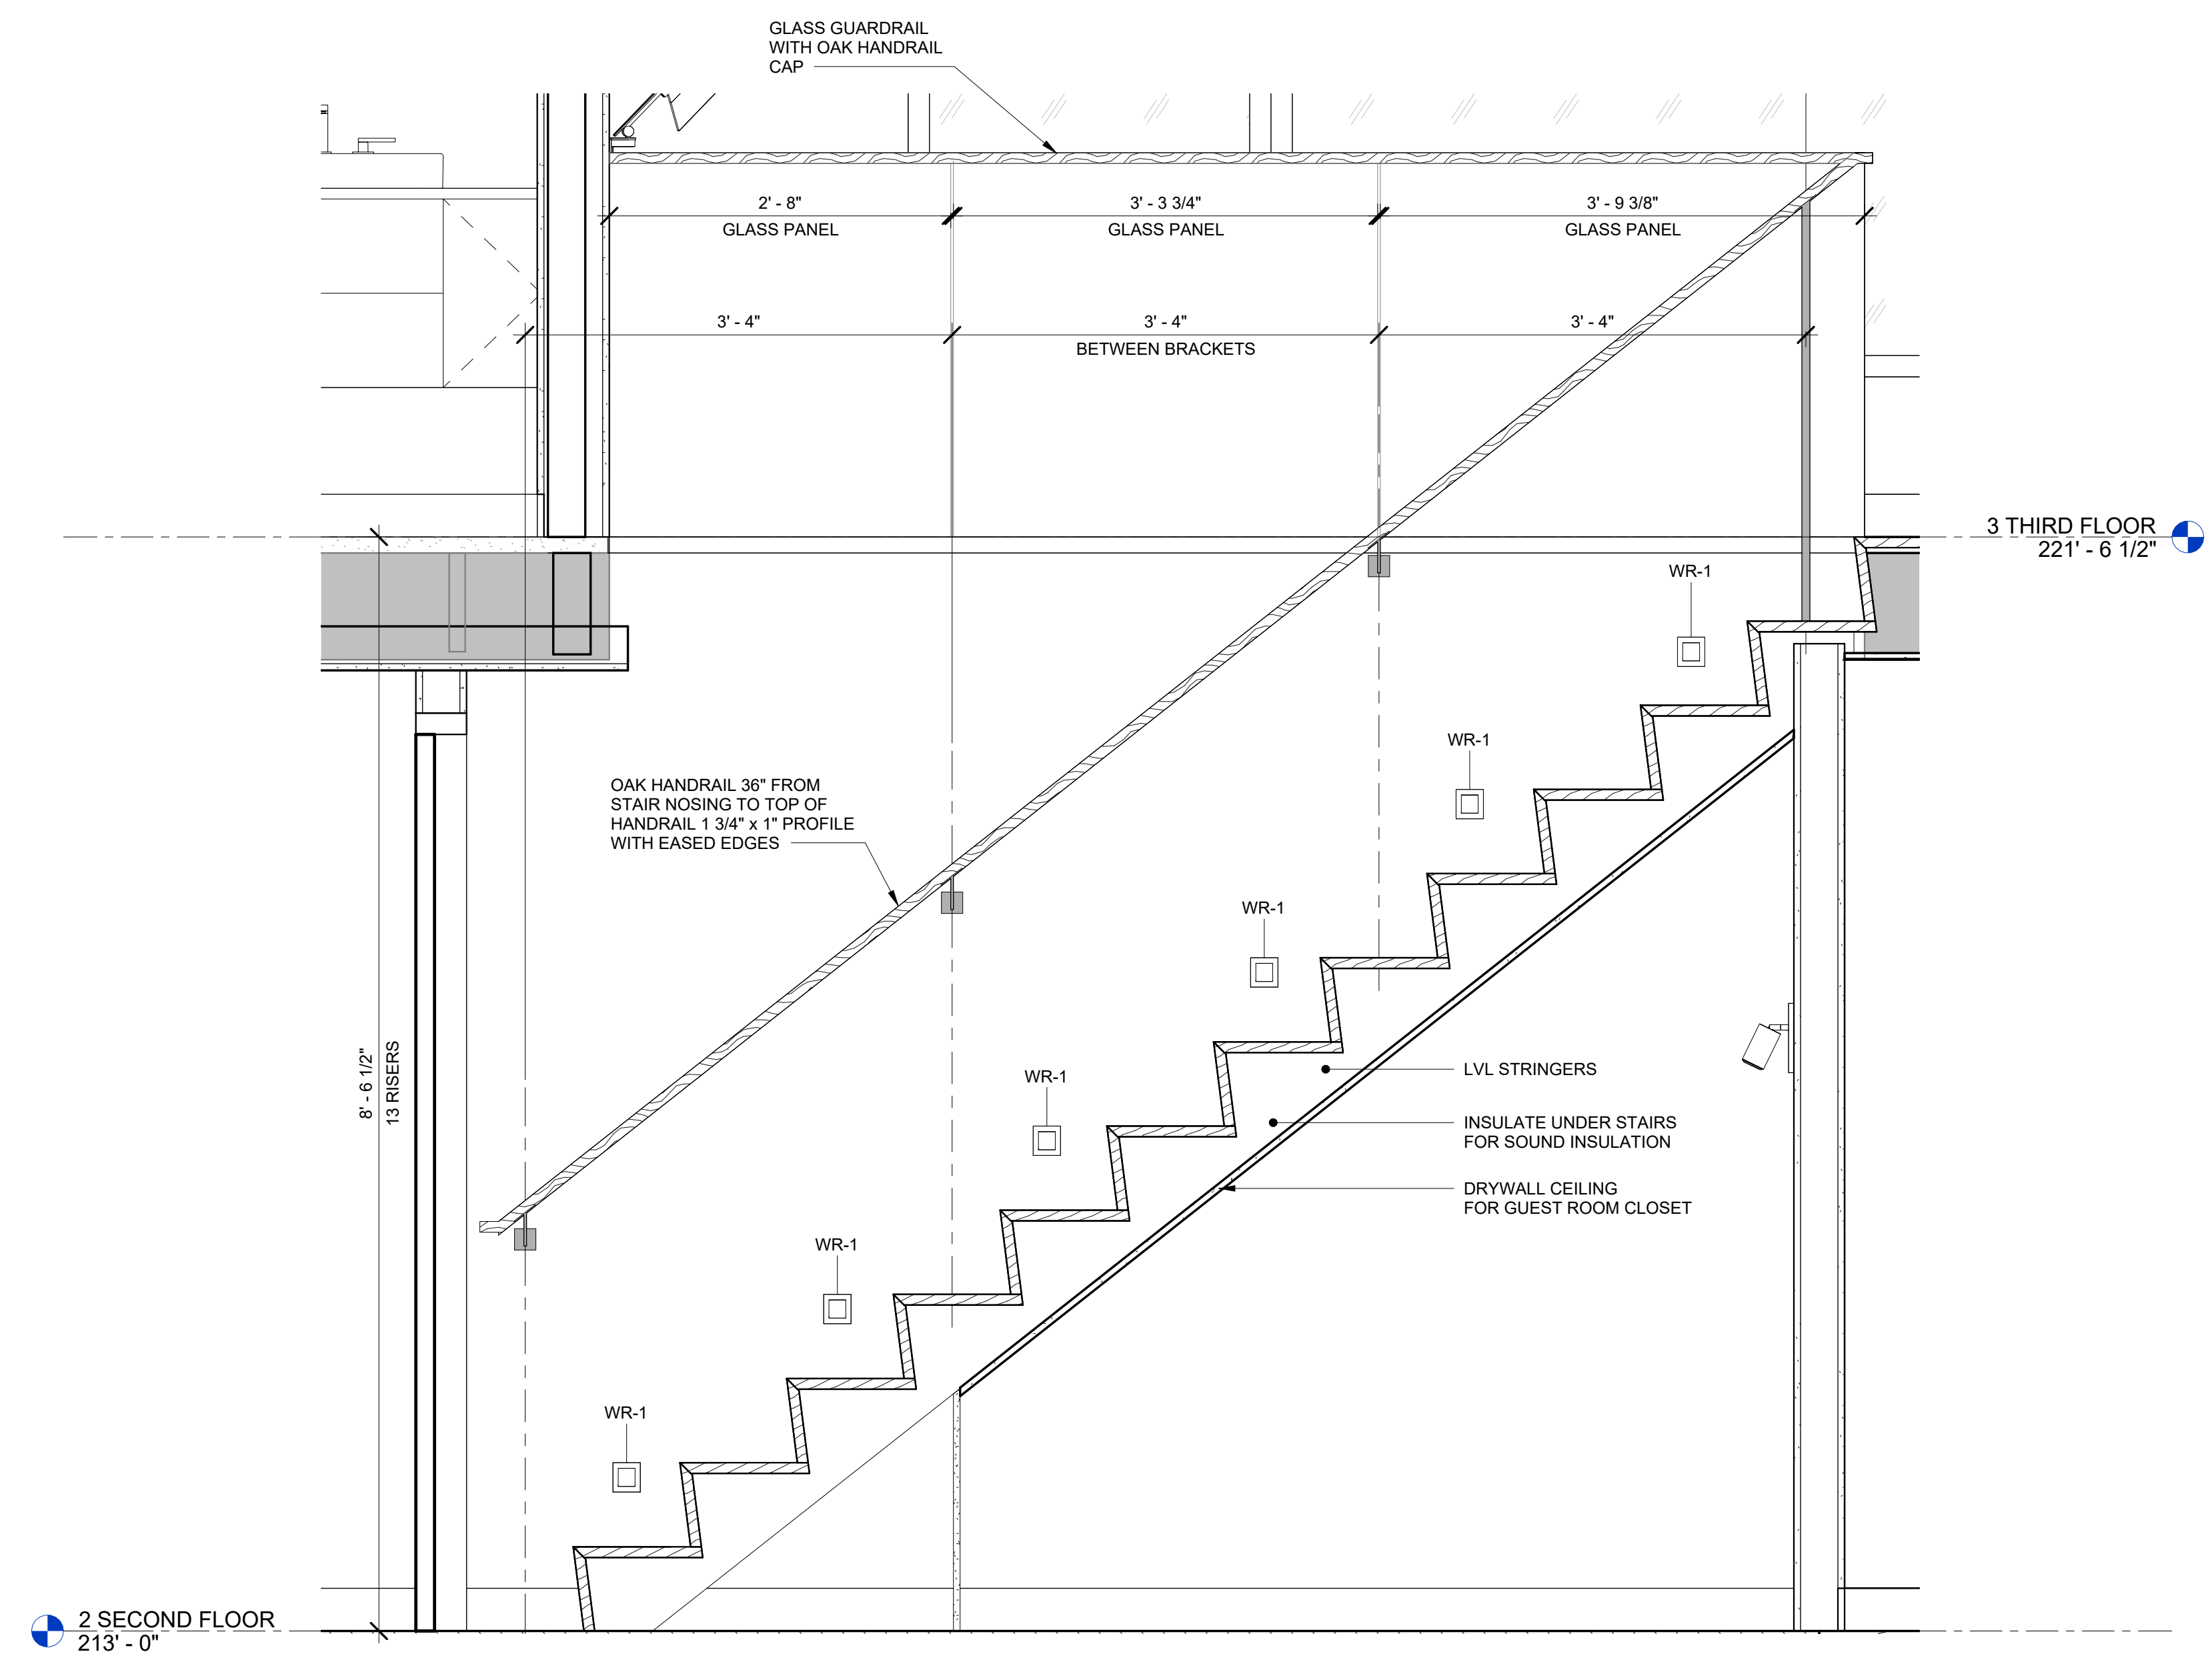

3 STAIR TO THIRD FLOOR - SECTION FACING NORTH
 1" = 1'-0"


REVISION HISTORY		
NO.	DESCRIPTION	DATE

PERMIT REVISION

DATE:	AUG 18, 2023
SCALE:	1" = 1'-0"
DRAWN BY:	CJ
CHECKED BY:	CR





SHEET TITLE:	PROJECT #:	40035
--------------	------------	-------

INTERIOR STAIR DETAILS

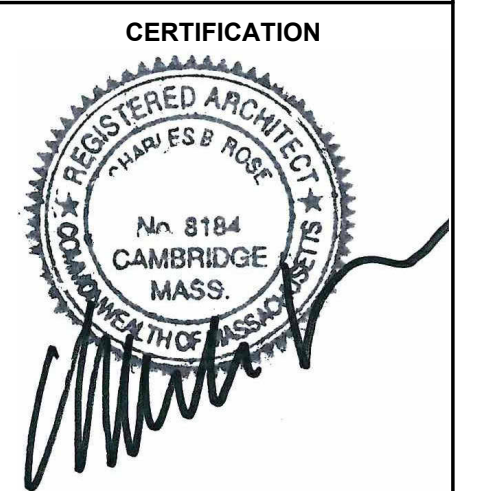

PARTITION NOTES

- UNLESS INDICATED OTHERWISE, ALL NEW INTERIOR PARTITIONS ARE TYPE B.
 - PARTITION TYPE DESIGNATIONS ARE SHOWN ON FLOOR PLANS. WHERE PLANS ARE ENLARGED, DESIGNATIONS ARE FOUND ONLY ON THE ENLARGED PLANS.
 - DIMENSIONS ARE TO THE FACE OF GYPSUM BOARD, UNLESS NOTED OTHERWISE, FOR ALL METAL STUD CONSTRUCTION.
 - STUD SIZES ARE NOTED WITH A NUMERICAL SUFFIX CORRESPONDING TO THE STUD SIZE, ACCORDING TO THE FOLLOWING:
- | SUFFIX | WOOD STUD SIZE |
|--------|----------------|
| 4 | 2x4 |
| 6 | 2x6 |
| 8 | 2x8 |
- ALL GYPSUM BOARD IS 5/8" TYPE X. WHERE TILE, STONE AND SIMILAR RIGID MATERIALS ARE USED AS FINISH MATERIALS, USE 5/8" CEMENT FIBER BACKER BOARD IN LIEU OF GYPSUM BOARD.
 - ALL STUDS ARE CONTINUOUS FOR THE FULL HEIGHT OF THE PARTITION. NO SPLICING OF STUDS IS PERMITTED.
 - TAPE AND FLOAT ALL JOINTS FOR THE FULL HEIGHT OF PARTITIONS.
 - FULL HEIGHT PARTITIONS EXTEND FROM THE TOP OF STRUCTURAL CONCRETE FLOORS TO THE UNDERSIDE OF STRUCTURE OF THE FLOOR OR ROOF ABOVE, AND ARE CONSIDERED UNBRACED FOR THEIR FULL HEIGHT.
 - PARTITIONS ARE DRAWN AT THEIR ACTUAL THICKNESS AND DO NOT INCLUDE APPLIED FINISHES.
 - SEE REFLECTED CEILING PLANS FOR CEILING HEIGHTS.

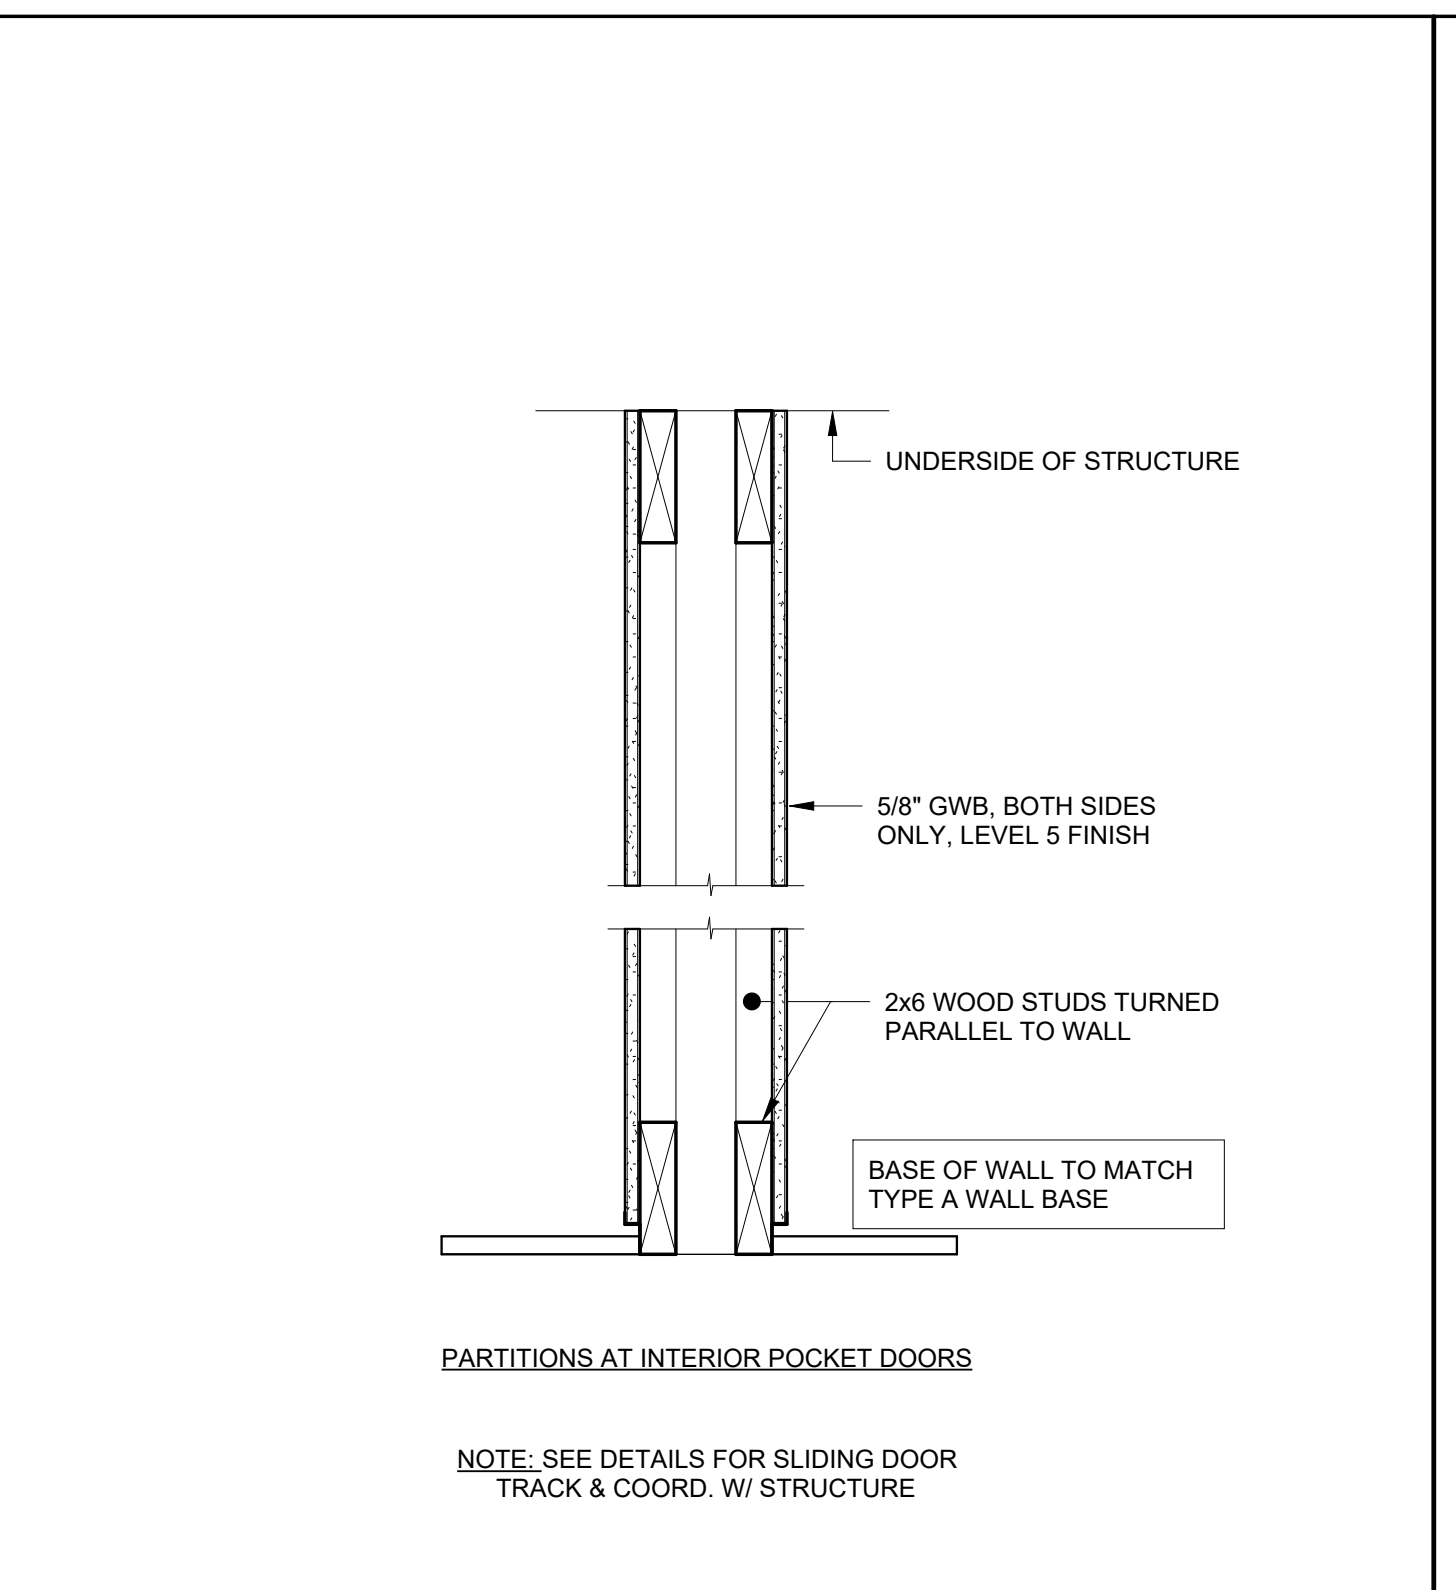
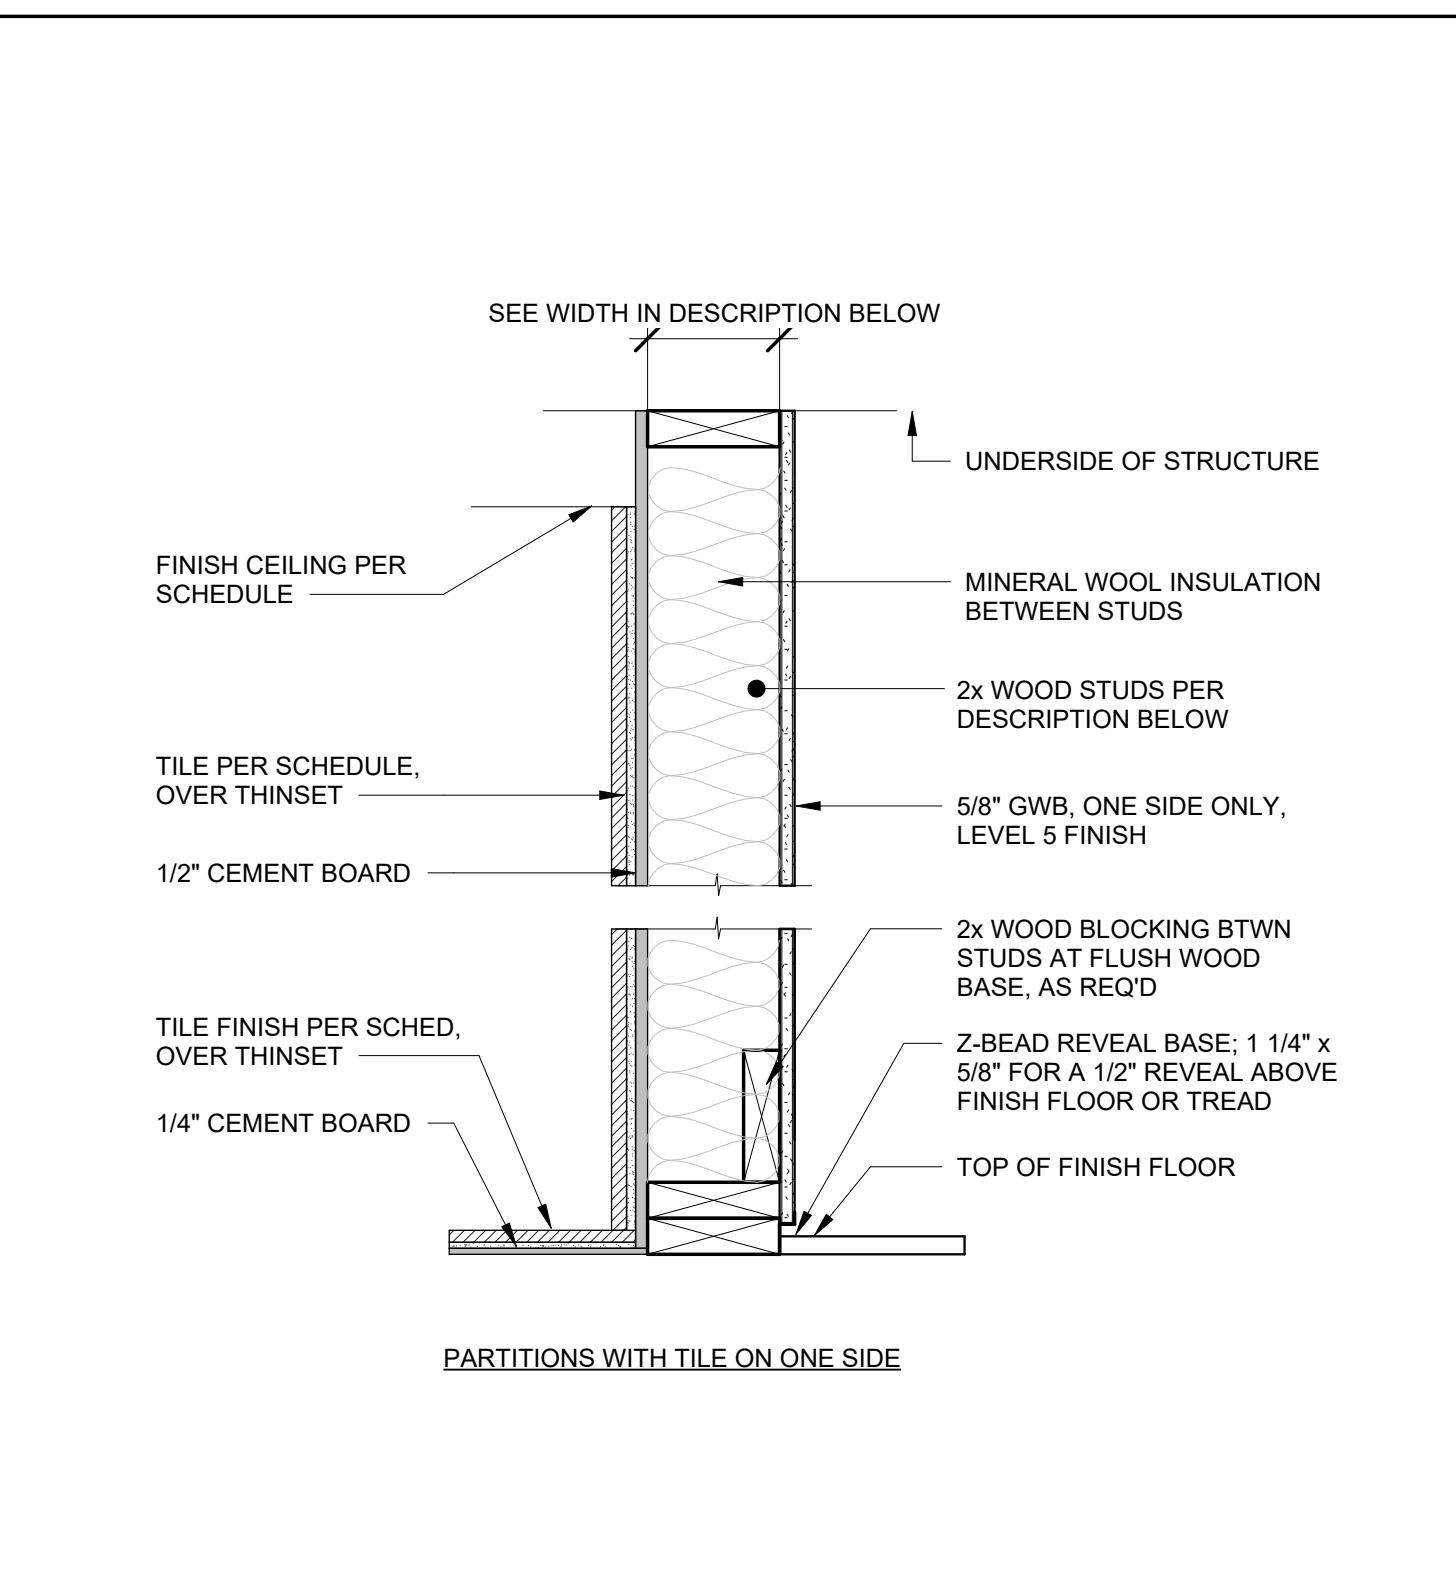
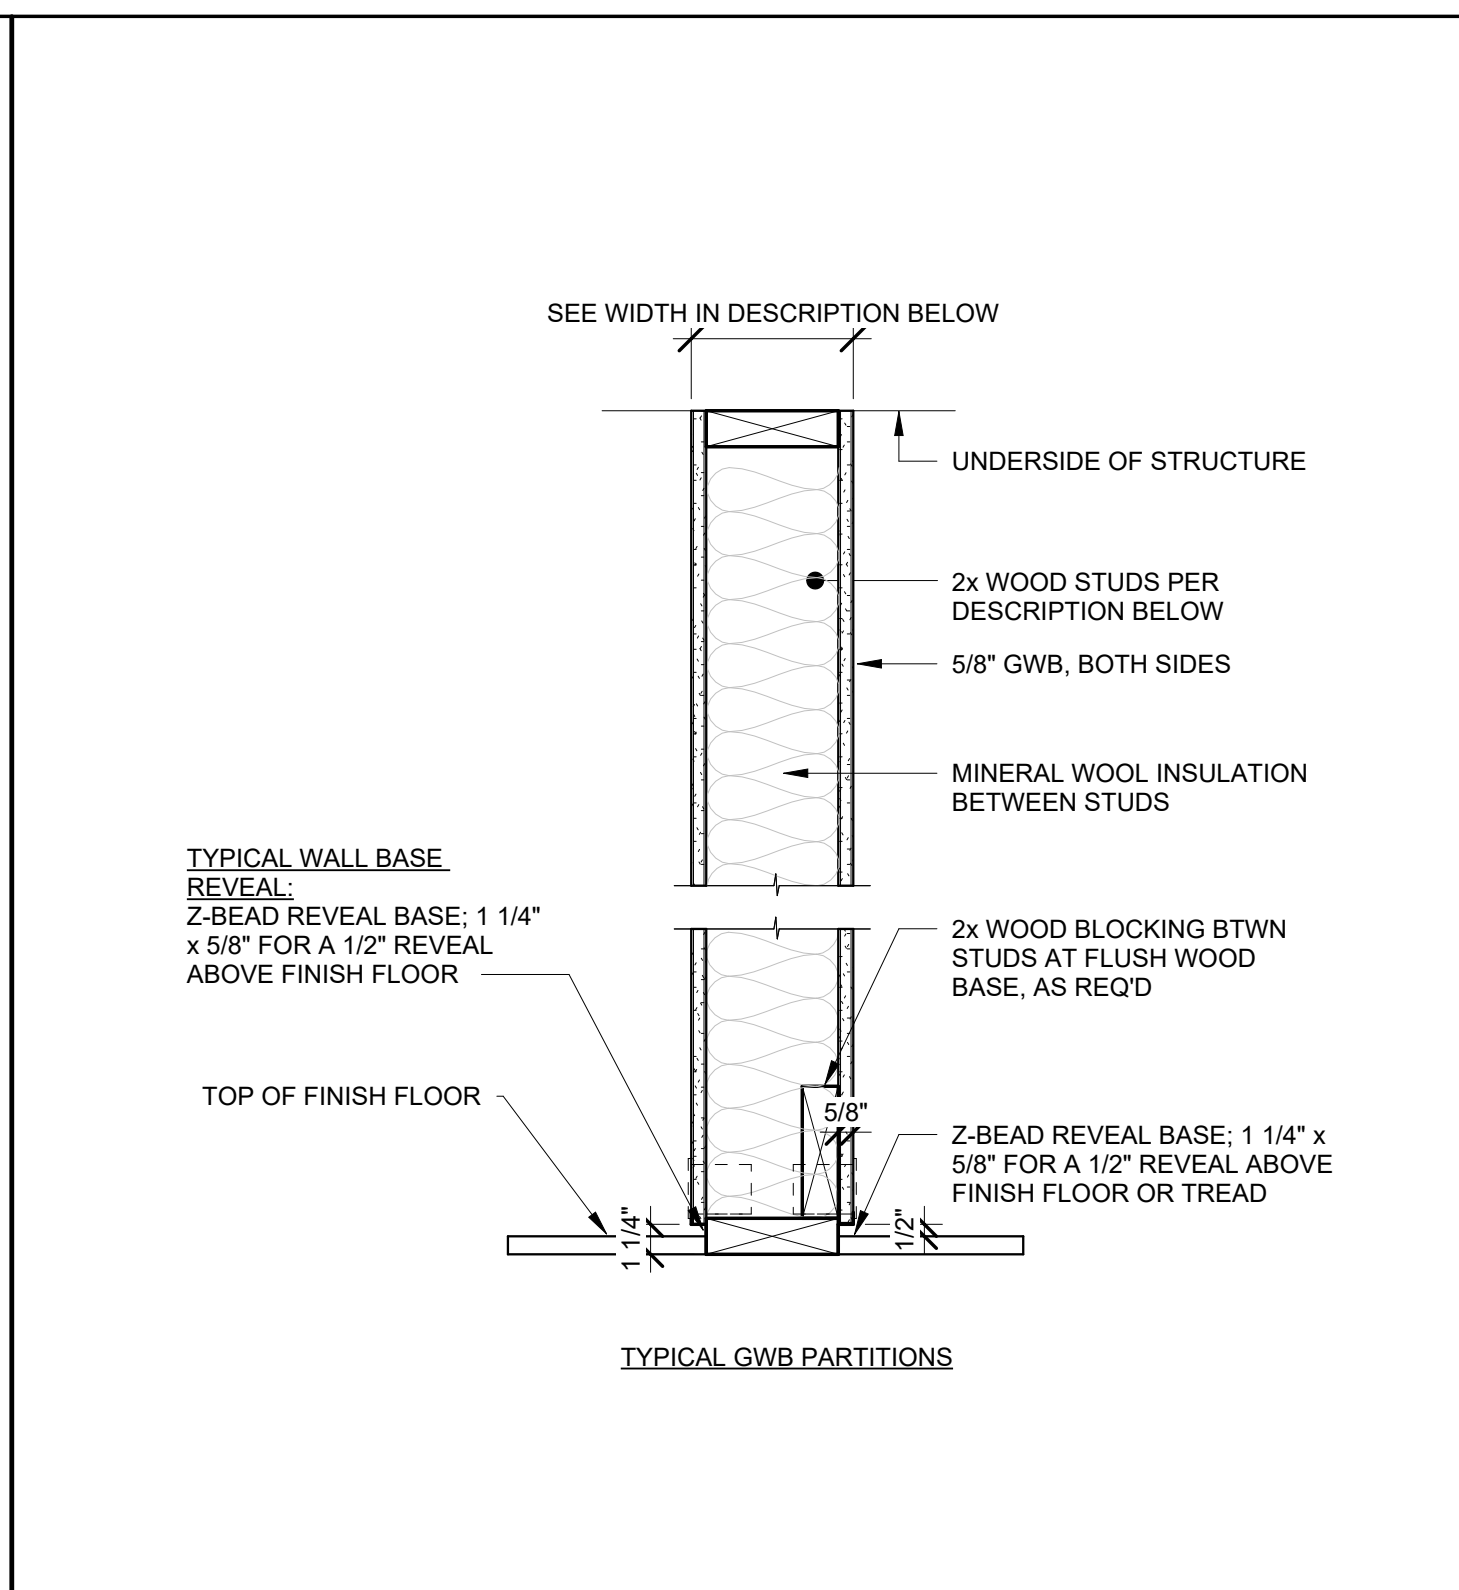
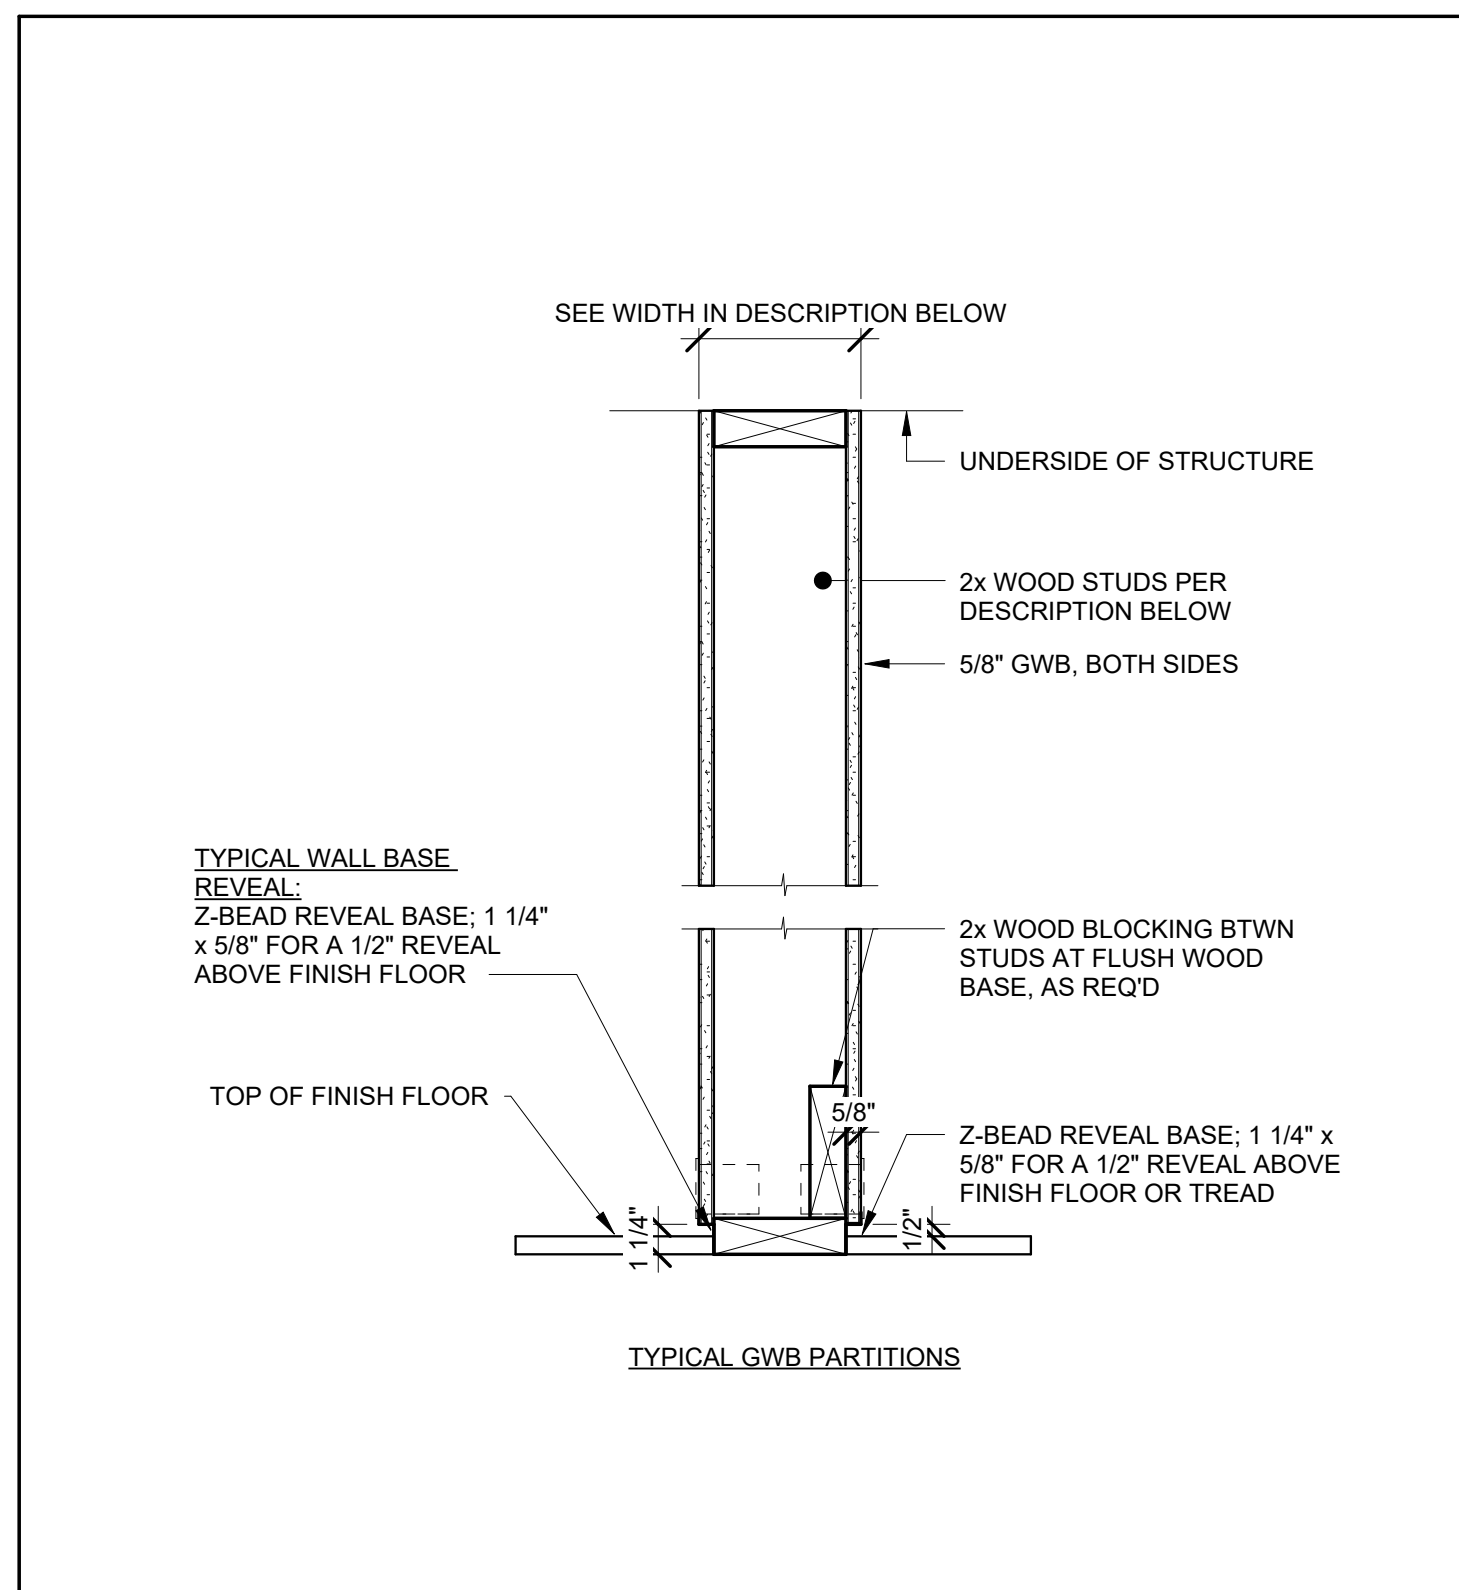


- A4 2x4 WOOD STUDS @ 16" O.C. W/ 5/8" GWB BOTH SIDES, LEVEL 5 FINISH TOTAL WIDTH: 4 3/4"
- A6 2x6 WOOD STUDS @ 24" O.C. W/ 5/8" GWB BOTH SIDES, LEVEL 5 FINISH TOTAL WIDTH: 6 3/4"

- B4 SAME AS A4 BUT ADD ACOUSTICAL BATTS INSULATION BETWEEN STUDS TOTAL WIDTH: 4 3/4"
- B6 SAME AS A6 BUT ADD ACOUSTICAL BATTS INSULATION BETWEEN STUDS TOTAL WIDTH: 6 3/4"

- C4 2x4 WOOD STUDS @ 16" O.C. W/ FULL HEIGHT TILE ON ONE SIDE TOTAL WIDTH: <5 5/8"
- C6 2x6 WOOD STUDS @ 16" O.C. W/ FULL HEIGHT TILE ON ONE SIDE TOTAL WIDTH: <7 5/8"

- D6 WOOD STUDS W/ 5/8" GWB BOTH SIDES, LEVEL 5 FINISH TOTAL WIDTH: 6 3/4"

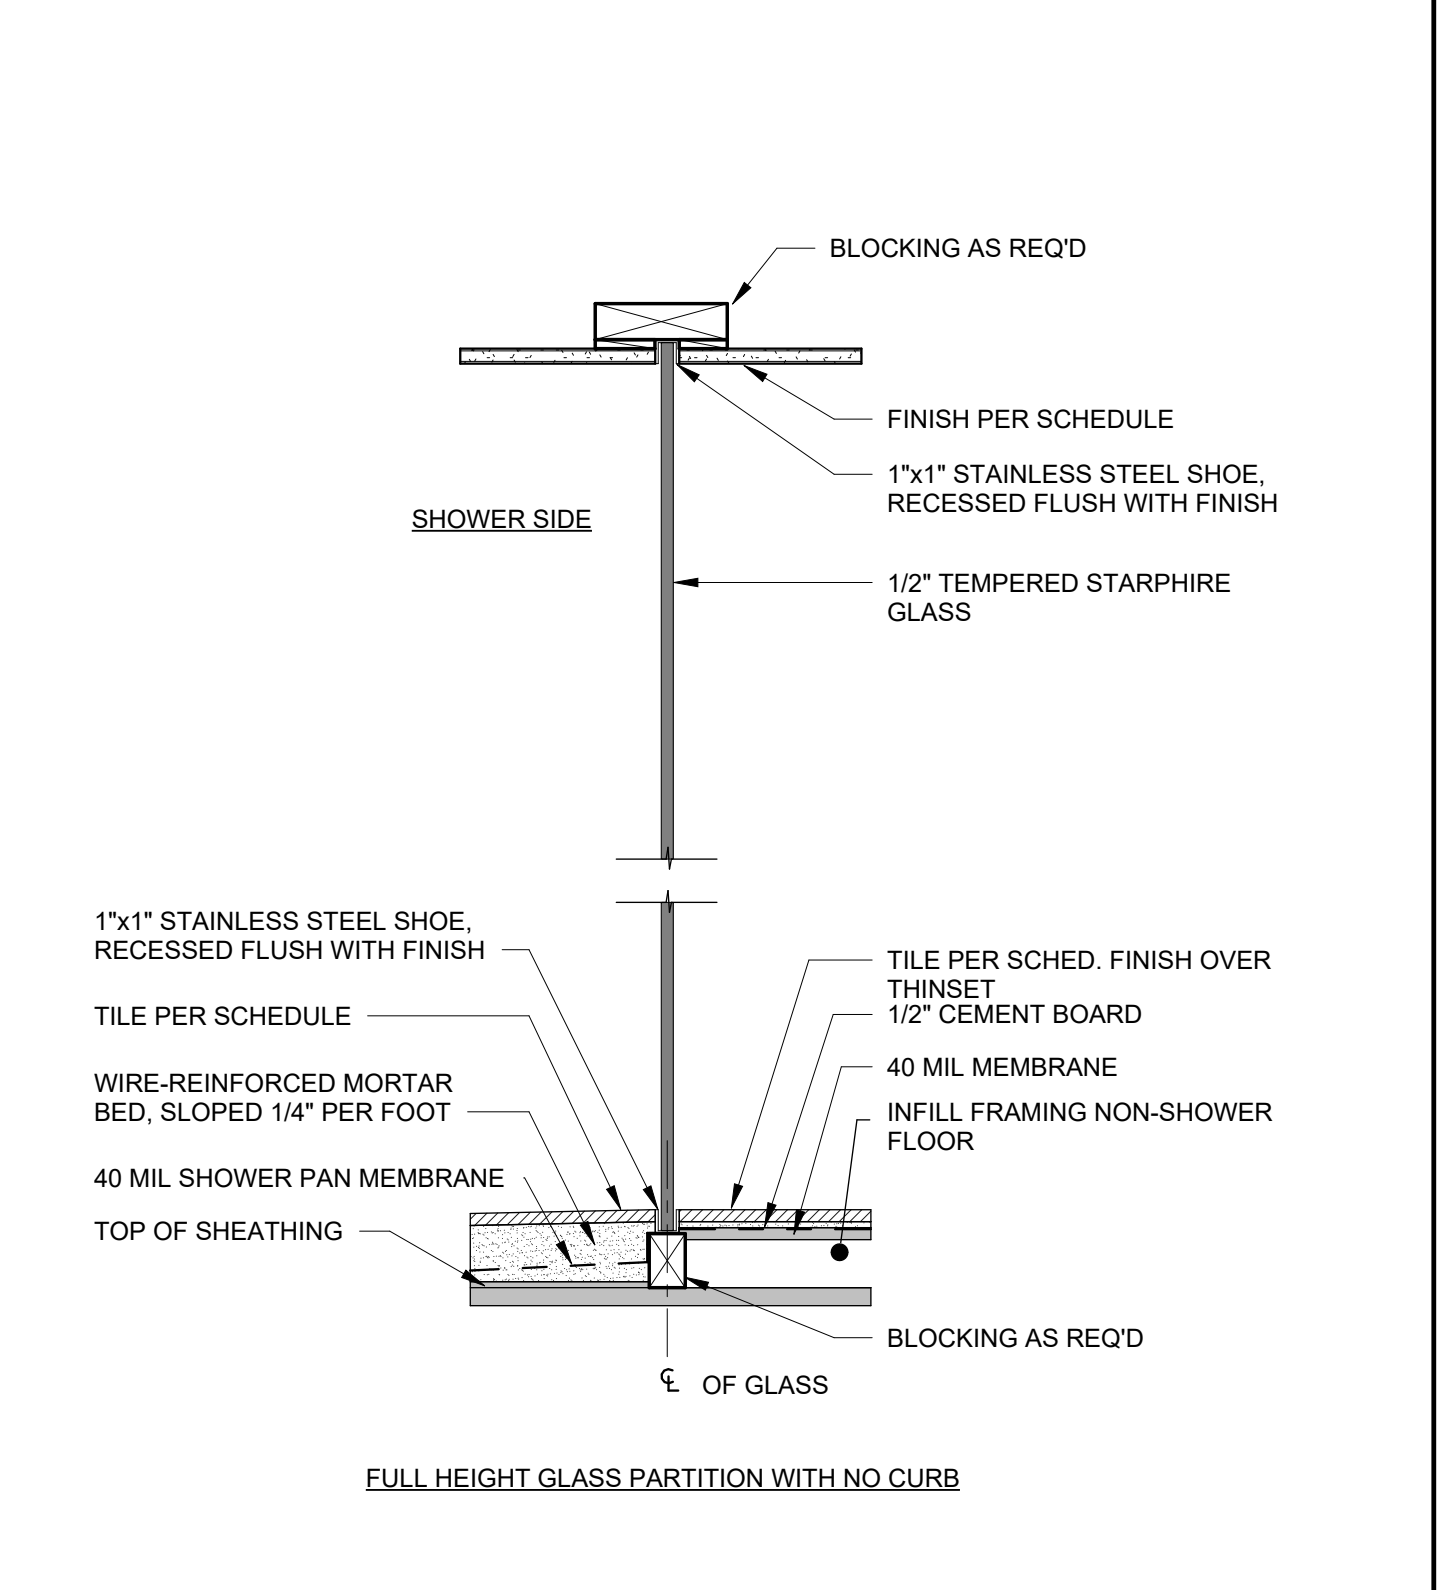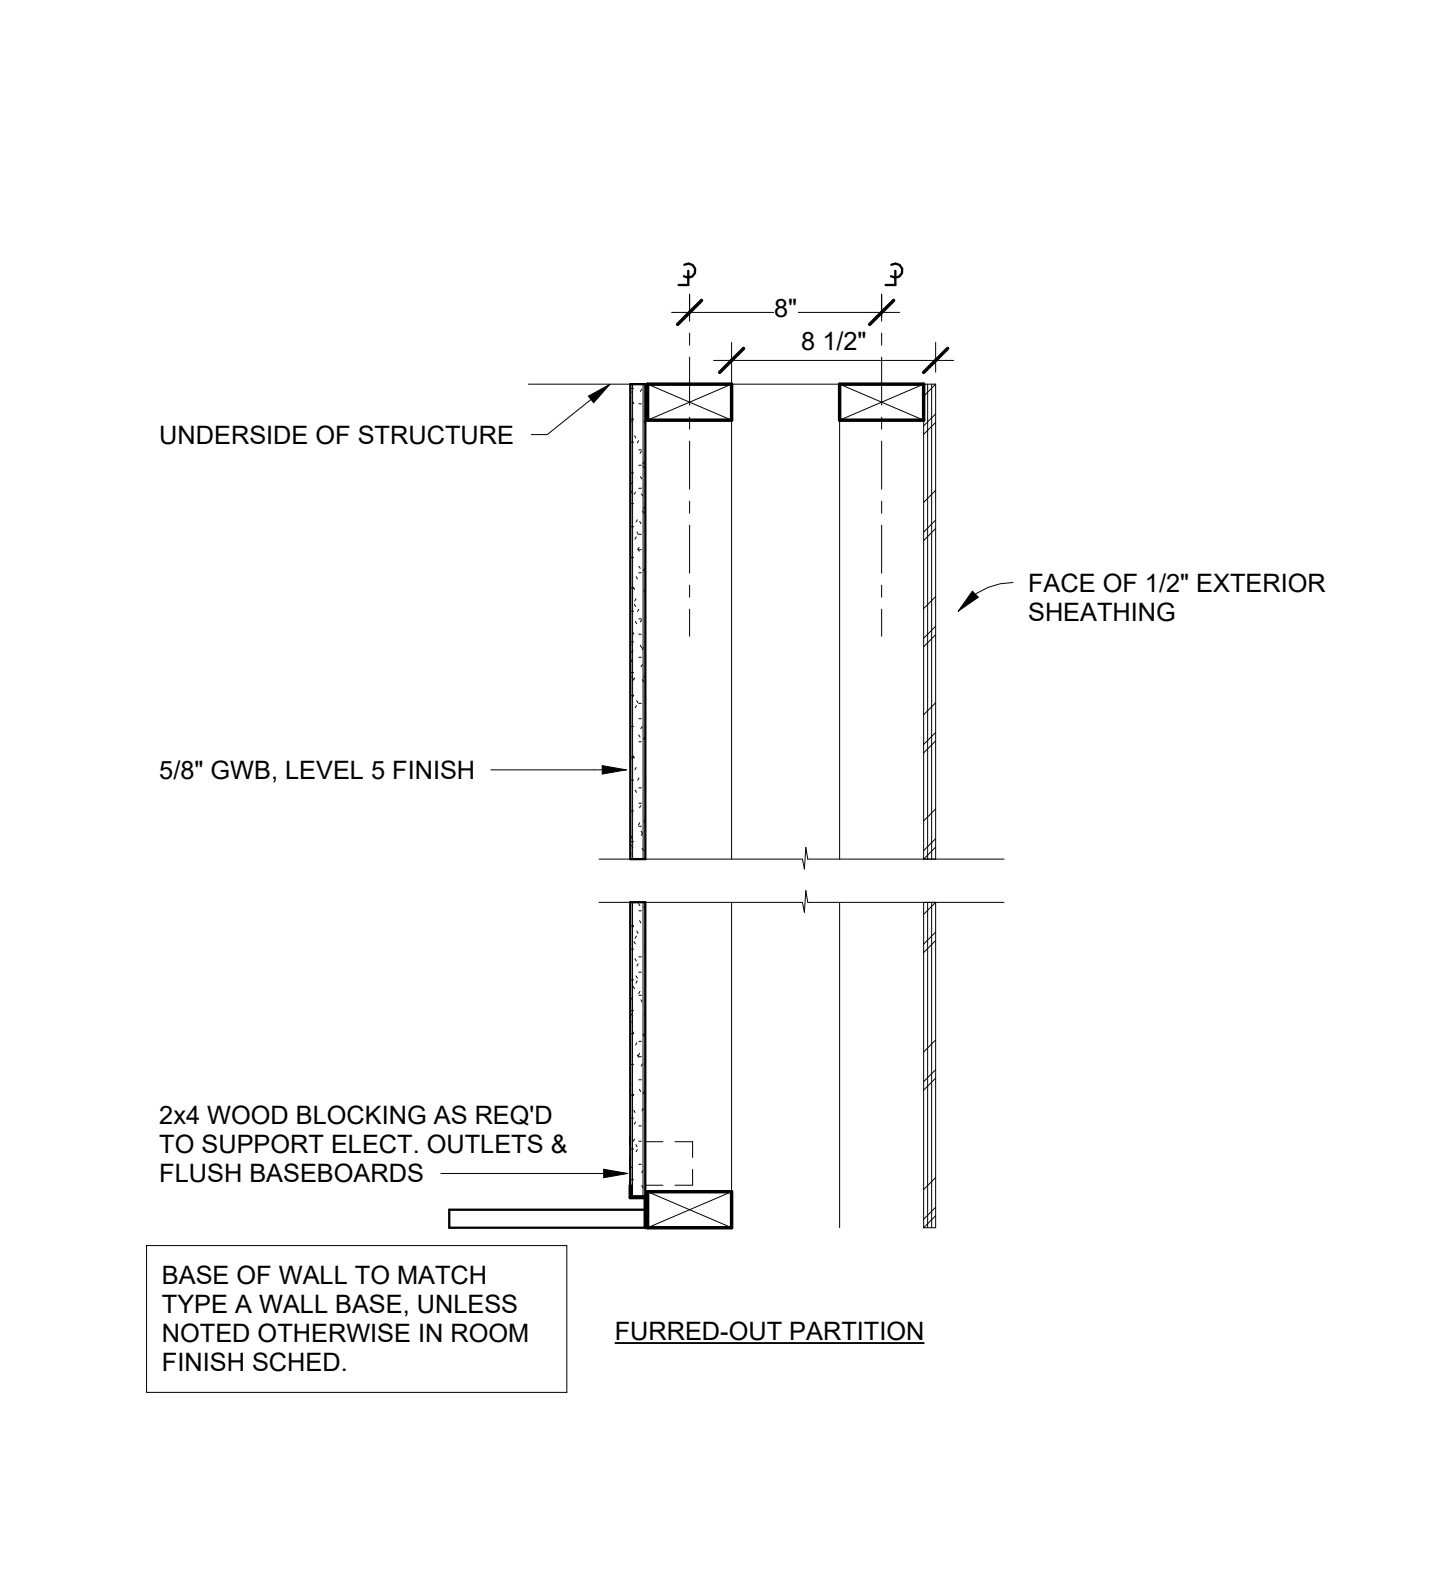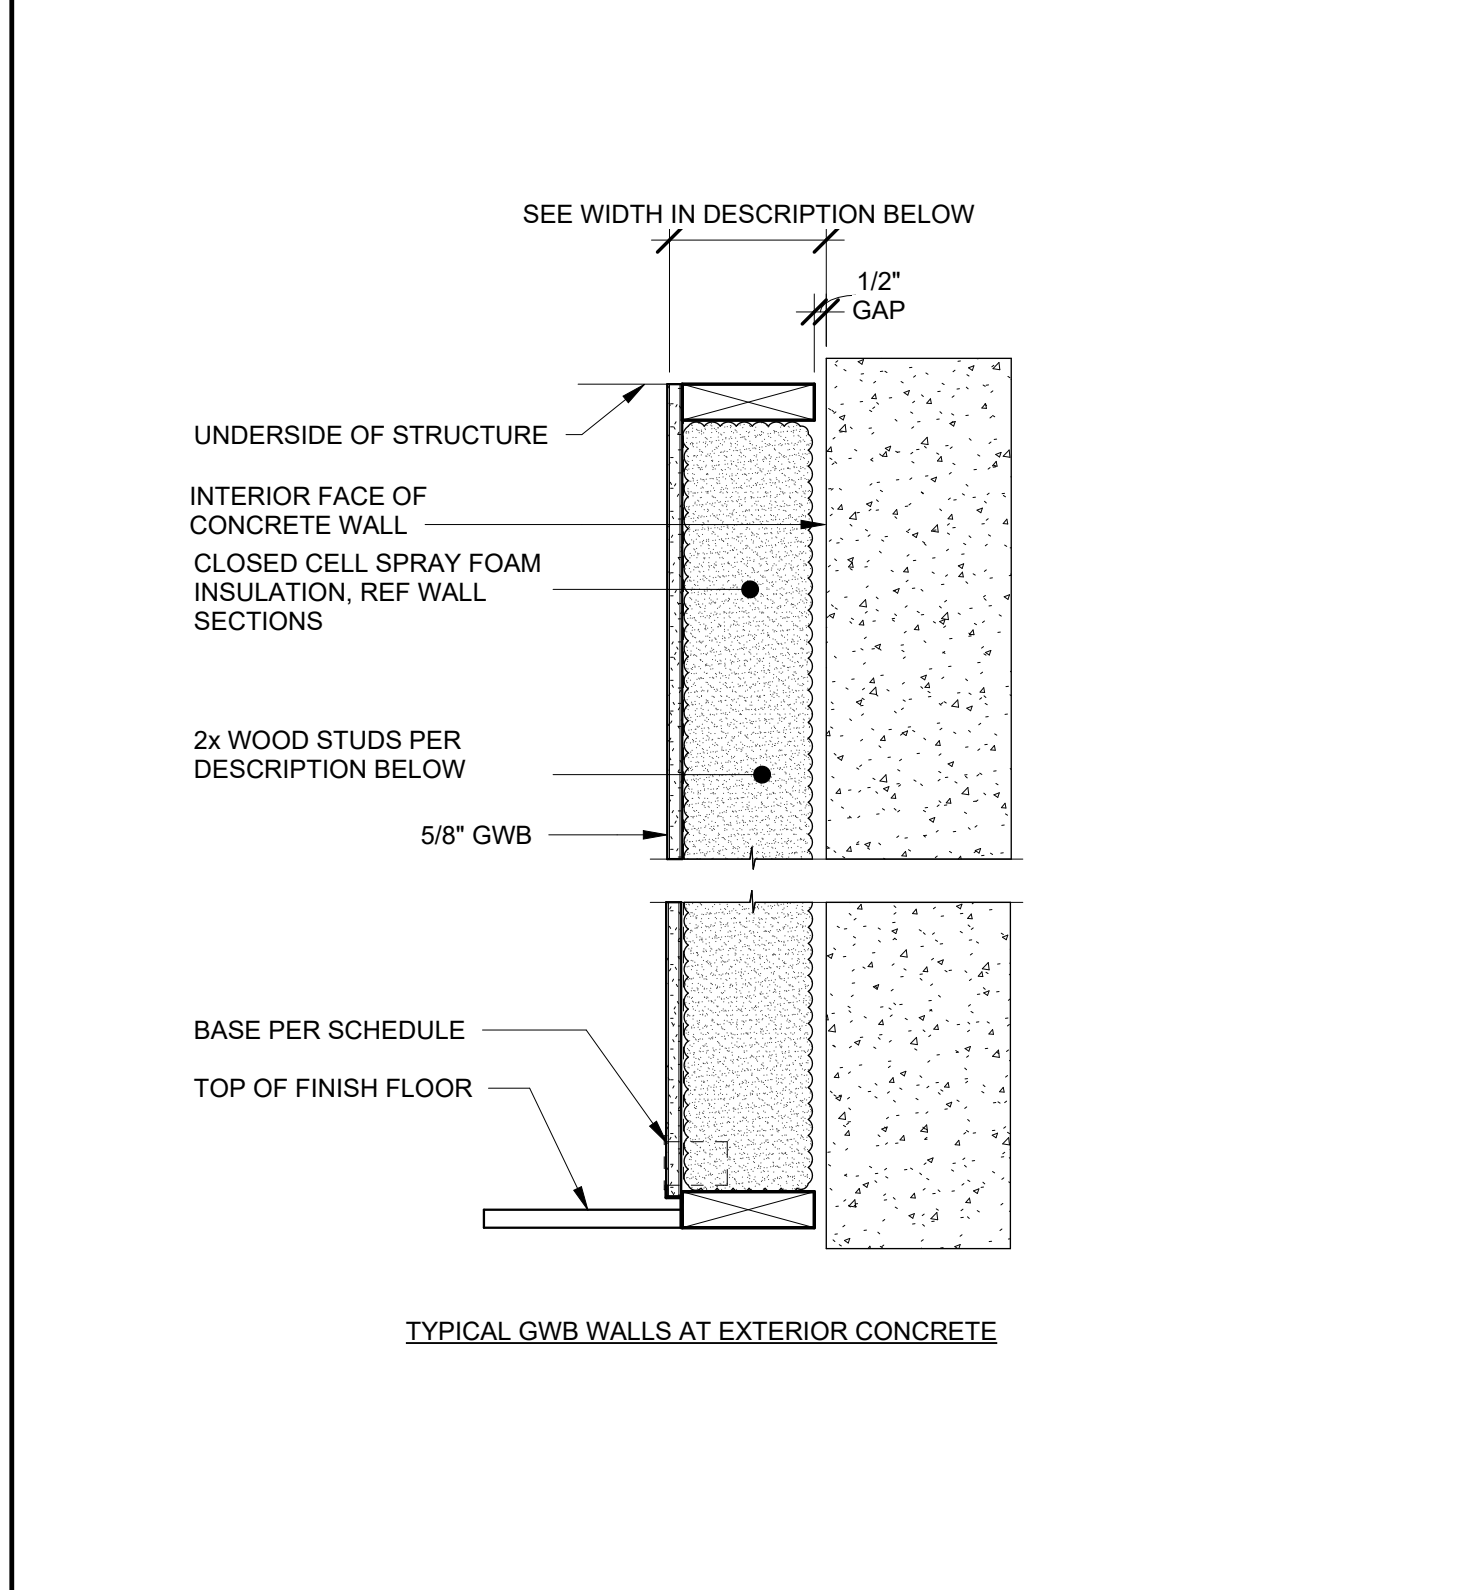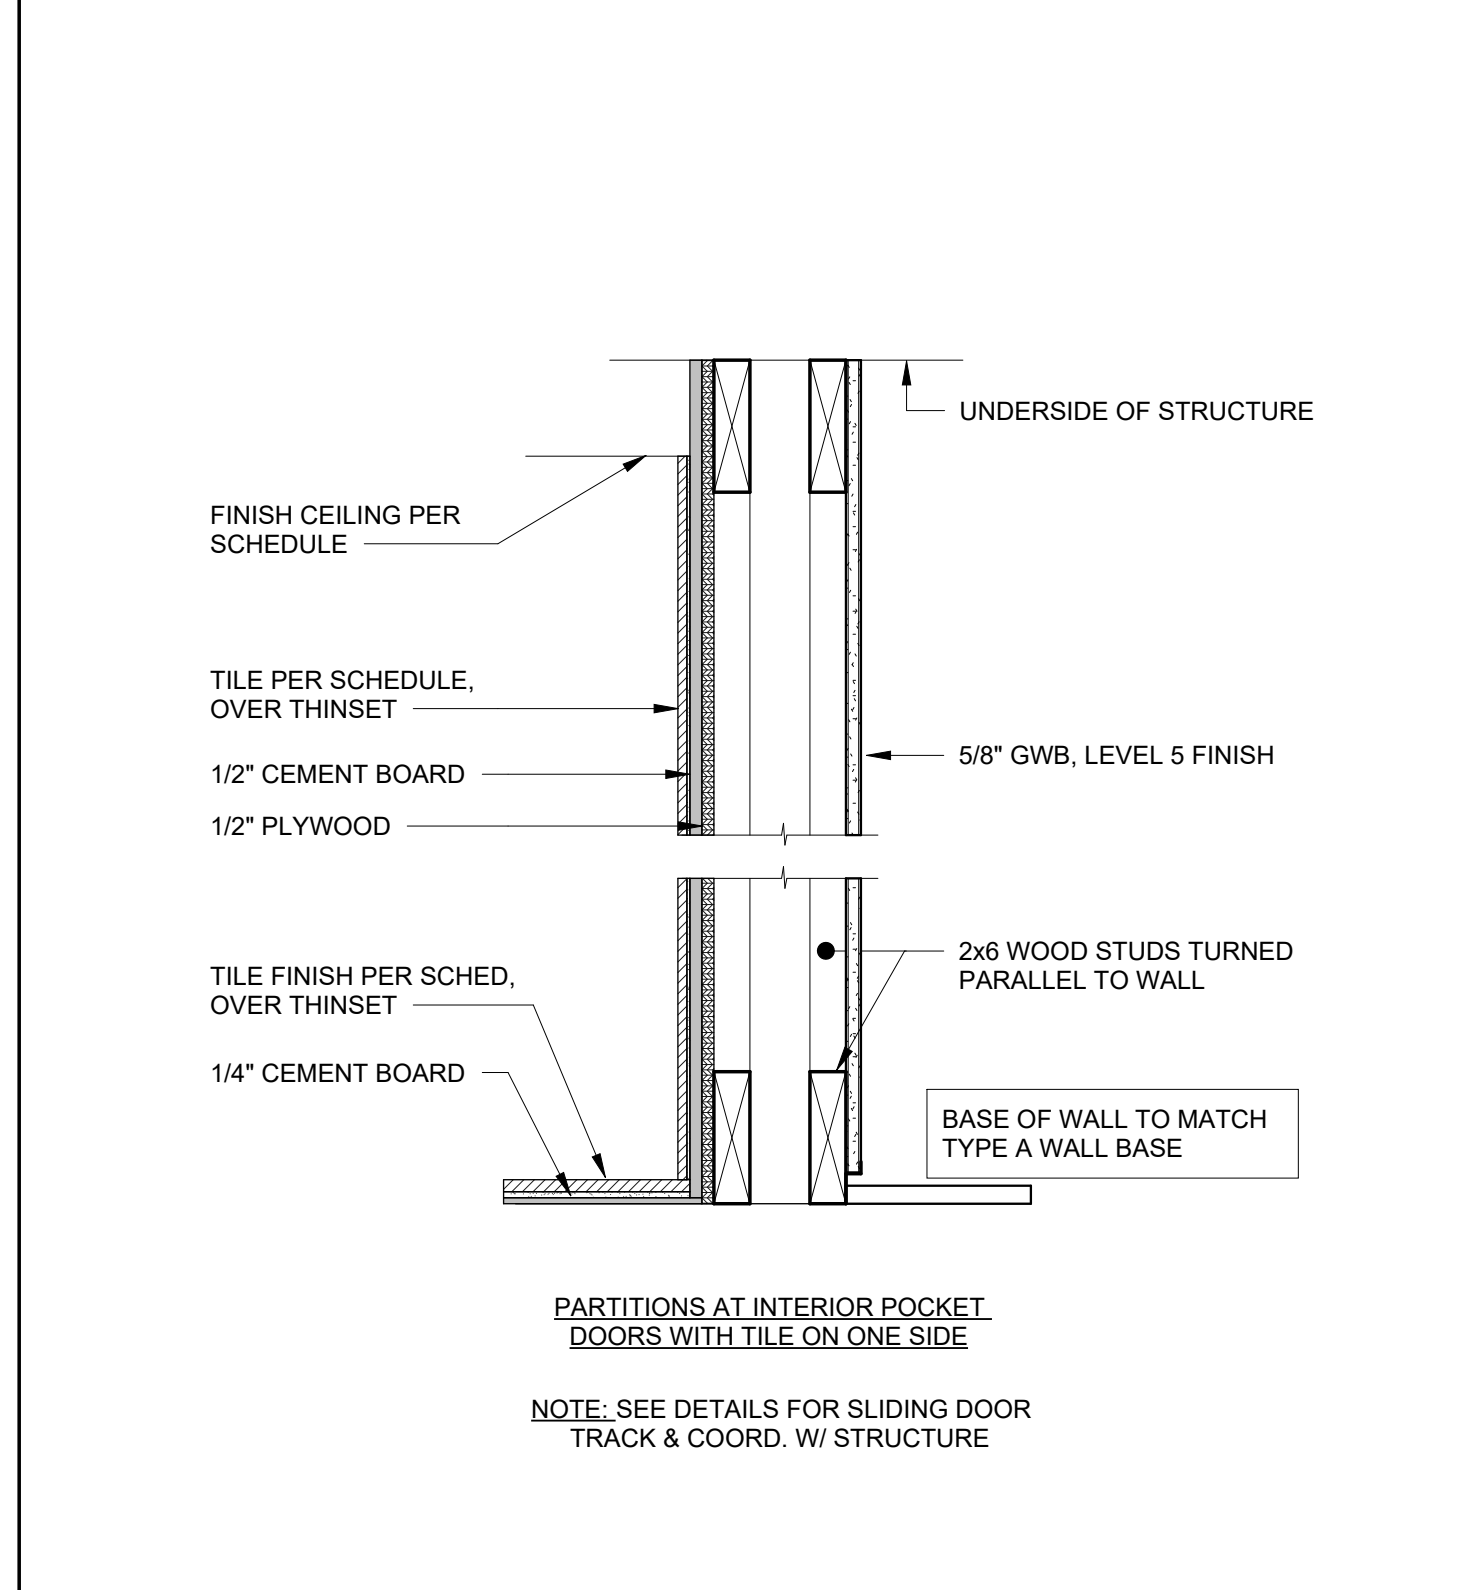


- E6 2x6 WOOD STUDS @ 24" O.C. W/ FULL HEIGHT TILE ON ONE SIDE

- F4 2x4 WOOD STUDS @ 16" O.C. W/ 5/8" GWB, LEVEL 5 FINISH TOTAL WIDTH FROM FACE OF CONCRETE: 4 1/8"
- F5 SAME AS F4, BUT REPLACE GWB WITH 1/2" CEMENT BOARD AND TILE FINISH OVER THINSET & EXTEND SHOWER PAN MEMBRANE UP WALL MIN. 6" TOTAL WIDTH FROM FACE OF CONCRETE: 4 1/2"

- F7 2x4 WOOD STUDS @ 24" O.C. AND 2x4 @ 16" O.C. W/ 5/8" GWB ON INSIDE, LEVEL 5 FINISH, EXTERIOR FINISH AS PER DRAWINGS

- G 1/2" TEMPERED STARPHIRE (LOW-IRON) GLASS PARTITION, WITH RECESSED SUPPORTS AT TOP AND BOTTOM

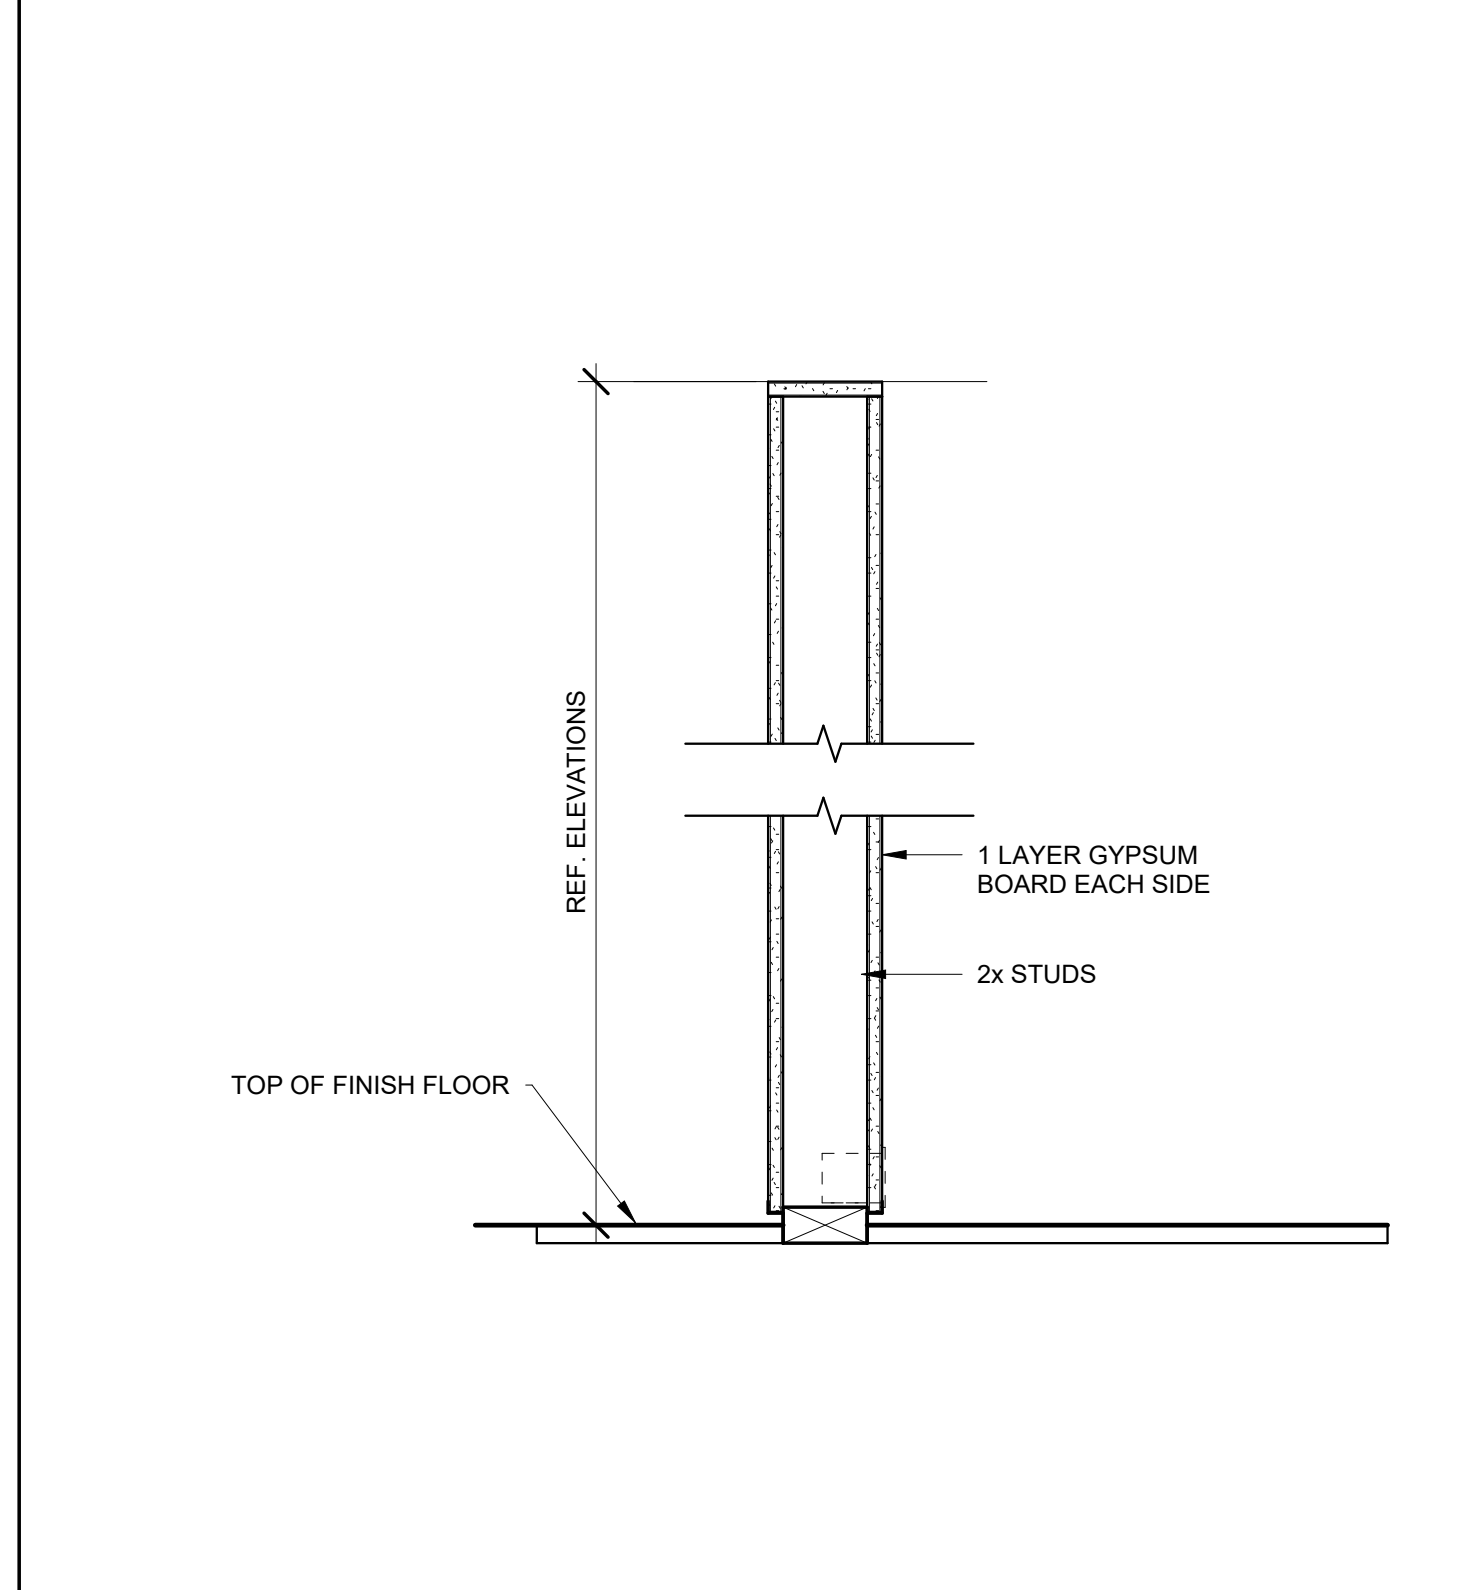

- H PARTIAL HEIGHT PARTITION

REVISION HISTORY

NO.	DESCRIPTION	DATE


PERMIT REVISION

DATE:	AUG 18, 2023
SCALE:	1 1/2" = 1'-0"
DRAWN BY:	CJ
CHECKED BY:	CR


SHEET TITLE PROJECT #: 40035

INTERIOR PARTITION TYPES


A7.00

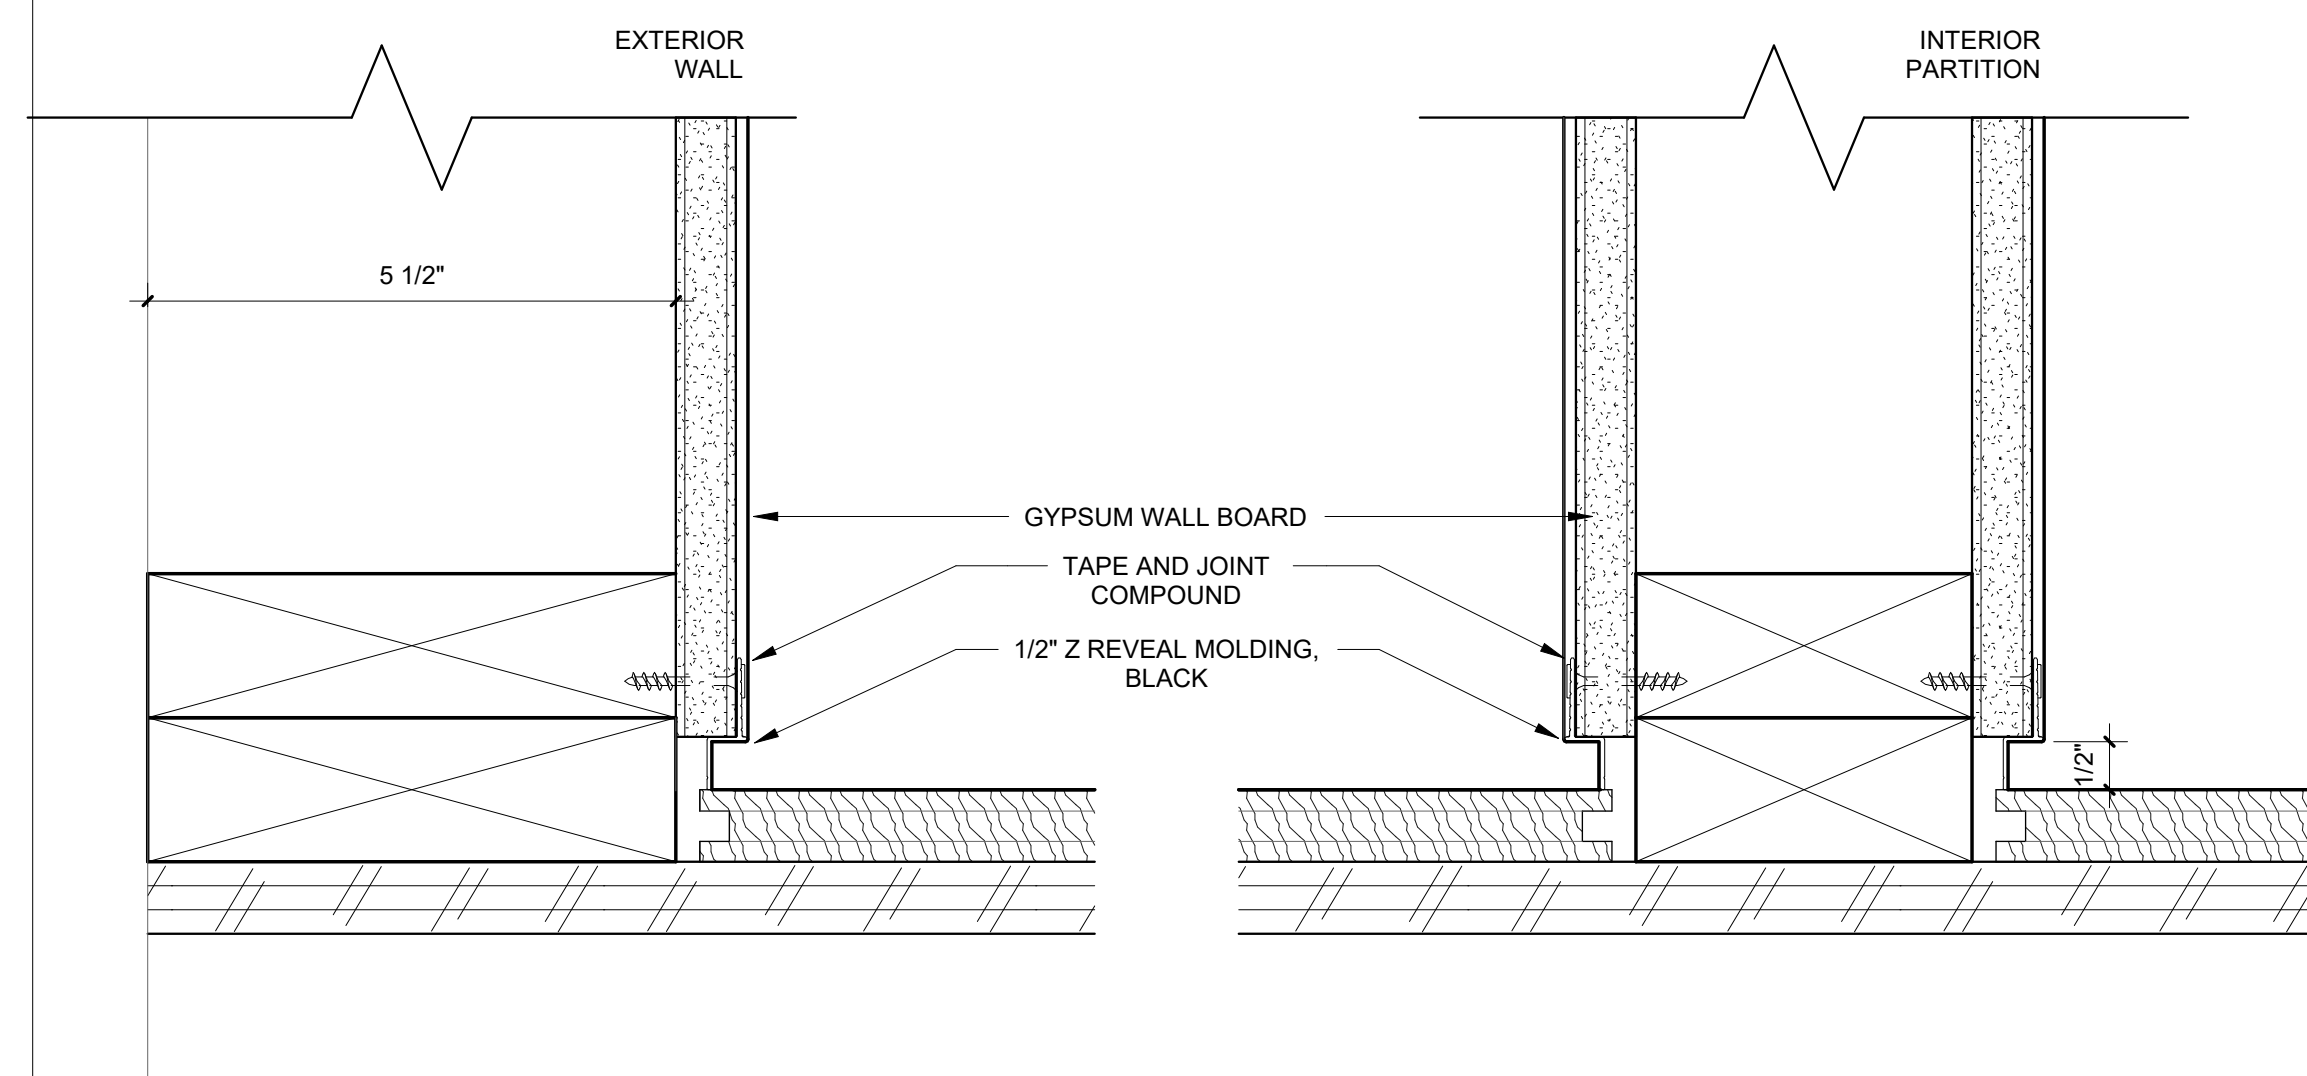


4 WALL BASE DETAIL - REVEAL 1/2"
 6" = 1'-0"

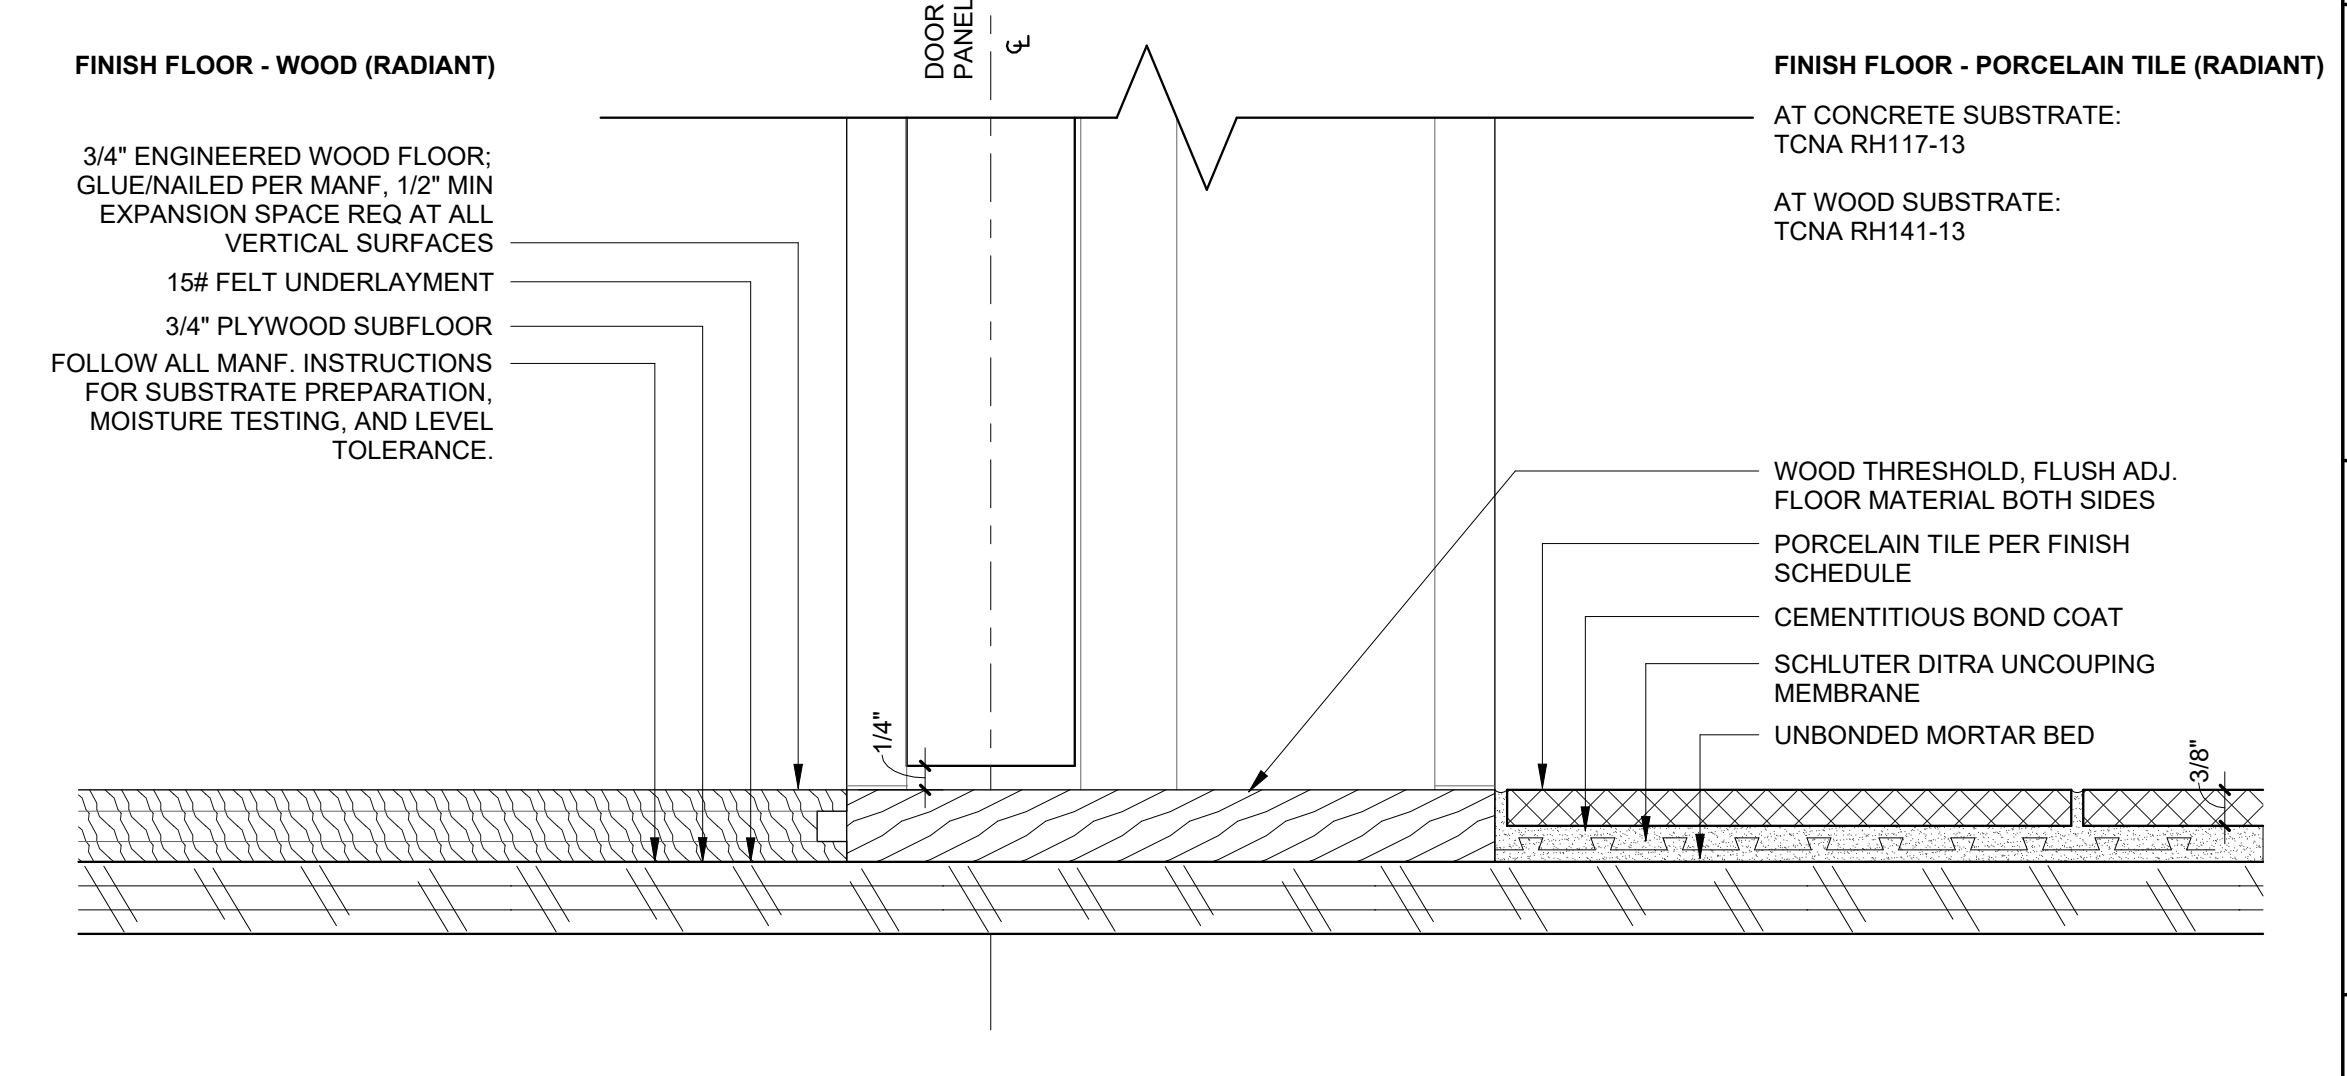


3 FLOOR TRANSITION - WOOD/TILE
 6" = 1'-0"

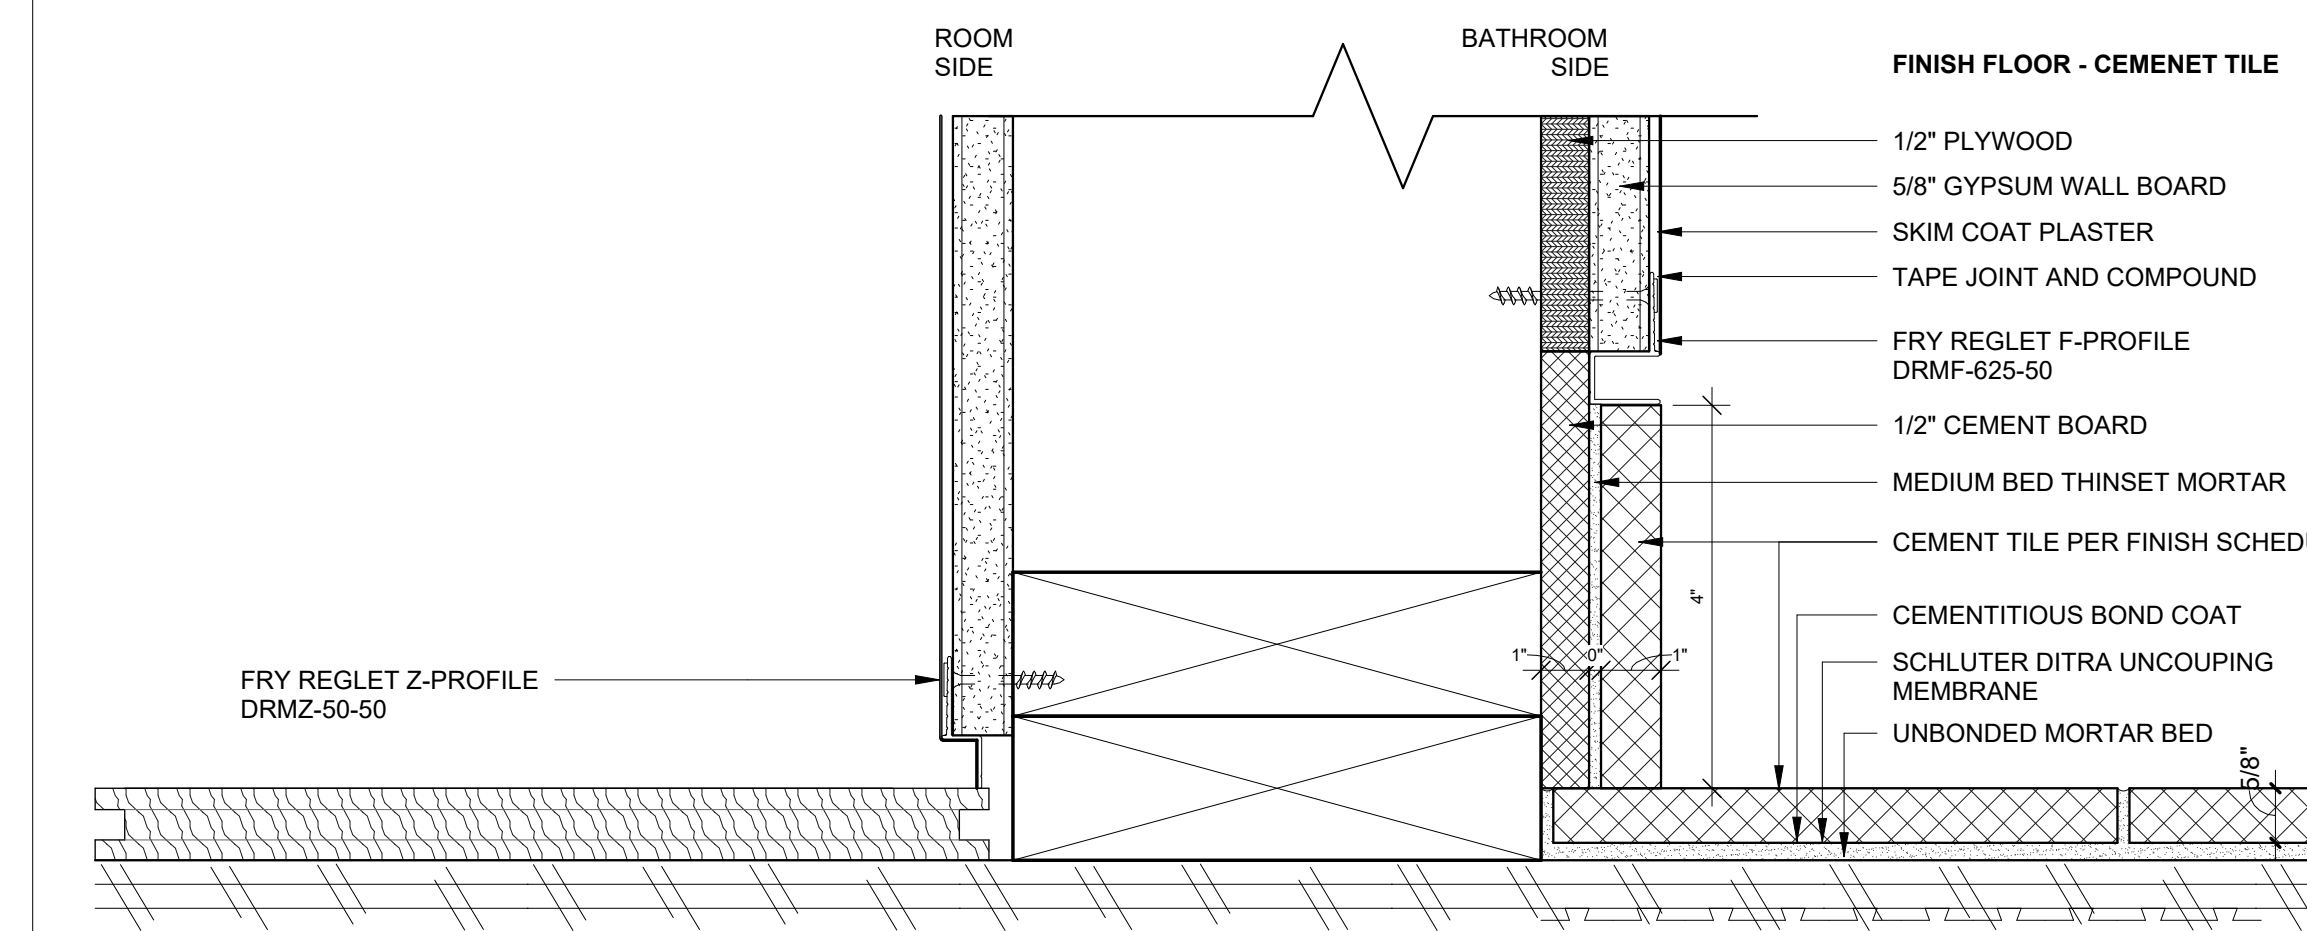


5 WALL BASE DETAIL - REVEAL 1/2" - CEMENT TILE BASE
 6" = 1'-0"

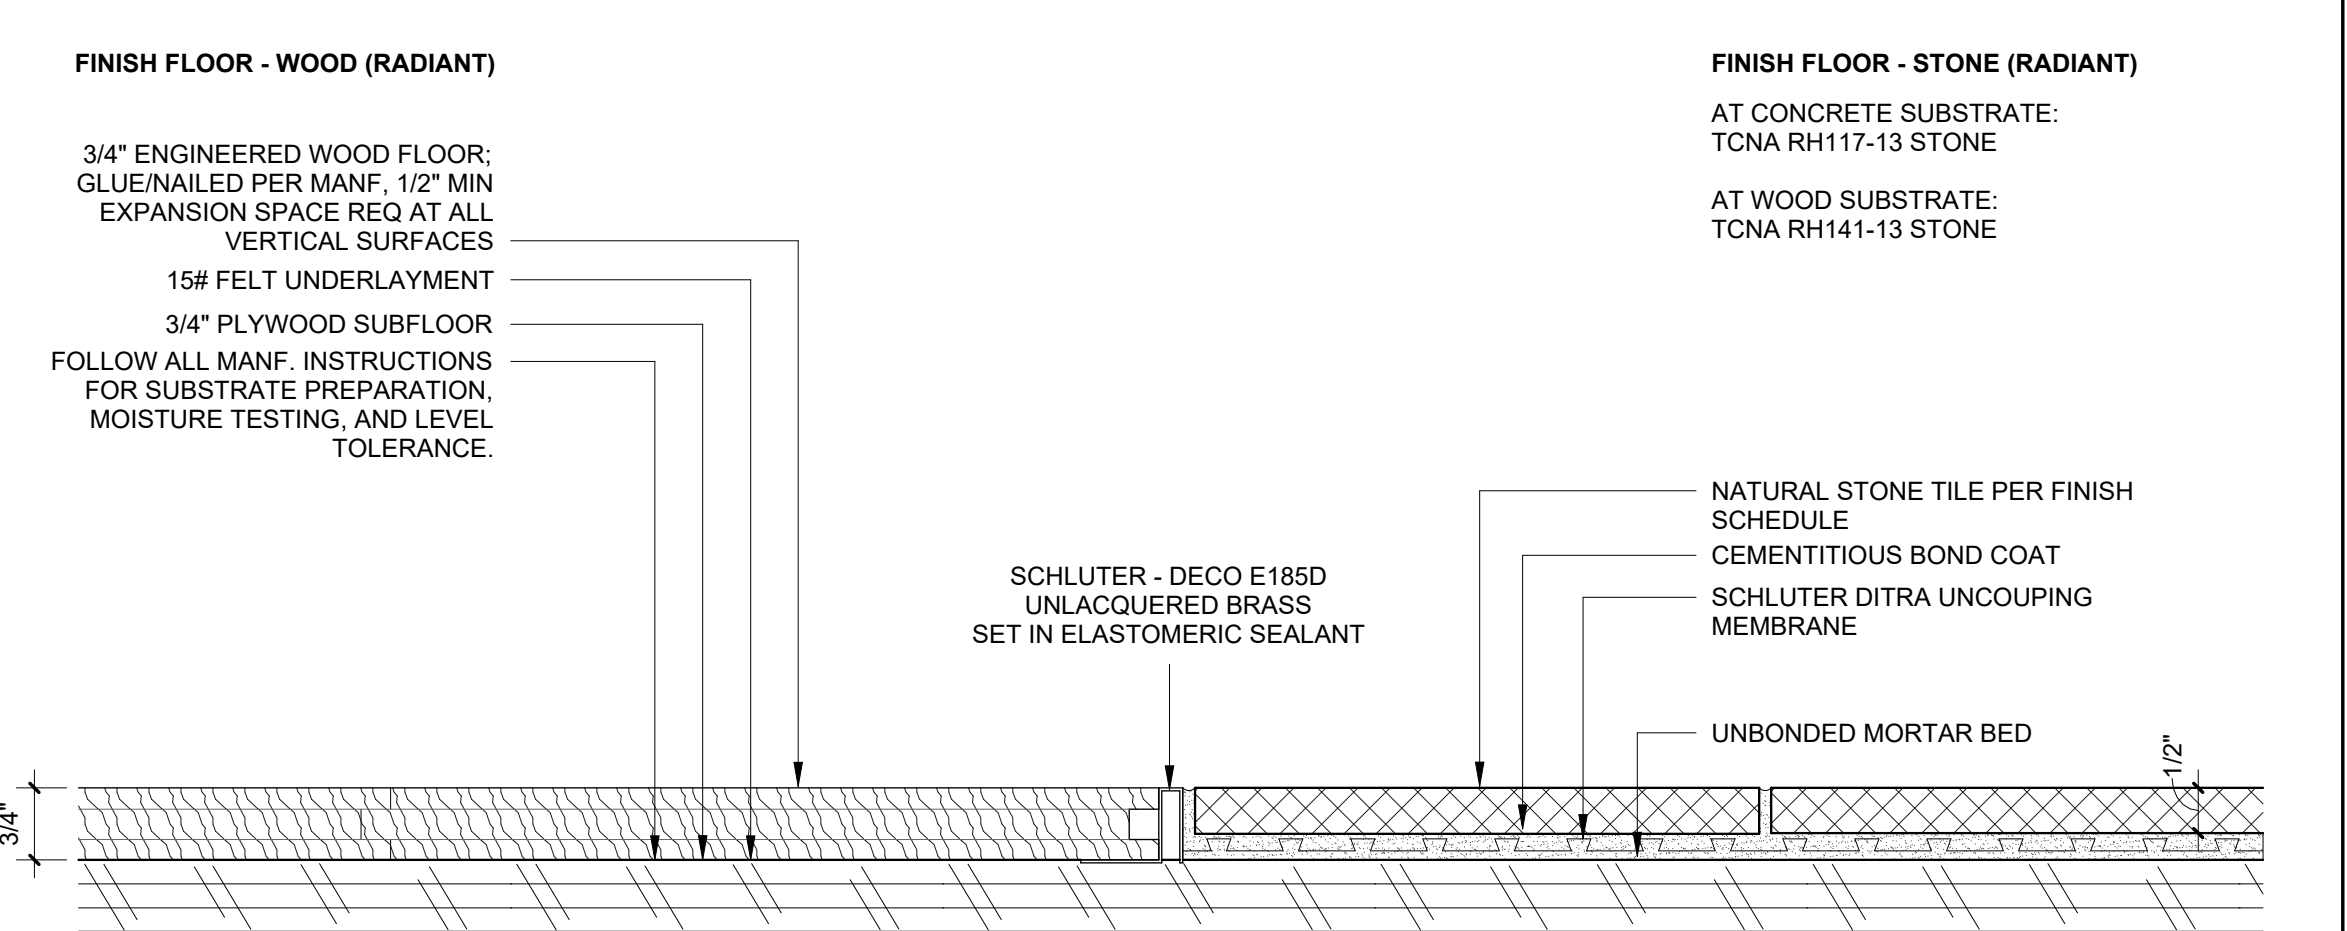

2 FLOOR TRANSITION - WOOD/STONE
 6" = 1'-0"

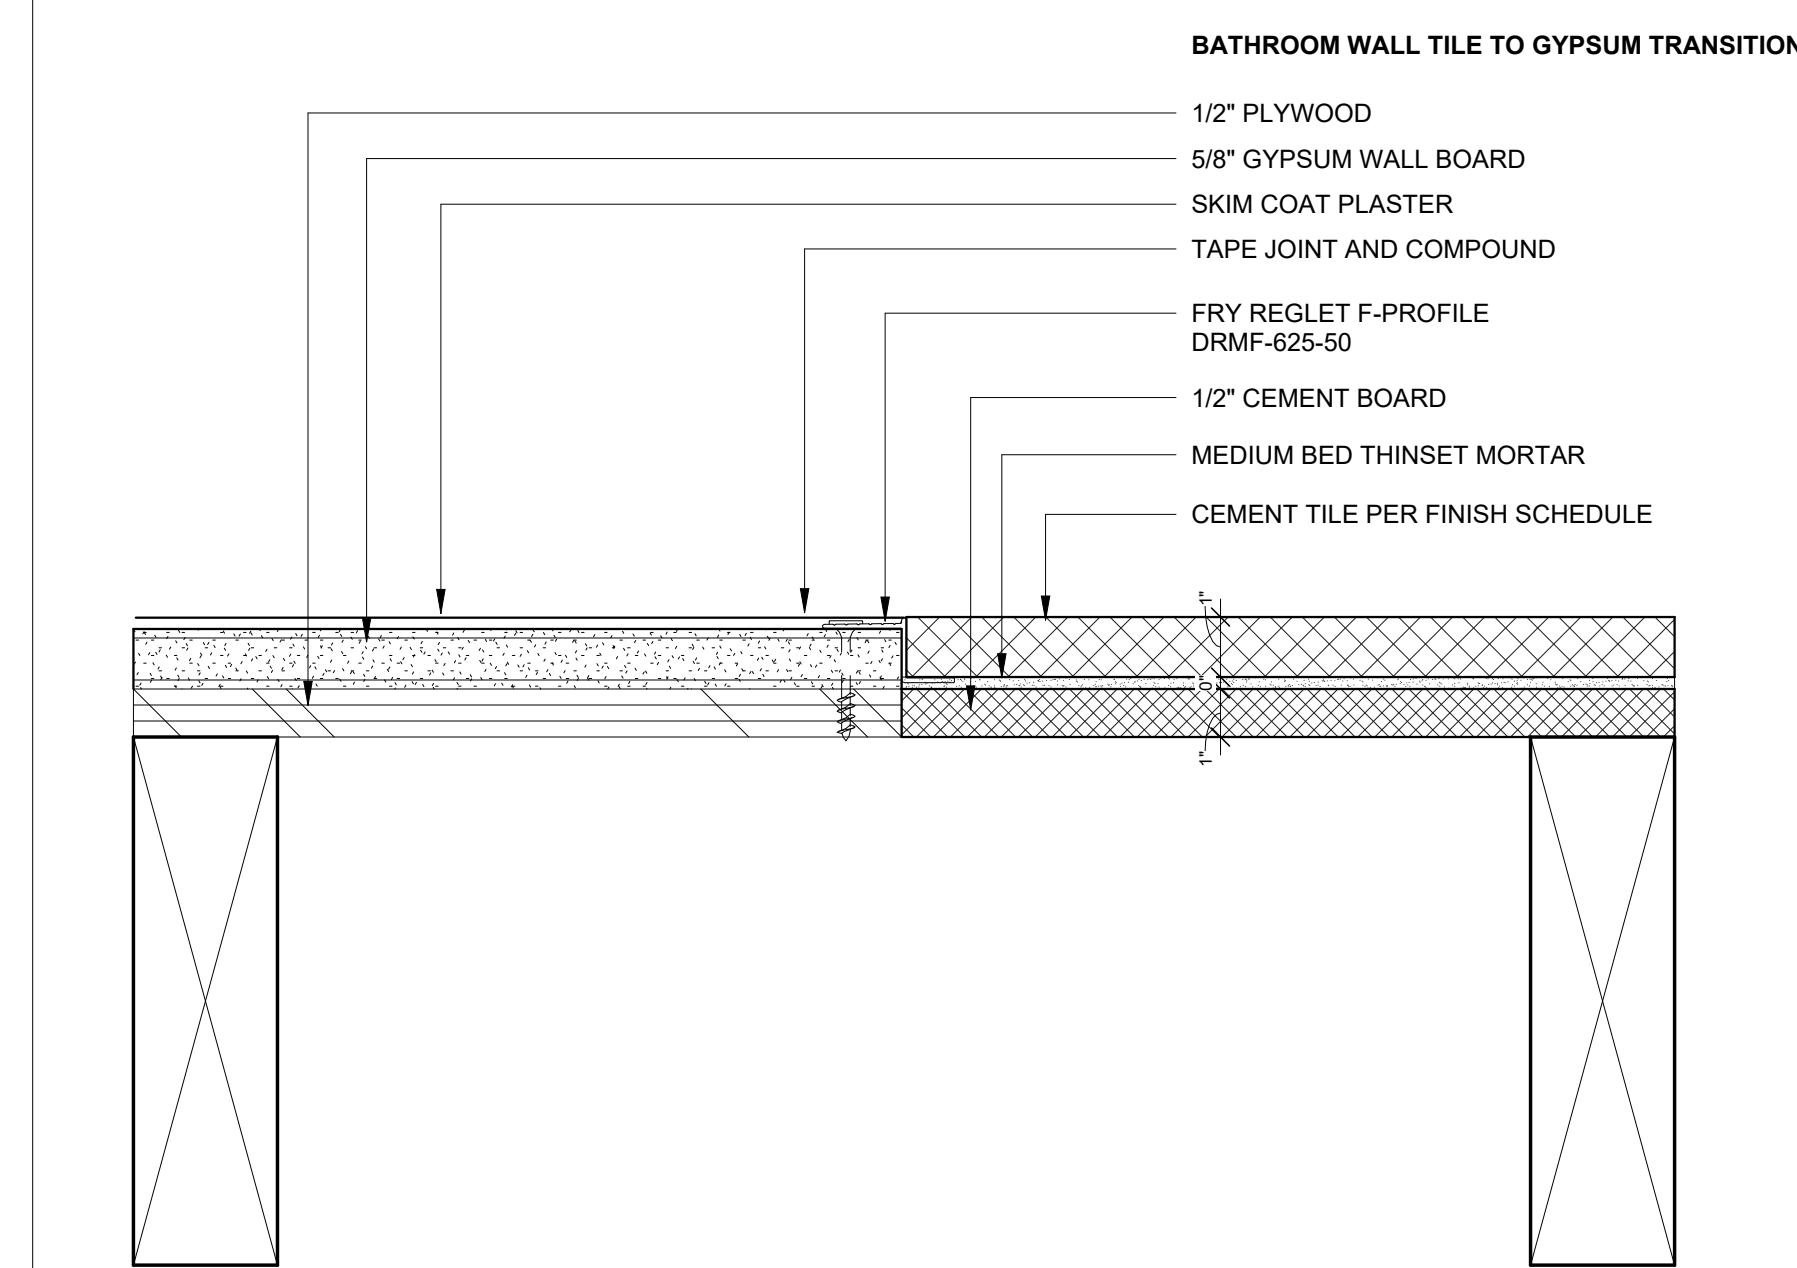

6 WALL TILE TRANSITION DETAIL
 6" = 1'-0"

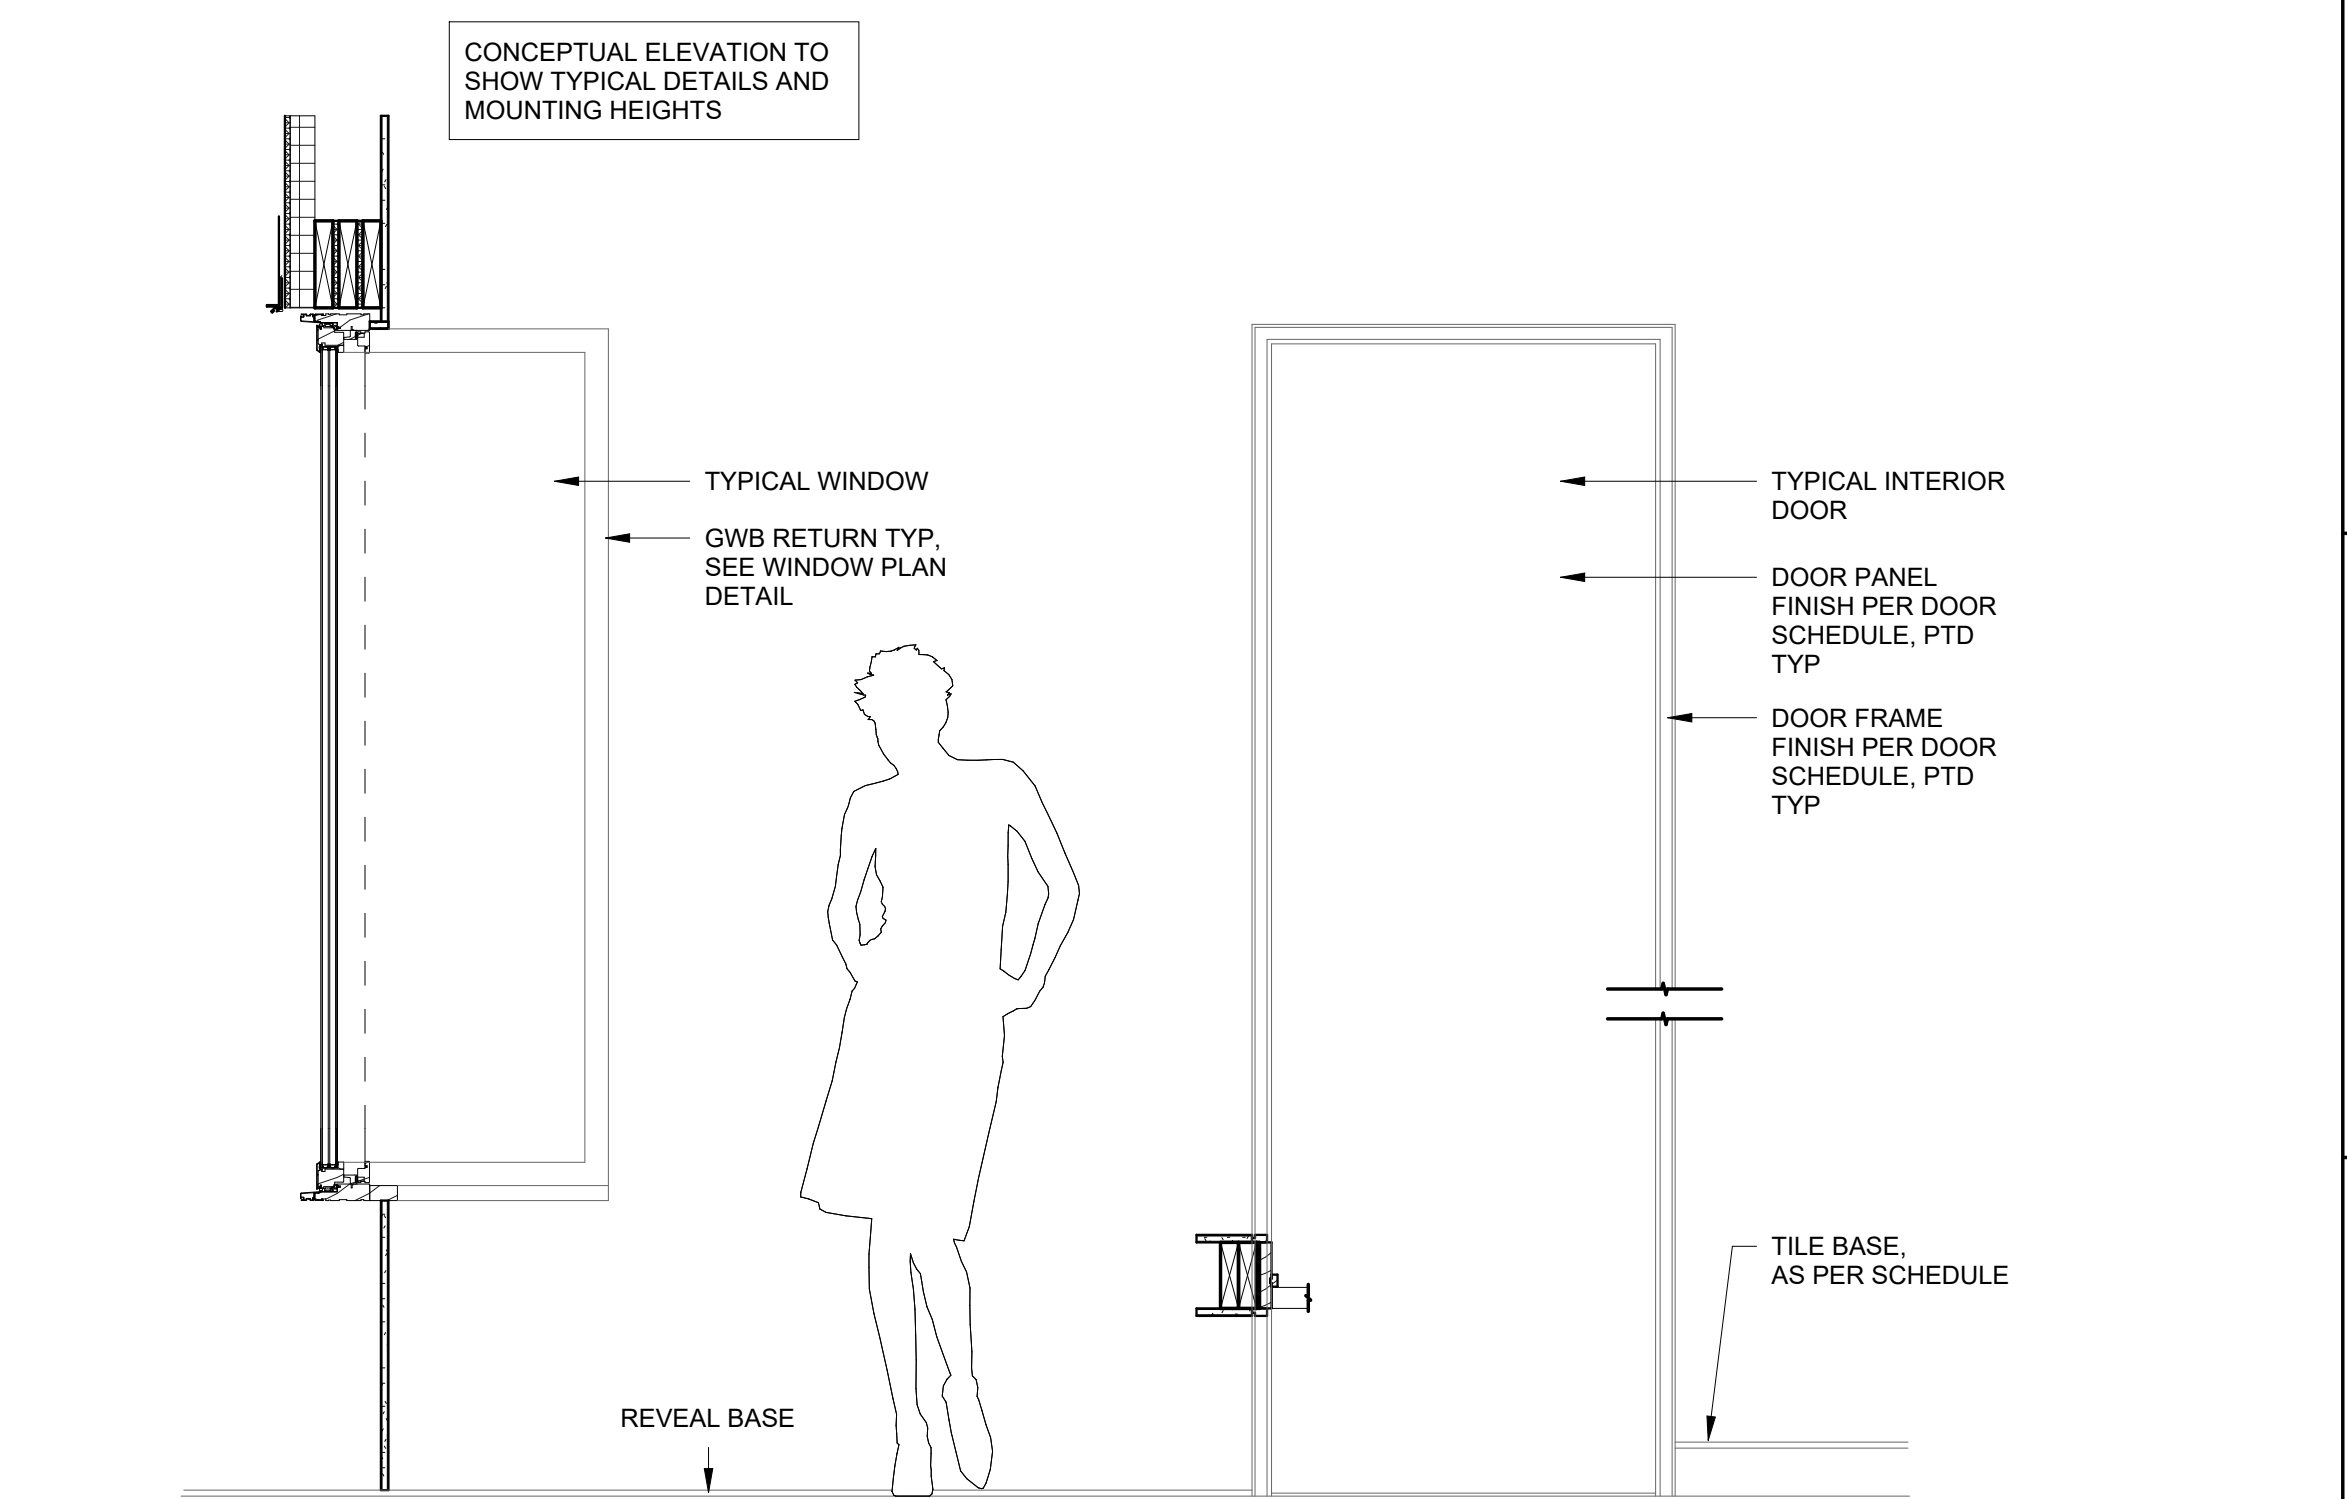

1 TYPICAL INTERIOR ELEVATION
 3/4" = 1'-0"

REVISION HISTORY		
NO.	DESCRIPTION	DATE

PERMIT REVISION	
DATE:	AUG 18, 2023
SCALE:	As indicated
DRAWN BY:	CJ
CHECKED BY:	CR

SHEET TITLE PROJECT #: 40035

INTERIOR FLOOR DETAILS