

Mayor

#### **Boston Inspectional Services Department**

#### **Planning and Zoning Division**

1010 Massachusetts Avenue, 5th Floor, Boston, MA 02118 Telephone: (617) 635-5300

#### MORE INFORMATION REQUEST LETTER

Marc Joseph
Inspector of Buildings

May 25, 2021

ALI KHIAT 16 MASON STREET HYDE PARK, MA 02136

RE: Application #: ALT1174348

Location: 16 Mason ST, Ward 18

Zoning District: Hyde Park Neighborhood, 2F-5000

Purpose: Add a bedroom and bathroom to unit one and unit two. [ePlan]

The following information shall be provided to Inspectional Services Department to complete the Building Permit Plan Review:

#### 1. Supporting Documents:

• Licensed Builder's Info (Workers' Compensation Affidavit)


#### 2. City Agencies' Approvals:


Boston Planning and Development Agency: Two Sets of Approved Drawings


#### 3. Additional Information/Comments:

You need relief from BPDA as this in a Neighborhood Design Review district There is a link on my email to the BPDA

All construction documents shall be organized in two sets, submitted together (no partial information will be accepted), and dropped off at Inspectional Services Department with the above referenced application number or re-uploaded on the portal if it is an ePlan application. More information may be required. Please be advised that the time limitation of your application shall be 180 days, otherwise it shall be deemed abandoned per 780 CMR. Thank you for your assistance.

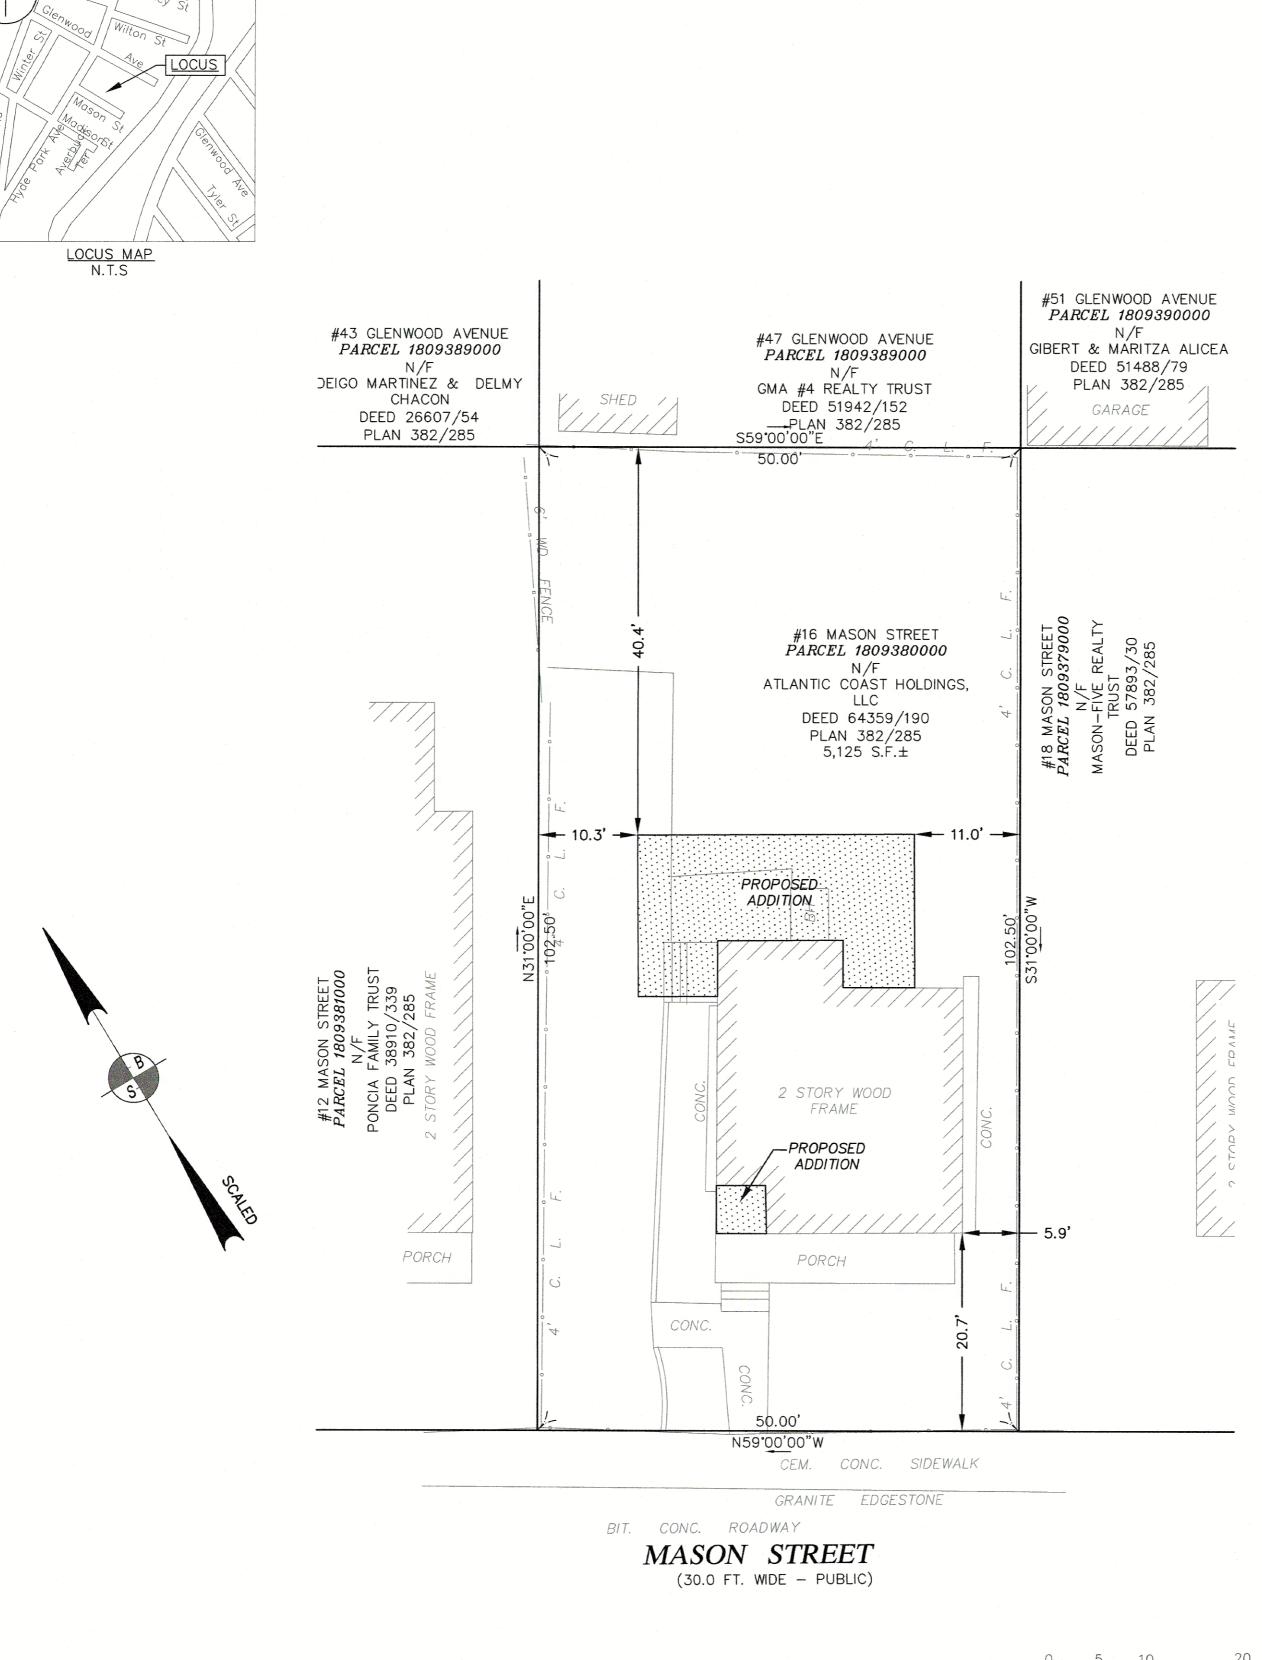

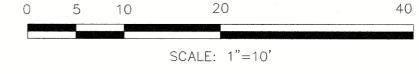

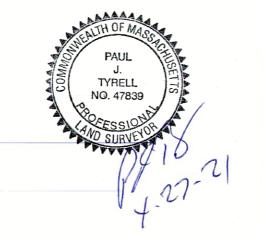

# PLAN OF PROPOSED CONSTRUCTION 16 MASON STREET BOSTON, MASSACHUSETTS

(HYDE PARK DISTRICT)

PREPARED FOR ROBERT NICHOLS 404 NEPONSETT AVENUE BOSTON MA



GREATER BOSTON SURVEYING AND ENGINEERING
19 FREDITH ROAD
WEYMOUTH, MA 02189

CALC BY: PJT DATE: DECEMBER 14, 2020

(781) 331-6128

SCALE: 1"=10"


# 16 Mason Street

Hyde Park, Massachusetts
Owner: Tony Baptiste

Permit Set: Issued 04/22/2021, Rev. 06/07/2021

# MODIFICATIONS FROM PERMIT SET UPDATED ON 04/22/2021 INCLUDED IN THIS SET:

- Refinement on exterior wall finishing and window materials.

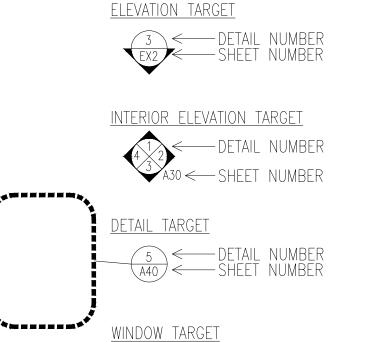

**Existing Photo** 

## GENERAL NOTES: 1 ALL WORK SE

- ALL WORK SHALL COMPLY WITH STATE, NATIONAL CODES, REGULATIONS AND RESTRICTIONS WHICH APPLY TO THIS PROJECT.
- 2. THE CONTRACTOR SHALL VISIT THE SITE AND BE KNOWLEDGEABLE OF CONDITIONS THEREON. THE CONTRACTOR SHALL INVESTIGATE, VERIFY AND BE RESPONSIBLE FOR ALL CONDITIONS OF THE PROJECT AND SHALL NOTIFY THE ARCHITECT OF ANY CONDITIONS REQUIRING MODIFICATION BEFORE PROCEEDING WITH THE WORK.
- THE CONTRACTOR IS RESPONSIBLE FOR OBTAINING AND POSTING ALL NECESSARY VALID CONSTRUCTION PERMITS FROM ALL LOCAL, STATE AND FEDERAL AUTHORITIES HAVING JURISDICTION PRIOR TO THE START OF ON-SITE CONSTRUCTION.
- THE CONTRACTOR SHALL KEEP ALL BUILDING MEANS OF EGRESS CLEAR OF ANY OBSTRUCTIONS AT ALL TIMES.
   THE GENERAL CONTRACTOR MUST COORDINATE WITH THE BUILDING FACILITIES MANAGER ALL ACTIVITIES INCLUDING, BUT NOT LIMITED TO WORK WHICH WILL GENERATE EXCESSIVE NOISE NOISE AND MODIFICATION TO UTILITIES. WORK MUST NOT INTERFERE WITH EXISTING SMOKE DETECTORS, ALARMS OR BUILDING SYSTEM
- 5.1. THE GENERAL CONTRACTOR SHALL REVIEW AND BE FAMILIAR WITH ANY TENANT DESIGN AND CONSTRUCTION MANUAL AND ANY OTHER BUILDING OWNER OR BUILDING STANDARDS.
- 6. THE CONTRACTOR IS SOLELY RESPONSIBLE FOR ALL CONSTRUCTION ACTIVITIES, MATERIALS, MEANS AND METHODS. THE CONTRACTOR IS TO COORDINATE ALL SUBCONTRACTORS TO COMPLETE THE FULL SCOPE OF WORK AS INDICATED IN THE CONSTRUCTION DOCUMENTS.
- 6.1. THE CONTRACTOR IS SOLELY RESPONSIBLE FOR PROPERLY LAYING OUT THE WORK AND FOR ALL LINES AND MEASUREMENTS FOR THE WORK.
- 6.2. BUILDING OR SITE COMPONENTS WHICH ARE AFFECTED OR DAMAGED BY THE WORK SHALL BE REPLACED OR RESTORED TO ORIGINAL CONDITION AND COLOR, OR AS APPROVED BY THE OWNER.
- 6.3. WHERE THE DESIGN INTENT CANNOT BE DETERMINED FROM THE DRAWINGS, CONSULT THE ARCHITECT BEFORE PROCEEDING WITH THE WORK. (312) 780-9456
- 7. THE CONTRACTOR SHALL VERIFY THE DIMENSIONS SHOWN ON THE DRAWINGS BEFORE LAYING OUT THE WORK, AND SHALL BE HELD RESPONSIBLE FOR ANY ERRORS OR INACCURACIES RESULTING FROM FAILURE TO DO SO. 7.1. DETAILS SHOWN ARE INDICATIVE OF THE CHARACTER, PROFILES, MATERIALS AND SYSTEMS REQUIRED FOR
- THE WORK INCLUDING THOSE CONDITIONS NOT COVERED BY SPECIFIC DETAILS.

  7.2. DIMENSIONS SHALL GOVERN, DO NOT SCALE THE DRAWINGS. WHERE THERE APPEARS TO BE A CONFLICT OR WHERE DIMENSIONS CANNOT BE DETERMINED, CONSULT THE ARCHITECT BEFORE PROCEEDING WITH
- 7.3. ALL DIMENSIONS ARE TO INSIDE FACE OF WALLS.
- 7.4. UNLESS SHOWN OTHERWISE, ALL DOORS SHALL BE LOCATED SUCH THAT THERE IS A 2 INCH WALL RETURN BETWEEN THE JAMB FRAME AND THE ADJACENT PERPENDICULAR WALL.
- 8. CONSULT WITH THE ARCHITECT OR ENGINEER BEFORE PENETRATING ANY JOISTS, BEAMS, OR OTHER STRUCTURAL MEMBERS
- 9. ALL CONSTRUCTION MATERIALS AND EQUIPMENT ARE TO BE STORED NEATLY WITHIN THE SCOPE OF WORK AREA ONLY.
- 10. ALL MATERIALS AND EQUIPMENT SHALL BE INSTALLED ACCORDING TO MANUFACTURER'S SPECIFICATIONS
  10.1. SUBMIT SHOP DRAWINGS AND SAMPLES FOR ALL STEEL, MILLWORK, SIGNAGE, HARDWARE AND INTERIOR
- 10.1. SUBMIT SHOP DRAWINGS AND SAMPLES FOR ALL STEEL, MILLWORK, SIGNAGE, HARDWARE AND INTERIOF FINISHES


  10.2. SUBMIT PRODUCT DATA FOR FIXTURES AND HARDWARE.
- 10.2. SUBMIT PRODUCT DATA FOR FIXTURES AND HARDWARE
- 10.3. ALL INTERIOR AND EXTERIOR FINISHES, COLORS AND MATERIALS ARE TO BE SELECTED AND APPROVED BY THE OWNER PRIOR TO CONSTRUCTION
- 10.4. ALL INTERIOR FINISHES AND FURNISHINGS ARE TO BE CLASS 'A' FIRE RATED AND ARE TO COMPLY WITH MASSACHUSETTS BUILDING CODE AND THE BOSTON FIRE CODE
- 10.5. ALL WOOD COMPONENTS SHALL BE FIRE TREATED
- 0.6. CONFIRM THAT ALL MATERIALS AND FINISHES, INCLUDING THEIR FABRICATION AND INSTALLATION WILL NOT RELEASE FUMES OR AROMAS WHICH MAY BE A HAZARD OR NUISANCE TO PERSONNEL
- 11. THE GENERAL CONTRACTOR SHALL BE RESPONSIBLE FOR ALL PANEL CONTROL AND CIRCUIT DESIGN AND FOR COMPLIANCE WITH ALL BUILDING, LIFE SAFETY, AND STATE AND NATIONAL ELECTRICAL CODES WHICH MAY APPLY 11.1. ALL EXPOSED UTILITY WIRES AND PIPES SHALL BE INSTALLED IN A WAY THAT DOES NOT OBSTRUCT OR
- 11.1. ALL EXPOSED UTILITY WIRES AND PIPES SHALL BE INSTALLED IN A WAY THAT DOES NOT OBSTRUCT OR PREVENT THE CLEANING OF FLOORS, WALLS AND CEILINGS; THEY SHALL BE INSTALLED A MINIMUM OF 6" OFF OF FLOORS AND 1' OFF OF WALLS, CEILINGS OR ADJACENT PIPES OR WIRES
- LOCATIONS ONLY WHERE CEILING IS ALTERED OR AS INDICATED ON FIRE PROTECTION DRAWINGS.

  13. EQUIPMENT INFORMATION AND SPECIFICATIONS, INCLUDING EQUIPMENT SUPPLIED BY THE OWNER, ARE TO BE

12. WHERE APPROPRIATE, EXISTING SPRINKLER HEADS ALARM SYSTEM AND DETECTORS ARE TO REMAIN. MODIFY

- THE MOST CURRENT AT THE TIME OF DOCUMENTATION PREPARATION.

  13.1. THE GENERAL CONTRACTOR SHALL BE RESPONSIBLE FOR VERIFYING THE EXACT DIMENSIONS AND EQUIPMENT CONNECTION REQUIREMENTS.
- 13.2. MAKE ALL FINAL CONNECTIONS, INSTALL THE SET UP IN WORKING ORDER, CHECK WARRANTIES, TEST AND NOTE VOID WARRANTIES.
- 13.3. COORDINATE WITH THE OWNER DELIVERY, STORAGE AND INSTALLATION OF ALL EQUIPMENT, INCLUDING THAT SUPPLIED BY THE OWNER.
- 14. PROVIDE ALL TEMPORARY FACILITIES AND SERVICES, CONSTRUCTION AND SUPPORT FACILITIES AND SECURITY AND PROTECTION AS NEEDED TO PROTECT NEW AND EXISTING CONSTRUCTION FOR THE DURATION OF THE WORK
- 15. ALL MATERIALS AND WORKMANSHIP SHALL BE GUARANTEED FOR A PERIOD OF ONE YEAR FROM THE DATE OF FINAL ACCEPTANCE UNLESS OTHERWISE SPECIFIED FOR A LONGER PERIOD OF TIME FOR A CERTAIN ITEM
- 6. SEAL AND CAULK AROUND ALL PENETRATIONS, CRACKS AND CREVICES AND ANY OPENINGS CAPABLE OF HARBORING INSECTS OR RODENTS
- 17. EMPLOY EXPERIENCED WORKERS FOR FINAL CLEANING, CLEAN TO COMMERCIAL BUILDING PROGRAM STANDARDS
- 17.1. DISPOSE OF ALL WASTE AND DEBRIS OFF THE PREMISES

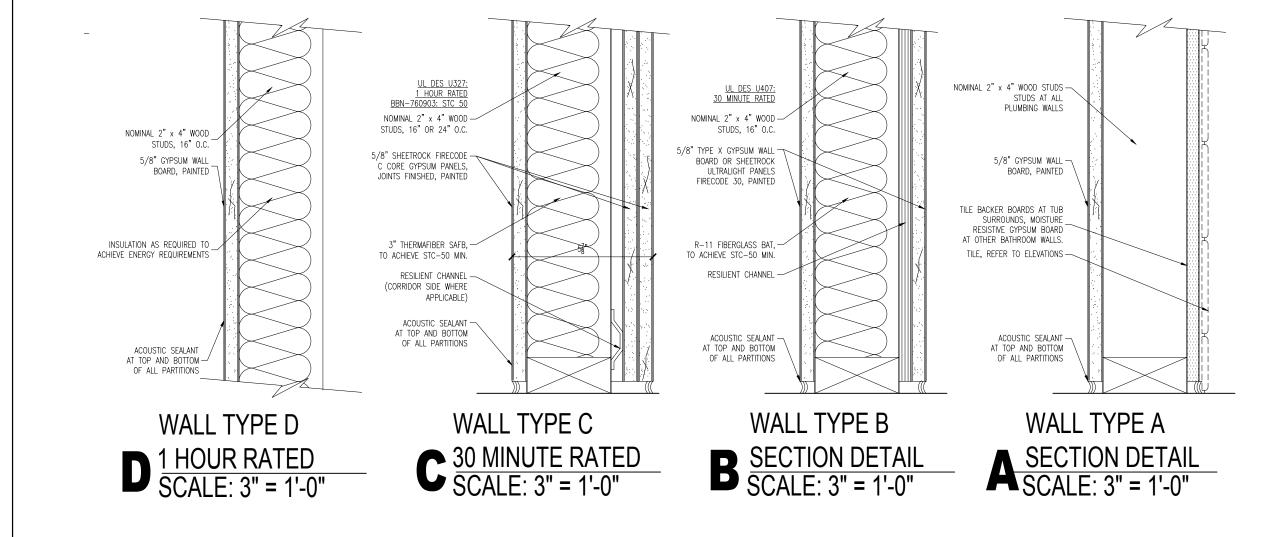



1 LOCATION PLAN SCALE: NOT TO SCALE

#### APPLICABLE CODES:

- 1. BUILDING CODE: CMR 780 MASSACHUSETTS STATE BUILDING CODE, 9TH EDITION (AMENDED INTERNATIONAL BUILDING CODE 2015, INTERNATIONAL RESIDENTIAL CODE 2015 AND THE 2015 INTERNATIONAL EXISTING BUILDIN CODE W/ MASSACHUSETTS AMENDMENTS)
- 2. ACCESSIBILITY: MASSACHUSETTS ARCHITECTURAL ACCESS BOARD CMR 521 AND UNIFORM FEDERAL ACCESSIBILITY STANDARDS
- 3. FIRE PROTECTION: MASSACHUSETTS COMPREHENSIVE FIRE SAFETY CODE CMR 527 1.00 2012 NFPA 1: FIRE CODE WITH AMENDMENTS
- 4. ELECTRICAL: 527 CMR 12.00 MASSACHUSETTS ELECTRICAL CODE 2014 NFPA 70 NATIONAL ELECTRICAL CODE WITH AMENDMENTS
- 5. MECHANICAL: INTERNATIONAL MECHANICAL CODE 2015 W/ AMENDMENTS
- 6. PLUMBING: 248 CMR BOARD OF STATE EXAMINERS OF PLUMBERS AND GAS FITTERS UNIFORM STATE PLUMBING CODE
- 7. ENERGY: INTERNATIONAL ENERGY CONSERVATION CODE 2018 (IECC)
- 8. AMERICANS WITH DISABILITIES ACT9. BOSTON ZONING CODE
- 10. MGL CH. 148 SECTION 26G

#### **BUILDING DESCRIPTION:**

RENOVATIONS TO THE EXISTING TWO-FAMILY DWELLING, INCLUDING ADDING A NEW ADDITION AND REFINING INTERIOR LAYOUT.

#### CODE SUMMARY:

1. PROPOSED USE OR OCCUPANCY: RESIDENTIAL - R-2

1.1 OCCUPANT LOAD: (200 GROSS SF/PERSON PER TABLE 1004.1.2) APPROX. 2,197 SF = 10 PERSONS

2. CONSTRUCTION TYPE: V.B. - TABLE 504.4

2.1 PER TABLE 601: STRUCTURAL FRAME, BEARING WALLS, FLOORS AND ROOF ARE NOT REQUIRED TO BE RATED 2.2 MAX. AREA IS UNLIMITED PER TABLE 506 AND MAXIMUM HEIGHT IS 3 STORIES ABOVE GRADE - 504.4
3. PER TABLE 1006.3.2(1) FOR USE GROUP R-2 - ONLY ONE EXIT IS REQUIRED WHEN THERE ARE LESS THAN FOUR STORIES AND 4 DWELLING UNITS OR LESS PER STORY. TRAVEL DISTANCE IS LIMITED TO 125'

4. MINIMUM WIDTH OF EGRESS STAIR: 36 INCHES PER SECTION 1011.2

5. MAXIMUM LENGTH OF EXIT TRAVEL: 250 FEET PER 1017.2

6. FIRE RATED CONSTRUCTION:

6.1 PER TABLE 602, EXTERIOR WALLS MORE THAN 10' FROM PROPERTY LINE ARE NOT REQUIRED TO BE RATED,
10' OR LESS MUST BE 1 HOUR RATED.

6.2 DEMISING PARTITION/CORRIDORS MUST BE 1 HOUR IN A TYPE V.B BUILDING 420.2 AND 708.3 6.3 HORIZONTAL SEPARATION BETWEEN DWELLING UNITS: 1 HOUR IN A TYPE V.B BUILDING PER 420 AND 711.2.4.3 - REFER TO DETAIL ON A-20

6.4 STAIRWAYS CONNECTING 4 OR MORE STORIES ARE TO BE 2 HOUR RATED, STAIRS CONNECTING LESS THAN 4 STORIES ARE TO BE 1 HOUR RATED PER 1023.2

6.5 PER TABLE 716.5: 1 HOUR ENCLOSURES AND EXIT ACCESS SHALL HAVE 1 HOUR DOORS. 1 HOUR AND HOUR CORRIDORS SHALL HAVE A MINIMUM 20 MIN. RATED DOOR. 2 HOUR ENCLOSURES AND EXIT ACCESS SHALL HAVE 90 MINUTE RATED DOORS.

7. DEMISING PARTITION MINIMUM: STC 50 PER SECTION 1207.2

8. ACCESSIBILITY REQUIREMENTS:

8.1 CMR 521 9.3 - EXISTING BUILDINGS RENOVATED FOR RESIDENTIAL USE ARE EXEMPT FROM MAAB REQUIREMENTS PER 521 CMR; ARCHITECTURAL ACCESS BOARD, PARAGRAPH 9.2.1

#### ENERGY REQUIREMENTS:

MASSACHUSETTS ENERGY STRETCH CODE, CHAPTER 4 - RESIDENTIAL ENERGY EFFICIENCY - RESIDENTIAL BUILDINGS, INTERNATIONAL ENERGY CONSERVATION CODE (IECC) 2018

1. CLIMATE ZONE 5H PER TABLE 301.1

- EXISTING WALLS AND CEILINGS: FILL EXISTING WALL AND CEILING CAVITIES WITH INSULATION PER IECC 503.1.1
- 3. PER IECC TABLES 402.1.2 AND R402.1.4, FENESTRATION SHALL HAVE A U-FACTOR OF 0.30 OR BETTER.
- 4. SKYLIGHTS SHALL HAVE A U-FACTOR OF 0.55 OR BETTER PER 402.1.2 AND 402.1.4.
- 5. VAPOR RETARDER IS REQUIRED TO COMPLY WITH R402.1.1 OF THE IECC AND R702.7 OF THE INTERNATIONAL RESIDENTIAL CODE. VAPOR RETARDER IS NOT REQUIRED IN BASEMENT OR BELOW GRADE WALLS.
- 6. R402.1.2 CEILING: R=49; WOOD FRAME WALL: R-20 OR 13(CAVITY)+5(CONTINUOUS); FLOOR R=30; BASEMENT WALLS AND CRAWL SPACES: R=15 CONTINUOUS OR R=19 IN CAVITY OR R=13 IN CAVITY WITH R=5 CONTINUOUS; SLAB R=10 DEMAND RECIRCULATION WATER SYSTEMS SHALL HAVE CONTROLS THAT COMPLY WITH REQUIRED CODES
- 8. HOT WATER PIPES IN UNCONDITIONED SPACES SHALL ALL BE INSULATED TO AT LEAST R-3, AND HOT WATER PIPES IN

CONDITIONED SPACES $\frac{3}{4}$ " AND LARGER SHALL I	BE INSULATED TO	AT LEAST R-3.		<b>G</b>
ZONING ANALYSIS:	2F-5000	PROPOSED	COMMENTS	
LOT AREA MIN.	5000 SF	UNCHANGED		ас
MIN. LOT WIDTH	50'	UNCHANGED		
MIN. LOT FRONTAGE	50'	UNCHANGED		
MAX. BUILDING HEIGHT (STORIES/HEIGHT)	2.5 / 35'	UNCHANGED		
MAX. FLOOR AREA RATIO	0.5	0.43		
MIN. FRONT YARD SETBACK	20'	UNCHANGED		02 01
MIN. SIDE YARD SETBACK	10'	10'-3"		No.
MIN. REAR YARD SETBACK	40'	40'-3"		Dra
OPEN SPACE REQUIREMENT	1,750 SF/UNIT	1,993 SF/UNIT		Pro
PARKING REQUIREMENT	2/UNIT	UNCHANGED		

LIST OF DRAWINGS

A-01 ANALYSIS, DRAWING LIST

AND NOTES

⟨ A ⟩ ← WINDOW TYPE

A-10 PROPOSED PLANS
A-30 PROPOSED ELEVATIONS

X-A1 EXISTING PLANS
X-A2 EXISTING ELEVATIONS



## 16 Mason Street

Tony Baptiste




Boston Massachusetts 02136

Issued for Revision 06/07/2021
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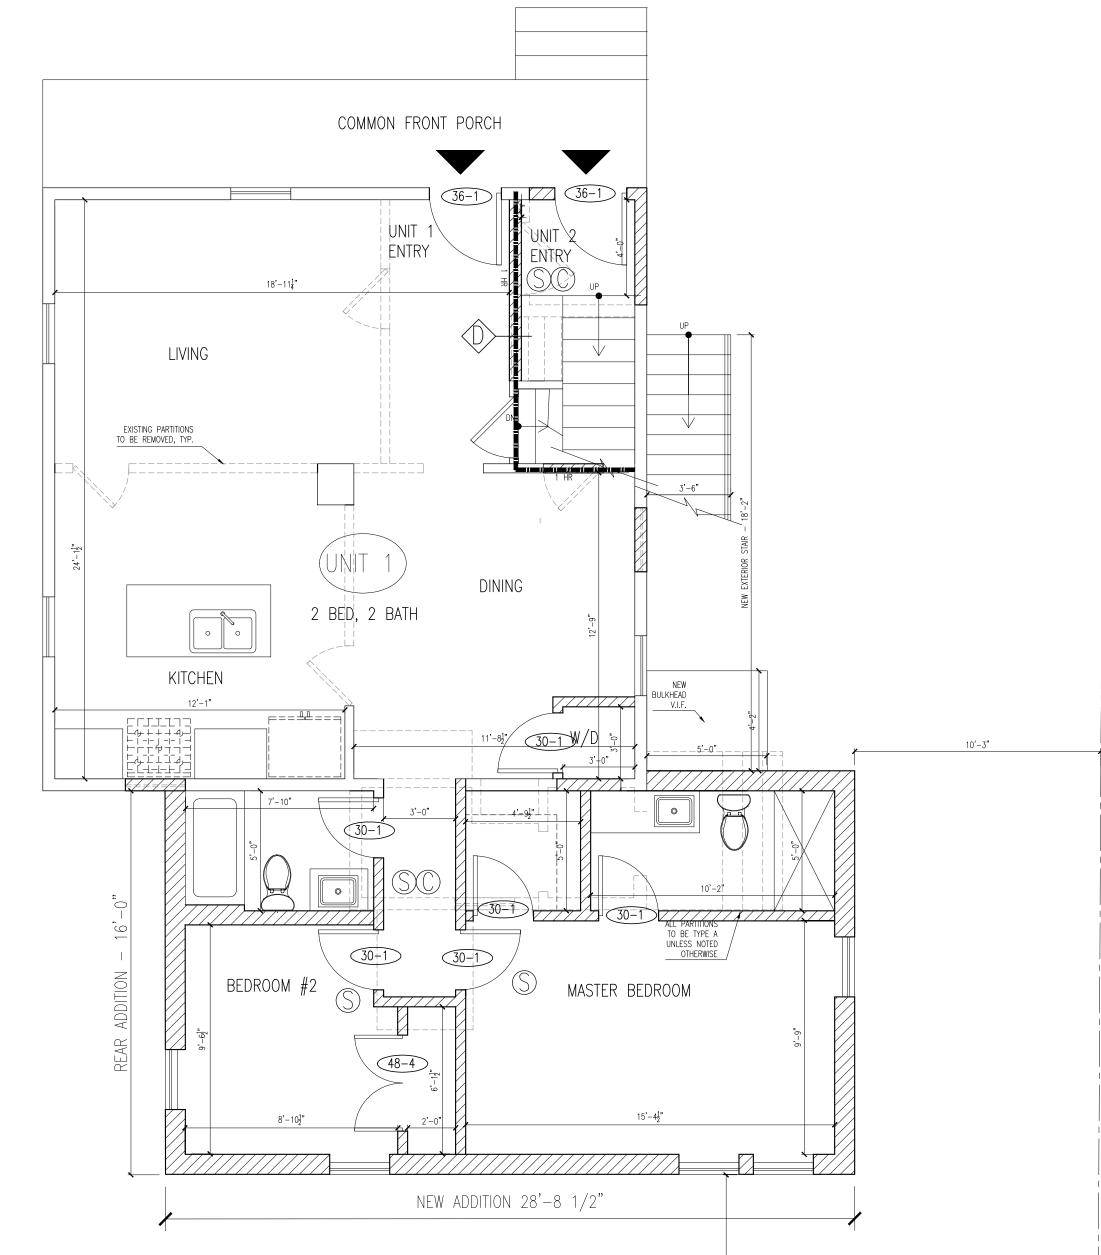
Description Date

rawing Title: ANALYSIS, DWG LIST, NOTES
roject No.: 0337 Checked by: EZ


A-0

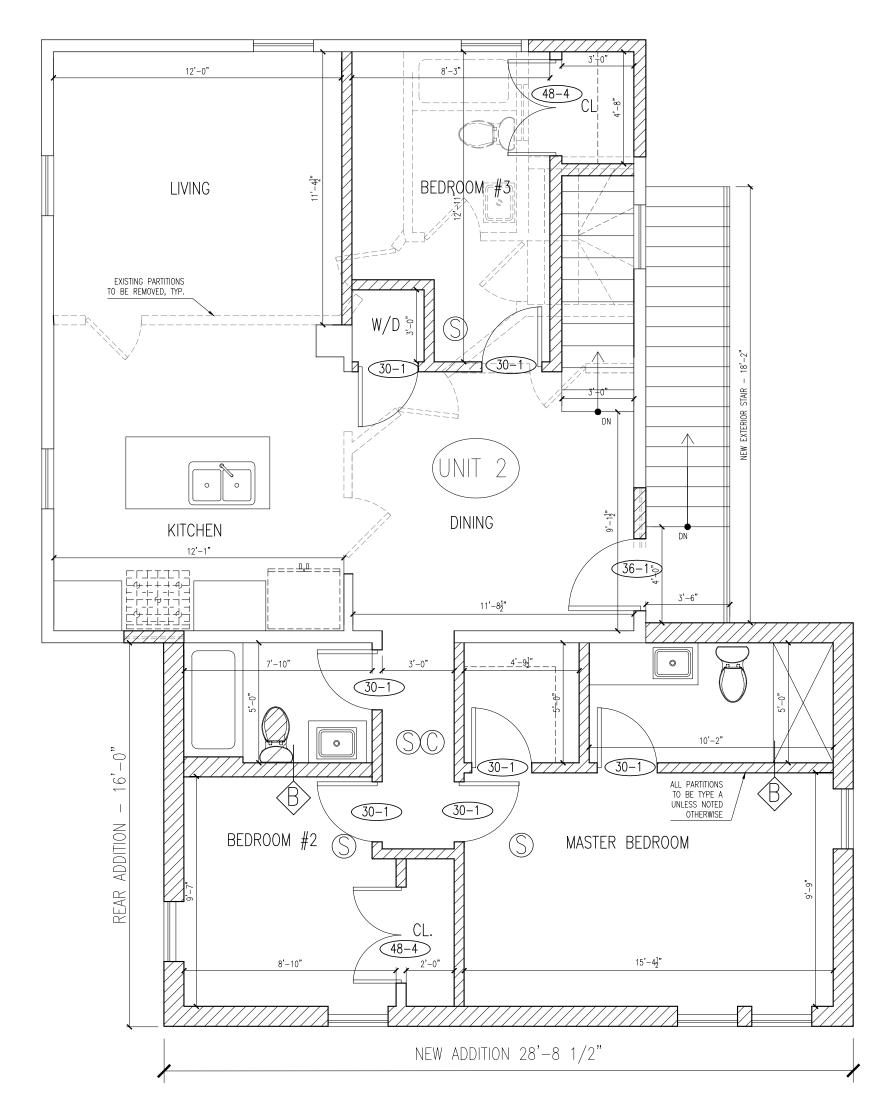

**2** LEVEL 2 PLAN SCALE: 1/4" = 1'-0"




1 LEVEL 1 PLAN SCALE: 1/4" = 1'-0"

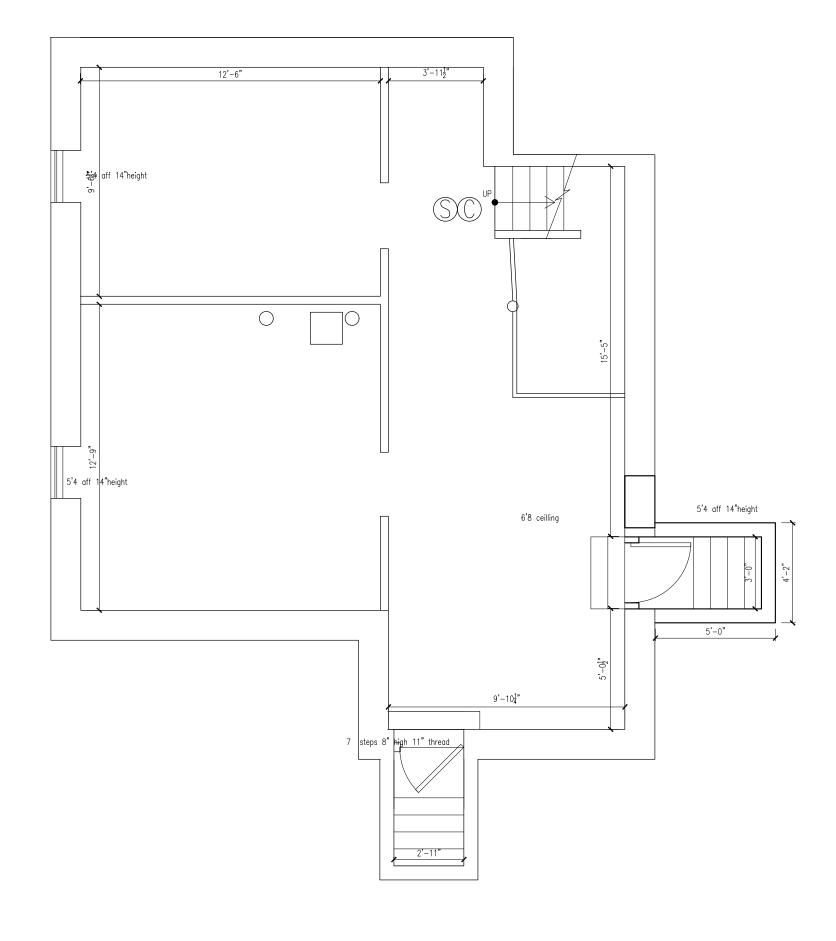

BASEMENT PLAN SCALE: 1/4" = 1'-0"

# NEW PARTITION 1/2 HOUR RATED PARTITION 1 HR PARTITION RATED PARTITION 2 HOUR RATED PARTITION

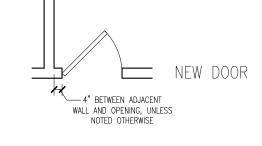

- SMOKE DETECTOR, HARDWIRED AND INTERCONNECTED
- CARBON MONOXIDE DETECTOR, HARDWIRED AND INTERCONNECTED
- HEAT DETECTOR, HARDWIRED AND INTERCONNECTED


WALL TYPE, REFER TO DRAWING A-01

### FINISH NOTES:

1. ALL WALLS TO BE PAINTED GWB, (WHITE TO MATCH ARCHITECT'S SAMPLE)
2. FLOORS TO BE HARDWOOD UNLESS NOTED OTHERWISE.

#### DOOR NOTES:

1. ALL NEW DOORS TO BE 6'-8" HIGH, 1 3/4" THICK SOLID CORE WOOD DOORS WITH WOOD FRAMES.
2. INTERIOR DOORS ARE TO BE PAINTED WHITE, CONFIRM EXTERIOR DOOR COLOR AND FINISH WITH OWNER AND ARCHITECT

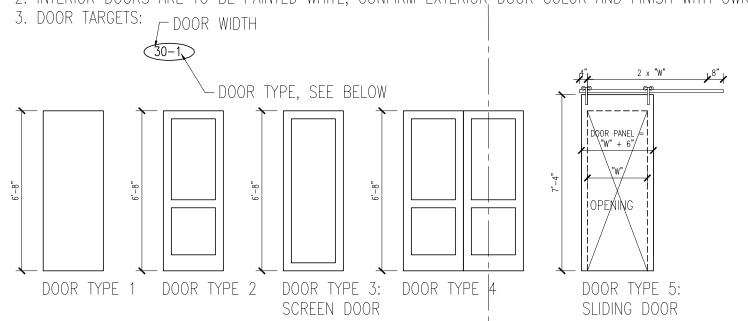


# **UNIT & BUILDING AREAS**


	-	
UNIT	NET SQUARE FOOTAGE/ UNIT	COMMENTS
UNIT 1	942 NET SF	2 BED, 2 BATH
UNIT 2	1002 NET SF	3 BED, 2 BATH

TOTAL BUILDING GROSS SF = 2,197 GSF, NEW ADDITION GROSS SF = 946 GSF


16 Mason Street Tony Baptiste

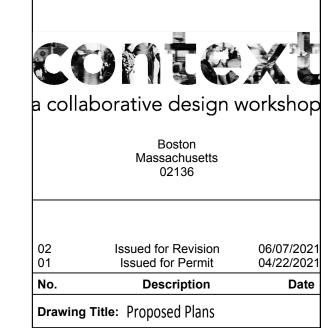


Checked by: EZ A-10

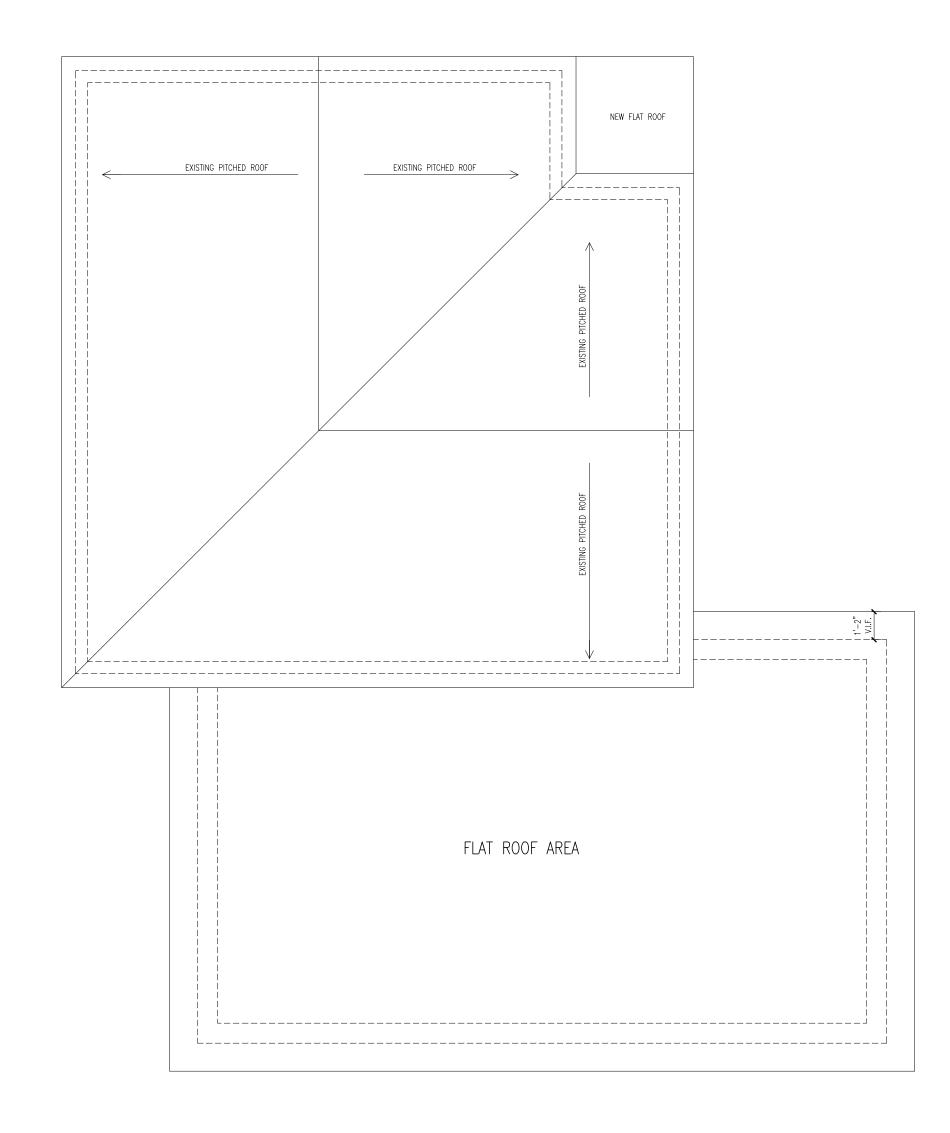

ROOF PLAN SCALE: 1/4" = 1'-0"

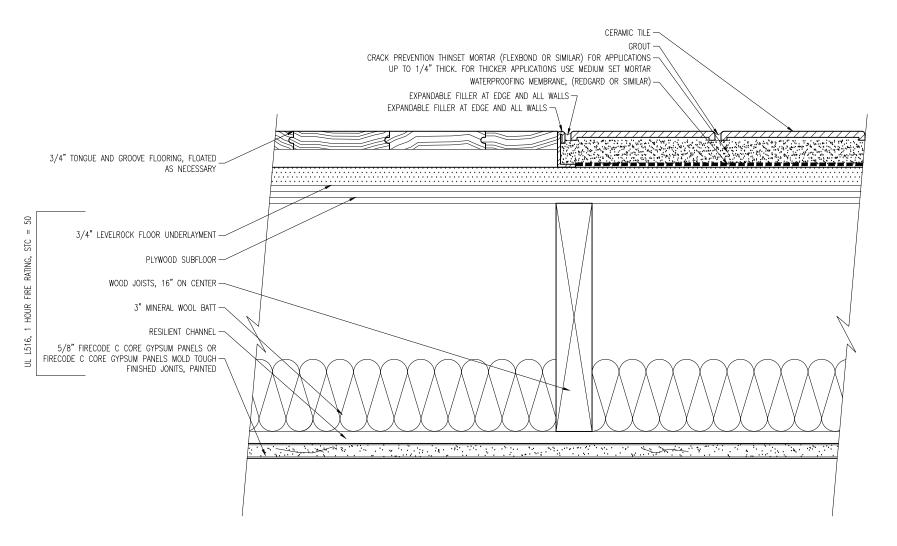

FLOOR CEILING SECTION DETAIL
SCALE: 3" = 1'-0"

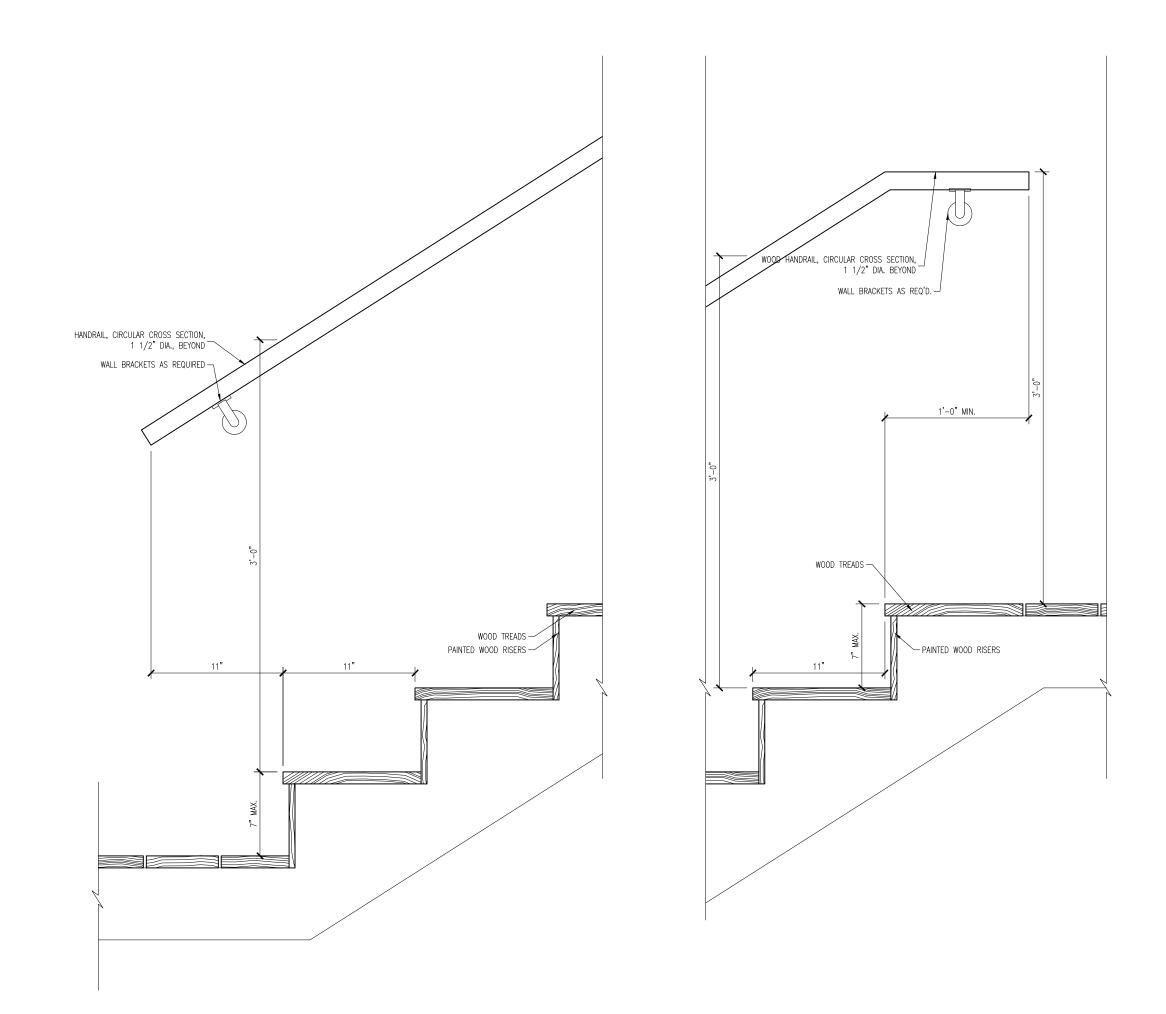

2 SECTION DETAIL@ BOTTOM OF STAIRS SCALE: 1-1/2" = 1'-0"

3 SECTION DETAIL@ TOP OF STAIRS SCALE: 1-1/2" = 1'-0"



16 Mason Street

Tony Baptiste

a collaborative design workshop


Boston
Massachusetts
02136

02 Issued for Revision
01 Issued for Permit
04/22/2021

No. Description
Date

Drawing Title: Proposed Plans


A-11

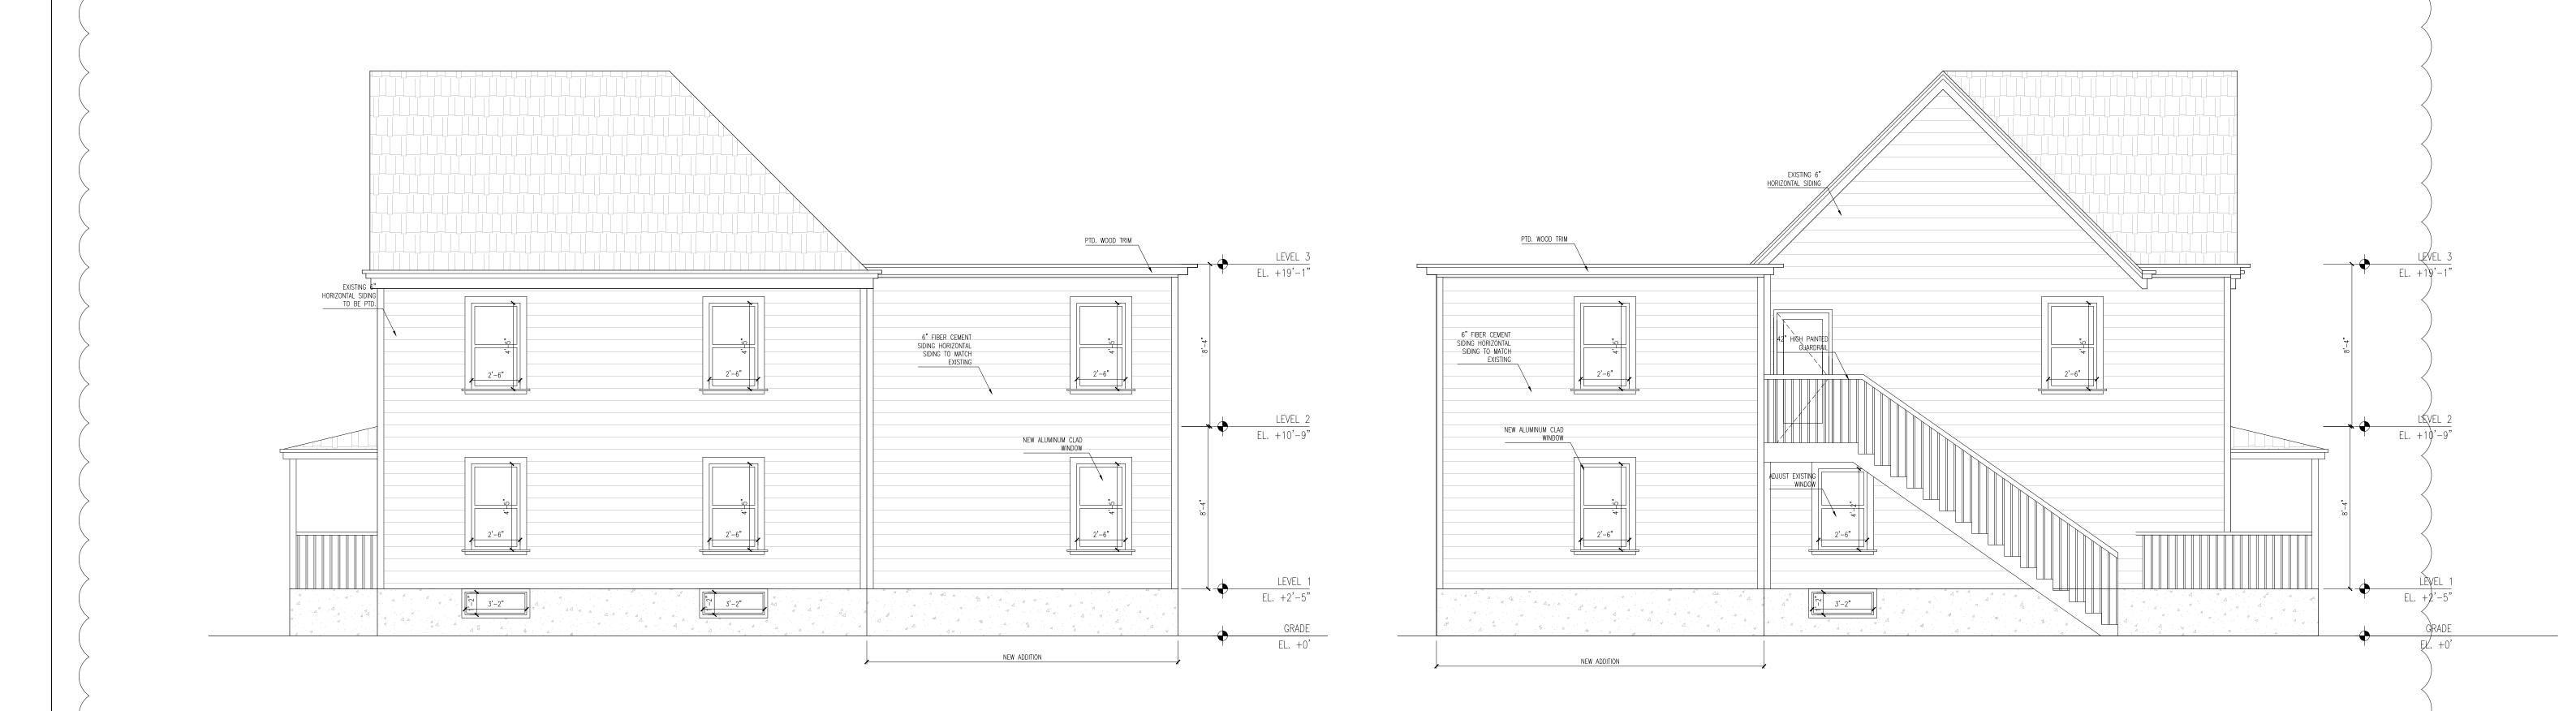


PROPOSED SIDE ELEVATION
SCALE: 1/4" = 1'-0"



PROPOSED SIDE ELEVATION SCALE: 1/4" = 1'-0"

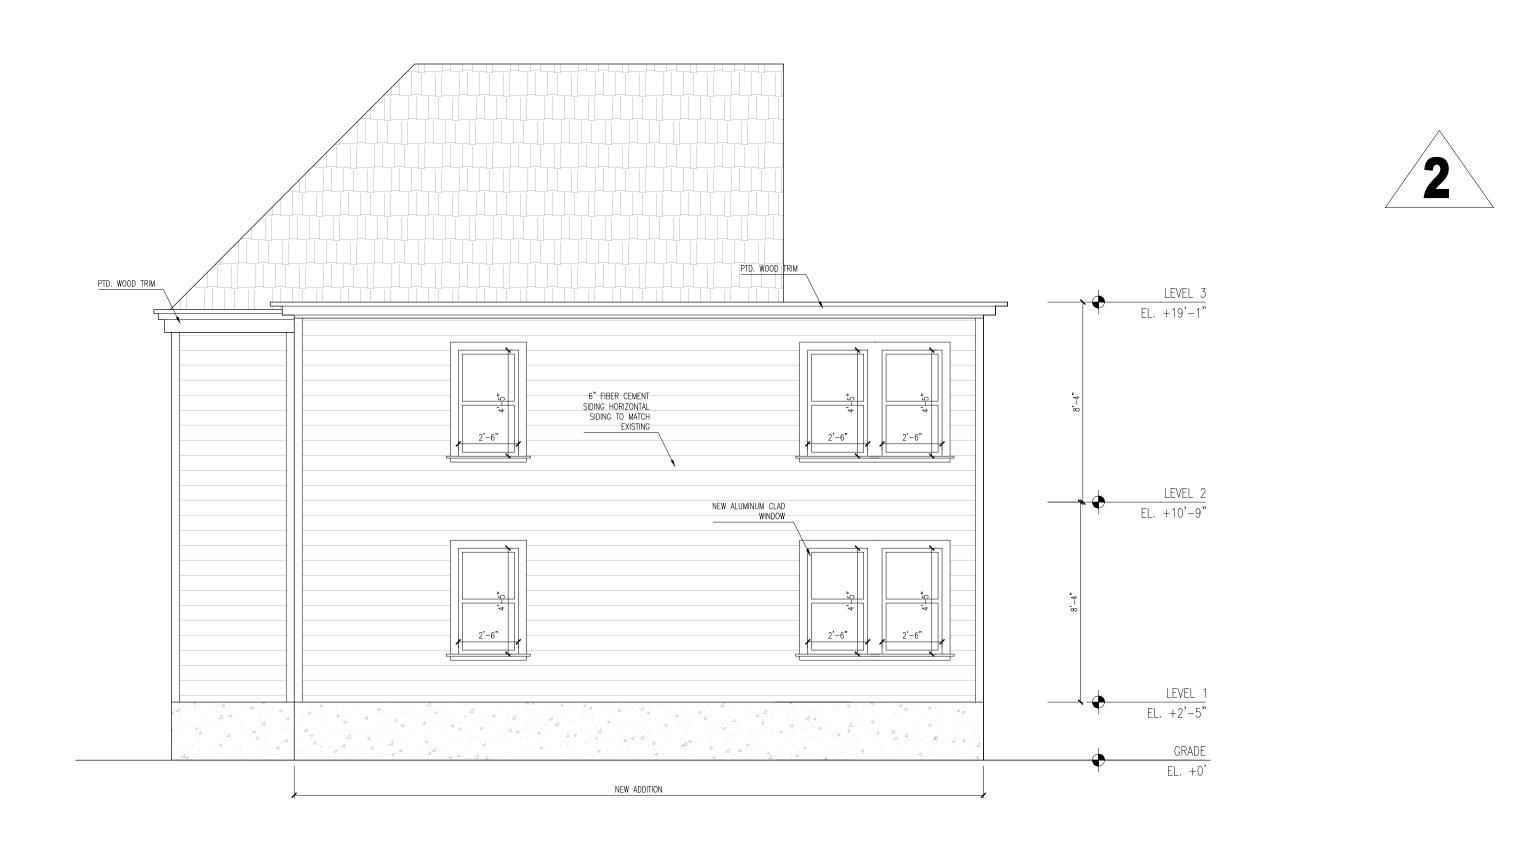

3 PROPOSED REAR ELEVATION SCALE: 1/4" = 1'-0"

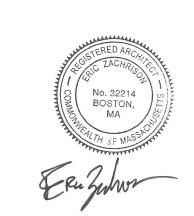



16 Mason Street Tony Baptiste a collaborative design workshop Boston Massachusetts 02136 06/07/2021 04/22/2021 Issued for Revision Issued for Permit Description **Drawing Title:** Proposed Elevations


A-30

Checked by: EZ

PROPOSED MASON STREET ELEVATION SCALE: 1/4" = 1'-0"

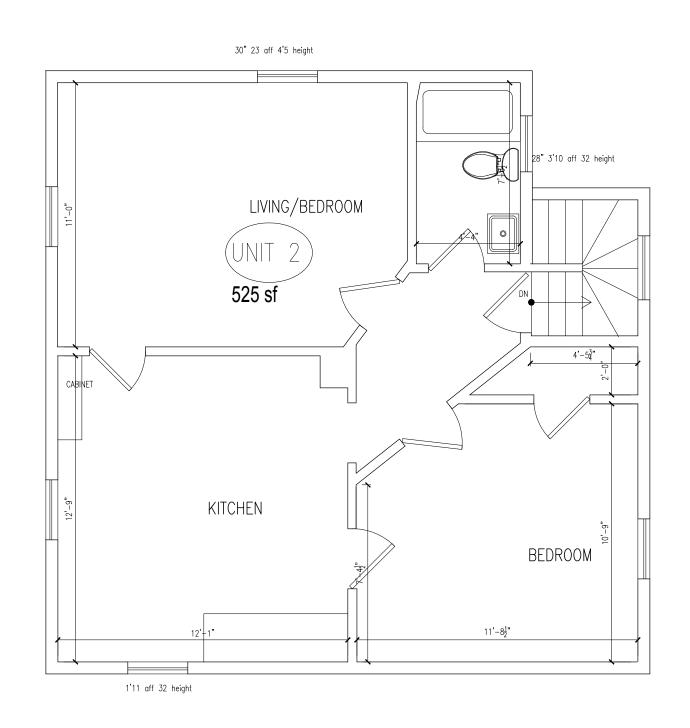

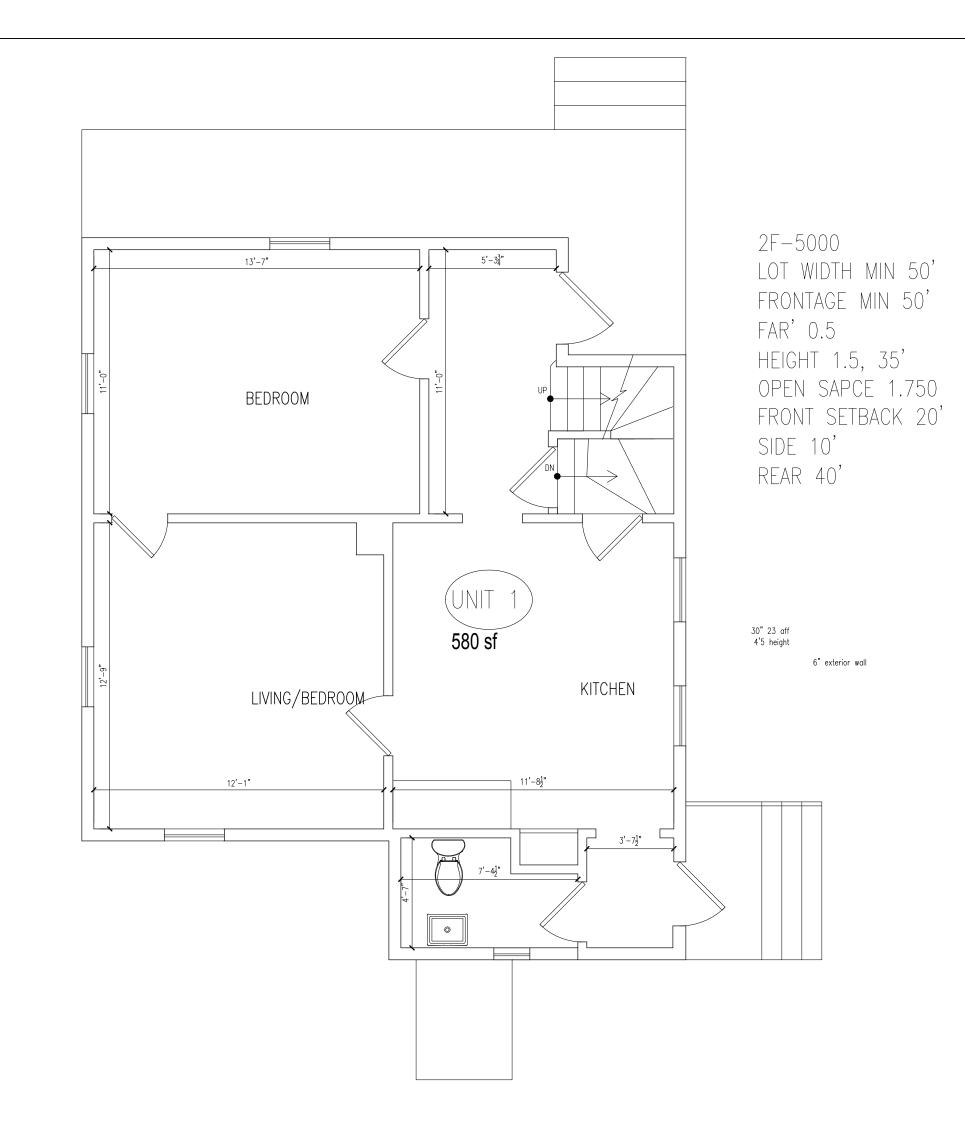

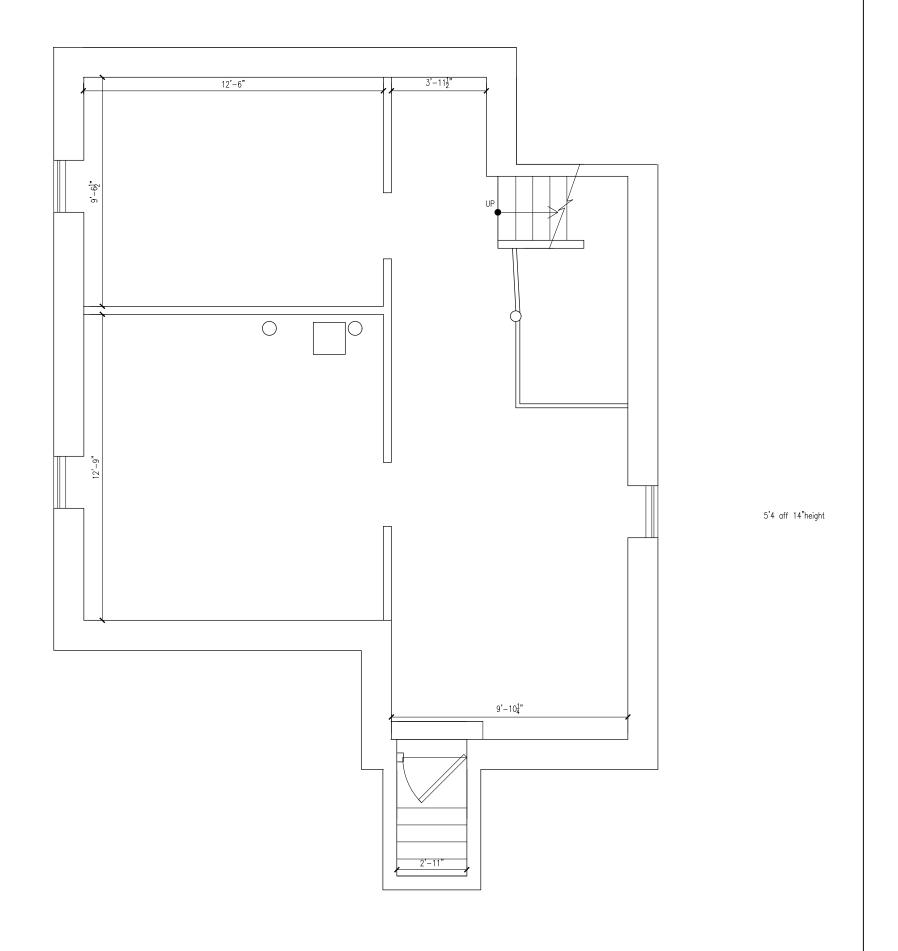



**2** LEVEL 2 PLAN SCALE: 1/4" = 1'-0"

1 LEVEL 1 PLAN SCALE: 1/4" = 1'-0"


BASEMENT PLAN SCALE: 1/4" = 1'-0"



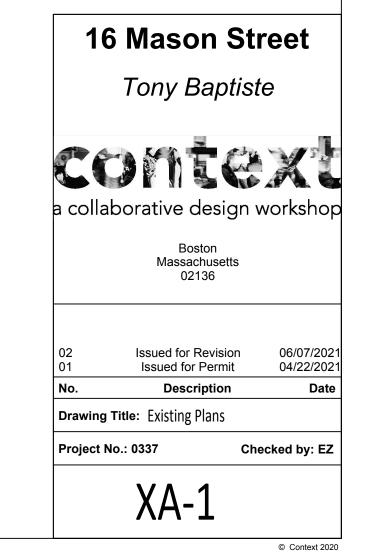


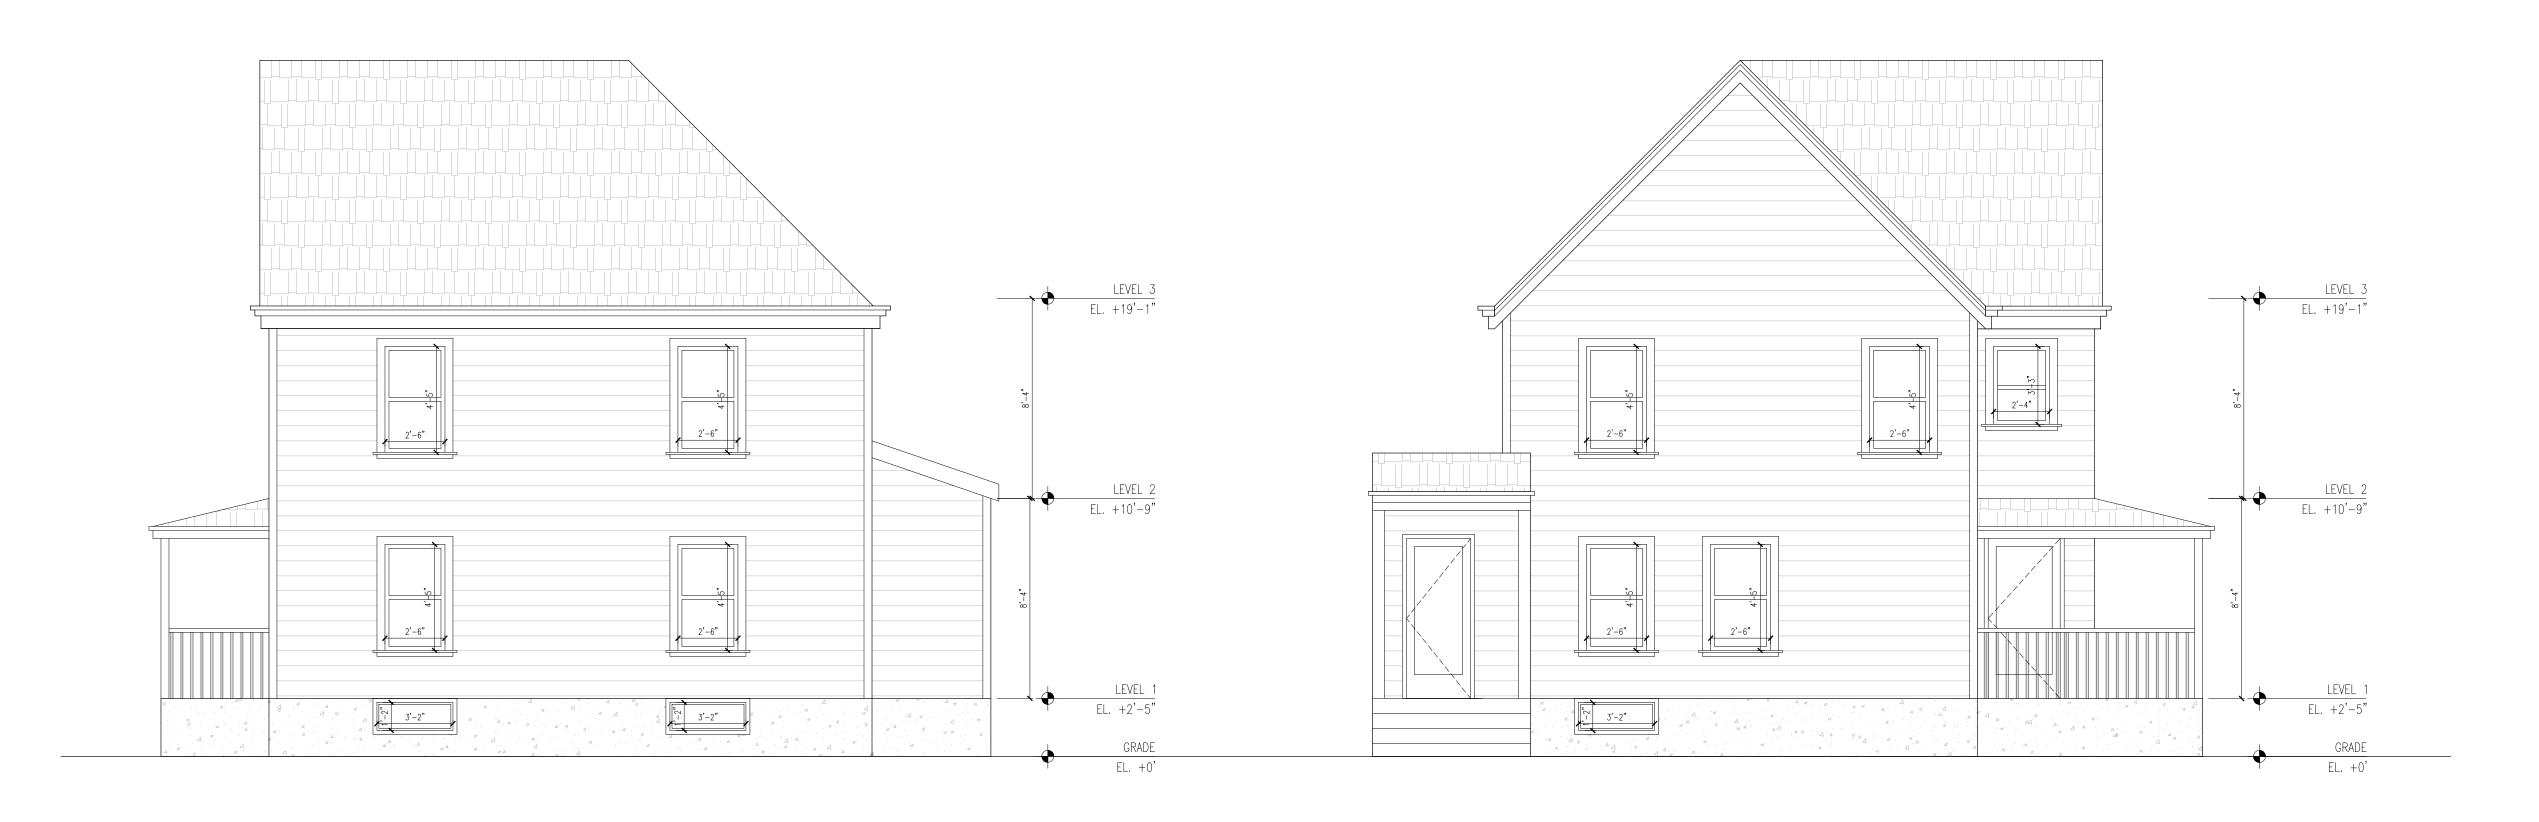

2 EXISTING SIDE ELEVATION SCALE: 1/4" = 1'-0"

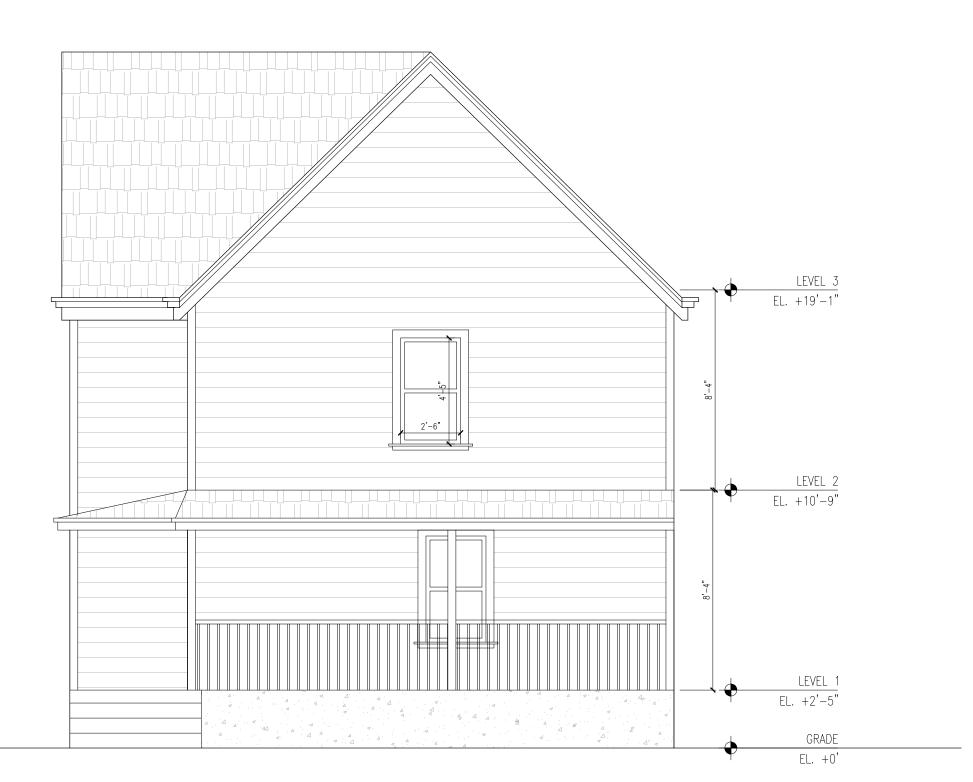

EXISTING SIDE ELEVATION SCALE: 1/4" = 1'-0"

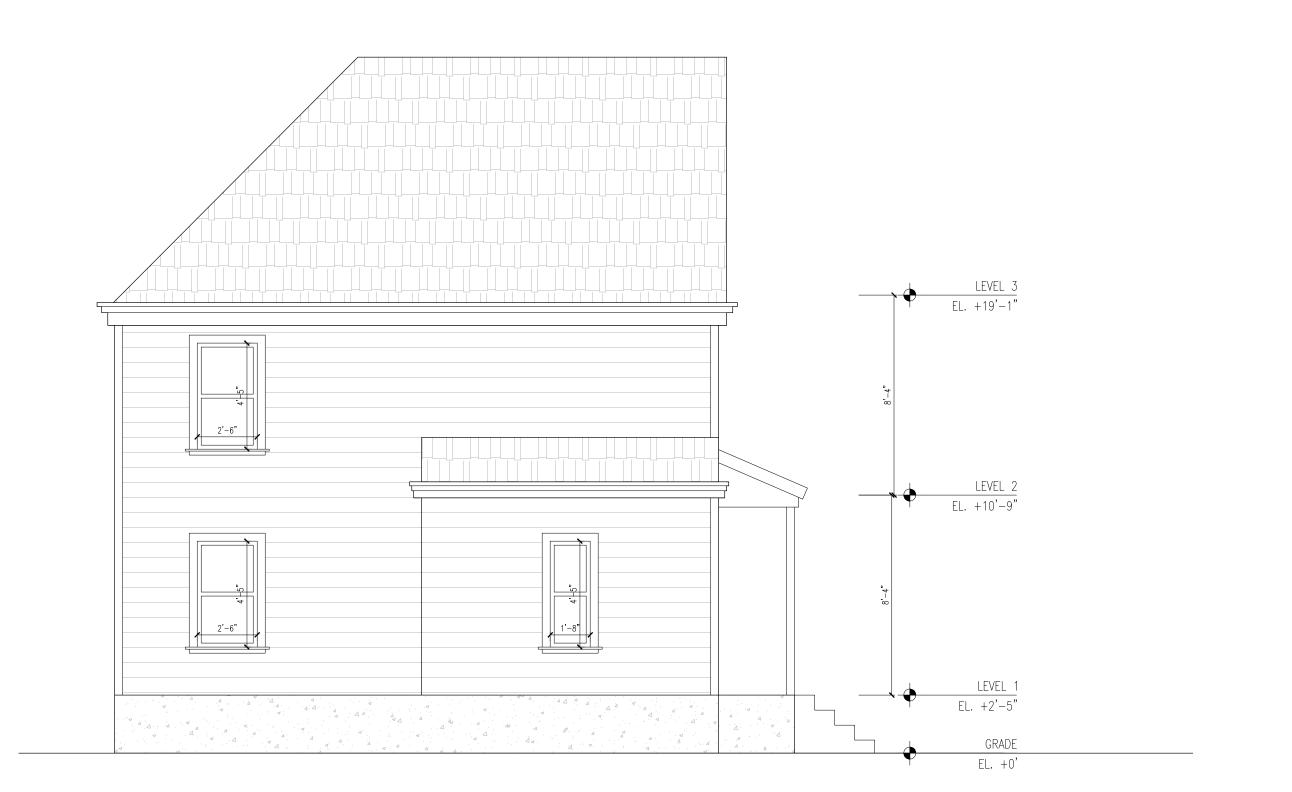

3 EXISTING REAR ELEVATION SCALE: 1/4" = 1'-0"



16 Mason Street

Tony Baptiste

a collaborative design workshop

Boston
Massachusetts
02136

Description


Date

Drawing Title: Existing Elevations

Checked by: EZ

**EXISTING MASON STREET ELEVATION** SCALE: 1/4" = 1'-0"

XA-2

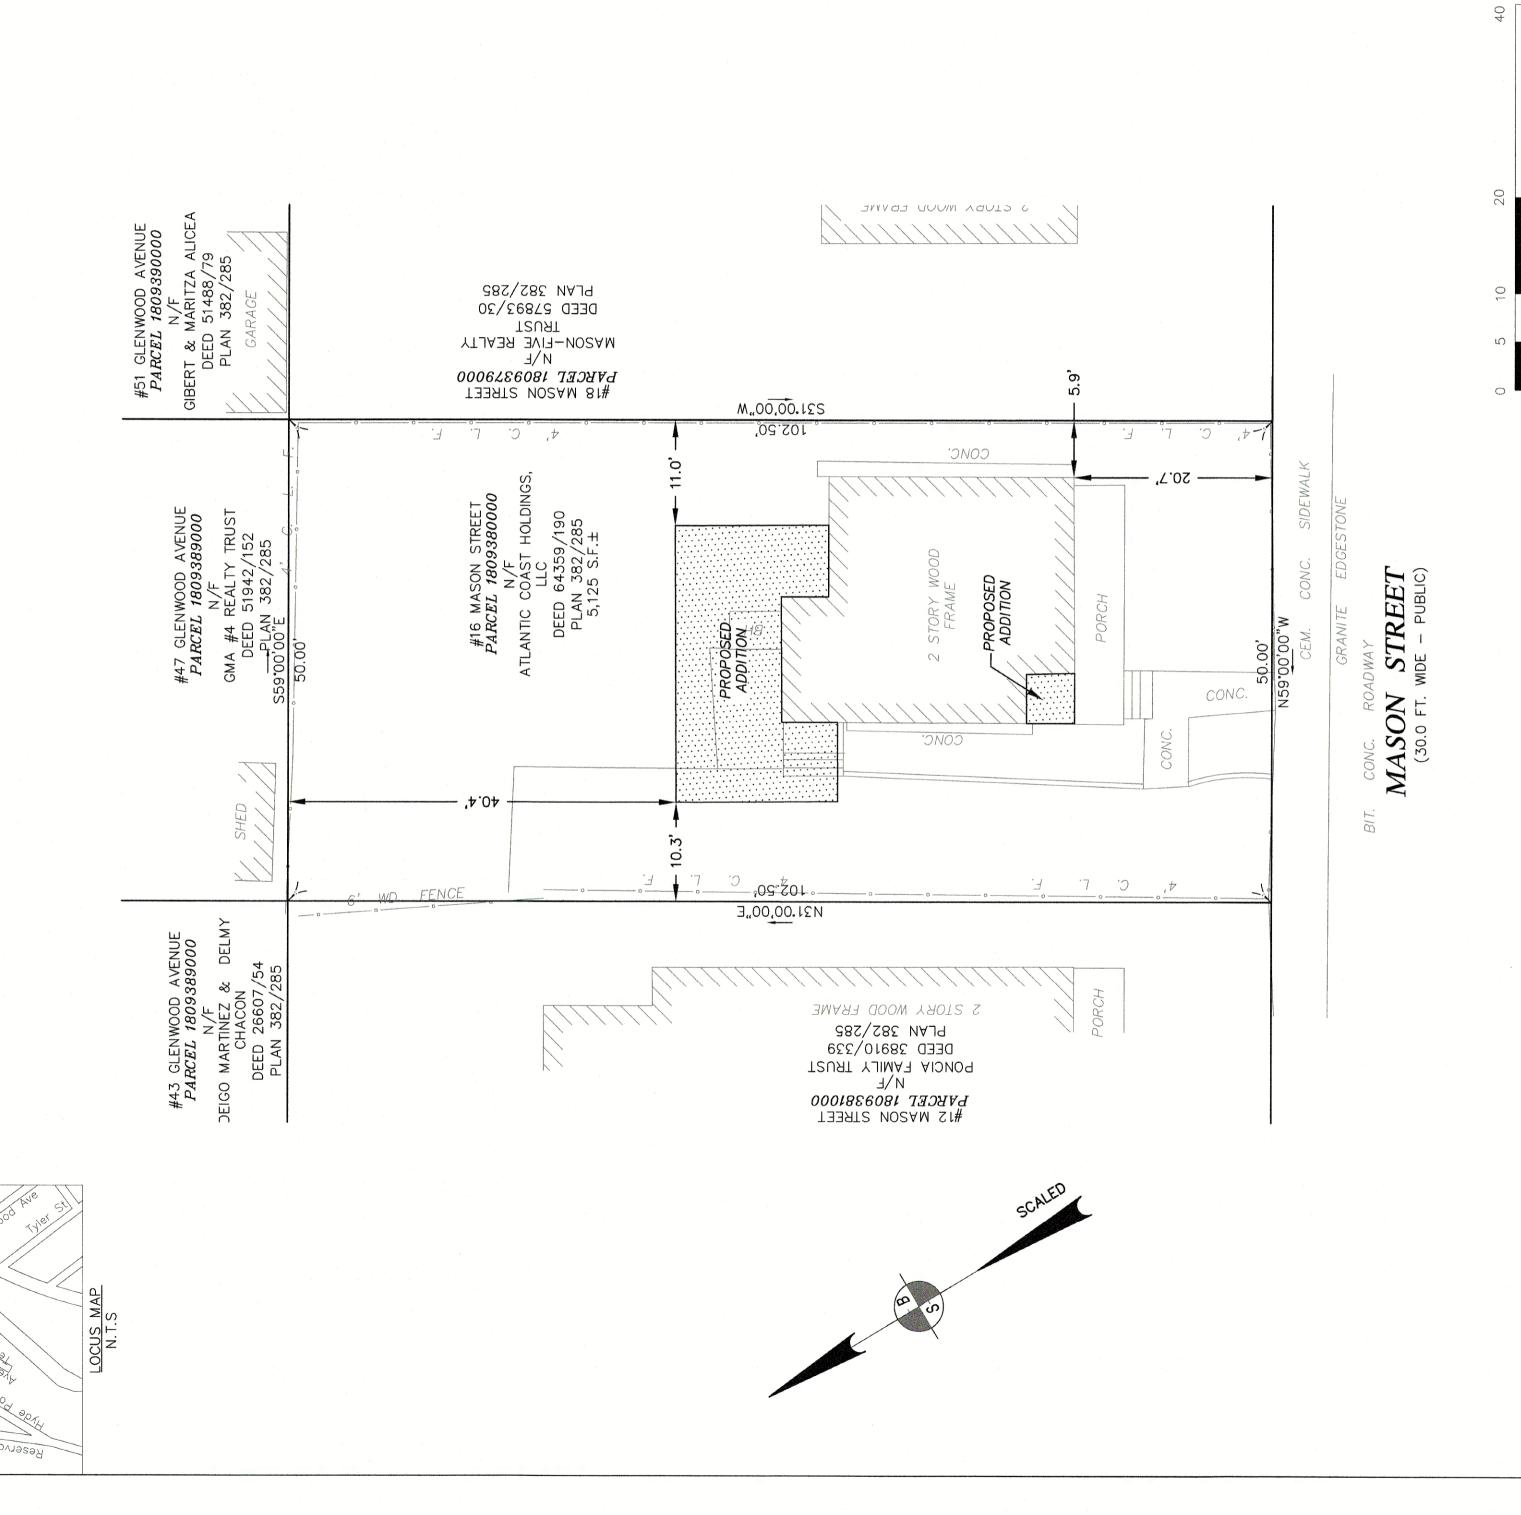

# PLAN OF PROPOSED CONSTRUCTION BOSTON, MASSACHUSETTS (HYDE PARK DISTRICT) 16 MASON STREET

PREPARED FOR ROBERT NICHOLS 404 NEPONSETT AVENUE BOSTON MA





DATE: DECEMBER 14, 2020