

BPDA Design Review Provisos 43-45 Mount Vernon Street, Charlestown 6/4/2024

General

- 1. All changes to the exterior and/or site plans shall be submitted to the Boston Planning & Development Agency ("BPDA") for review and approval.
- 2. All building improvements shall be completed *prior to issuance of occupancy permit by ISD* unless prior approval is granted by the BPDA.
- 3. All site improvements, including but not limited to hardscape and plantings, must be completed *prior to issuance of occupancy permit by ISD* unless prior approval is granted by the BPDA for a delay in completing the site improvements.

Landscape/Street/Site

- 4. Building, building protrusions, and construction shall not negatively impact the existing street light fixture. Approval from the City's Public Improvement Commission may be required.
- 5. Fences shall be of high-quality material; wood or metal is preferred. Chain link fencing is not preferred, especially in front yards; if chain-link is used, it must be vinyl-coated chain link in combination with landscaping. Fences shall not be higher than 6'-0" without ZBA approval. Fences of 6'-0" height are only allowed for rear yards. Front yard fences should not be taller than 42" (3'-6").
- 6. Permeable surfaces are encouraged on site; use permeable paving for any necessary paved surfaces and increase the vegetative cover as much as possible through the inclusion of ground-level plantings, green roofs, and porous surfaces. Project sites located in a Groundwater Conservation Overlay District (GCOD) are strongly encouraged to maximize permeable surfaces on their site.

Building

- 7. The existing brick foundations are to remain and will not be parged in concrete.
- 8. Siding: No vinyl or aluminum siding will be allowed. Clapboards shall be wood or fiber-cement. Shingles shall be wood or fiber-cement. All trim (corner boards, door/window casings, soffit/fascia trim, skirt boards, frieze boards, etc.) shall be wood or fiber cement with a painted finish.
- 9. Doors: All doors including garage doors should be wood. Metal or vinyl doors will not be allowed. Fiberglass doors may be considered as long as the detailing and finish matches wood doors and has a painted finish. All doors facing the street, including garage doors shall have translucent panels.

- 10. Windows: Windows should be wood or wood clad in another material, such as aluminum, fiberglass, or vinyl. All vinyl windows will not be allowed. All windows shall have exterior muntins and half screens.
- 11. Window and door trim shall have the following minimum dimensions: 4" casings with 5" or 6" trim at head. Corner boards shall be 8" wide at minimum.
- 12. Vestibule ceilings and walls shall be painted wood paneling.
- 13. Pressure treated lumber will not be allowed as an externally visible material for exterior decking. All pressure treated wood exposed to public views on the site shall be covered and shielded from view. Use of PVC, composite, and/or natural wood materials is acceptable.

Mechanical

- 14. The final location of the HVAC compressors, gas meters, electric meters, generators, switchgear, and transformers shall be adequately screened from public view and will not be allowed in the front yard.
- 15. All mechanical vents shall be through the roof or rear wall and shall not be visible from the public street. Vents located on elevations that do not directly face a public way should be composed on the facade so as to minimize their appearance.

PROPOSED ADDITION & RENOVATION 43 MOUNT VERNON STREET, CHARLESTOWN, MASSACHUSEUS



IMAGE FROM GOOGLE STREET VIEW

ZONING SUMMARY

Use Regulations: Section Table					
Existing	Proposed				
1 Family	1 Family				
·					

Dimensional Regulations: Table					
	Code Req	uirement	Existing Condition	Proposed Project	Notes
	Any Other Dwelling				
Lot Area Minimum	1,000 SF				
Min Lot Area for Additional Units	1,000 SF				
Total Required Lot Size	1,000 SF		1,309 SF	1,309 SF	
Min Required Lot Width and Frontage	20' / 20'		18.5' / 18.2'	18.5' / 18.2'	
Max FAR	2.00		1.60	2.00	2,093 SF EX'G 2,617 SF PROP
Max Building Height / Stories	3 STORIES / 35'		3 STORIES / 32.9'	3 STORIES / 32.9'	HEIGHT OF PROP ADDITION 21.0'
Usable Open Space	427 SF / DU		430 SF / DU	430 SF / DU	326 SF YARD & 117 SF ROOF DECK
Min Front Yard	MODAL / 0'		0'	0,	No Change
Min Side Yard	2.5'		0'	0' / 2.7'	
Min Rear Yard	18'		22.9'	18.2'	62-30.10
Max Use of Rear	25%				

Overlays: Parks Design Review

Parking: EX'G PARK'G - 0 SPACES REQ'D PARK'G - 0 SPACES (62.29.2) PROP PARK'G - 0 SPACES

Other Non-Dimensional Zoning Issues:



Revision Date

SITE LOCATION MAP:



IMAGE FROM GOOGLE MAP

KEY

SMOKE DETECTOR

HEAT DETECTOR

CARBON MONOXIDE DETECTOR

1 HOUR WALL

WALL TO REMAIN

45 MIN. DOOR

1-1/2 HOUR DOOR

WINDOW TYPE

1 HOUR CLG. ABOVE (SEE C.T.1/A-3.1)

2 HOUR CLG. WALL(SEE C.T.2/A-3.1)

FIRE EXTINGUISHER

NEW WALL

CODE SUMMARY

EX'G TYPE 5 CONSTRUCTION EX'G R-3 USE GROUP EX'G 3 STORIES & BASEMENT

SOIL TESTING

NOTE: THERE HAS BEEN NO SOIL TESTING PROVIDED TO THIS OFFICE FOR THIS PROJECT. THE DESIGNING ARCHITECT OR STRUCTURAL ENGINEER ACCEPTS NO RESPONSIBILITY FOR EXISTING SOIL CONDITIONS. ANY SOIL BEARING CAPACITY OF THIS FOUNDATION SYSTEM IS DESIGNED BASED ON A 2 TON MINIMUM SOIL BEARING CAPACITY. IT SHALL BE THE CONTRACTORS OR OWNERS' RESPONSIBILITY TO DETERMINE SUITABLE SOIL CONDITIONS AND VERIFY THE BEARING PRESSURE. IF A SUITABLE SOIL THAT CAN WITHSTAND A 2 TON BEARING CAPACITY IS NOT AVAILABLE, THIS OFFICE SHOULD BE CONTACTED BY THE CONTRACTOR OR OWNER FOR A FOUNDATION REDESIGN.

Project No: 2023208 Scale: AS NOTED Date: 02-20-2024

Drawn By: DF

Drawing Name

COVER SHEET

Sheet No.

PREPARED FOR:

EAGLE HILL CAPITAL 200 FALCON STREET EAST BOSTON, MA 02128

REFERENCES: OWNERS OF RECORD:

THOMAS C. WHITE DIANA WHITE

45 MOUNT VERNON STREET

PHILIP A. DOHERTY JOSEPH F. DOHERTY, JR. DEBORAH A. FIORILLO

43 MOUNT VERNON STREET

BK 8768; PG 6 45 MOUNT VERNON STREET BK 60981; PG 113 43 MOUNT VERNON STREET

BK 6080; PG 161 PL BK 2A; PL 10 (So. MIDDLESEX)

LCC: 4971-A YUNITS: SHEET P-13

SHEET S-13

AS SHOWN HEREON.

VERTICAL DATUM

BENCHMARK

FOR NEW WAYS ARE SHOWN.

AVAILABLE AT THE REGISTRY OF DEEDS.

1) RIM OF SEWER MANHOLE ELEVATION = 53.40'

TO ANY EXCAVATIONS.

FLOOD ZONE: X

MAP NUMBER: 25025C0018J EFFECTIVE DATE: 03-16-2016

ACCORDING TO THE FEDERAL EMERGENCY MANAGEMENT

AGENCY (F.E.M.A.) MAPS, THE MAJOR IMPROVEMENTS ON

THIS PROPERTY FALL IN AN AREA DESIGNATED AS

PARCEL ID: 0202760000 45 MOUNT VERNON STREET 0202761000

UTILITY SITE PLAN

LOCATED AT

43 & 45 MOUNT VERNON STREET

CHARLESTOWN, MA

DATE: NOVEMBER 30, 2023 SCALE: 1.0 INCH = 10.0 FEET





FIELD:


DRAFT:

CHECK:

DATE:

11/30/23

JOB # 23-00718

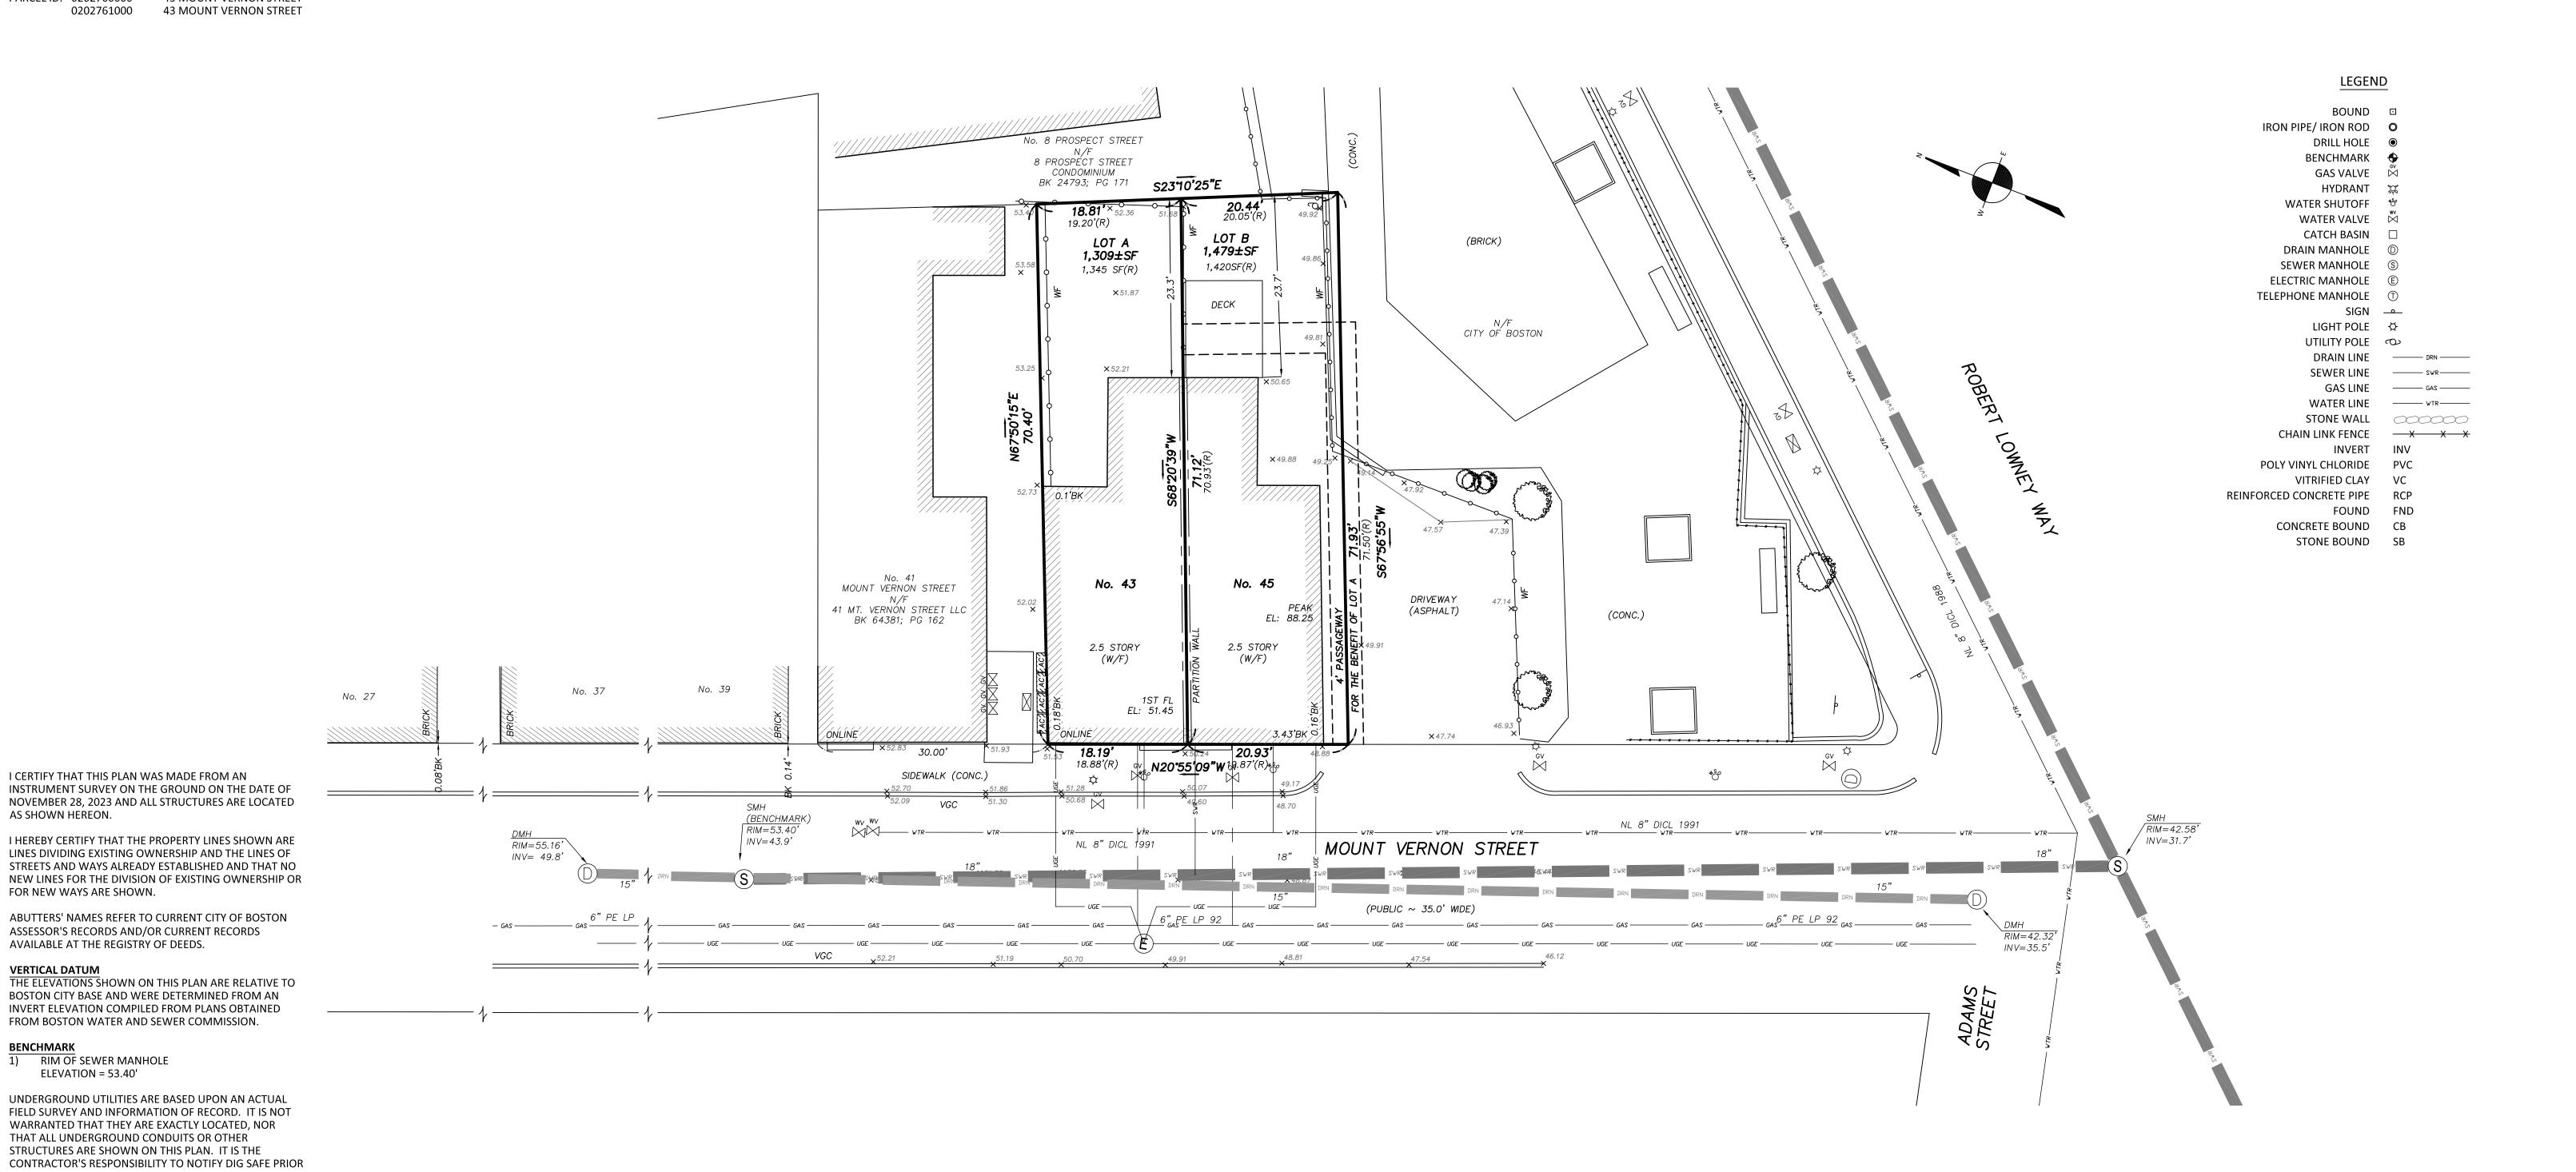

PREPARED FOR:

OWNER OF RECORD: FL MOUNT VERNON LLC 200 FALCON STREET BOSTON, MA 02128

REFERENCES:

BK 69731, PG 151 45 MOUNT VERNON STREET BK 69731, PG 145 43 MOUNT VERNON STREET

BK 6080; PG 161 PL BK 2A; PL 10 (So. MIDDLESEX)

LCC: SHEET P-13 YUNITS: SHEET S-13

PARCEL ID: 0202760000 45 MOUNT VERNON STREET 43 MOUNT VERNON STREET

UTILITY SITE PLAN

LOCATED AT

43 & 45 MOUNT VERNON STREET

CHARLESTOWN, MA

DATE: JANUARY 30, 2024 SCALE: 1.0 INCH = 10.0 FEET 10 20



LEGEND



06/04/2024

Approved pursuant to the requirements in a Neighborhood Design Overlay District and with the attached provisos.

I CERTIFY THAT THIS PLAN WAS MADE FROM AN INSTRUMENT SURVEY ON THE GROUND ON THE DATE OF NOVEMBER 28, 2023 AND ALL STRUCTURES ARE LOCATED AS SHOWN HEREON.

I HEREBY CERTIFY THAT THE PROPERTY LINES SHOWN ARE LINES DIVIDING EXISTING OWNERSHIP AND THE LINES OF STREETS AND WAYS ALREADY ESTABLISHED AND THAT NO NEW LINES FOR THE DIVISION OF EXISTING OWNERSHIP OR FOR NEW WAYS ARE SHOWN.

ABUTTERS' NAMES REFER TO CURRENT CITY OF BOSTON ASSESSOR'S RECORDS AND/OR CURRENT RECORDS AVAILABLE AT THE REGISTRY OF DEEDS.

VERTICAL DATUM

THE ELEVATIONS SHOWN ON THIS PLAN ARE RELATIVE TO BOSTON CITY BASE AND WERE DETERMINED FROM AN INVERT ELEVATION COMPILED FROM PLANS OBTAINED FROM BOSTON WATER AND SEWER COMMISSION.


BENCHMARK


1) RIM OF SEWER MANHOLE ELEVATION = 53.40'


UNDERGROUND UTILITIES ARE BASED UPON AN ACTUAL FIELD SURVEY AND INFORMATION OF RECORD. IT IS NOT WARRANTED THAT THEY ARE EXACTLY LOCATED, NOR THAT ALL UNDERGROUND CONDUITS OR OTHER STRUCTURES ARE SHOWN ON THIS PLAN. IT IS THE CONTRACTOR'S RESPONSIBILITY TO NOTIFY DIG SAFE PRIOR TO ANY EXCAVATIONS.

ACCORDING TO THE FEDERAL EMERGENCY MANAGEMENT AGENCY (F.E.M.A.) MAPS, THE MAJOR IMPROVEMENTS ON THIS PROPERTY FALL IN AN AREA DESIGNATED AS FLOOD ZONE: X MAP NUMBER: 25025C0018J

EFFECTIVE DATE: 03-16-2016

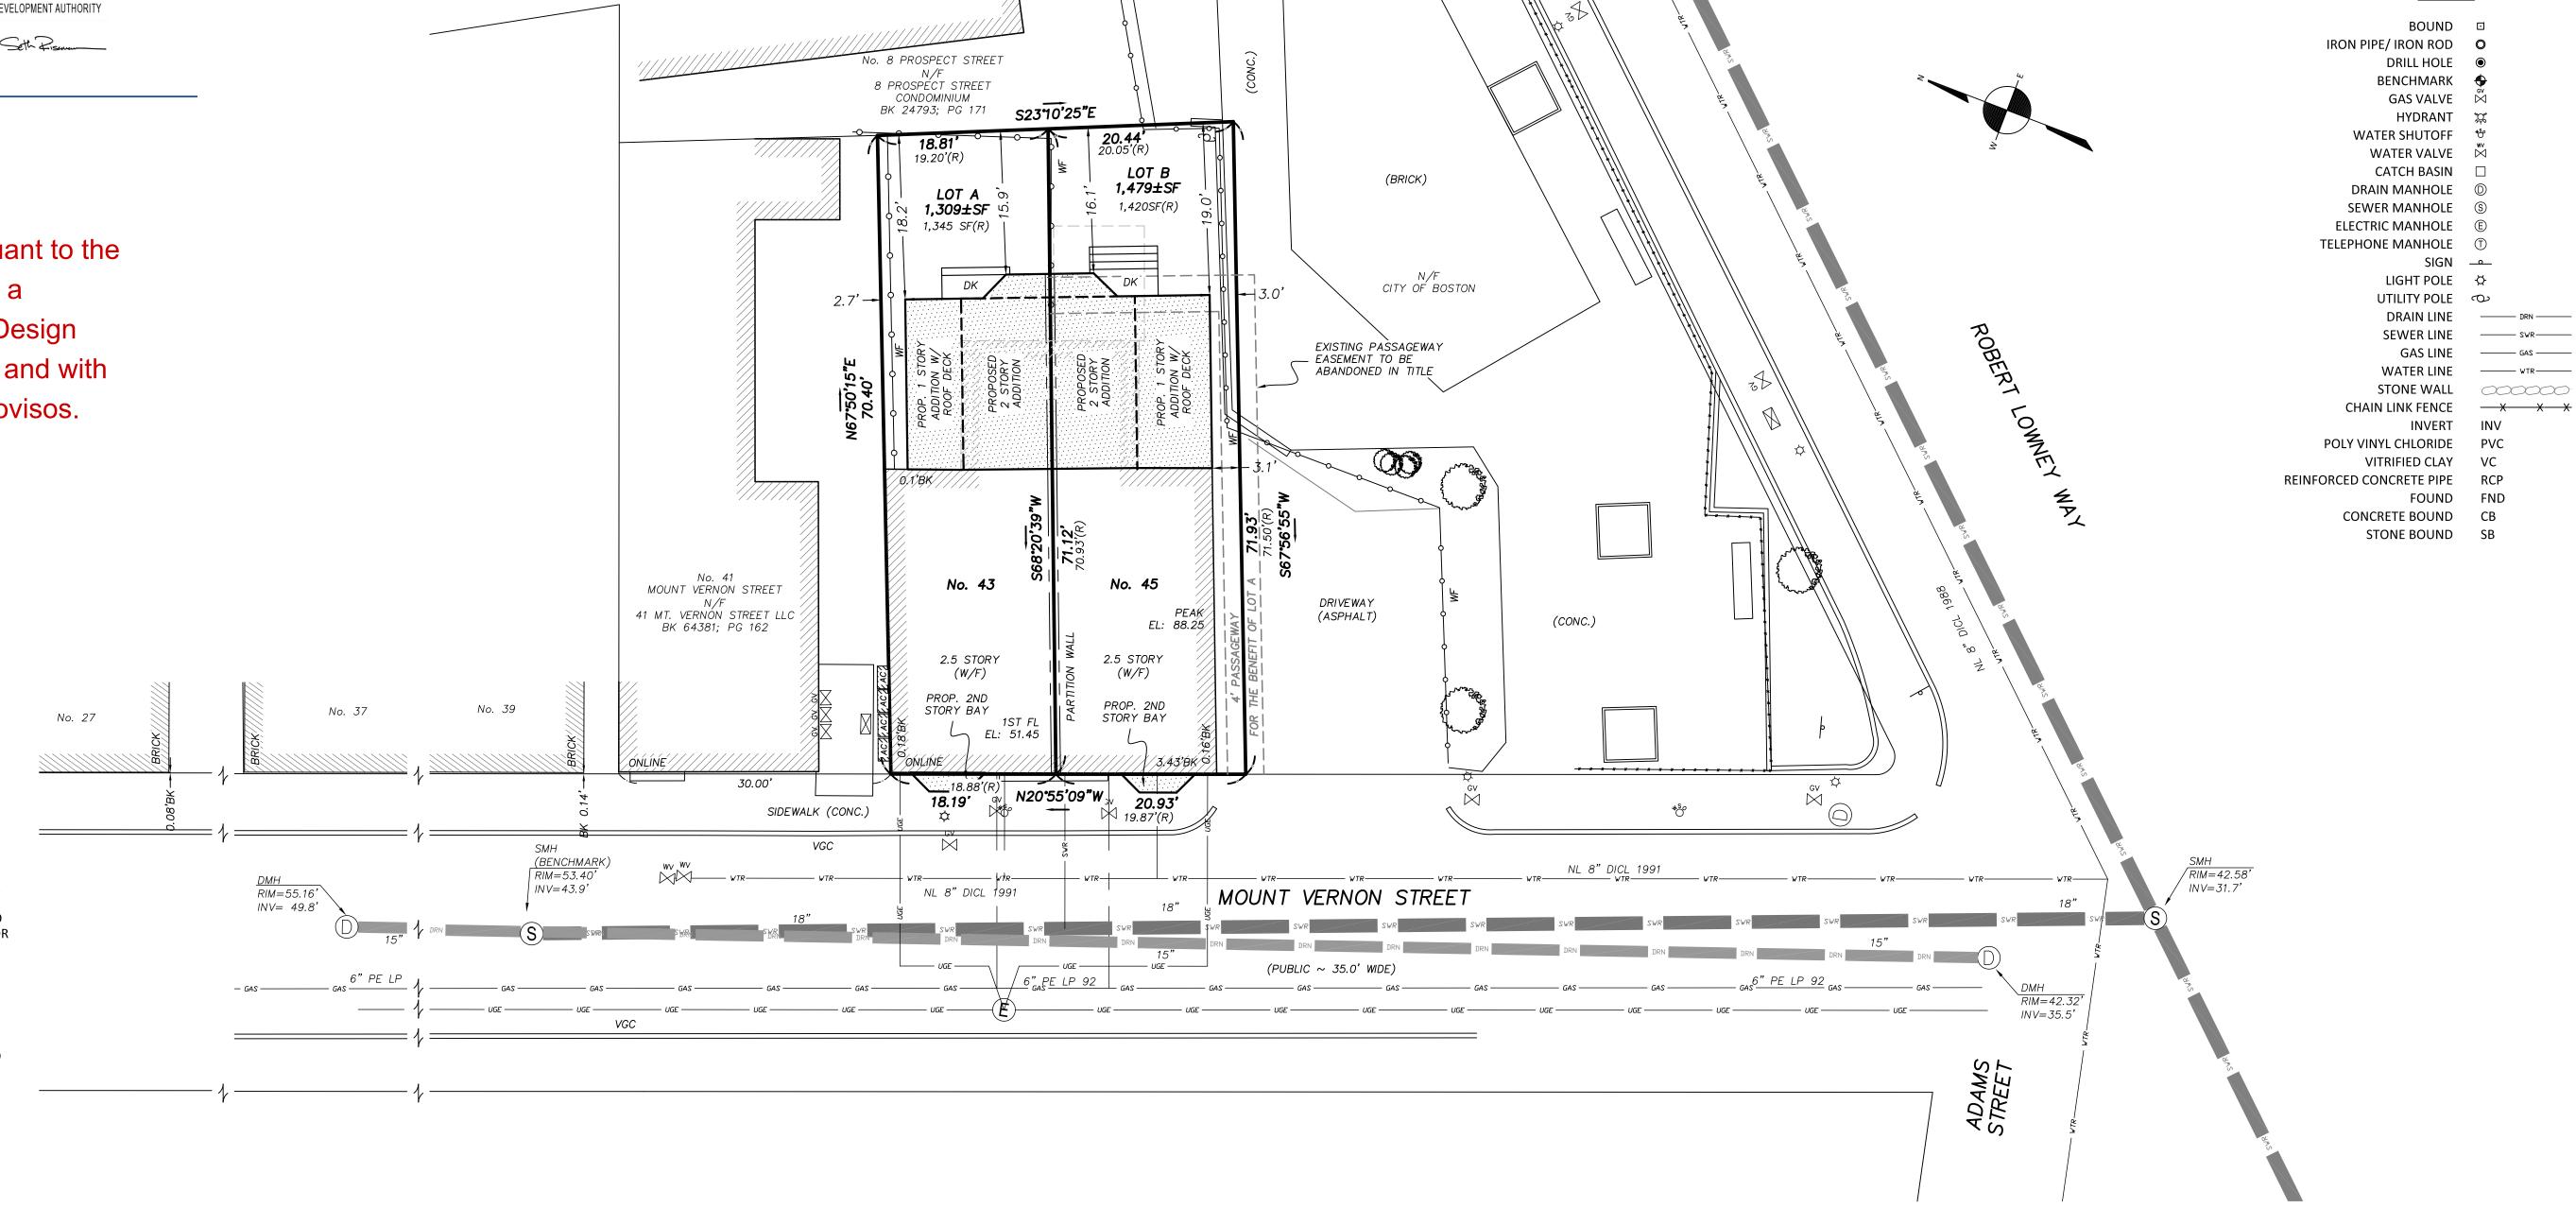

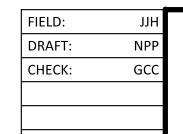

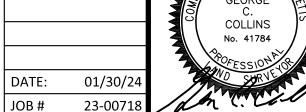

GENERAL NOTES:

CONTRACTOR RESPONSIBILITY-

CONTRACTOR IS SOLELY RESPONSIBLE FOR:

- 1. VIEWING SITE AND INCLUDING ANY SPECIAL CONDITIONS NECESSARY TO PERFORM THE WORK AS DESCRIBED IN THE DRAWINGS.
- PERFORM THE WORK AS DESCRIBED IN THE DRAWINGS.

 2. ESTABLISHING CONTROL OF THE SITE VIA SURVEY, AND LAYOUT.
- 3. OBTAINING AND PAYING FOR ALL PERMITS.
- 4. PAYING FOR ALL TEMPORARY UTILITIES AND FACILITIES.
- 5. CHECKING AND CONFIRMING ALL DIMENSIONS, AND LAYOUTS.
- 6. SCHEDULING AND SEQUENCING.
- 7. CONSTRUCTION MEANS, METHODS AND TECHNIQUES
- 8. MAINTAINING DRAWINGS AND PERMITS ON SITE.
- 9. JOB SITE SAFETY
- 10. COORDINATION BETWEEN TRADES, AND SUPPLIERS
- 11. PROVIDE SCHEDULE TO OWNER AND ARCHITECT,
- 12. PROVIDE A SCHEDULE OF VALUES TO THE OWNER AND ARCHITECT.
 13. TEMPORARY HEAT, ICE AND SNOWPLOWING IS THE RESPONSIBILITY OF THE
- CONTRACTOR.

 14. SITE CLEANLINESS AND CONFORMANCE TO NFPA 241 REQUIREMENTS.
- 15. REPAIRING ANY WORK DAMAGED BY HIS FORCES WHILE PERFORMING THIS CONTRACT.
- 16. GIVING WARRANTY FOR HIS WORK FOR A PERIOD OF ONE YEAR FROM THE DATE OF FINAL COMPLETION.

REVIEW OF WORK BY DESIGNERS-

CONTRACTOR SHALL NOTIFY ARCHITECT BEFORE PROJECT STARTS.

CONTRACTOR SHALL NOTIFY ARCHITECT, ONE WEEK PRIOR TO:

- 17. POURING CONCRETE
- 18. INSULATING
- 19. INSTALLING DRYWALL
- 20. FINAL INSPECTION

SHOP DRAWINGS-

ALL SHOP DRAWINGS SHALL BE SUBMITTED 30 DAYS AFTER CONTRACT AWARD.

GENERAL CONTRACTOR SHALL APPROVE SHOP DRAWINGS, PRIOR TO SUBMITTING TO ARCHITECT OR ENGINEER.

NON SUBMISSION DOES NOT CONSTITUTE APPROVAL OF ANY WORK.

NO EXCEPTIONS TAKEN DOES NOT RELIEVE THE CONTRACTOR OF PERFORMING ANY OTHER WORK ON THE DRAWINGS.

CONTRACTOR SHALL EXPECT A MINIMUM OF 2 WEEKS FOR DESIGNERS' REVIEW TIME

ANY VARIANCE FROM THE ORIGINAL DESIGN SHALL BE NOTED.

ANY SUBSTITUTION NOT INDICATED SHALL NOT CONSTITUTE APPROVAL OF A CHANGE.

SHOP DRAWINGS ARE NOT COORDINATION DRAWINGS.

DESIGNERS ARE NOT RESPONSIBLE FOR DIMENSIONS.

CHANGE ORDERS-

CONTRACTOR SHALL VISIT THE SITE AND BE THOROUGHLY ACQUAINTED WITH THE PROJECT PRIOR TO SUBMITTING A PRICE. ADDITIONAL MONEY WILL NOT BE GRANTED FOR WORK NOT CLARIFIED PRIOR TO BIDDING.

DESIGNER SHALL BE NOTIFIED OF ANY CHANGE TO THE DRAWINGS, UNFORESEEN FIELD CONDITIONS OR DISCREPANCIES PRIOR TO PERFORMING WORK.

ANY PROPOSED CHANGES SHALL BE ACCOMPANIED WITH A WRITTEN DESCRIPTION OR A SKETCH FOR CLARIFICATION.

ALL CHANGE ORDERS SHALL BE APPROVED PRIOR TO PERFORMING WORK.

CHANGE ORDERS SHALL BE PRICED EITHER LUMP SUM OR UNIT PRICE OR TIME AND MATERIALS.

ANY SUBSTITUTION REQUEST SHALL BE MADE VIA CHANGE ORDER, AND NOT VIA SHOP DRAWINGS UNLESS AGREED TO.

ANY CHANGE SHALL STATE THE CREDIT OR COST ADD AND/OR ANY CHANGE TO THE SCHEDULE.

REQUISITIONS-

ANY REQUISITION REQUIRED TO BE SIGNED BY THE ARCHITECTED SHALL BE SUBMITTED A MINIMUM OF ONE WEEK PRIOR TO BEING SUBMITTED TO THE BANK FOR REVIEW.

CONTRACTOR SHALL PROVIDE RECEIPTS AND INSURANCE CERTIFICATES FOR ANY MATERIALS FOR PAYMENT FOR ANY UNINSTALLED MATERIALS.

FOUNDATION NOTES:

- 1. ALL FOUNDATION FOOTINGS SHALL BE CARRIED DOWN TO A MINIMUM OF 4'-0" BELOW FINISH GRADE, OR DEEPER, IF NECESSARY, TO OBTAIN A SAFE SOIL BEARING PRESSURE OF 2 TONS PER SQUARE FOOT, FOUNDATION DESIGN IS BASED ON ASSUMED SOIL BEARING CAPACITY OF 2 TONS PER SQUARE FOOT.
- ALL FOOTINGS SHALL BE PLACED ON UNDISTURBED SOIL; OR, ON ENGINEERED BANK RUN GRAVEL FILL MATERIAL WITH A MINIMUM DRY DENSITY OF 95%.
- 3. ALL FOOTING SHALL BE POURED IN THE DRY ONLY. WATER SHALL NOT BE ALLOWED TO FLOW THROUGH THE DEPOSITED CONCRETE.
- 4. NO FOOTING SHALL BE POURED ON FROZEN GROUND. FOUNDATIONS NEED TO BE PROTECTED FROM FREEZING FOR A MIN. OF 5 DAYS AFTER THEY WERE POURED.
- 5. THE MINIMUM REINFORCING FOR ALL FOUNDATION WALLS SHALL BE 2-#6 BARS AT THE TOP AND BOTTOM, CONTINUOUS; OR, AS SHOWN ON DRAWINGS
- 6. LAP ALL BARS 40 DIAMETERS AND PROVIDE CORNER BARS.
 7. ALL REINFORCEMENT: ASTM A615-60, WWF A185.

CONCRETE NOTES:

- 1. ALL CONCRETE SHALL ATTAIN A MINIMUM COMPRESSIVE STRENGTH OF:
- 3000 PSI FOR FOUNDATION WALL, EXTERIOR WALLS AND OTHER VERTICAL CONCRETE SURFACES EXPOSED TO THE WEATHER
- 2. MAXIMUM SLUMP SHALL NOT EXCEED 3"; AND MAXIMUM; COARSE AGGREGATE SIZE SHALL NOT EXCEED 3/4" IN DIAMETER.

REINFORCING NOTES:

- 1. ALL REINFORCEMENT, EXCEPT FOR TIES AND STIRRUPS, SHALL CONFORM TO ASTM 615-60.
- 2. ALL REINFORCEMENT FOR TIES AND STIRRUPS SHALL CONFORM TO ASTM 615-40.
- 3. ALL WELDED WIRE FABRIC SHALL CONFORM TO ASTM A185-70 SPECIFICATIONS.
- 4. ALL REINFORCEMENT SHALL BE INSPECTED AND APPROVED BY THE ARCHITECT OR HIS ENGINEER PRIOR TO THE PLACEMENT OF ANY CONCRETE.
- 5. THE CONTRACTOR SHALL SUBMIT FOUR PRINTS OF SHOP DRAWINGS: SHOWING ALL REINFORCING DETAILS, CHAIR BARS, HIGH CHAIRS, SLAB BOLSTERS, ETC. TO THE ARCHITECT FOR HIS APPROVAL. THE CONTRACTOR SHALL RECEIVE WRITTEN APPROVED SHOP DRAWINGS FROM THE ARCHITECT OR HIS ENGINEER PRIOR TO THE FABRICATION OF REINFORCEMENT.
- 6. CLEARANCES OF MAIN REINFORCING FROM ADJACENT CONCRETE SURFACES SHALL BE AS FOLLOWS:

3 INCHES

2 INCHES

- A. FOOTINGS
- B. SIDES OF FOUNDATIONS WALLS.
 EXPOSED FACES OF FOUNDATIONS.
 SIDES OF COLUMNS/PIERS, SLABS
- ON GRADE FROM TOP SURFACE
 C. INTERIOR FACES OF FOUNDATIONS,
- TOP REINFORCING IN SLABS EXPOSED TO THE WEATHER
- TO THE WEATHER 1-1/2 INCHES
 D. TOP STEEL OF INTERIOR SLABS 1 INCHES
 7. MAXIMUM DEVIATION FROM THESE REQUIREMENTS SHALL BE 1/4" OF
- MAXIMUM DEVIATION FROM THESE REQUIREMENTS SHALL BE 1/4" SECTIONS 10" OR LESS, 1/2" FOR SECTIONS GREATER THAN 10".

DESIGN CRITERIA:

ALL WORK PERFORMED UNDER THIS CONTRACT SHALL CONFORM TO THE NINTH EDITION OF THE MASSACHUSETTS BUILDING CODE.

DESIGN LIVE LOAD = 40 POUNDS PER SQUARE FOOT

- FLOORS - PRIVATE DECK

DESIGN SNOW LOAD = 40 POUNDS PER SQUARE FOOT

WITH SNOW DRIFT WHERE APPLICABLE.

WIND LOAD = 128 MILES PER HOUR SEISMIC: Ss = 0.217

S1 = 0.069

ALL LUMBER SHALL BE #2 SPF, Fb= 875 PSI, Fv=135 PSI.

WOOD NOTES:

- 1. ALL LUMBER SHALL HAVE A MOISTURE CONTENT OF NOT MORE THAN 19%.
- 2. ALL FRAMING LUMBER SHALL BE #2 SPF, OR BETTER, HAVING A MINIMUM:

FB=875 PSI, FV=135 PSI, E=1,300,000 PSI.

- 3. ALL JOIST SPANS SHALL HAVE ONE ROW OF 1" X 3: CROSS BRIDGING AT MID SPAN AND NOT MORE THAN 8'-O" O.C.
- 4. ALL STUD BEARING WALLS SHALL HAVE ONE ROW OF 2X
 HORIZONTAL BLOCKING AT 1/2 STUD HEIGHT, AND NOT MORE THAN
 6'-O" O.C. MAXIMUM
- 5. PROVIDE AND INSTALL ALL NECESSARY TIMBER CONNECTORS WITH ADEQUATE STRENGTH.
- 6. PROVIDE DOUBLE JOIST BELOW PARTITIONS PARALLEL TO JOIST FRAMING.
- 7. PROVIDE SOLID BRIDGING BELOW PARTITIONS PERPENDICULAR TO JOIST FRAMING.
- 8. PROVIDE SOLID BRIDGING BETWEEN JOIST FRAMING MEMBERS WHEN BEARING ON STUD PARTITIONS OR BEAMS.
- 9. PROVIDE A CONTINUOUS BAND JOIST AT EXTERIOR STUD WALLS.
- 10. PROVIDE DIAGONAL METAL STRAP BRACING AT ALL CORNERS AND WALL INTERSECTIONS, AT THE INSIDE FACE OF STUDS, FROM TOP PLATE TO FLOOR PLATE AT A 45 DEGREE ANGLE WITH A SIMPSON TYPE "RCWB" STRAP, OR EQUAL.
- 11. ALL BUILT-UP BEAMS SHALL BE BOLTED WITH $\frac{1}{2}$ " Ø THRU BOLTS, MEETING A307 STANDARDS, OR, AS NOTED ON DRAWINGS.

WOOD LINTEL SCHEDULE:

Lintels over openings in bearing walls shall be as follows;or as noted on drawings.

Span o	f opening:	Size: 2x6 studs	Size: 2x4 studs
less tha	an 4'-0"	3 - 2x4	2 - 2x4
up to	6'-0"	3 - 2x6	2 - 2x6
up to	8'-0"	3 - 2x8	2 - 2x8
up to	10'-0"	3 - 2x10	2 - 2x10

DEMO NOTES

- 1. DEMOLITION CONTRACTOR IS TO ARRANGE FOR SHUT OFF OF EXISTING UTILITIES. CONTRACTOR SHALL ARRANGE ALL TEMPORARY POWER.
- 2. CONTRACTOR SHALL COORDINATE ALL DEMOLITION WITH NEW CONSTRUCTION BEFORE STARTING DEMOLITION.
- 3. ALL EXISTING UNUSED WALL PENETRATIONS IN INTERIOR AND EXTERIOR WALLS ALONG WITH PENETRATIONS LEFT AFTER SELECTIVE DEMOLITION ACTIVITIES SHALL BE INFILLED TO MATCH ADJACENT WALL FINISHES AND THICKNESS AS DIRECTED.
- 4. MAINTAIN CLEAR EXIT PATHS DURING DEMOLITION AND CONSTRUCTION ACTIVITIES.
- 5. ALL STRUCTURAL ELEMENTS SHALL BE PROTECTED DURING DEMOLITION.
- 6. REMOVE ONLY NON-LOAD BEARING CONSTRUCTION AND PARTITIONS. CONTRACTOR TO VERIFY, PRIOR TO REMOVAL, THAT NO STRUCTURAL COMPONENTS, I.E. BEARING WALLS, BEAMS, HEADERS, ETC.. SUPPORTING FLOOR, ROOF OR CEILING JOISTS ARE DESIGNATED FOR REMOVAL. CONTACT THE ARCHITECT PRIOR TO REMOVAL OF ANY CONSTRUCTION IN QUESTION OR DEVIATING FROM THE DESIGN INTENT. CONTRACTOR'S NON-CONTACT OF ARCHITECT PRIOR TO REMOVAL OF ANY WORK INDICATES HIS COMPLETE UNDERSTANDING THAT NO LOAD BEARING OR STRUCTURAL WORK IS BEING ALTERED UNDER THIS CONTRACT.
- 7. PROTECT ALL EXISTING STRUCTURE, SYSTEMS, FINISHES AND GENERAL CONSTRUCTION THAT ARE TO REMAIN THROUGHOUT THE COURSE OF THE WORK TO PREVENT DAMAGE OR LOSS. ANY SUCH DAMAGE CAUSED DURING THE COURSE OF THIS WORK WILL BE REPAIRED AT THE CONTRACTOR'S EXPENSE BEFORE THIS WORK IS CONCLUDED.
- 8. ALL STRUCTURAL FLOOR SHOULD BE REMOVE AND REPLACE ONE FLOOR AT A TIME.
- 9. CONTRACTOR IS TO VERIFY UTILITY LINE LOCATIONS AND MAINTAIN THOSE THAT SERVE OTHER PARTS OF THE BUILDING THAT ARE NOT AFFECTED BY THE DEMOLITION.
- 10. ALL WORK WILL BE PERFORMED IN THE BEST WORKMANSHIP POSSIBLE IN ACCORDANCE WITH THAT TRADE'S BEST INDUSTRY STANDARDS.
- 11. G.C. TO MAINTAINING FIRE SEPARATION BETWEEN ATTACHED BUILDING.

EXTERIOR:

- 1. REMOVE ALL WINDOWS, SKYLIGHTS, AND DOORS SHOWN DASHED.
- 2. REMOVE ALL EXISTING ROOFING MATERIALS. EXISTING FLASHING TO REMAIN WERE POSSIBLE.
- 3. REMOVE ALL ROOF PENETRATION ELEMENTS. PROVIDE TEMPORARY UNIT AS NEEDED WITH COMMON ELEMENTS.
- 4. REMOVE EXISTING REAR WALLS SHOWN DASHED, INCLUDING ALL MECHANICAL, ELECTRICAL AND PLUMBING ITEMS THERE IN. PROVIDE TEMPORARY SUPPORT AS NEEDED.

INTERIOR:

- 1. REMOVE ALL EXISTING NON-LOAD BEARING WALLS, DOORS, AND PARTITIONS SHOWN DASHED,
- INCLUDING ALL MECHANICAL, ELECTRICAL AND PLUMBING ITEMS THERE IN.
- 2. REMOVE EXISTING MEZZANINE STAIR.
- 3. EXISTING MEZZANINE TO BE REMOVED OVER KITCHEN AND BACK TO THE STEP UP AT THE ENTRY WALL.
- 4. REMOVE ALL FLOOR AND CEILING FINISHES BACK TO SUBSTRATE.
- 5. CONTRACTOR RESPONSIBLE FOR THE REMOVAL AND DISPOSAL OF APPLIANCES
- AND PLUMBING FIXTURES, ACCESSORIES AND ASSOCIATED
- 6. CONTRACTOR IS RESPONSIBLE FOR THE DEMOLITION OF ALL CEILINGS, FURRING
- STRIPS AND FASTENERS DOWN TO EXPOSED STRUCTURE AT EXISTING PITCHED ROOF AREA.
- 7. G.C. IS RESPONSIBLE FOR PATCHING AND FINISHING ANY REMAINING WALLS. G.C. IS RESPONSIBLE TO MAINTAIN FIRE WALL & SEPARATION AND PATCH ANY OPENINGS OR GAPS IN KIND AFFECTED BY THE DEMOLITION TO MATCH EXISTING EXACTLY OR PER INTERIOR SPECS.
- 8. G.C. SHALL BE FULLY RESPONSIBLE FOR PROTECTING ALL EXISTING SURFACES AND
- ITEMS TO REMAIN, TYPICAL THROUGHOUT.
- 9. COORDINATE ALL DEMOLITION WITH STRUCTURAL DRAWINGS. PROVIDE TEMPORARY SHORING AS REQUIRED.
- 10. GC IS RESPONSIBLE FOR PROVIDING DEMOLITION ENGINEERING IF REQUIRED.
- 11. EXISTING INTERIOR PARTITIONS ARE ASSUMED 2x4 WOOD STUDS WITH PLASTER OR GWB FINISH.
- 12. REMOVE AND PROPERLY DISPOSE OF ALL BASE TRIM, WAINSCOTING, CASING, AND MOLDING UNLESS OTHERWISE NOTED.

MEP NOTES

- 1. G.C. IS RESPONSIBLE FOR THE REMOVAL OF ALL PLUMBING FIXTURES.
- 2. G.C. IS RESPONSIBLE FOR KEEPING AND CAPPING OFF ANY PIPING WITHIN WALLS NOT BEING DEMOLISHED.
- 3. G.C. TO COORDINATE CAREFUL REMOVAL OF EXISTING LIGHTING WITH NEW LIGHTING PLANS.4. G.C. TO MAKE OBSOLETE ALL EXISTING KNOB AND TUBE


WIRING (IF APPLICABLE) . REMOVE WHERE DEMOLITION

5. G.C. IS RESPONSIBLE FOR CAPPING ANY GAS OR ELECTRICAL LINES.

Location

PROPOSED ADDITION & RENOVATION 45 MOUNT VERNON STRE



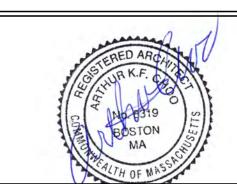

Revision Date

Project No: 2023208

Scale: AS NOTED

Date: 02-20-2024


Drawn By: DF

Drawing Name

GENERAL NOTES

Sheet No.

A-0.1

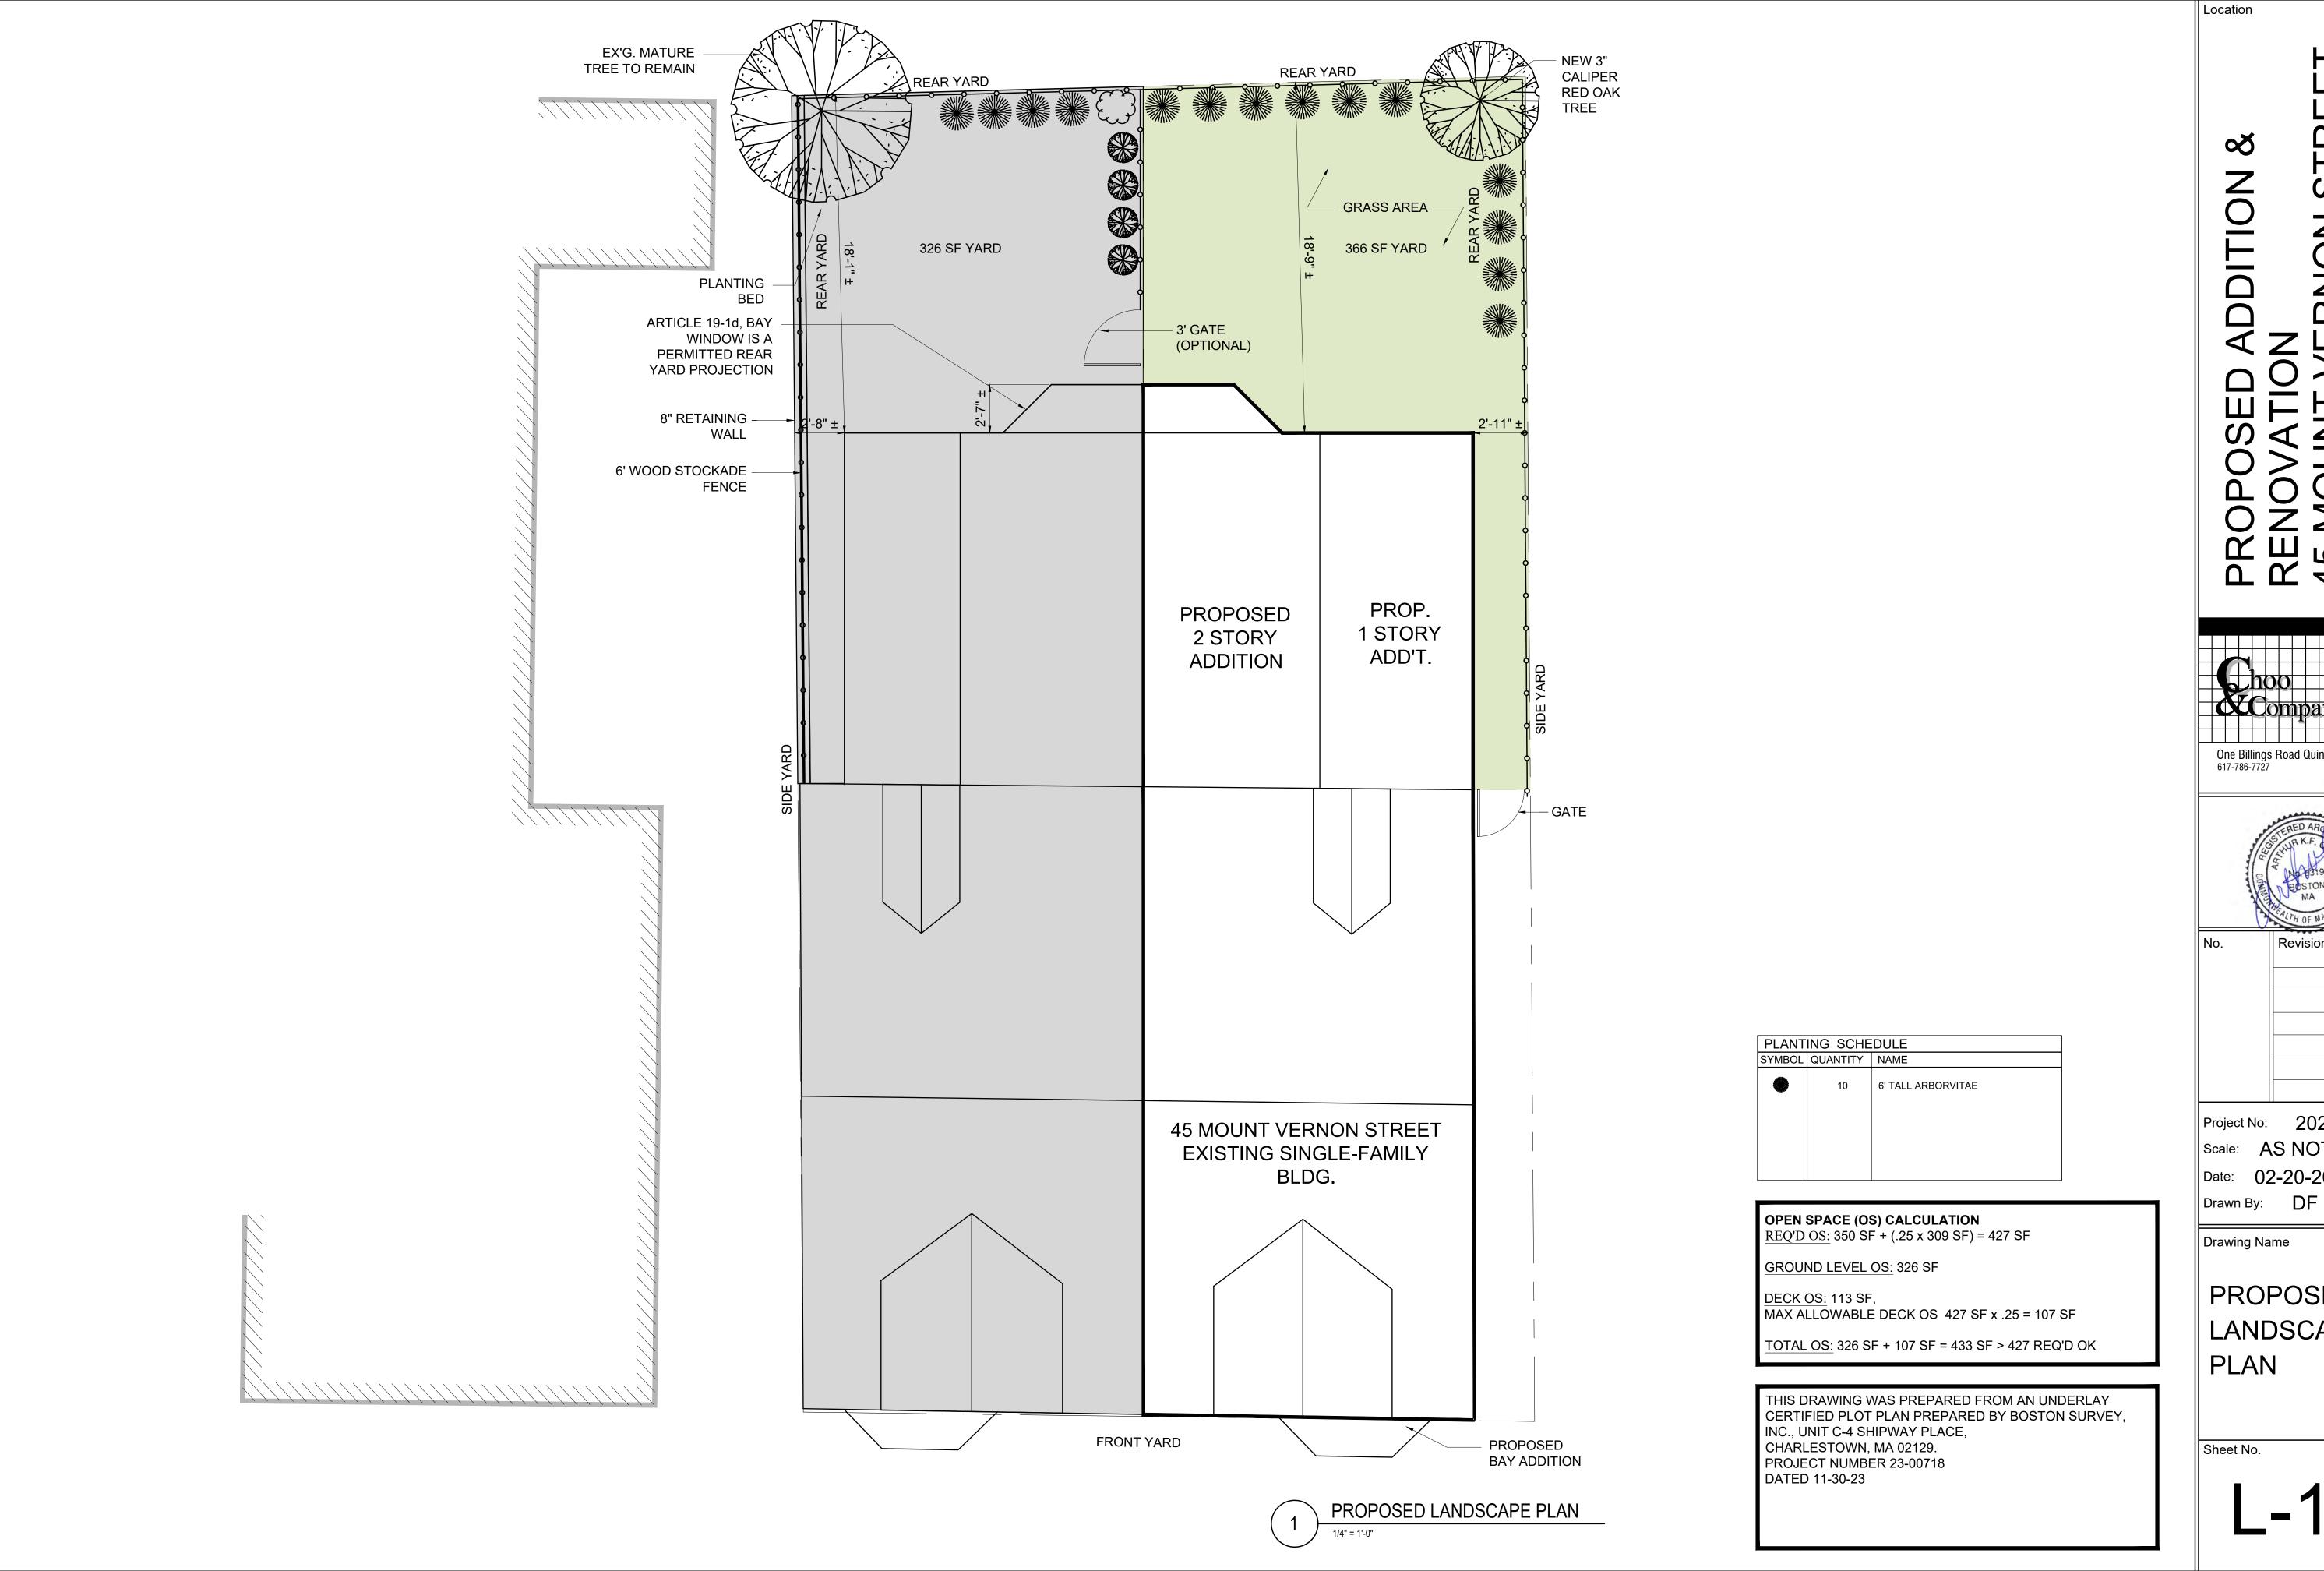

Location

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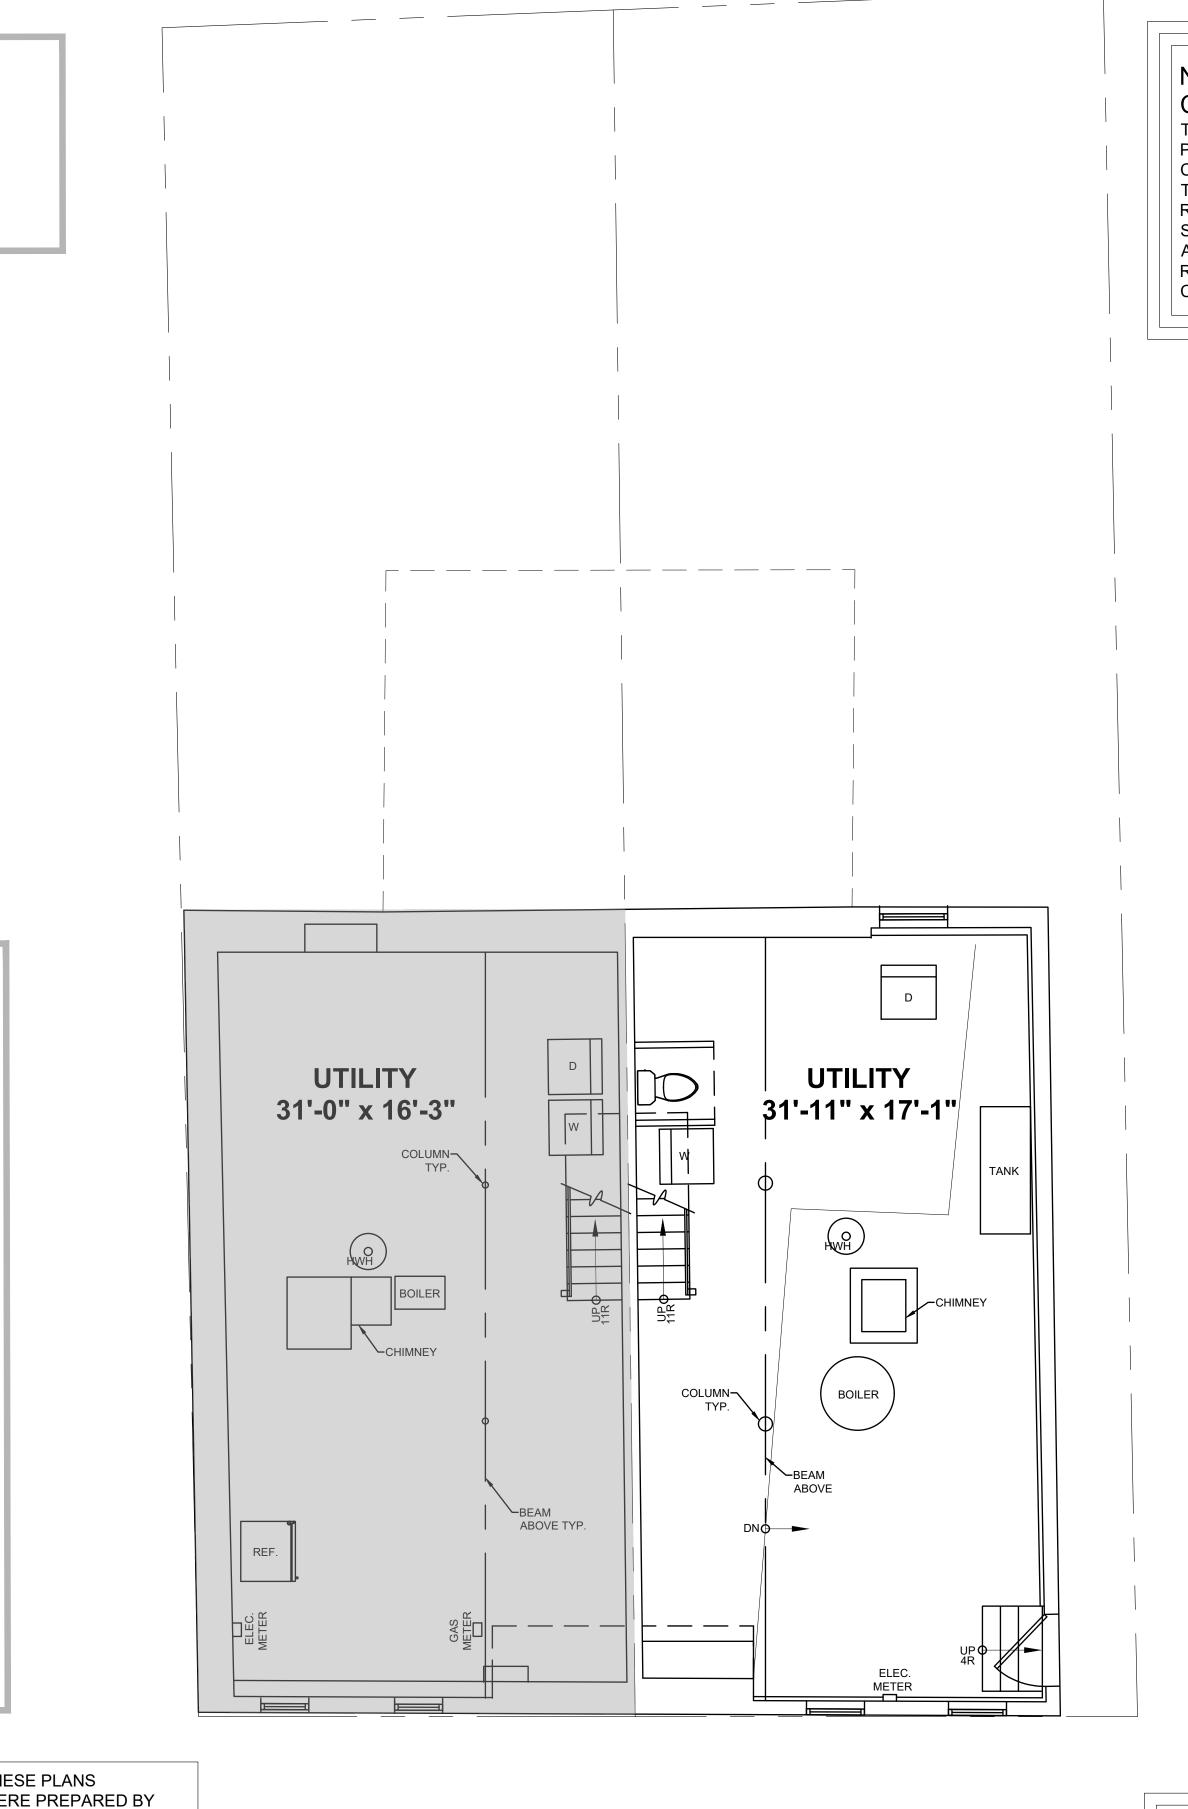
Revision Date

Project No: 2023208 Scale: AS NOTED Date: 02-20-2024

Drawing Name

PROPOSED LANDSCAPE PLAN

Sheet No.



NOTE:ENERGY CODE COMPLIANCE

THE CONTRACTOR IS RESPONSIBLE FOR PROVIDING STRETCH/ ENERGY CODE COMPLIANCE PRIOR TO CLOSING OF WALLS. THE PROPER ENERGY CONSULTANT, HERS RATER, OR OTHER ALLOWED PROFESSIONAL SHALL PERFORM THE FINAL INSPECTIONS ASSOCIATED WITH THE CONSTRUCTION REQUIREMENTS AT THE DIRECTION OF THE CONTRACTOR.

10" CONC. FROST WALL 4' BELOW GRADE **VENT W/ PAINTED -**PERFORATED **COVER PLATE** 2" CONC. RAT SLAB VENT W/ PAINTED -PERFORATED **COVER PLATE** NEW 18"X24" ACCESS DOOR NEW (2) LAYERS

TYPE X, 5/8" GWB <u>UTILITY</u> - FIRE BLOCKING **NEW WOOD STAIR** (12) RISERS @ 7 9/16" EA. (11) TREADS @ 10" EA. NEW 36" HIGH WOOD GUARDRAIL ON OPEN SIDE. NEW WALL MOUNTED 36" HIGH WOOD HANDRAIL. ROOM 16'-2" ±

GENERAL NOTES - NOTE: GC TO COORD. R. VALUES W/ HERS REPORT

- 1. PROVIDE R-30 INSULATION IN ALL FLOOR JOIST CAVITIES.
- 2. PROVIDE R-38.5 INSULATION IN ALL NEW EXTERIOR WALL CAVITIES.
 3. PROVIDE R-60 INSULATION IN ALL ROOF JOIST CAVITIES, TYPICAL.
- 4. PROVIDE R-19 INSULATION IN BASEMENT WALL EXTERIOR STUD WALL CAVITIES.
- 5. PROVIDE R-10 INSULATION UNDER SLAB
- 6. PROVIDE R-15 CI IN NEW CRAWL SPACE WALLS.


MT. VERNON STREET

PROPOSED BASEMENT FLOOR PLAN

Location

SENOVATION
5 MOUNT VERNON STREE
5 HARI FSTOWN MA 02129



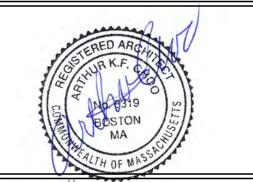

Revision Date

Project No: 2023208
Scale: AS NOTED
Date: 02-20-2024

Drawing Name

Drawn By: DF

EXISTING &
PROPOSED
BASEMENT
FLOOR PLANS

Sheet No.

A-1.0


THESE PLANS
WERE PREPARED BY
NATIONAL FLOOR PLANS
DATED NOVEMBER 2023


— MT. VERNON STREET —



EXISTING BASEMENT FLOOR PLAN

) 1/4" = 1'-0'

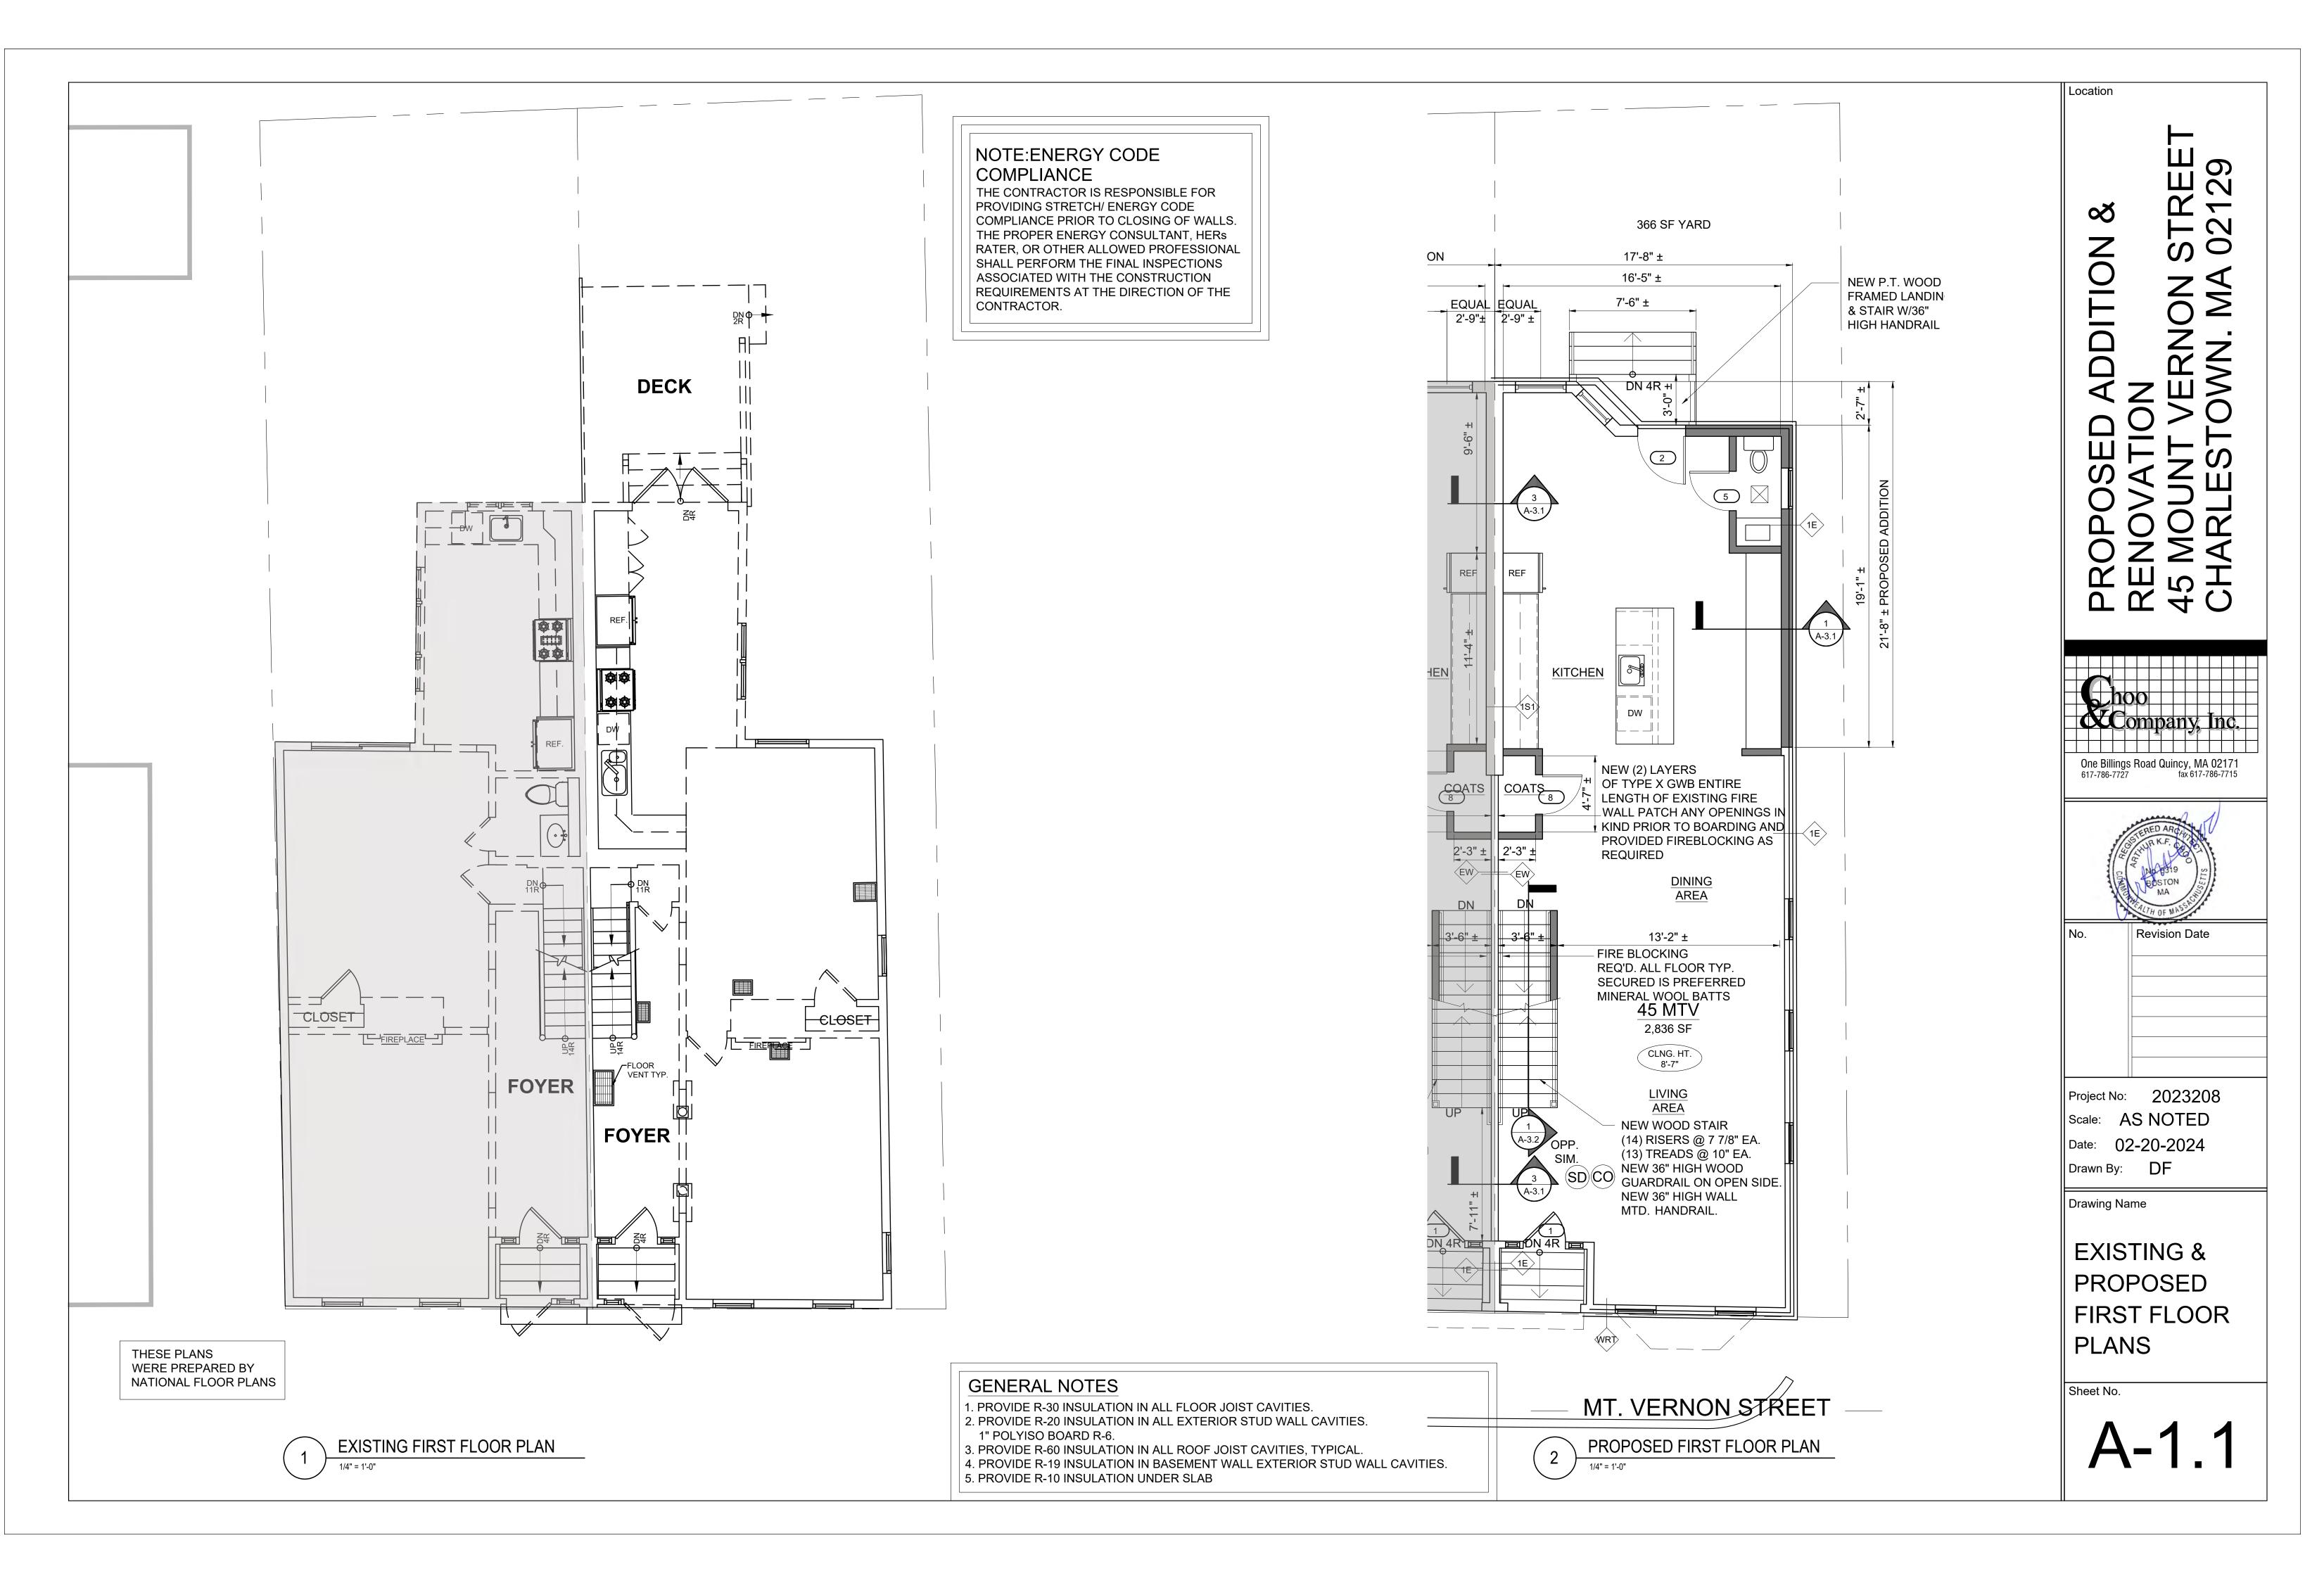

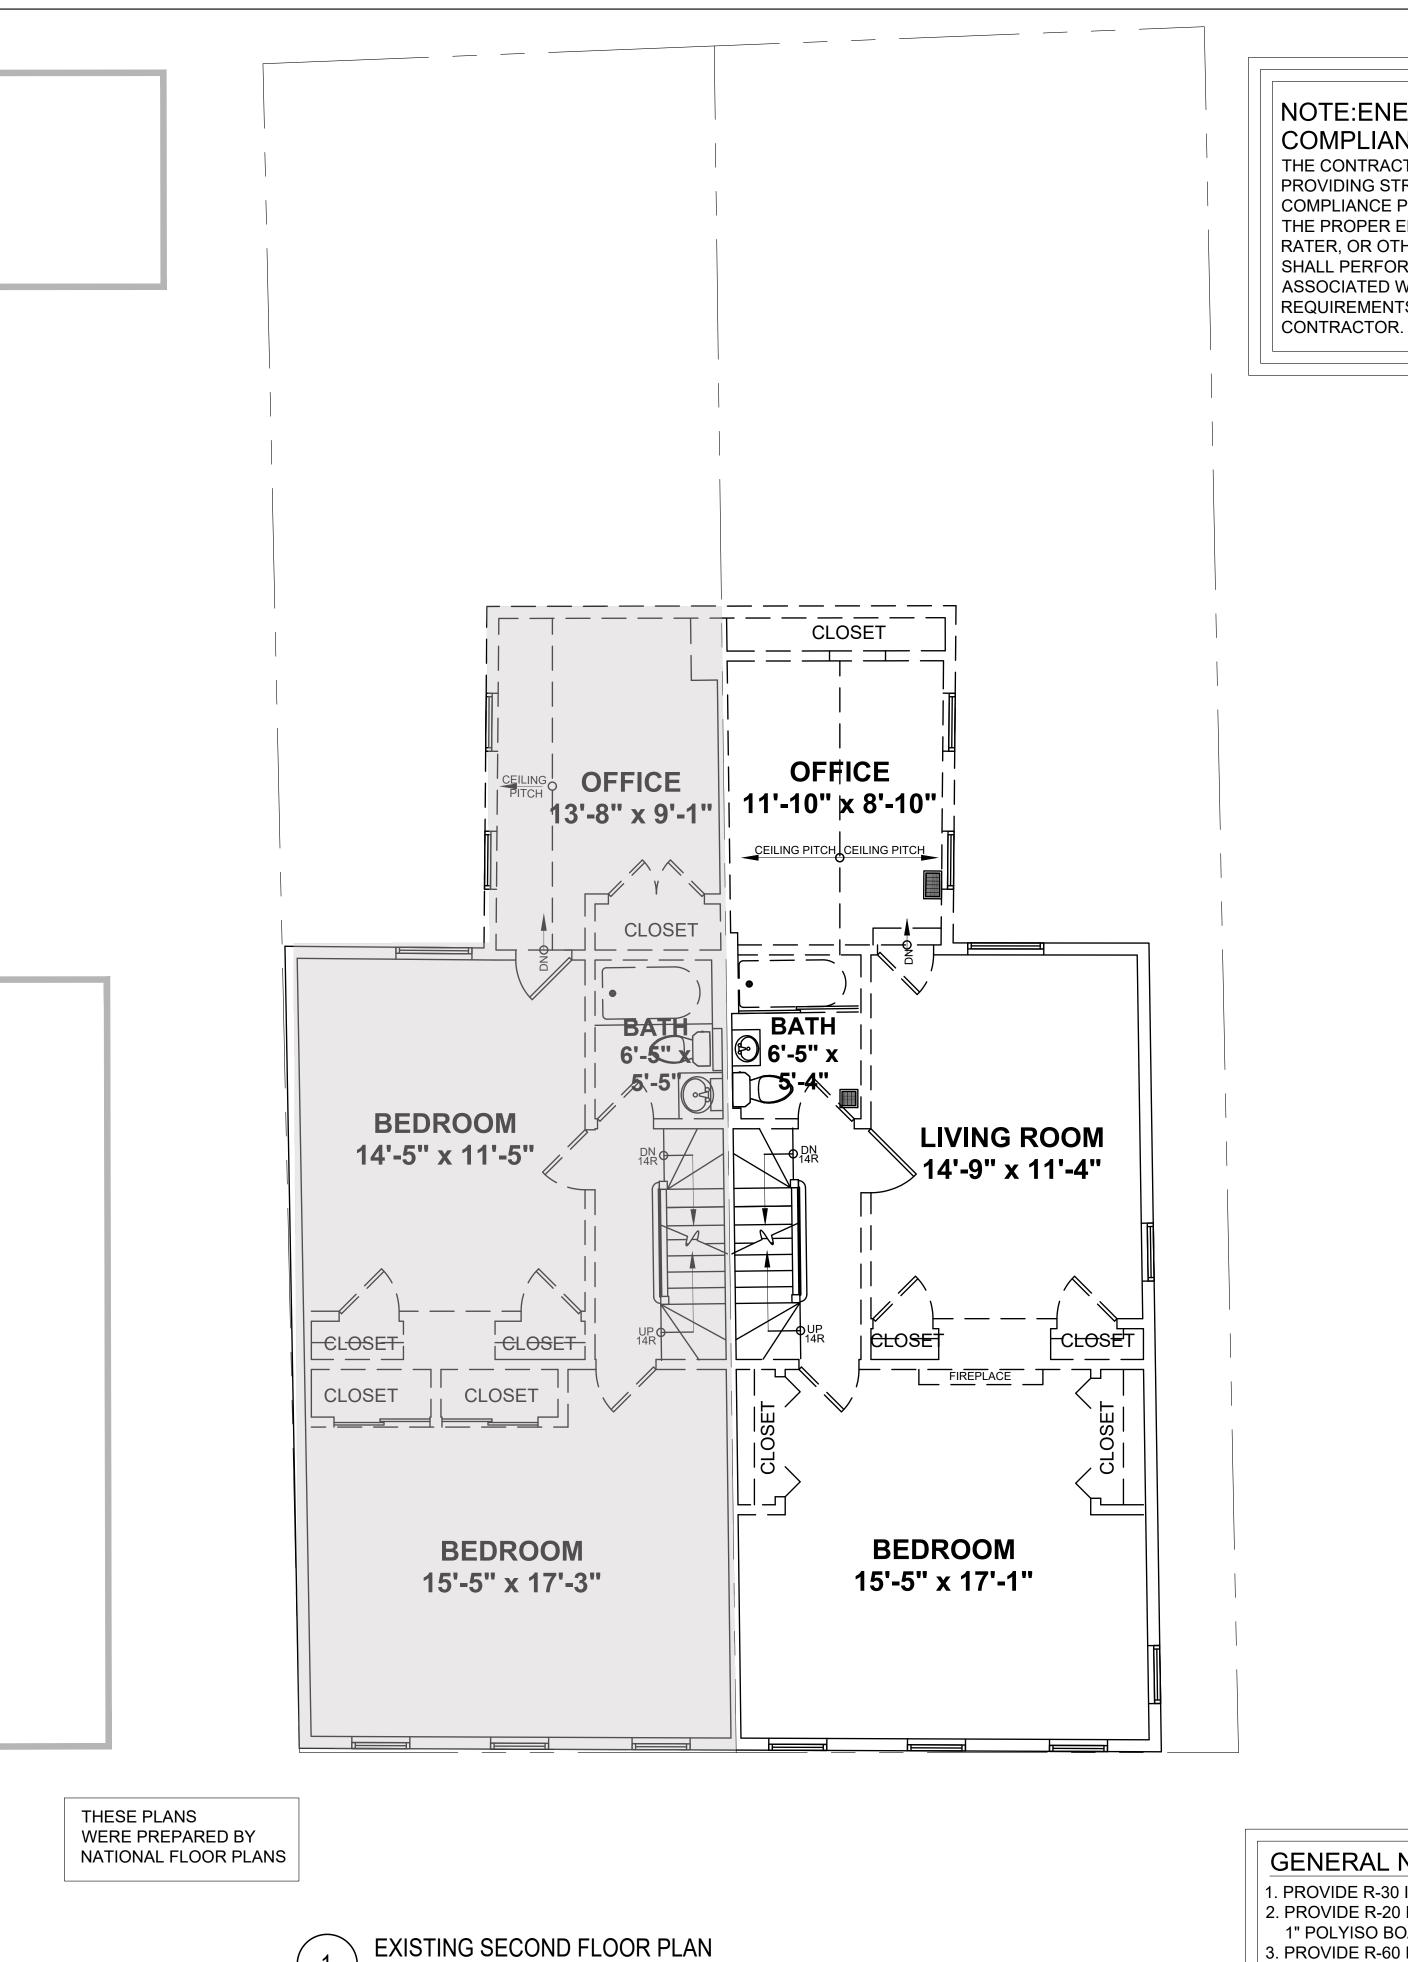

NOTE:ENERGY CODE COMPLIANCE

THE CONTRACTOR IS RESPONSIBLE FOR PROVIDING STRETCH/ ENERGY CODE COMPLIANCE PRIOR TO CLOSING OF WALLS. THE PROPER ENERGY CONSULTANT, HERS RATER, OR OTHER ALLOWED PROFESSIONAL SHALL PERFORM THE FINAL INSPECTIONS ASSOCIATED WITH THE CONSTRUCTION REQUIREMENTS AT THE DIRECTION OF THE

17'-8" ± PROPOSED ADDITION 9'-5" ± 8'-3" ± 8'-3" ± EQUAL EQUAL 6'-9" ± 2'-9"± 2'-9" ± ROOF BELOW BEDROOM 4 DECK 156 SF 4'-5" ± 8 4 3 9'-4" + FIRE BLOCKING AT • FIRE WALL REQ'D, SECURED MINERAL LINENS WOOL OR SIM. TYP. BEDROOM 3 NEW (2) LAYERS OF TYPE X GWB ENTIRE LENGTH OF EXISTING FIRE WALL PATCH ANY OPENINGS IN KIND PRIOR TO BOARDING AND PROVIDED FIREBLOCKING AS REQUIRED 9 CLNG. HT. 8'-0" 3'-2" + 3'-2" + (SD)(CO) UP (4) -NEW WOOD STAIR (14) RISERS @ 7 15/16" E (11) TREADS @ 9" EA. (2) LANDING 3'-2"X3'-2" SD NÉW 36" HIGH WOOD GUARDRAIL ON OPEN S SECONDARY NEW 36" HIGH WALL MTD. HANDRAIL. **EN SUITE** 11'-7" ± - DE MINIMIS DE MINIMIS **PROJECTION** PROJECTION 8'-3" ±
PROPOSED ADDITION

GENERAL NOTES

- 1. PROVIDE R-30 INSULATION IN ALL FLOOR JOIST CAVITIES.
- 2. PROVIDE R-20 INSULATION IN ALL EXTERIOR STUD WALL CAVITIES. 1" POLYISO BOARD R-6.
- 3. PROVIDE R-60 INSULATION IN ALL ROOF JOIST CAVITIES, TYPICAL.
- 4. PROVIDE R-19 INSULATION IN BASEMENT WALL EXTERIOR STUD WALL CAVITIES. 5. PROVIDE R-10 INSULATION UNDER SLAB

PROPOSED SECOND FLOOR PLAN

MT. VERNON STREET

Location

∞






Project No: 2023208 Scale: AS NOTED Date: 02-20-2024 Drawn By: DF

Drawing Name

EXISTING & PROPOSED SECOND FLOOR **PLANS**

Sheet No.

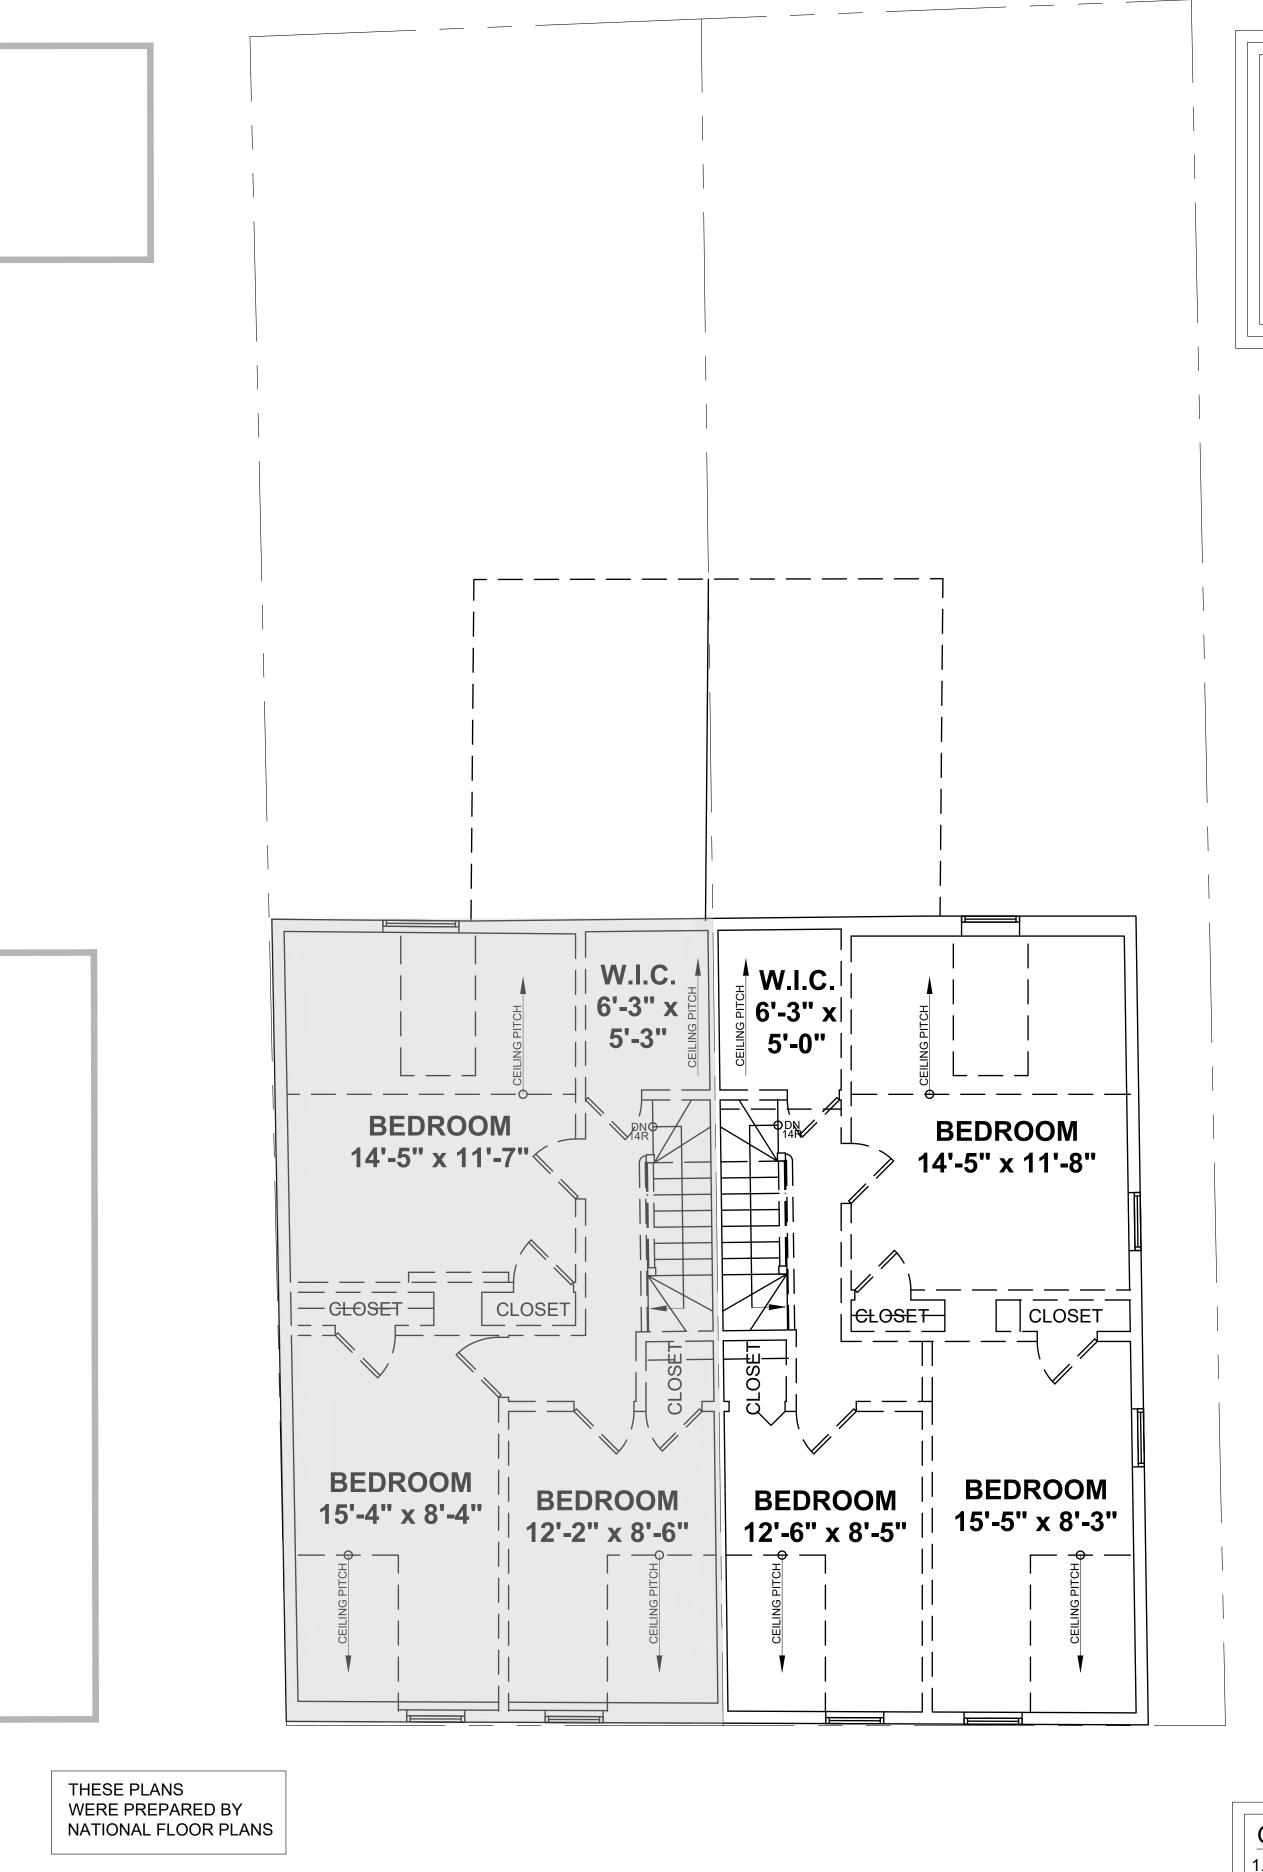

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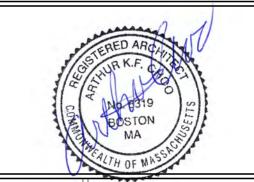
9'-5" ± DDITION PROPOSED ADDITION 4'-0" - LINE OF GUTTER FRT. ROOF SHEATHING - CLASS B MIN. ROOF COVERING 5/8" TYPE X (REQUIRED U ROOF SHEAT **ENTIRE ROO** 60 MIL EPDM ROOFING ON TAPERED SLOPE DN 9'-4" ± 4'-5" ± SDCO **EN SUITE** CLNG. HT. SLOPES TO 9'-8" +/-/ WIC 3'-10" ± 12'-11" ± 8'-7" ± ROOF BELOW 8'-3" ±
PROPOSED ADDITION MT. VERNON STREET

PROPOSED THIRD FLOOR PLAN

Location

∞ >

One Billings Road Quincy, MA 02171 617-786-7727 fax 617-786-7715



Revision Date

Project No: 2023208 Scale: AS NOTED Date: 02-20-2024

Drawing Name

Drawn By: DF


EXISTING & PROPOSED THIRD FLOOR **PLANS**


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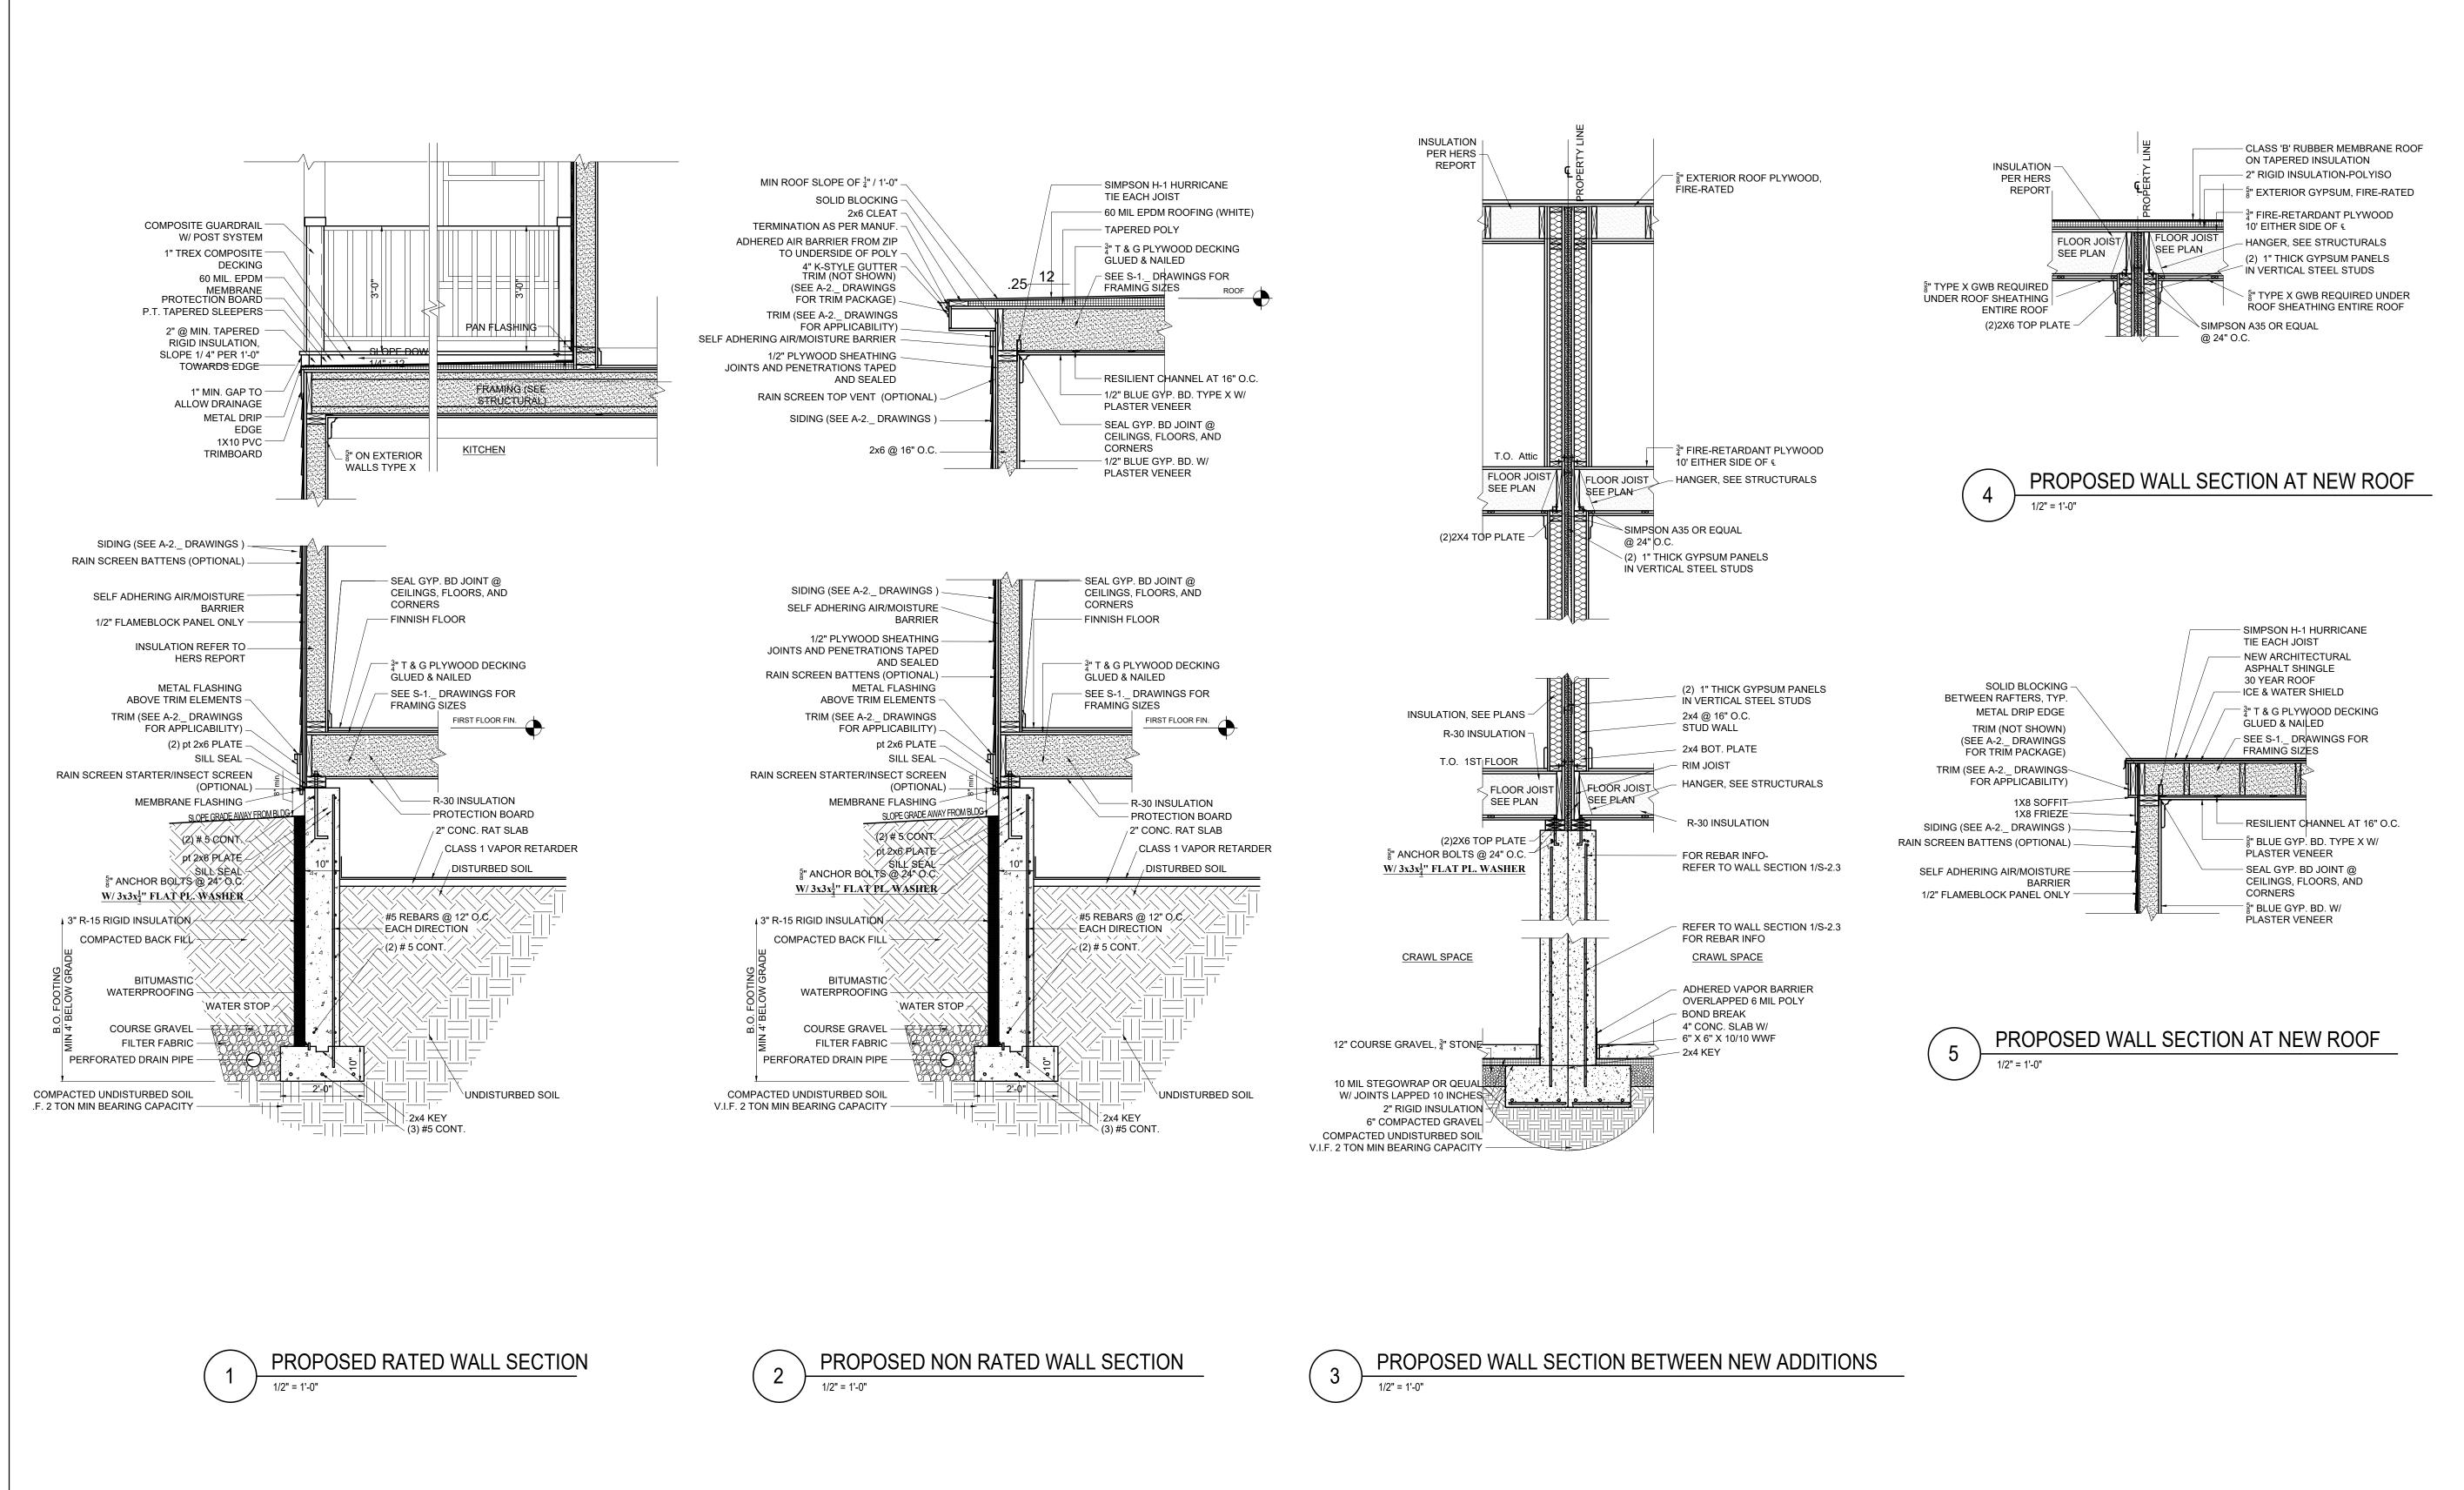
GENERAL NOTES

- 1. PROVIDE R-30 INSULATION IN ALL FLOOR JOIST CAVITIES.
- 2. PROVIDE R-20 INSULATION IN ALL EXTERIOR STUD WALL CAVITIES. 1" POLYISO BOARD R-6.
- 3. PROVIDE R-60 INSULATION IN ALL ROOF JOIST CAVITIES, TYPICAL.
- 4. PROVIDE R-19 INSULATION IN BASEMENT WALL EXTERIOR STUD WALL CAVITIES. 5. PROVIDE R-10 INSULATION UNDER SLAB

EXISTING THIRD FLOOR PLAN



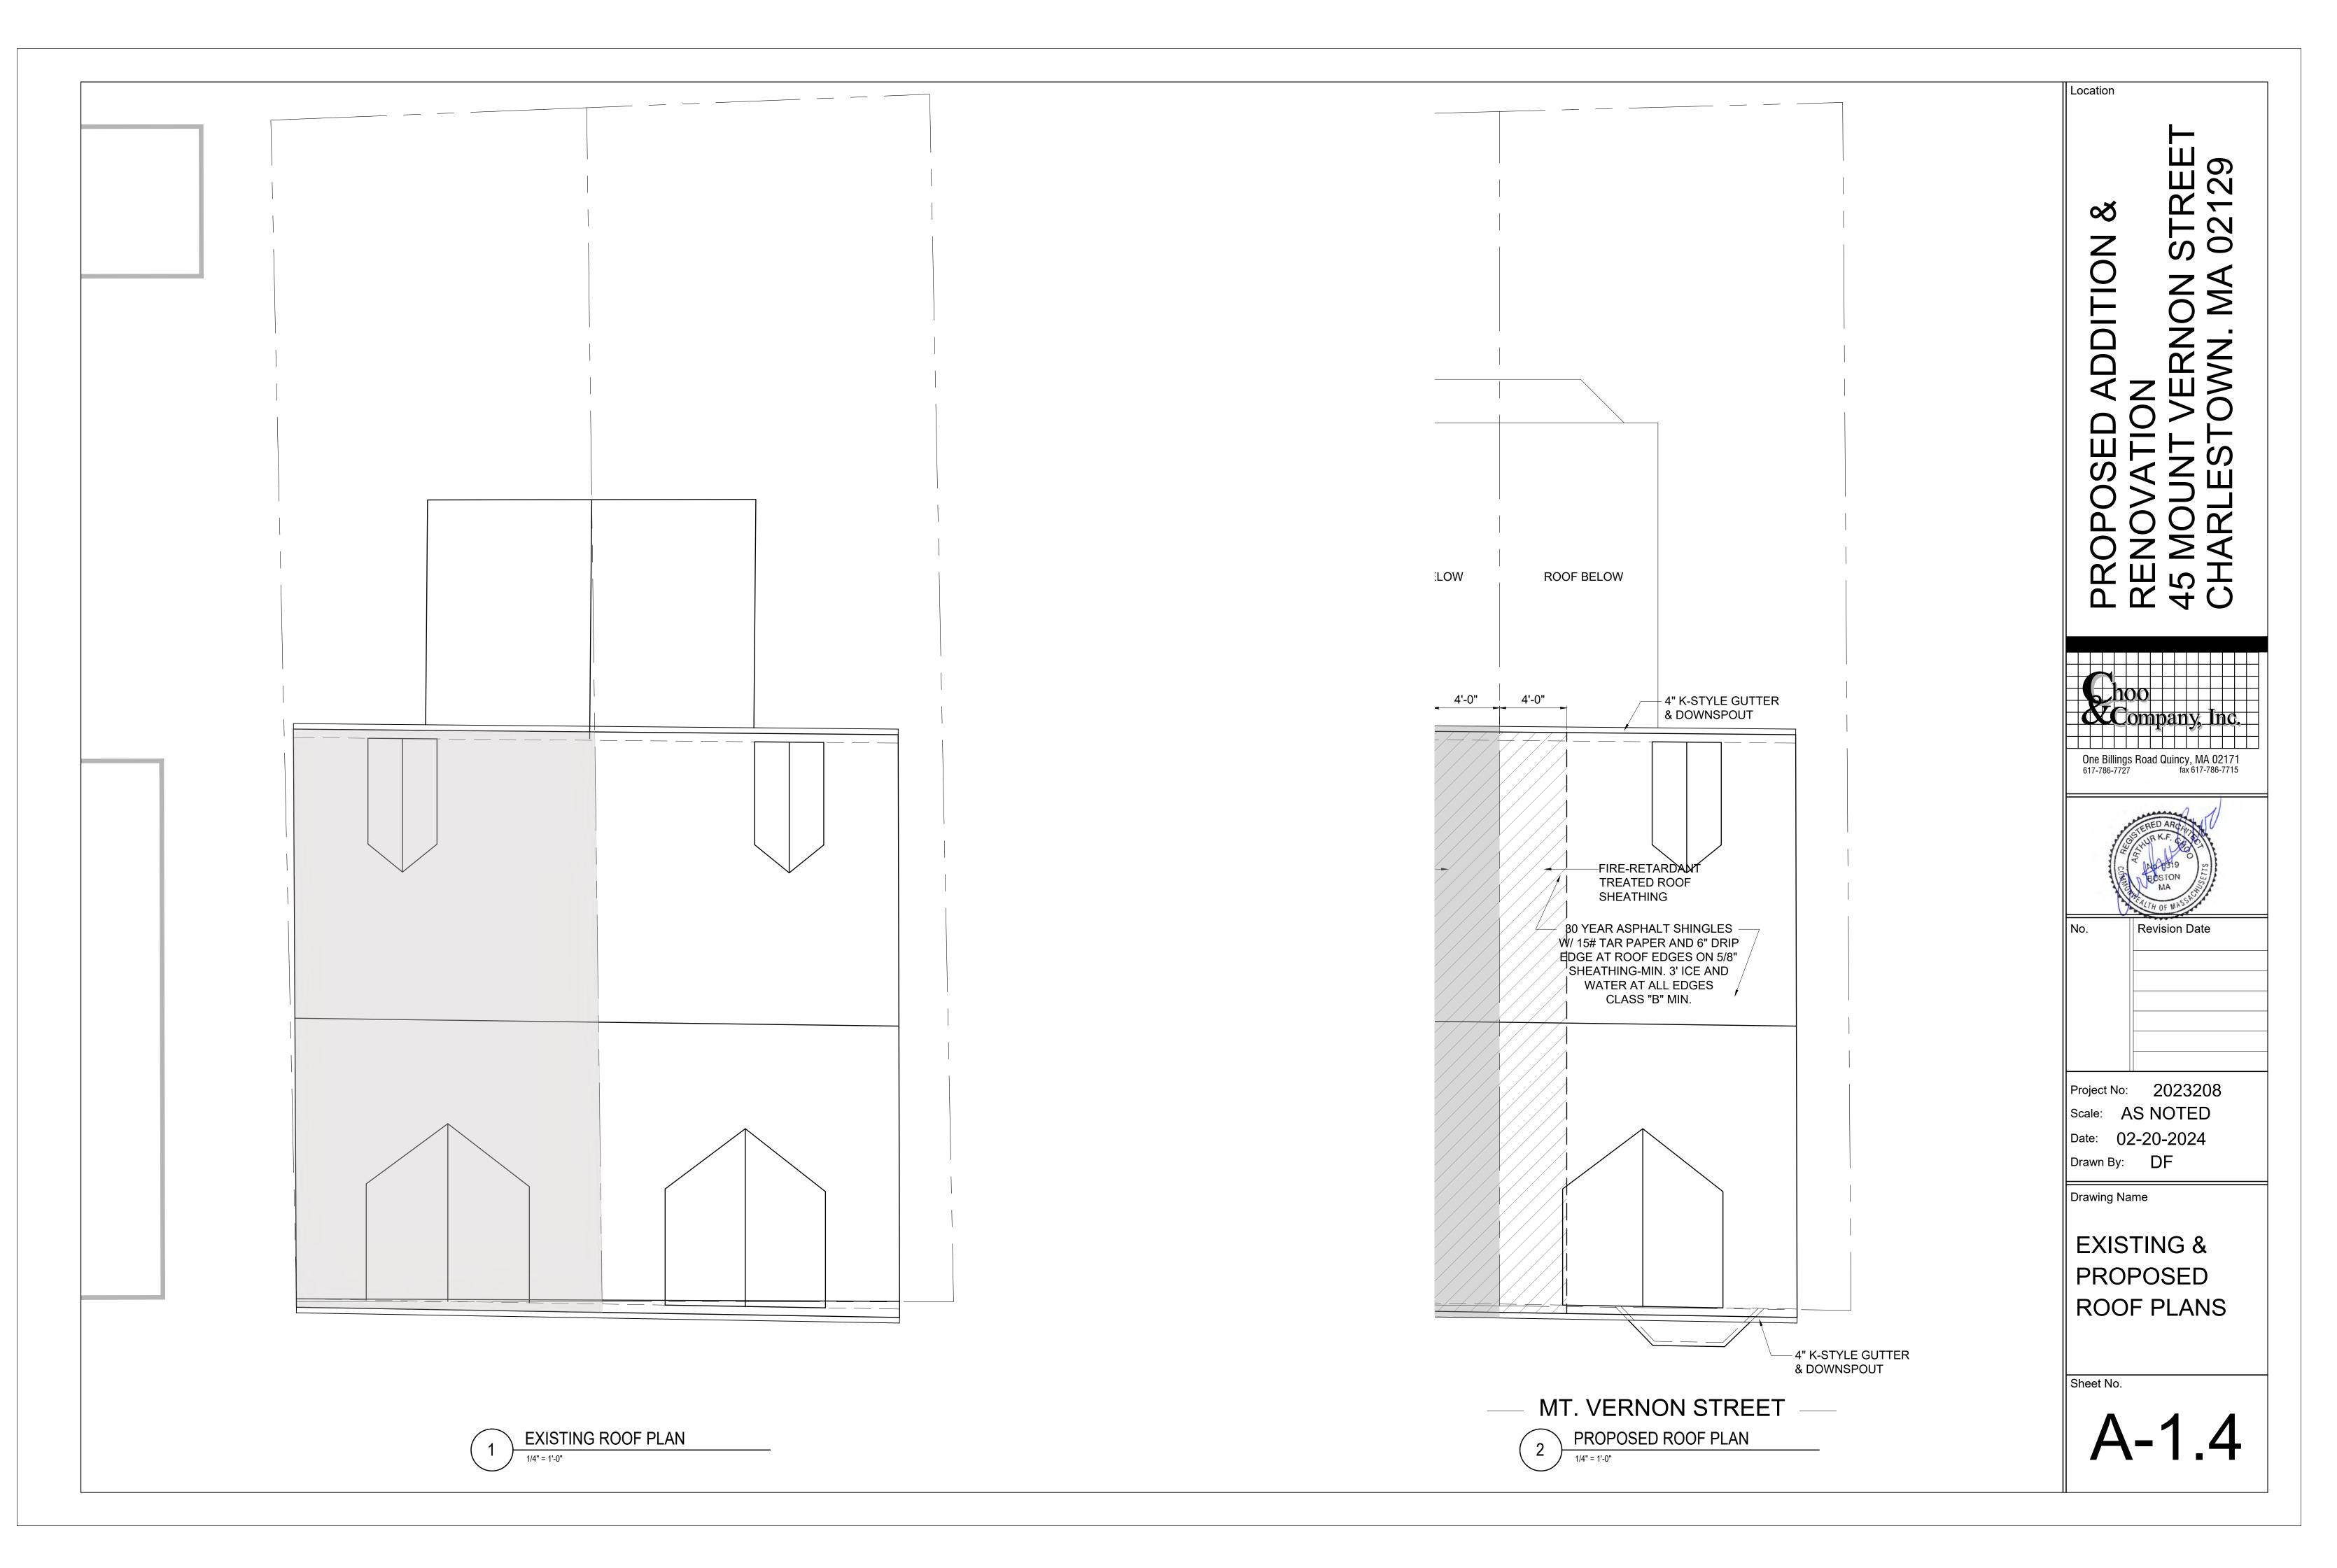


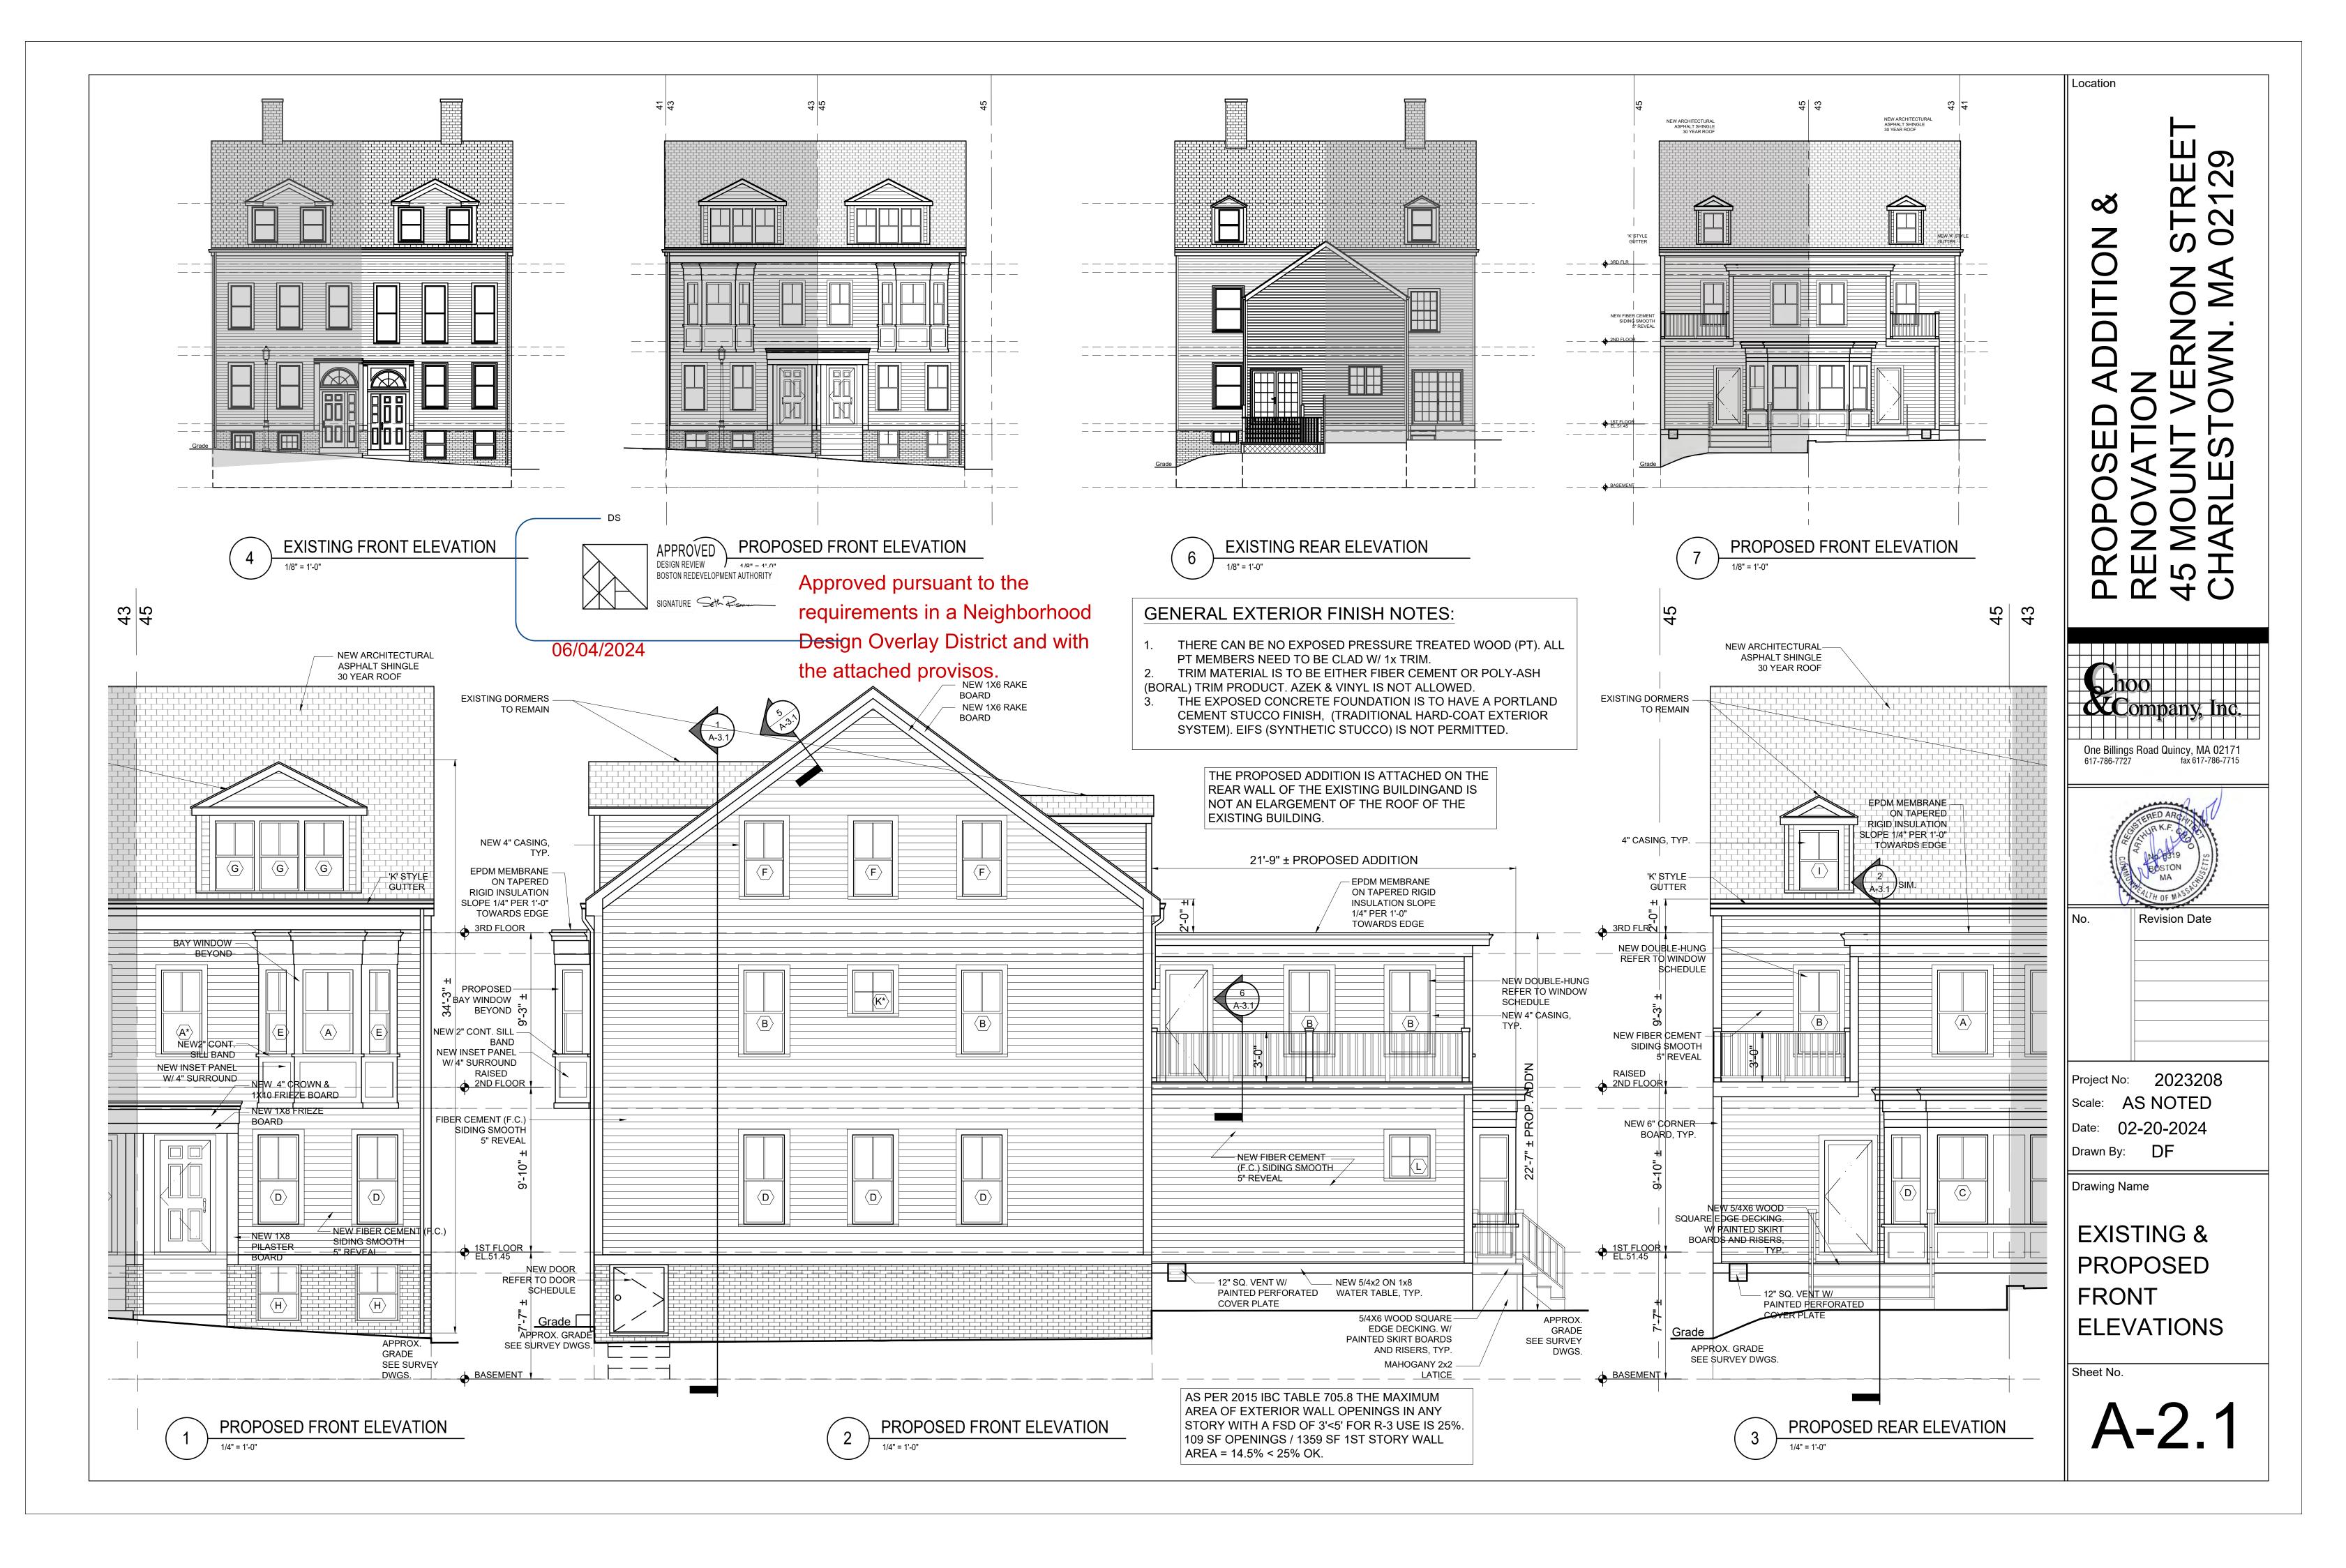

PROPOSED ADDITION &
RENOVATION
45 MOUNT VERNON STREET
CHARLESTOWN, MA 02129

Location

One Billings Road Quincy, MA 02171
617-786-7727 fax 617-786-7715

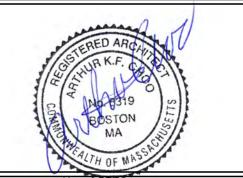

D. Revision Date


Project No: 2023208
Scale: AS NOTED
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Drawn By: DF


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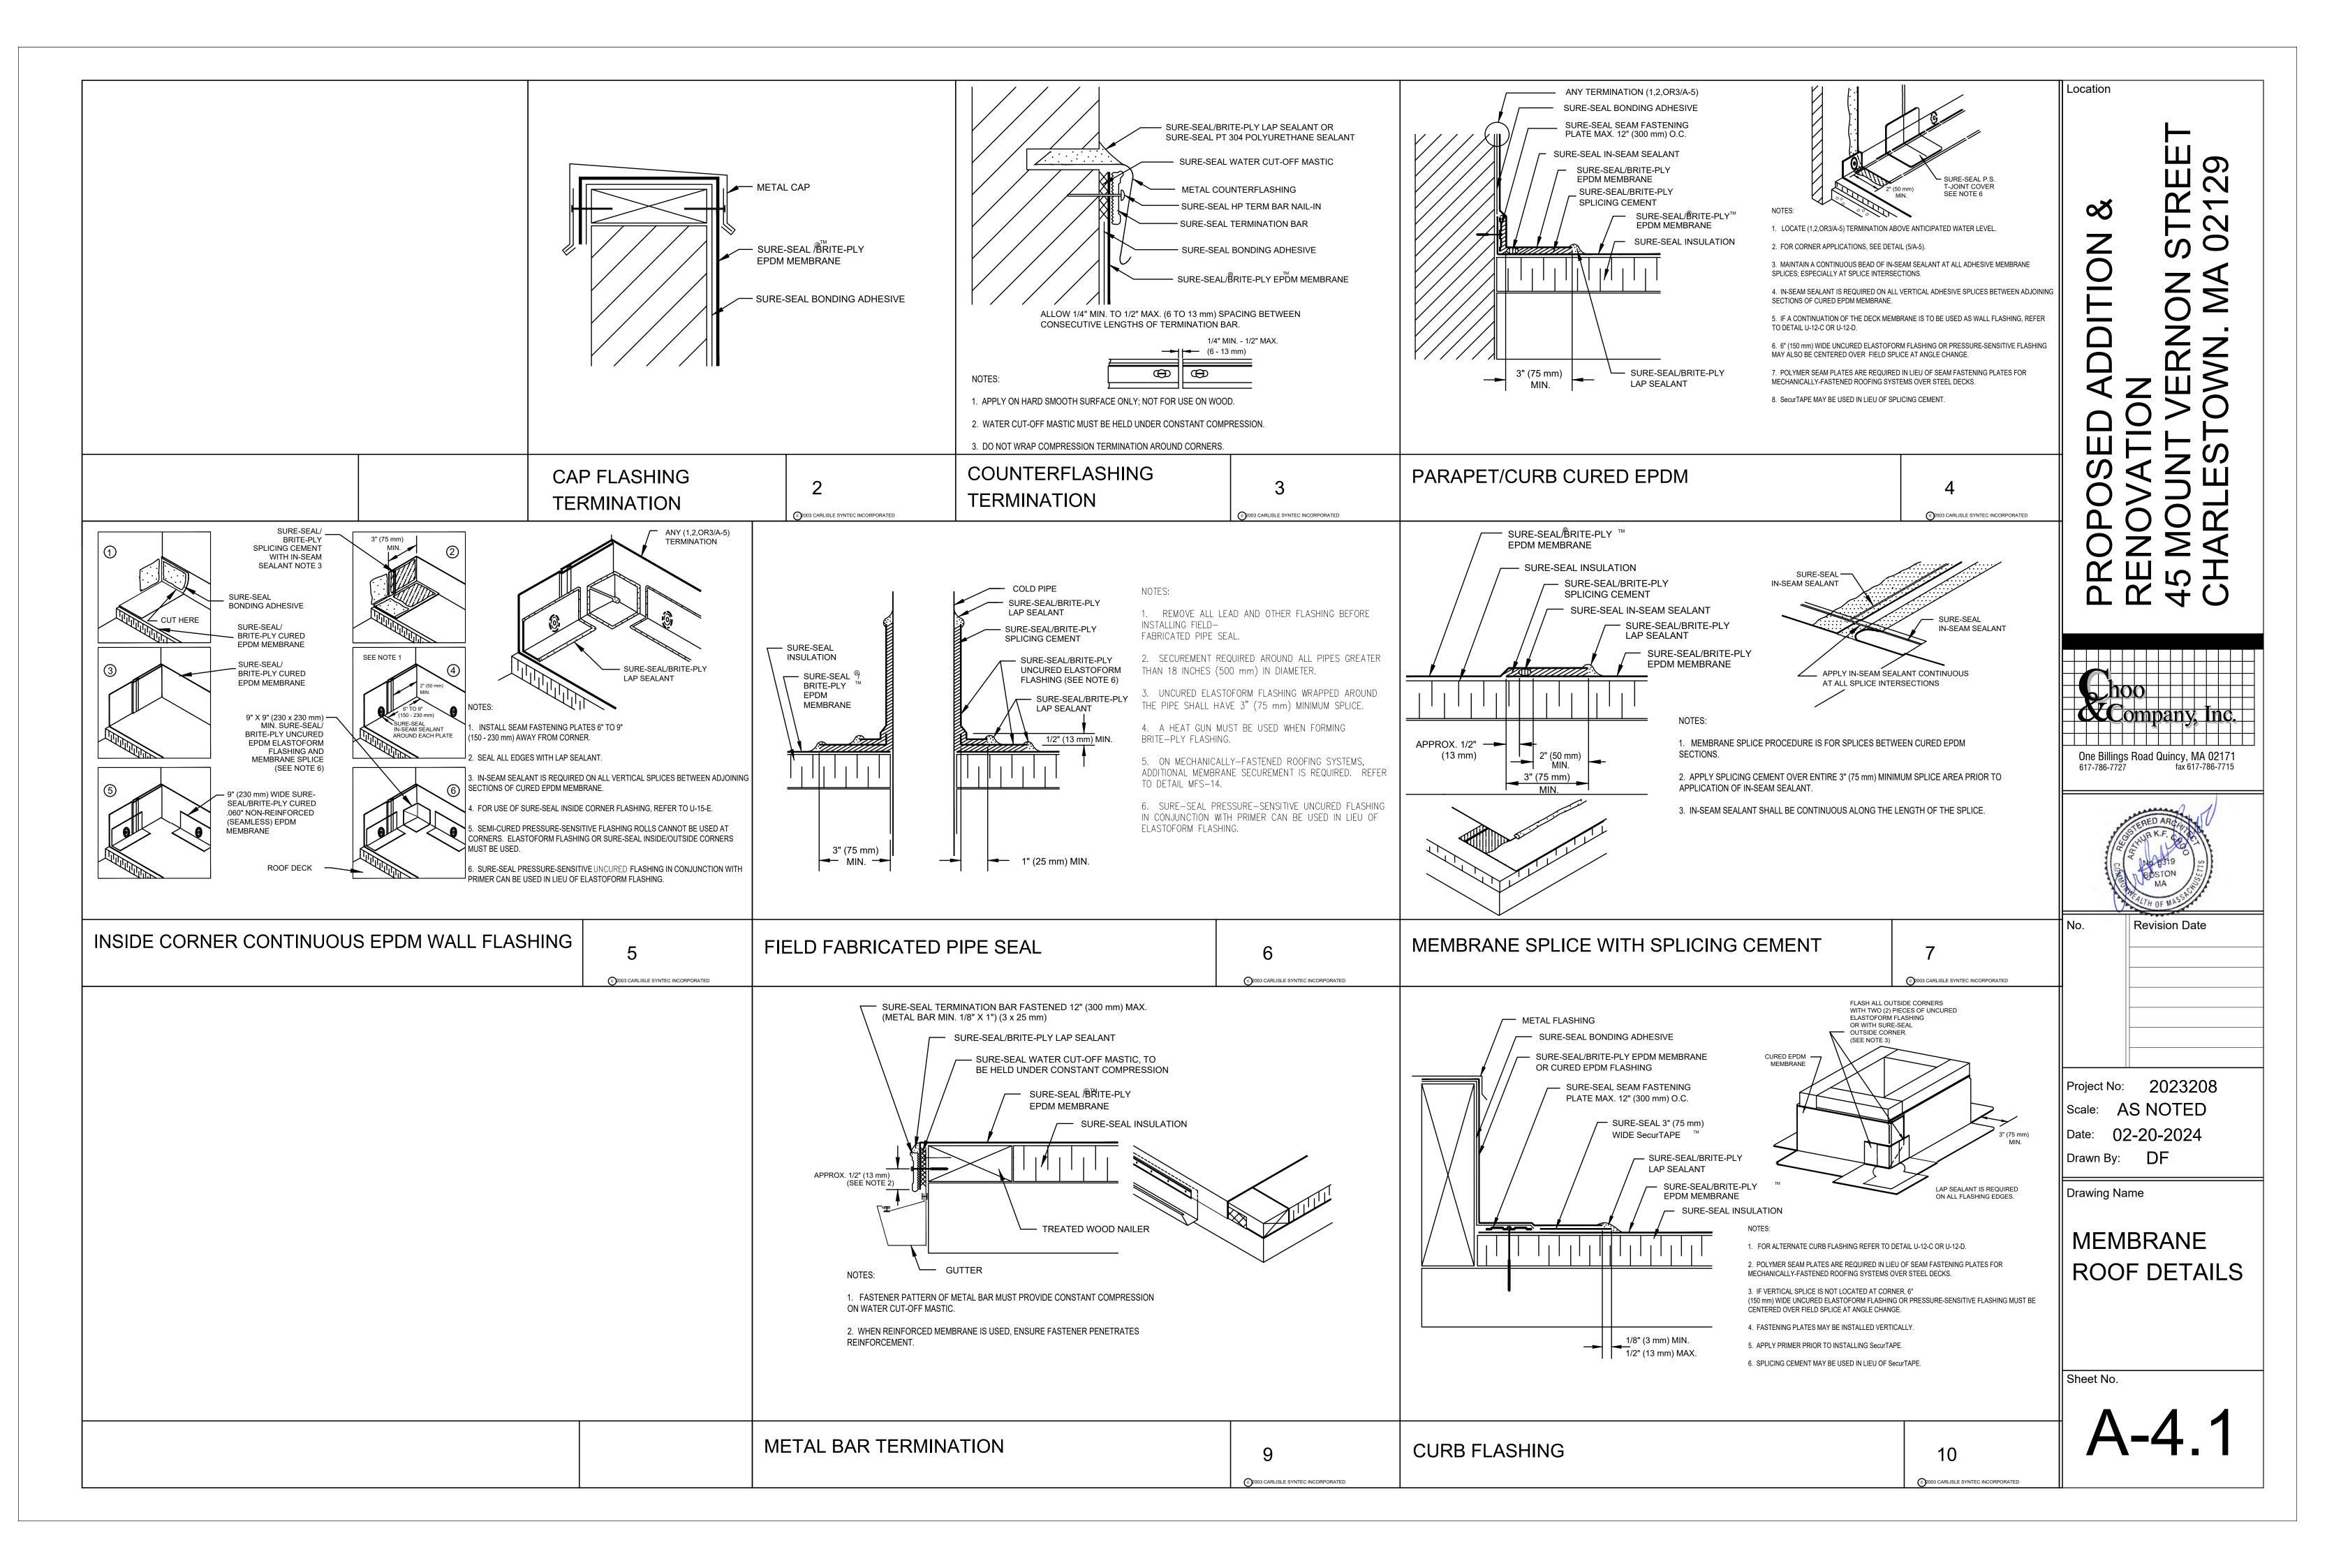
WALL SECTIONS & DETAILS

Sheet No.


A-3.1



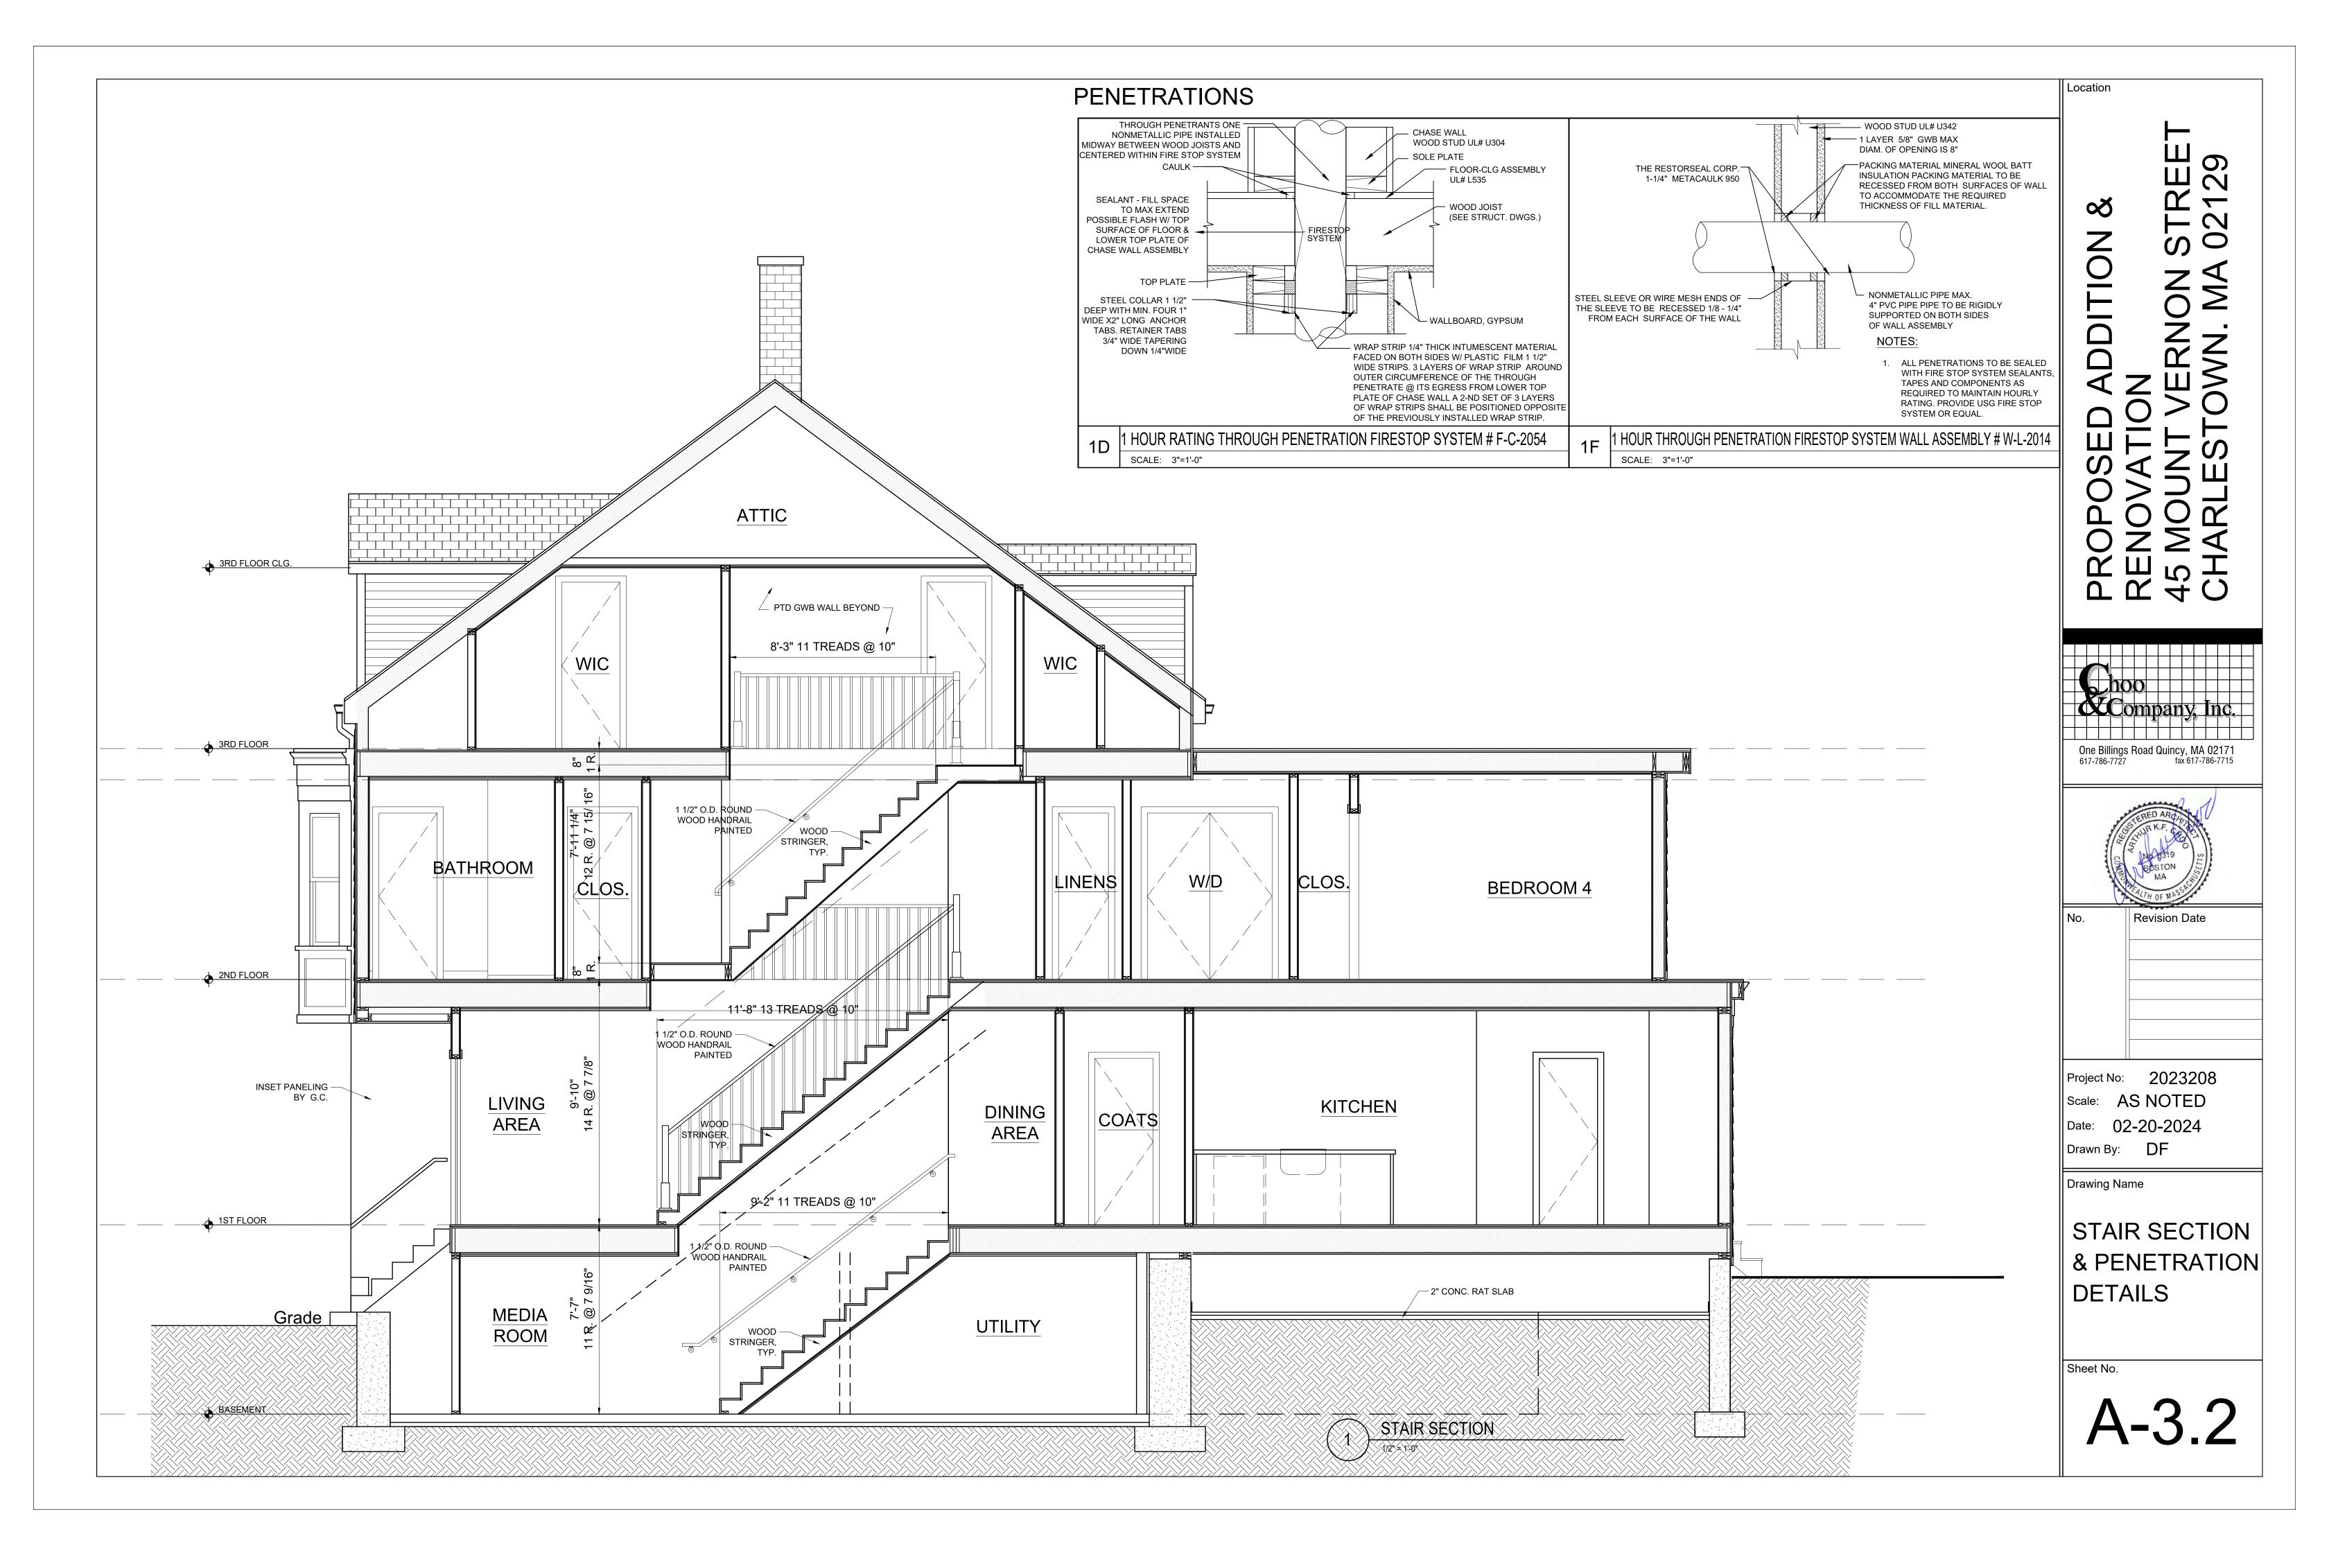

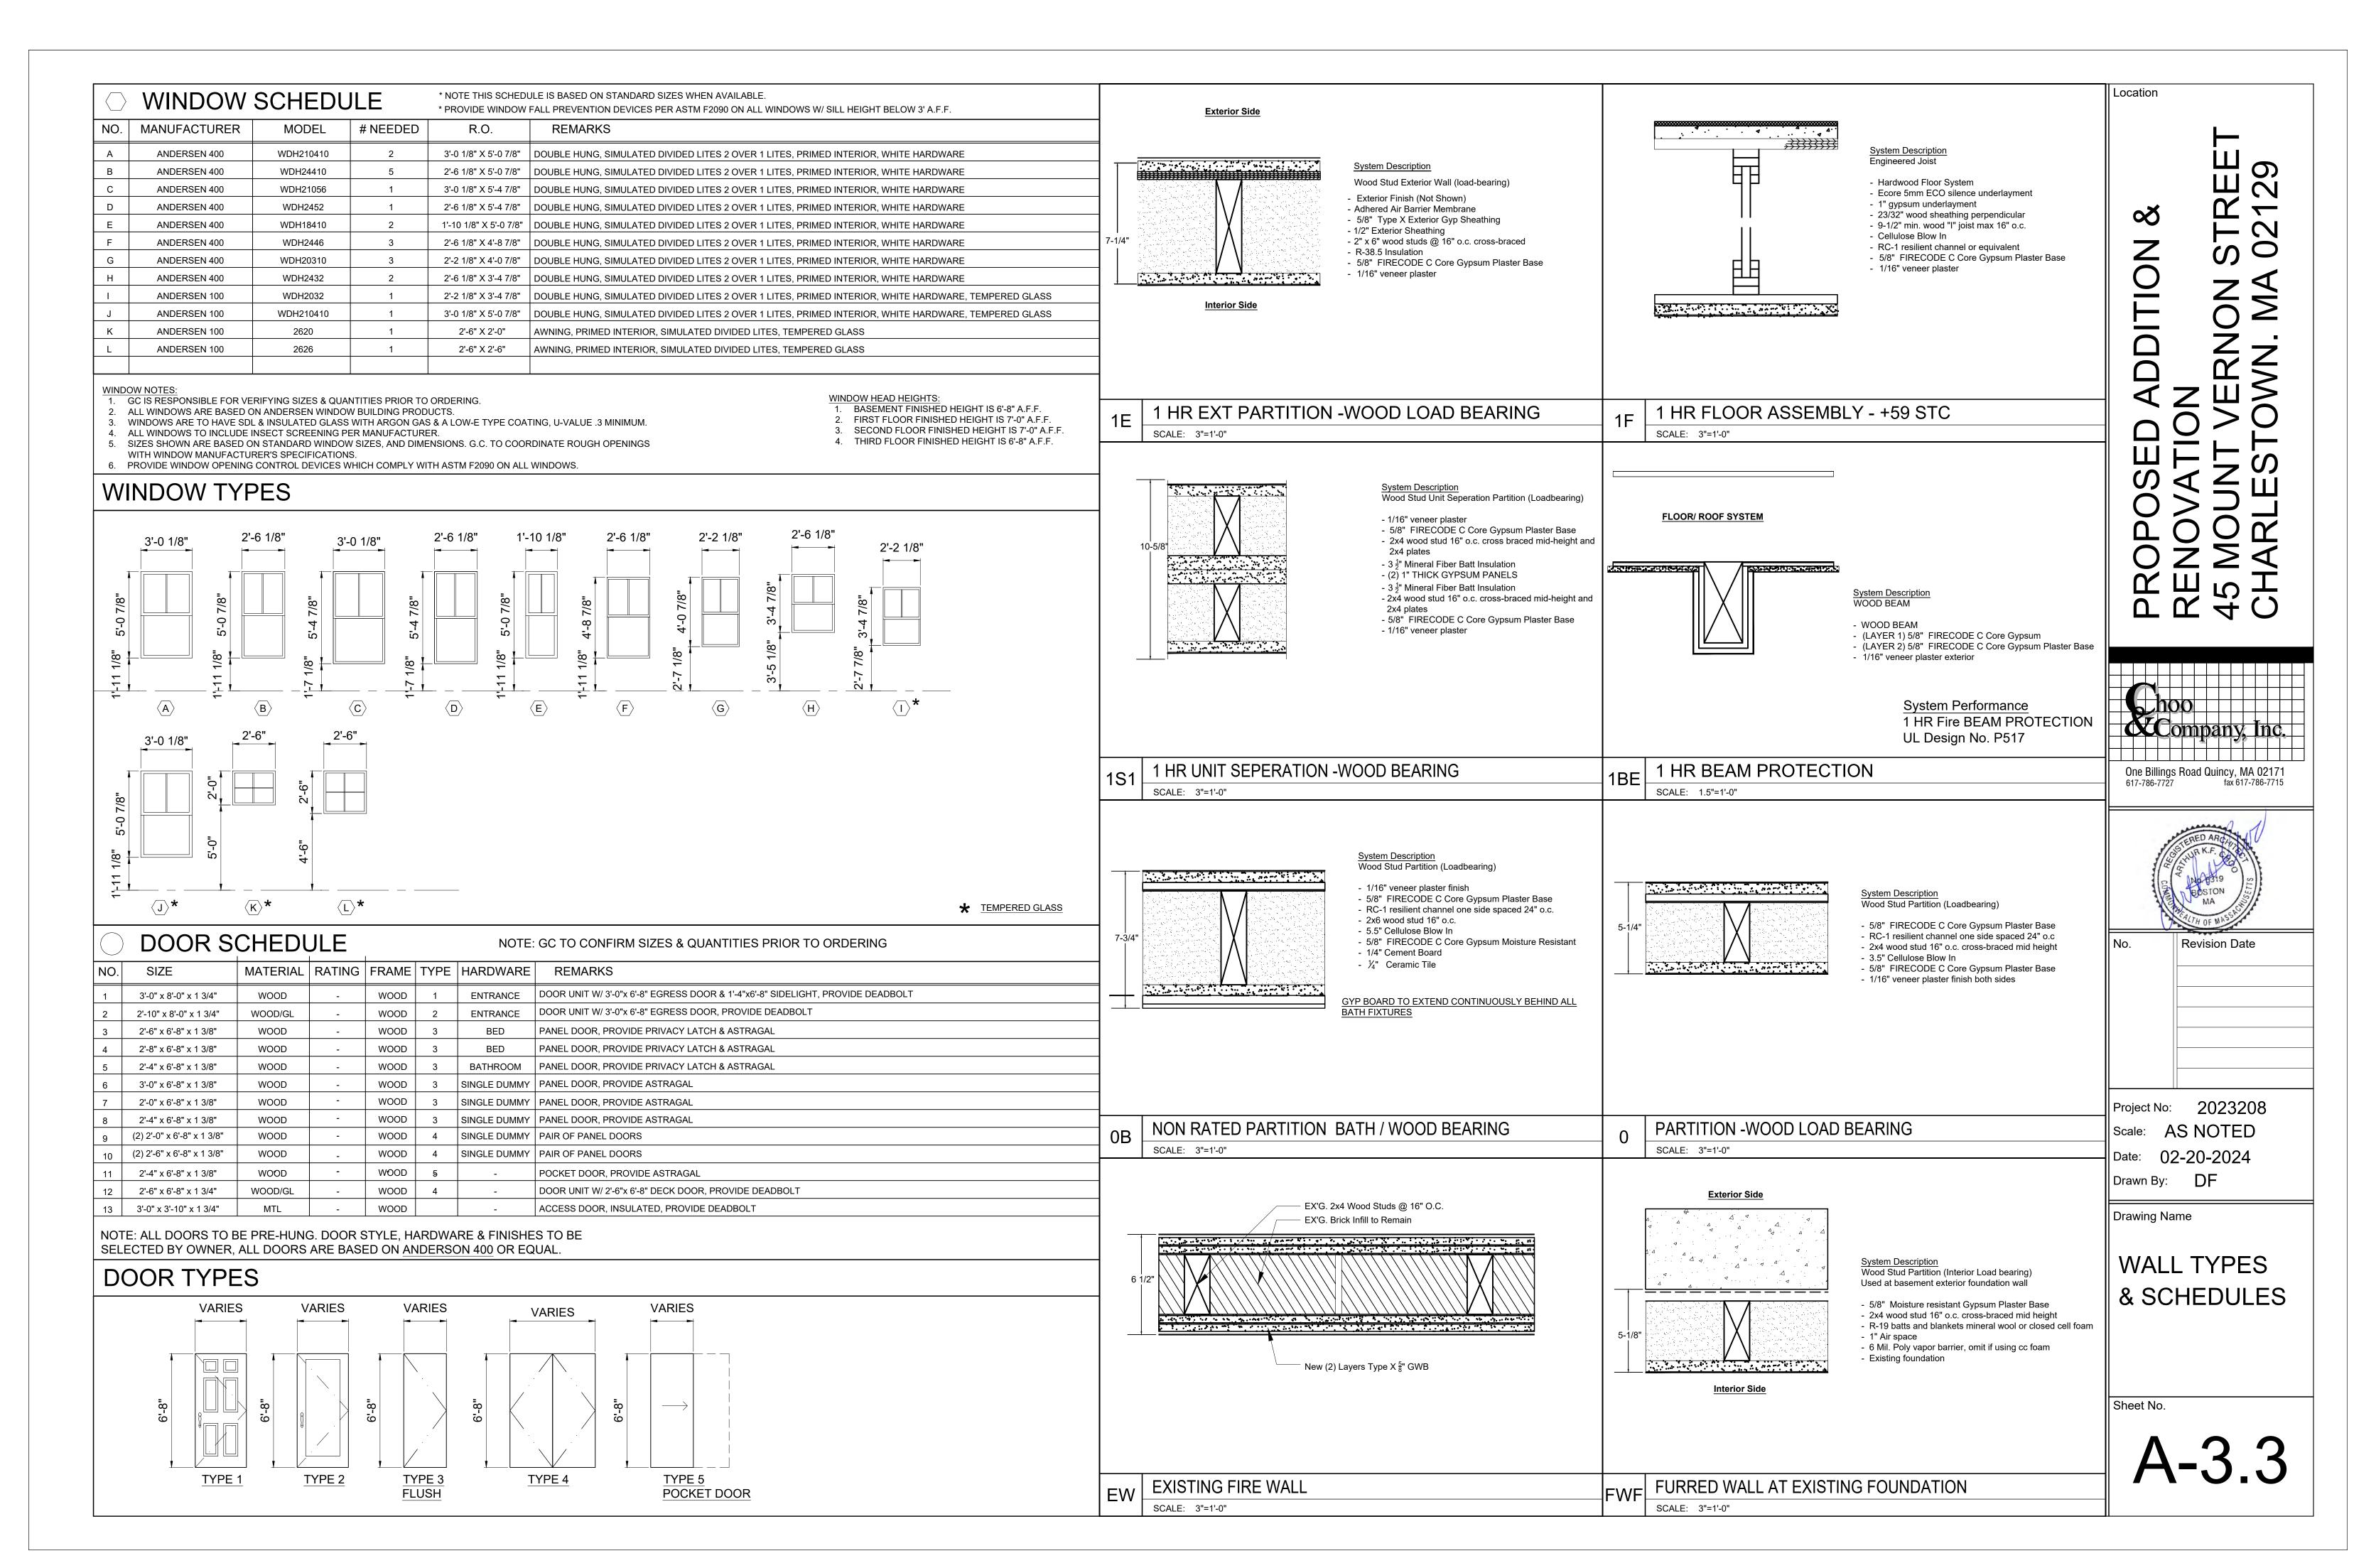

BUILDING ELEMENT	NAIL SIZE AND TYPE	NUMBER AND LOCATION	
STUD TO SOLE PLATE	8D COMMON	4 TOE-NAIL OR 2 DIRECT-NAIL	
STUD TO CAP PLATE	16D COMMON 16D COMMON	2 TOE-NAIL OR 2 DIRECT-NAIL	
DOUBLE STUDS	10D COMMON	12" O.C. DIRECT	
CORNER STUDS	16D COMMON	24" O.C. DIRECT	
SOLE PLATE TO JOIST OR BLOCKING	16D COMMON	16" O.C.	
DOUBLE CAP PLATE	10D COMMON	16" O.C. DIRECT	
CAP PLATE LAPS	10D COMMON	2 DIRECT-NAIL	
RIBBON STRIP, 6" OR LESS	10D COMMON	2 EACH DIRECT BEARING	
RIBBON STRIP, 6" OR MORE	10D COMMON	3 EACH DIRECT BEARING	
ROOF RAFTER TO PLATE	8D COMMON	3 TOE-NAIL	
IACK RAFTER TO RIDGE	16D COMMON	2 TOE-NAIL OR DIRECT-NAIL	
JACK RAFTER TO HIP	10D COMMON 16D COMMON	3 TOE-NAIL OR 2 DIRECT-NAIL	
FLOOR JOISTS TO STUDS (NO CEILING JOISTS)	10D COMMON 10D COMMON	5 DIRECT OR 3 DIRECT	
FLOOR JOISTS TO STUDS (WITH CEILING JOISTS)	10D COMMON	2 DIRECT	
FLOOR JOISTS TO SILL OR GIRDER	3D COMMON	3 TOE-NAIL	
LEDGER STRIP	16D COMMON	3 EACH DIRECT	
CEILING JOISTS TO PLATE	16D COMMON	3 TOE-NAIL	
CEILING JOISTS (LAPS OVER PARTITION)	10D COMMON	3 DIRECT-NAIL	
CEILING JOISTS (PARALLEL TO RAFTER)	10D COMMON	3 DIRECT	
COLLAR BEAM	10D COMMON	3 DIRECT	
BRIDGING TO JOISTS	8D COMMON	2 EACH DIRECT END	
DIAGONAL BRACE (TO STUD AND PLATE)	8D COMMON	2 EACH DIRECT BEARING	
TAIL BEAMS TO HEADERS (WHEN NAILING PERMITTED)	20D COMMON	1 EACH END 4 SQ. FT. FLOOR AREA	
HEADER BEAMS TO TRIMMERS	20D COMMON	1 EACH END 8 SQ. FT. FLOOR AREA	
" ROOF DECKING	8D COMMON	2 EACH DIRECT RAFTER	
(OVER 6" IN WIDTH)	8D COMMON	3 EACH DIRECT RAFTER	
I" SUBFLOORING (6" OR LESS) I" SUBFLOORING (8" OR MORE)	8D COMMON	2 EACH DIRECT JOIST	
2" SUBFLOORING (8" OR MORE) 2" SUBFLOORING	8D COMMON	3 EACH DIRECT JOIST	
I" WALL SHEATHING (8" OR LESS IN WIDTH)	16D COMMON	2 EACH DIRECT STUD	
I" WALL SHEATHING (OVER 8" IN WIDTH)	8D COMMON 8D COMMON	2 EACH DIRECT STUD 3 EACH DIRECT STUD	
PLYWOOD ROOF & WALL SHEATHING	SE CONNICIA	o External National States	
(1/2" OR LESS) (5/8" OR GREATER) (5/16",3/8", OR 1/2") (OVER 6" IN WIDTH)	6D COMMON 8D COMMON 16 GAUGE GALVANIZED WIRE STAPLES, 3/8" MINIMUM CROWN; LENGTH OF 1" PLUS PLYWOOD THICKNESS SAME AS IMMEDIATELY ABOVE	6" O.C. DIRECT EDGES & 12" O.C. INTERMEDIATE 6" O.C. DIRECT EDGES & 12" O.C. INTERMEDIATE 4" O.C. EDGES & 8" O.C. INTERMEDIATE 2 1/2" O.C. EDGES & 5" O.C. INTERMEDIATE	
PLYWOOD SUBFLOORING (1/2") (3/8", 3/4") (1", 1 1/8")	6D COMMON OR 6D ANNULAR OR SPIRAL THREAD 8D COMMON OR 8D ANNULAR OR SPIRAL THREAD 10D COMMON OR 8D RING SHANK OR 8D ANNULAR OR SPIRAL THREAD	6" O.C. DIRECT EDGES & 10" O.C. INTERMEDIATE 6" O.C. DIRECT EDGES & 10" O.C. INTERMEDIATE 6" O.C. DIRECT EDGES & 6" O.C. INTERMEDIATE	
(1/2") (3/8")	16D GALVANIZED WIRE STAPLES 3/8" MINIMUM CROWN; 1 3/8' LENGTH	4" O.C. EDGES & 7" O.C. INTERMEDIATE 2 1/2" O.C. EDGES & 4" O.C. INTERMEDIATE	
BUILT-UP GIRDERS AND BEAMS	20D COMMON	32" O.C. DIRECT	
CONTINUOUS HEADER TO STUD	8D COMMON	4 TOE-NAIL	
CONTINUOUS HEADER, TWO PIECES 1/2" FIBER BOARD SHEATHING	16D COMMON 1 1/2" GALVANIZED ROOFING NAIL OR 16 GAUGE STAPLE, 1 1/2" LONG WITH MIN. CROWN OF 7/16"	16" O.C. DIRECT 3" O.C. EXTERIOR EDGE 6" O.C. INTERMEDIATE	
25/32" FIBER BOARD SHEATHING	1 3/4" GALVANIZED ROOFING NAIL OR 8D COMMON NAIL OR 16 GAUGE STAPLE, 1 1/2" LONG WITH	3" O.C. EXTERIOR EDGE 6" O.C. INTERMEDIATE	
GYPSUM SHEATHING	MIN. CROWN OF 7/16" 12 GAUGE 1 3/4" LARGE HEAD CORROSION- RESISTANT	4" O.C. EDGE 8" O.C. INTERMEDIATE	
PARTICLE BOARD UNDERLAYMENT (1/4"-3/4")	6D ANNULAR THREADED	6" O.C. DIRECT EDGES 10" O.C. INTERMEDIATE	
PARTICLE BOARD ROOF AND WALL SHEATHING /2" OR LESS	6D COMMON	6" O.C. DIRECT EDGES 12" O.C. INTERMEDIATE	
5/8" OR GREATER	8D COMMON	6" O.C. DIRECT EDGES 12" O.C. INTERMEDIATE	
PARTICLE BOARD SUBFLOORING	8D COMMON	6" O.C. DIRECT EDGES 12" O.C. INTERMEDIATE	
(5/8" OR GREATER)			
SHINGLES, WOOD*	NO. 14 B&S GAGE CORROSION RESISTIVE	2 EACH BEARING	
NEATHER BOARDING	8D CORROSION	2 EACH BEARING	

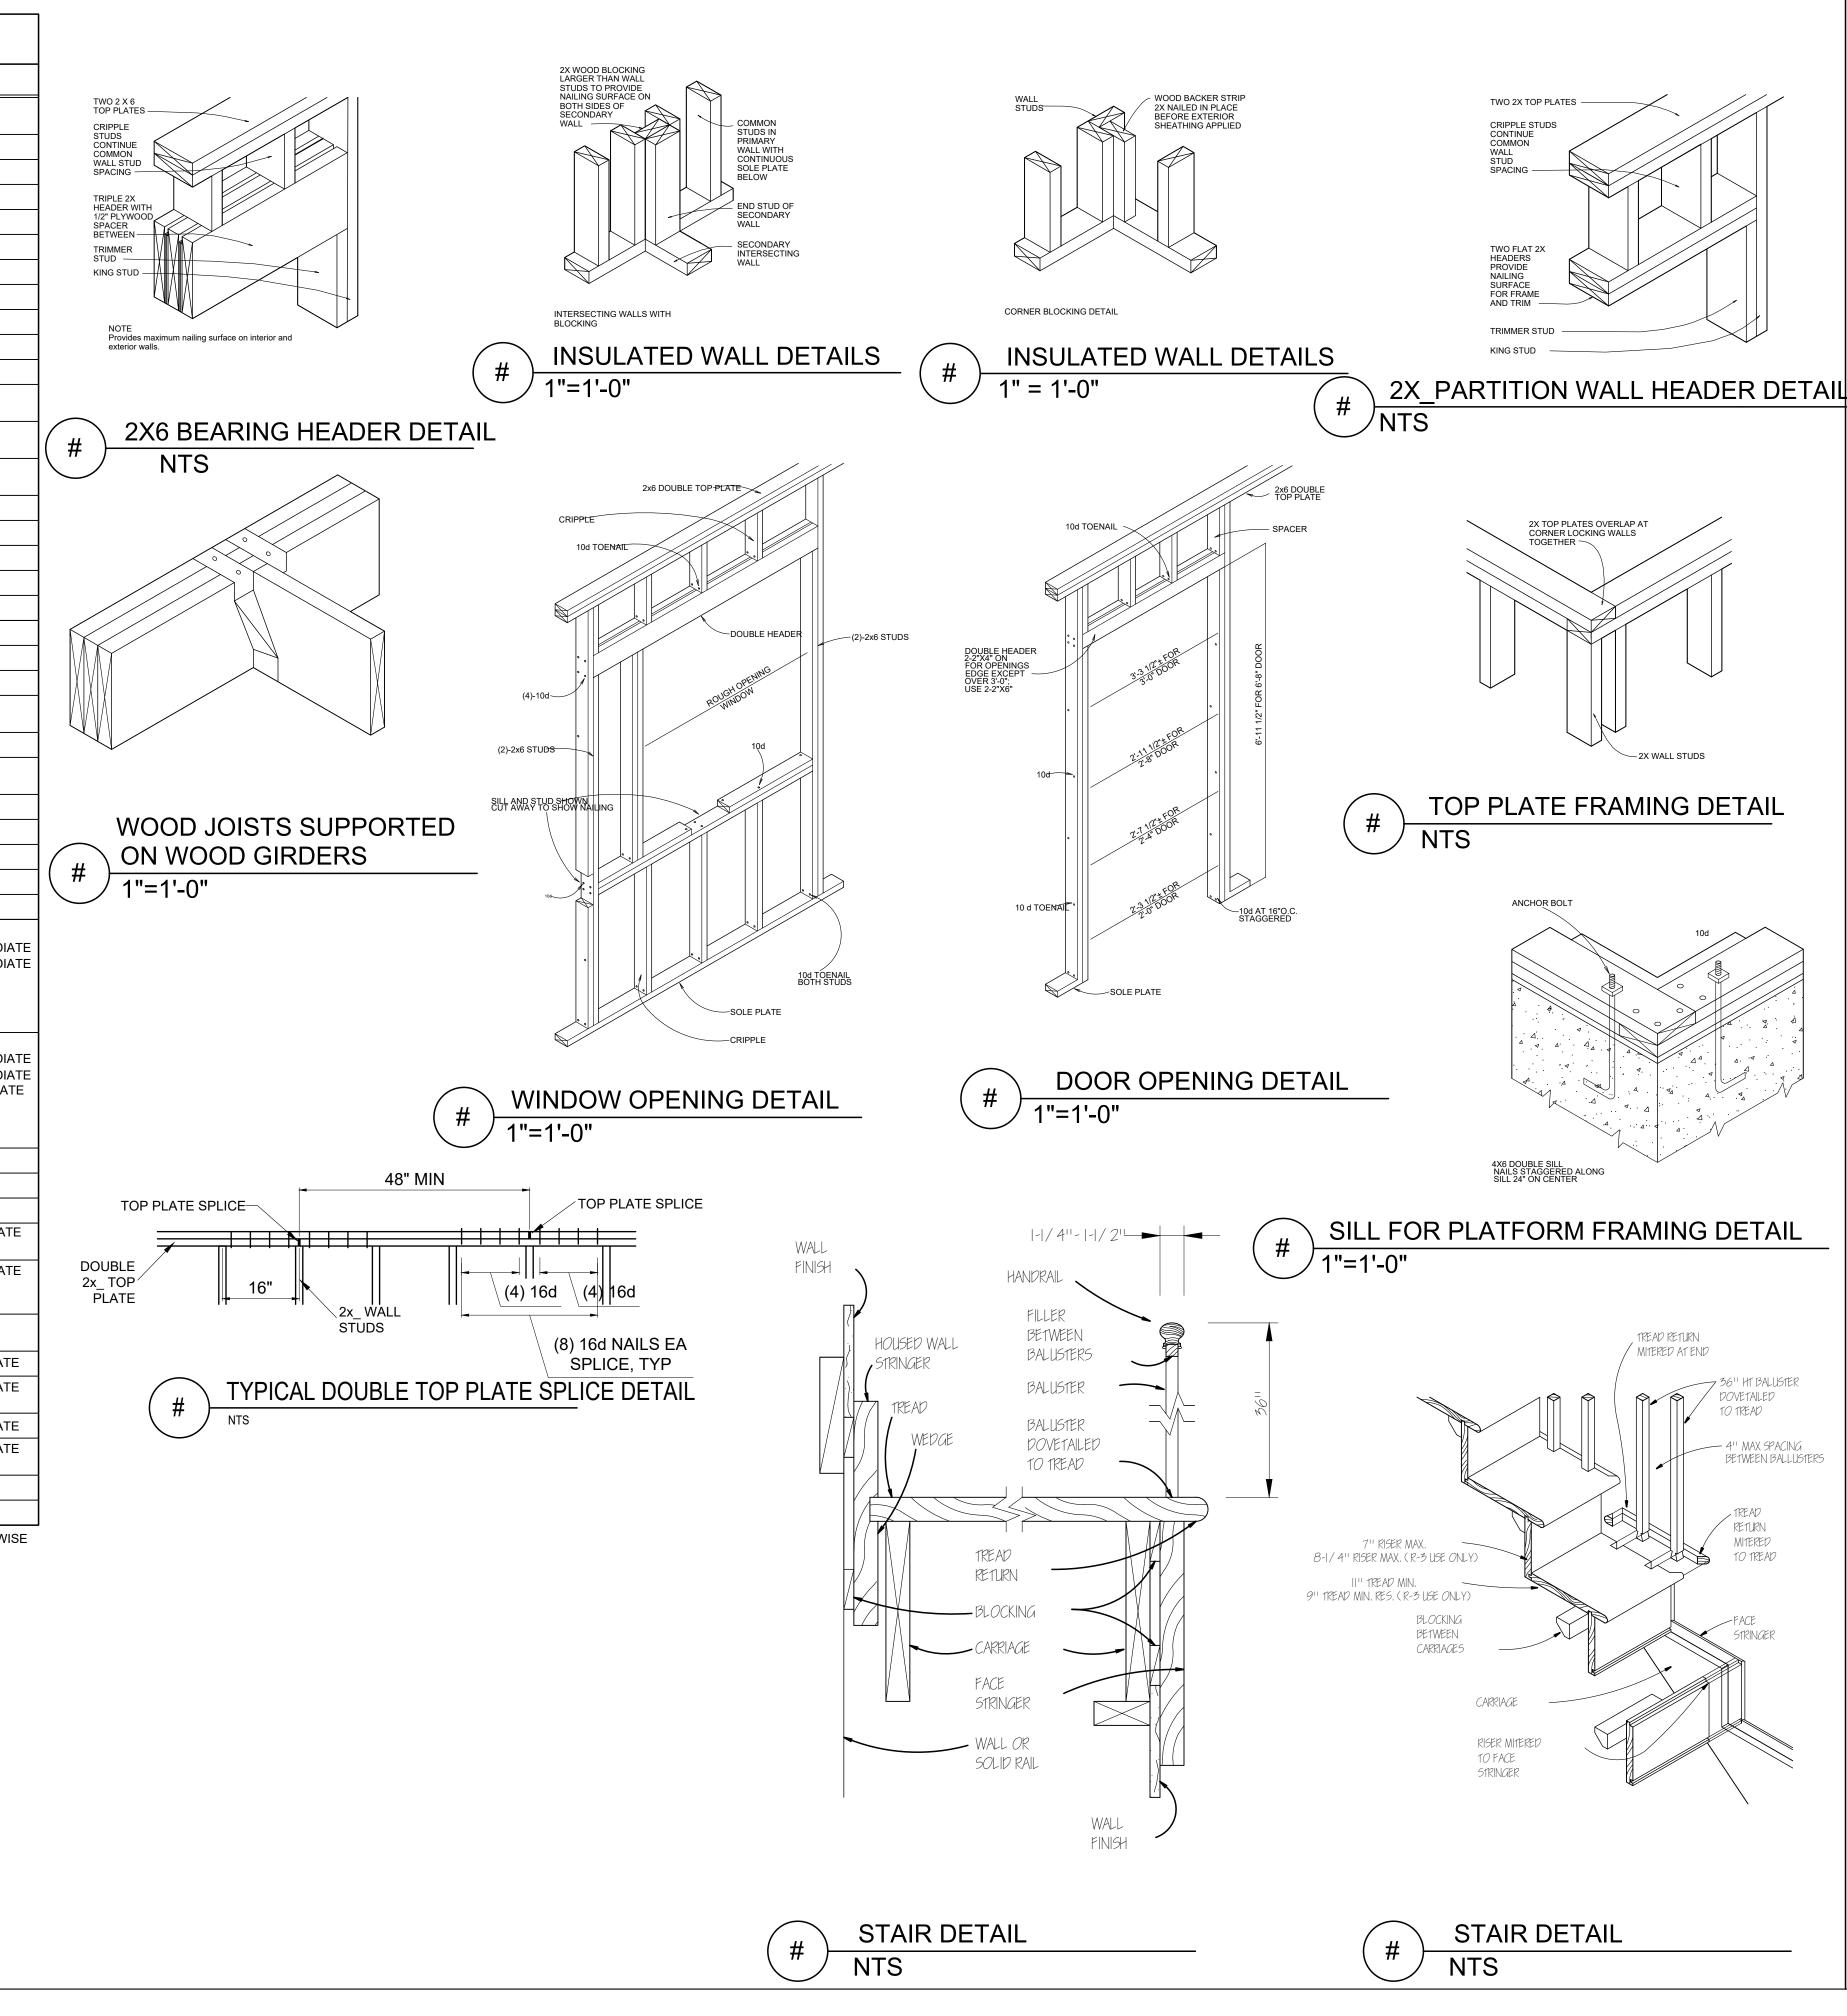

Location

One Billings Road Quincy, MA 02171 617-786-7727 fax 617-786-7715

Revision Date

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Scale: AS NOTED

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FASTENING

SCHEDULE &


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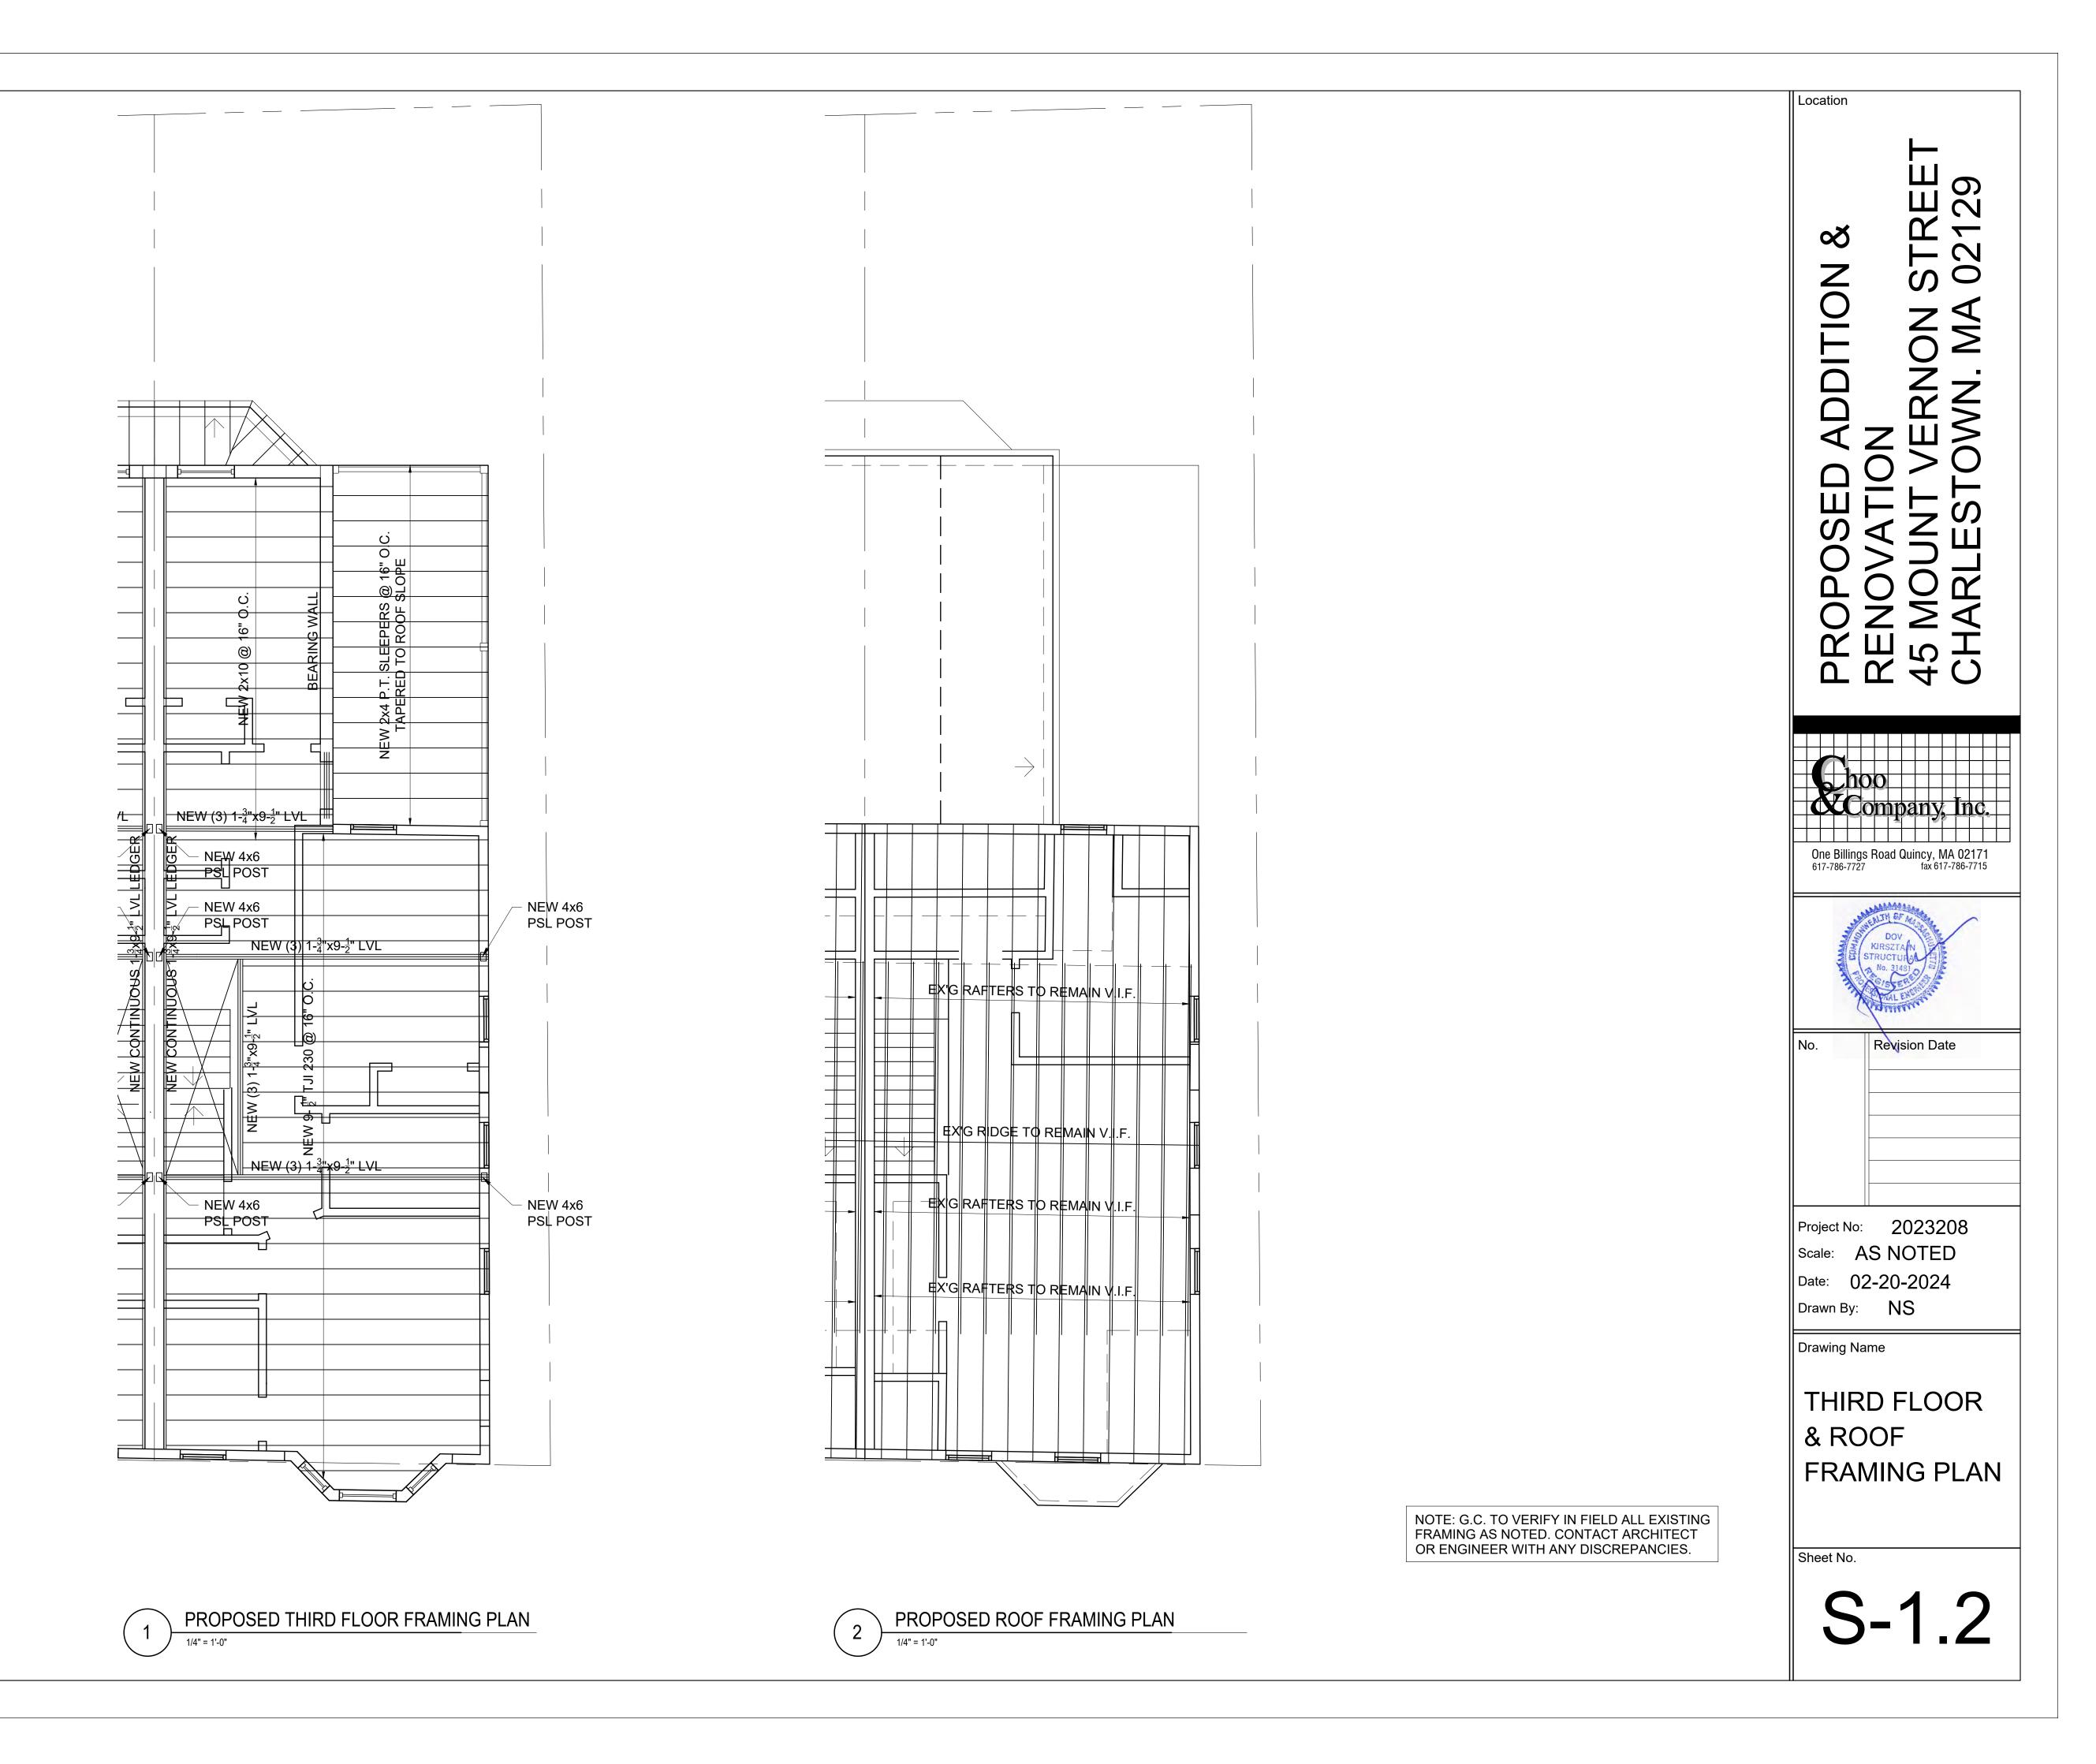
DETAILS


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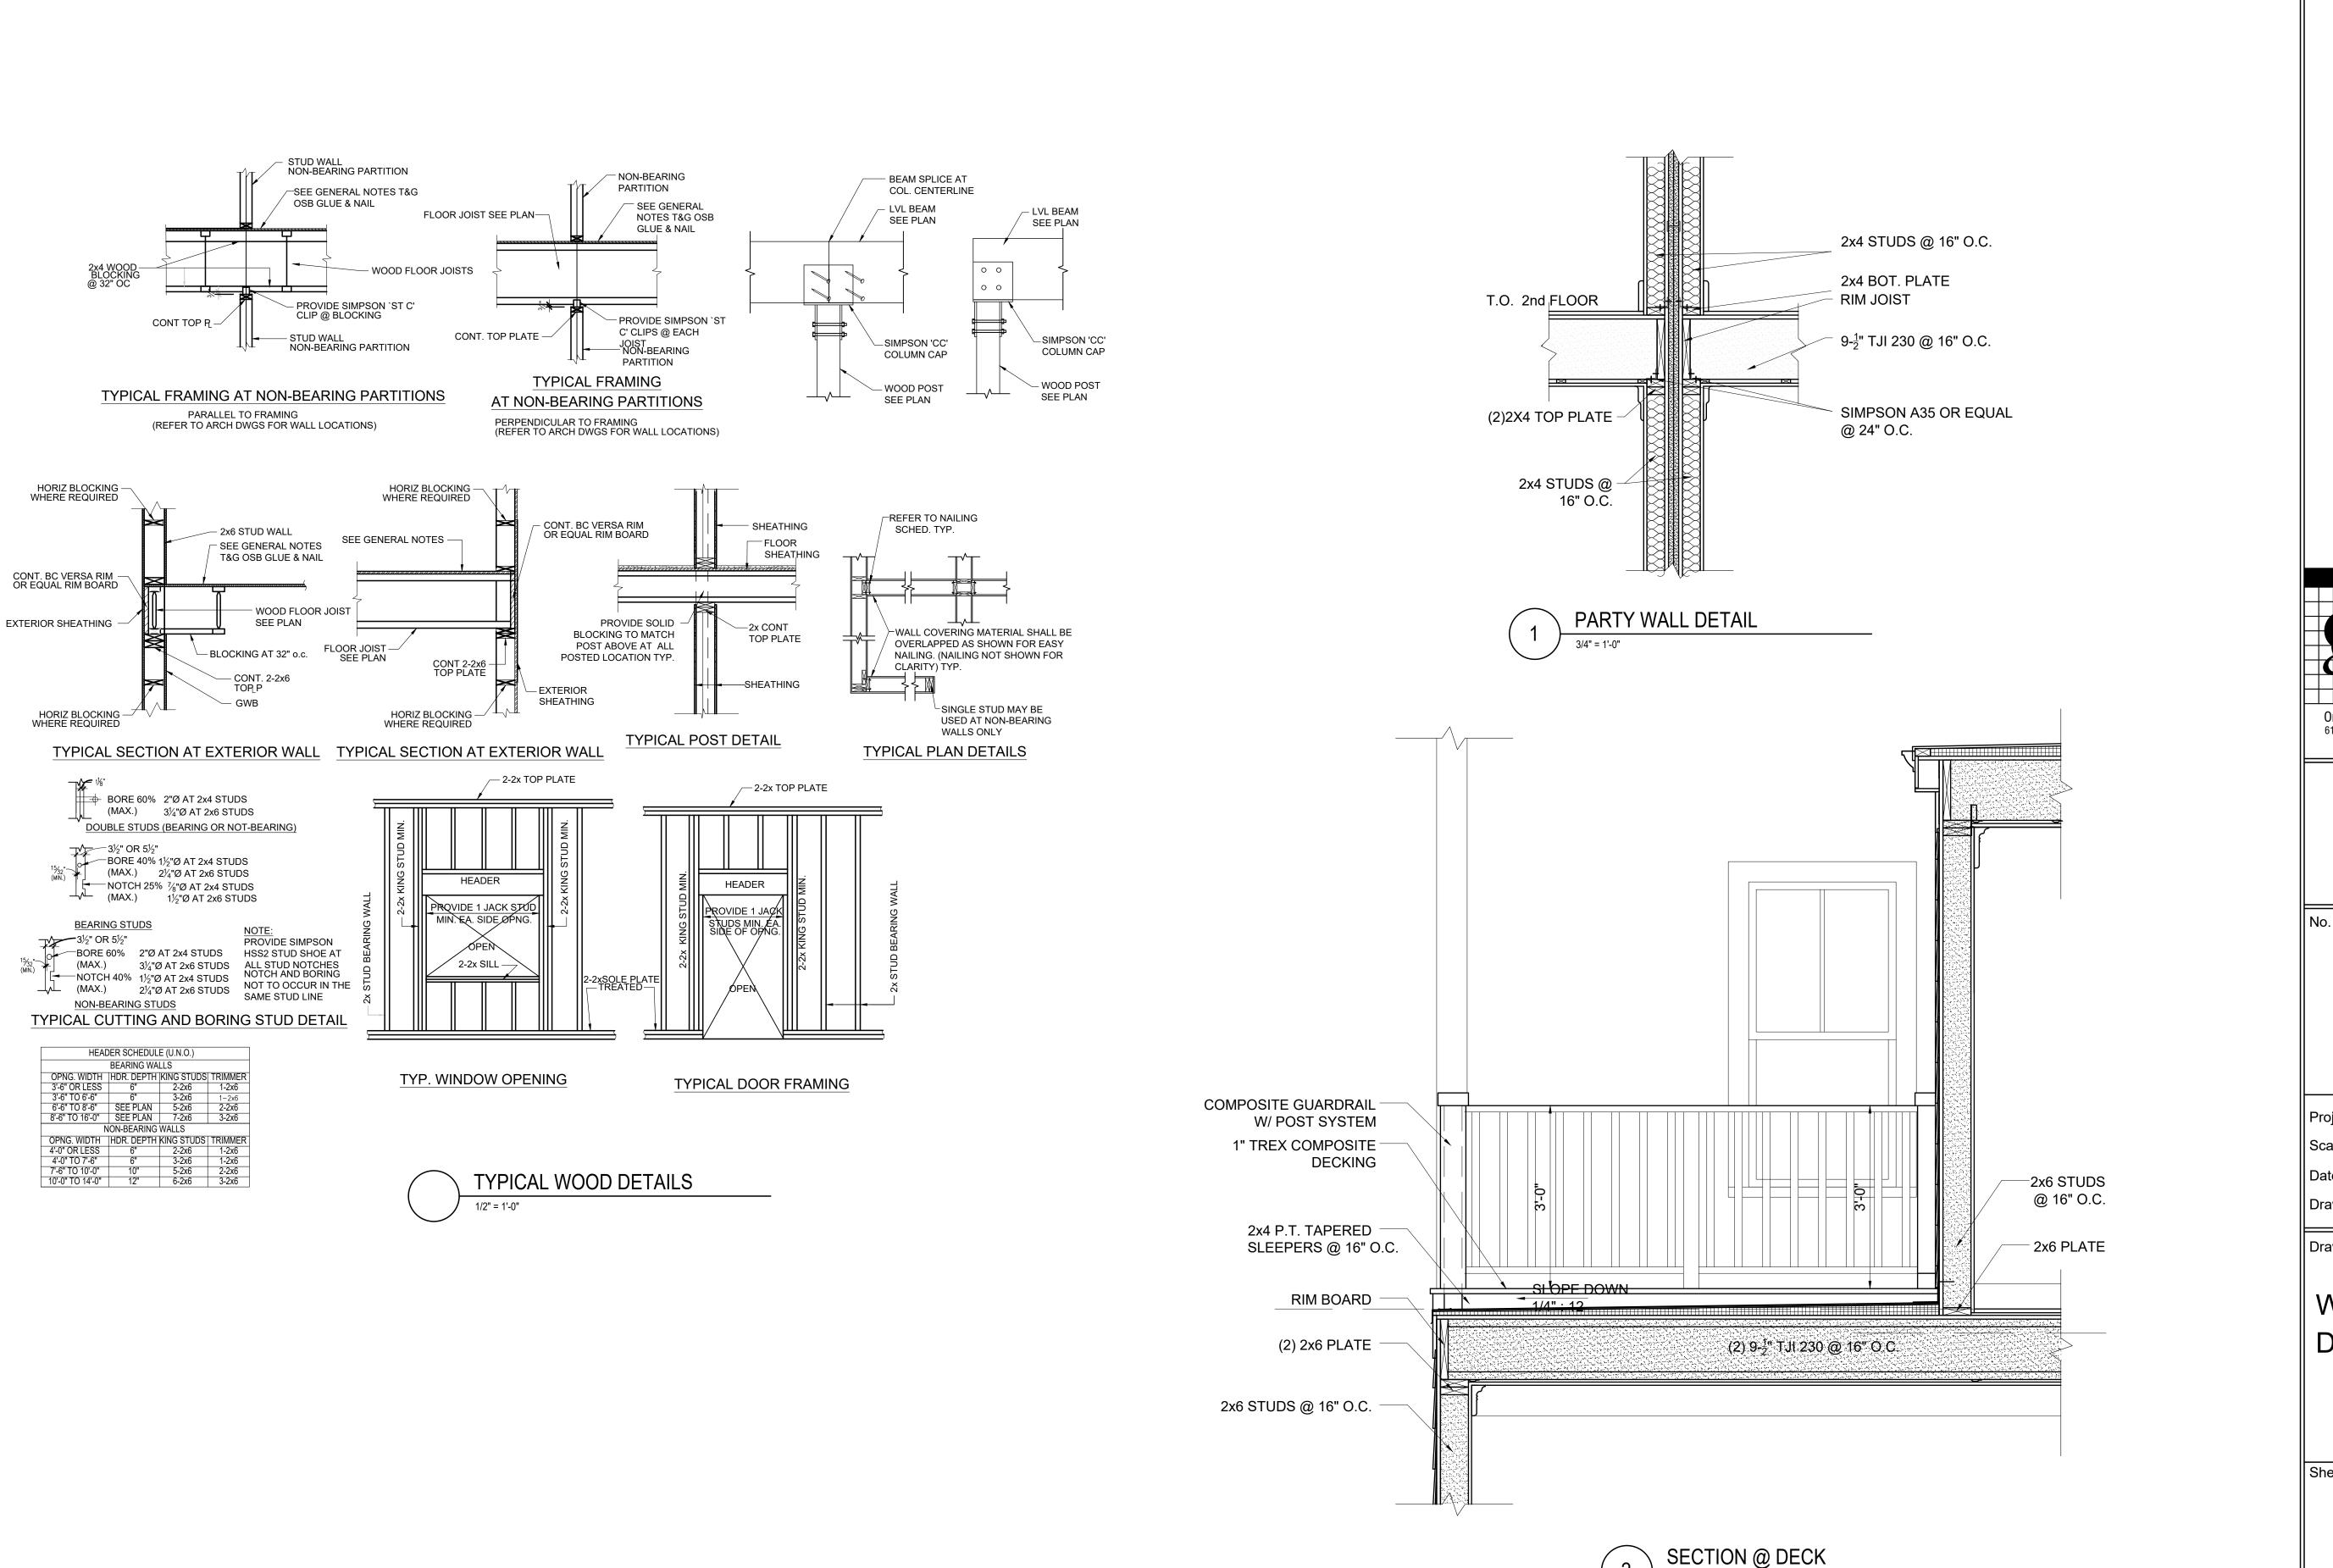
Drawn By: DF

Drawing Name





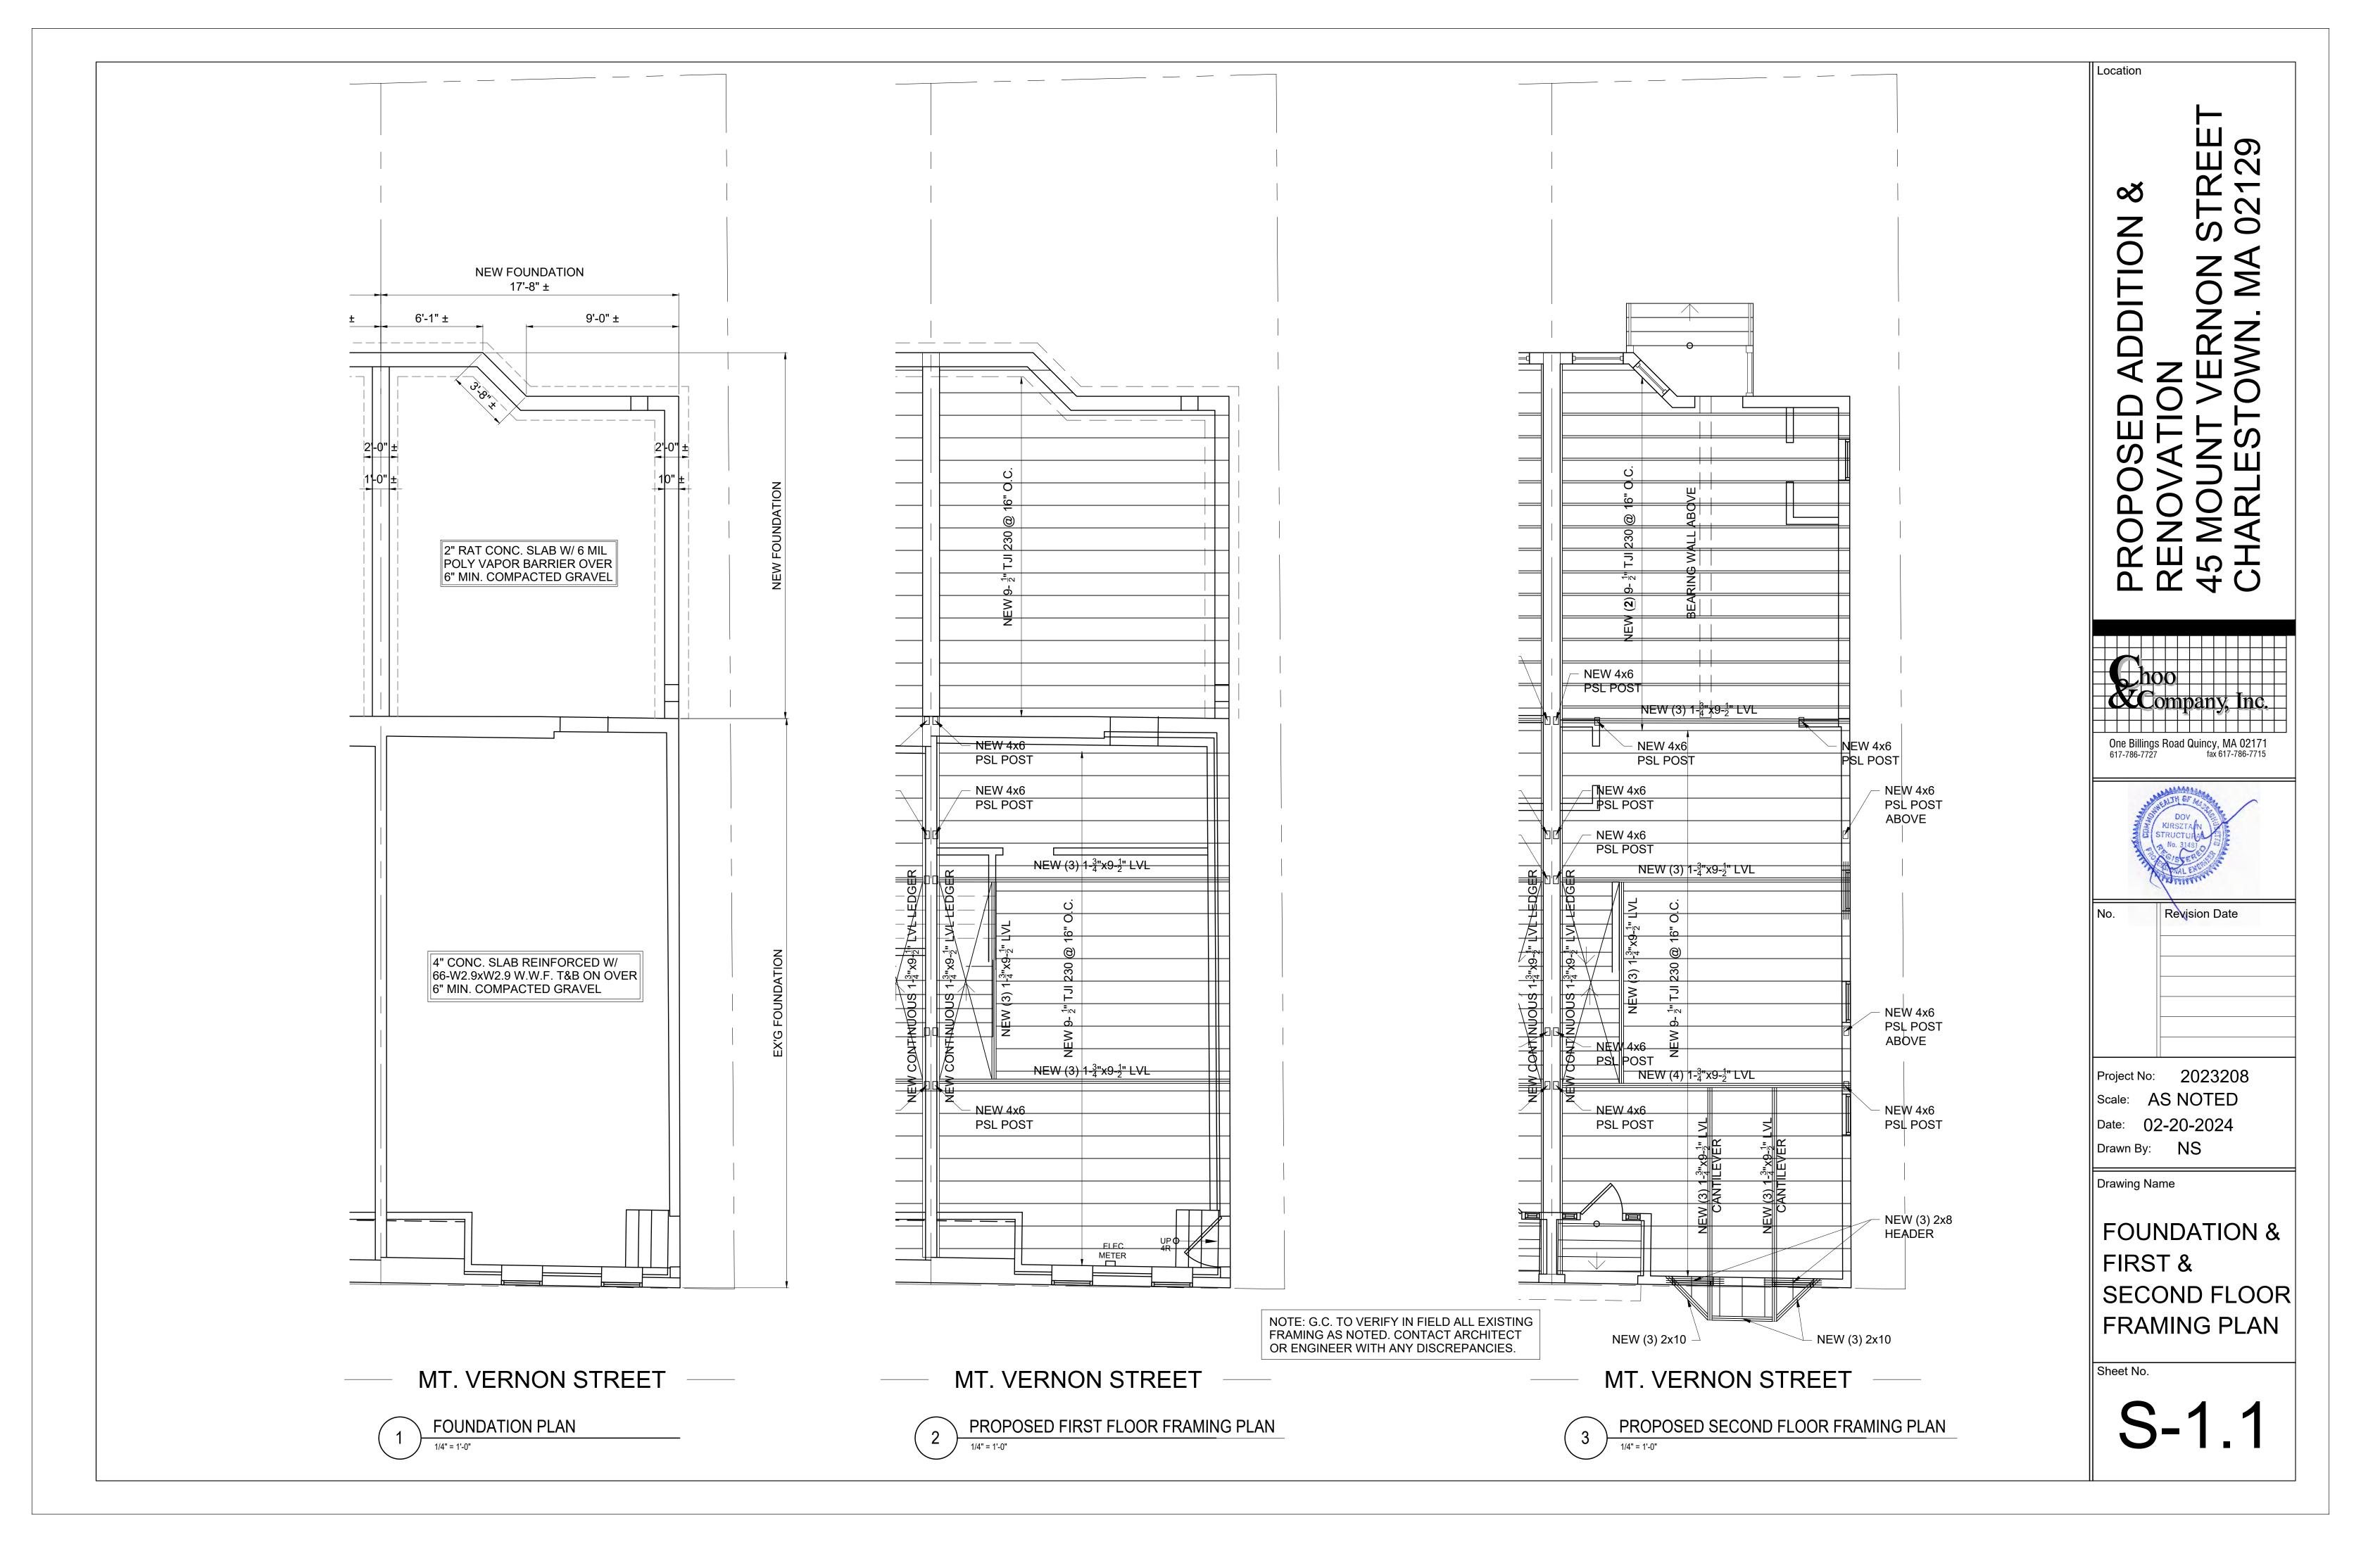

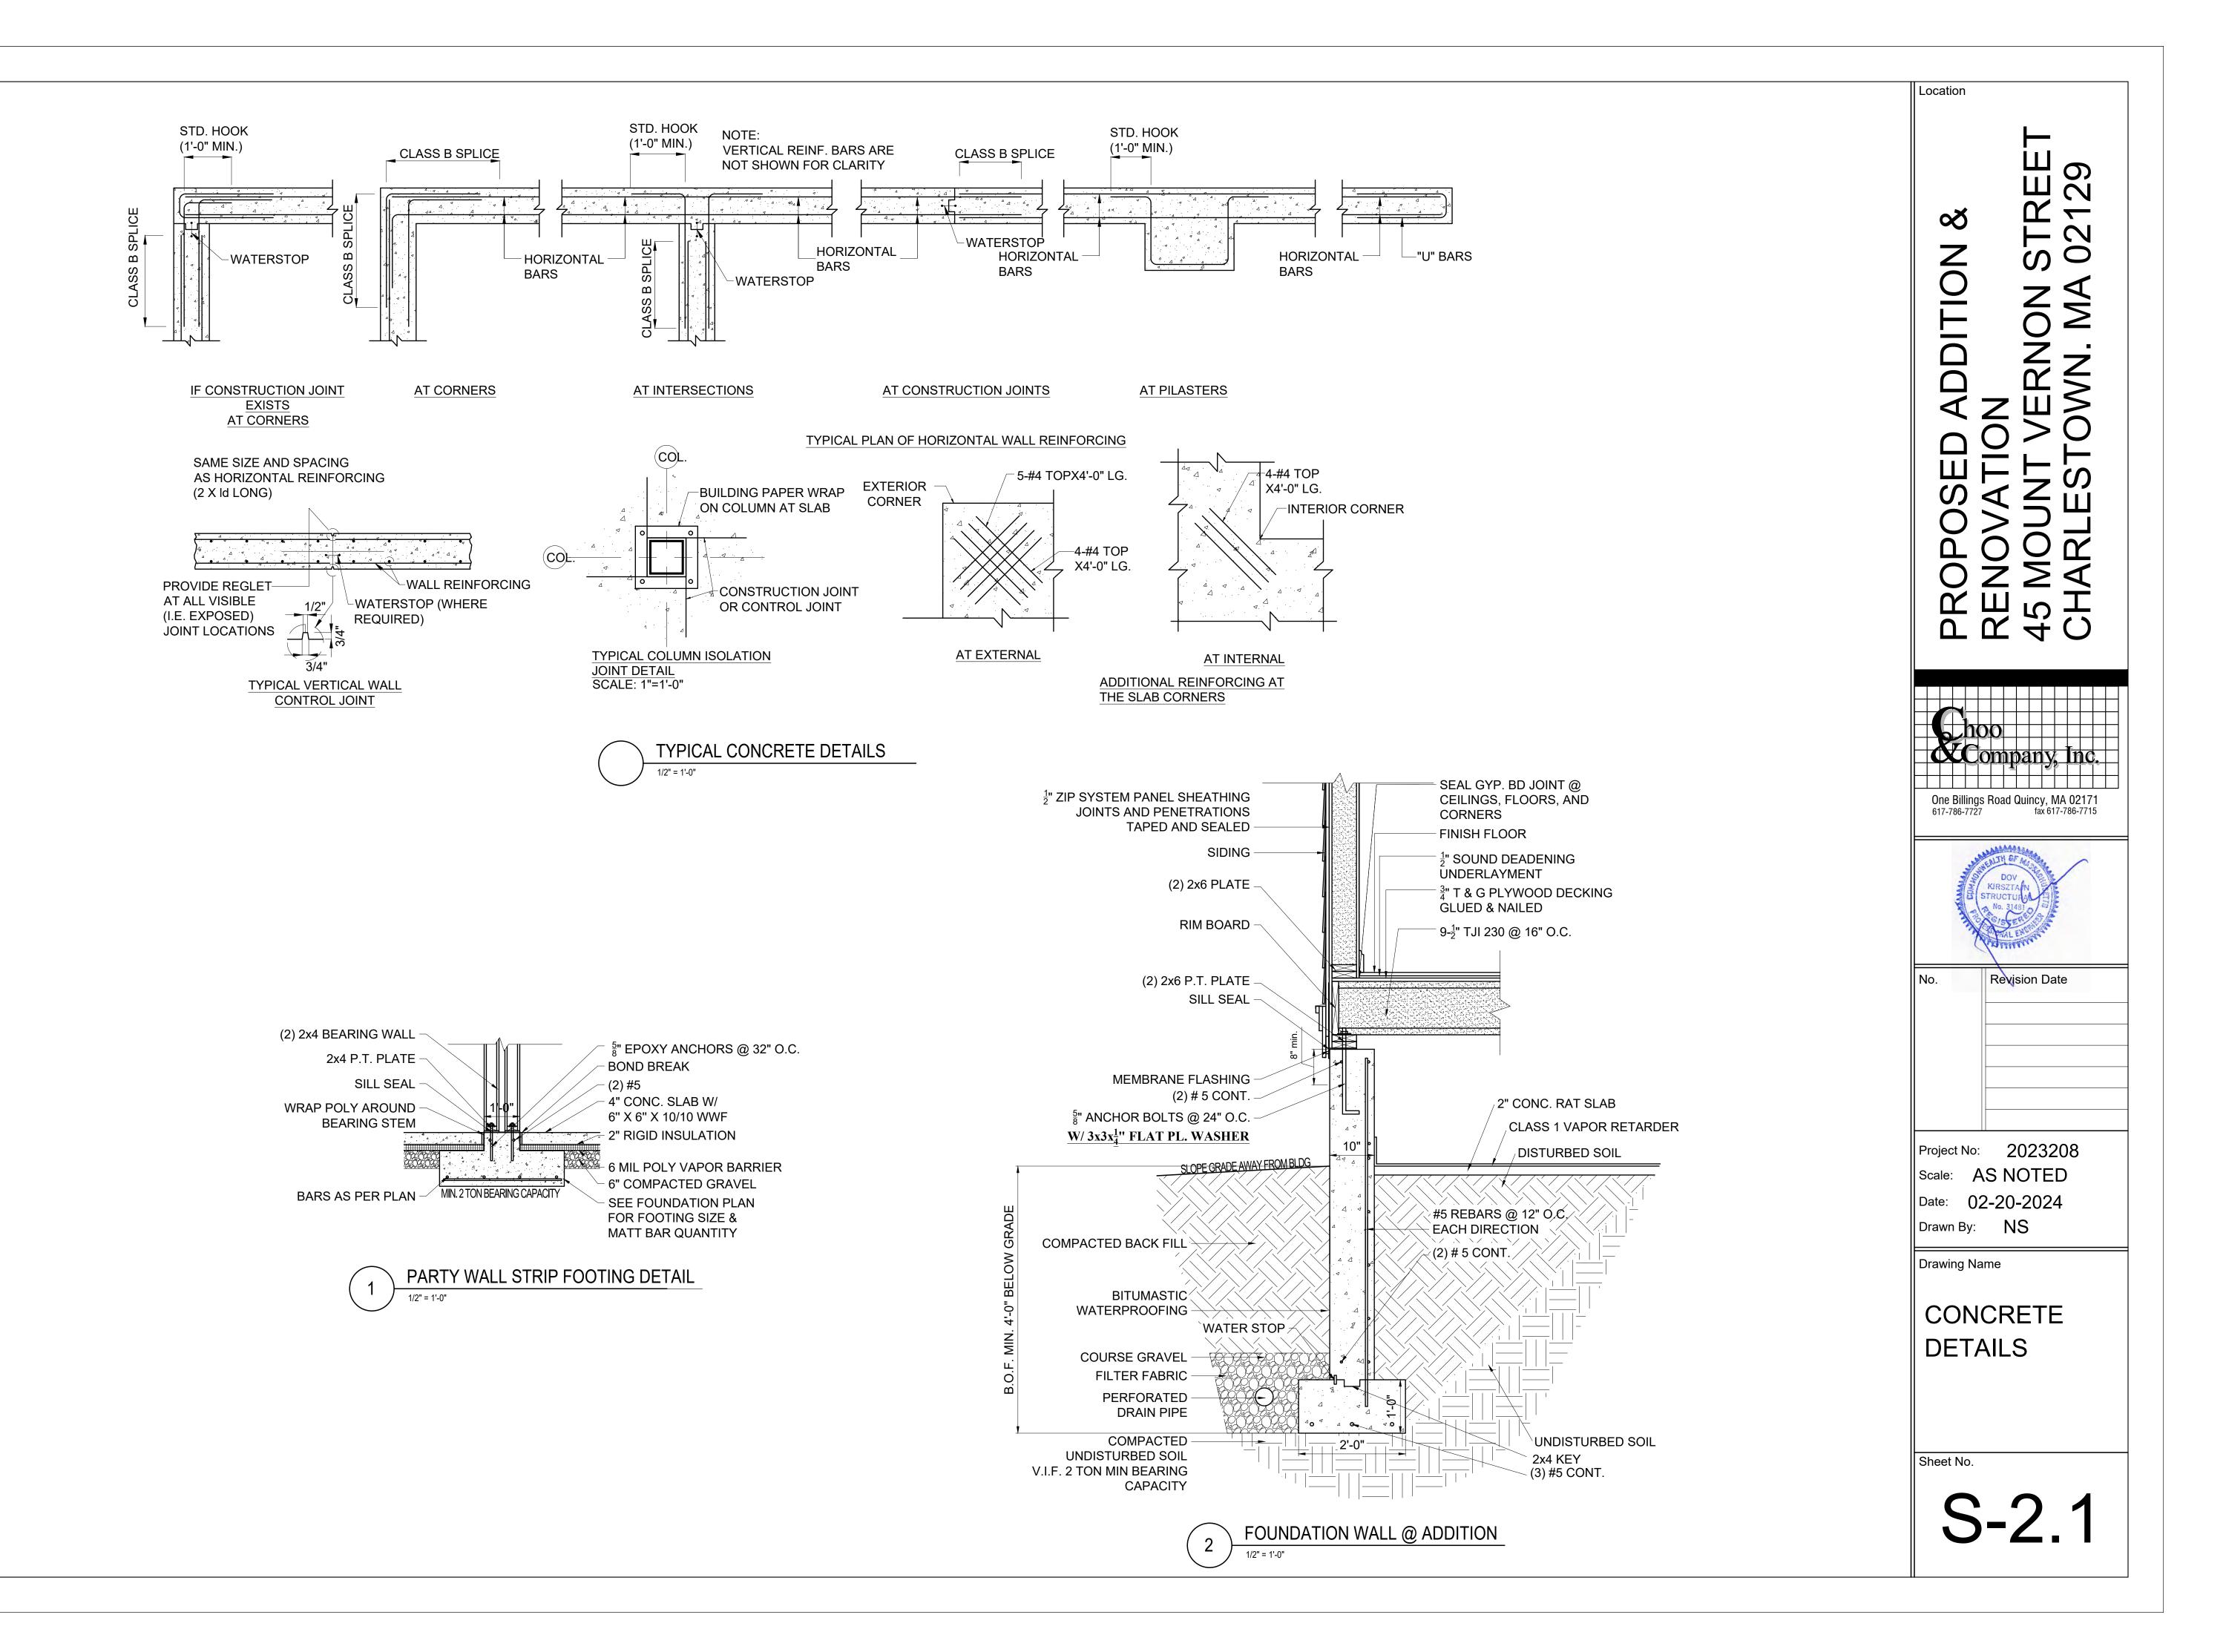

PROPOSED ADDITION & RENOVATION 45 MOUNT VERNON STREE CHARLESTOWN, MA 02129

Location

One Billings Road Quincy, MA 02171
617-786-7727 fax 617-786-7715



o. Revision Date

Project No: 2023208
Scale: AS NOTED
Date: 02-20-2024
Drawn By: NS

Drawing Name

WOOD DETAILS

Sheet No.

S-2.2