Boston, MA 02129

3/23/2023 PERMIT SET **APPROVED**

Design Section **BOSTON REDEVELOPMENT AUTHORITY**

Board of Appeal

Signature

04/25/2023

Approved

in a

pursuant to

Article 80E

for projects

Neighborhood

District.

Design Overlay

VICINITY MAP

ZONING REVIEW

PROJECT 3D



CHARLESTOWN

NEIGHBORHOOD.

RH-2000 ZONING SUBDISTRICT

LOT AREA (SF)

ADDITIONAL LOT AREA

PER DWELLING UNIT

LOT WIDTH

(FEET) MINIMUM

LOT FRONTAGE

(FEET) MINIMUM

FLOOR AREA RATIO

(FAR) MAXIMUM

BUILDING HEIGHT

(STORIES) MAXIMUM

BUILDING HEIGHT

(FEET) MAXIMUM

USABLE OPEN SPACE

FRONT YARD MIN. DEPTH

(FEET - SOUTH SIDE)

SIDE YARD DEPTH

SIDE YARD DEPTH

REAR YARD DEPTH

(FEET - NORTH SIDE)

area of such dormers shall be included in Gross Floor Area of the Dwelling..

* - E/N - Existing Nonconforming

area specified in this Table C for the lot.

(MIN. SQUARE FEET/DW UNIT)

LEVEL	AREA
BASEMENT	1,269
FIRST	1,267
SECOND	1,267
THIRD	1,266
FOURTH	1,268
TOTAL GSF =	6,337 GSF

9 MONUMENT SQUARE ZONING SUMMARY PROPOSED THREE FAMILY

RESIDENTIAL RH-2000 SUBDISTRICT

EXISTING

DIMENSION

2,900

114.91

25

2.11

7.5

2. For the purpose of determining Building Height, the floor area of a dormer on a Dwelling shall not be included in the floor area calculation for a half story; provided that such dormer is not wider than eight (8) feet and the ridge line of the dormer does not exceed the ridge line of an existing Structure of which it is a part, or .a thirty-five (35)

For any lot that exceeds the minimum lot area specified in this Table C, the required number of square feet of usable open space per dwelling unit shall be calculated by

feet, whichever is less; and provided further that only the floor area of two such dormers shall not be included in the floor area calculation for a half story. However, the floor

adding: (a) the minimum usable open space per dwelling unit specified in this Table C, and (b) twenty-five percent (25%) of the lot area in excess of the required minimum lot

All ground level open space used to satisfy the minimum usable open space requirements specified in this Table C must have an unobstructed length of not less than teh (10)

feet and an unobstructed width of not less than ten (10) feet, except that, for yards used to meet the open space requirements of this Table C, shorter or narrower dimensions

In the 3F Subdistricts and the MFR Subdistricts, up to twenty-five percent (25%) of the usable open space requirement may be met by unenclosed porches (with or without roofs) or by suitably designed and accessible space on balconies of Main Buildings of on the roofs of Main Buildings or on the roofs of Accessory Buildings, provided

that any such space on a porch, balcony, or roof has an unobstructed length of not less than six (6) feet and an unobstructed width of not less than six (6) feet.

PROPOSED

DIMENSION

2,900

114.91

2.11

59.1'

+/- 475

7.5

43.1

PERMITTED

DIMENSION

2,000

1,000

2.0

3 (2)

250+225 (3)

NONE

3. The minimum usable open space requirement is applicable only to Residential Uses and Dormitory/Fraternity Uses.

are allowed where specifically permitted by the provisions of Section 62-30 (Application of Dimensional Requirements).

4.See Section 62-30.1, Conformity with Existing Building Alignment. A bay window may protrude into a Front Yard.

A. PROJECT DESCRIPTION: INTERIOR RENOVATION OF EXISTING DWELLING DECKS ADDITION AT REAR YARD. B. USE GROUP: R - RESIDENTIAL C. GOVERNING COGE: MA 780 CMR RESIDENTIAL - 9TH EDITION, IRC 2015 D. CONSTRUCTION CLASSIFICATION: V-E. FULLY SPRINKLERED

RELIEF

REQUIRED

E/N*

E/N*

Evan Hankin 617.839.9690 elhankin@me.com

F. HEIGHT AND AREA: PER BOSTON MEP Engineer ZONING ORDINANCES

Reiter Fire Protection 60 Monroe Street, Pembroke MA 02359 781.205.9440 service@reiterfire.com



No.	Description	Date
-		
-		
-		

8-9 MONUMENT SQ LLC

221062A Project number 3/23/2023 Drawn by

ABBREVIATIONS SHEET LIST

ABOVE FINISHED FLOOR ACT ACOUSTICAL CEILING TILE AMERICANS W/ DISABILITIES ACT **APPROX APPROXIMATE ARCHITECTURAL AUDIO VISUAL** BLDG BUILDING BLKG **BLOCKING BOTTOM OF** CABINET **CEILING HEIGHT** CLR CLEAR CENTERLINE COL COLUMN CONT **CONTINUOUS** CMU CONCRETE MASONRY UNIT **CONTROL JOINT** DTL DETAIL DIAMETER **DIMENSION**

DOWN DWG **DRAWING EXIST EXISTING** ELEV **ELEVATION ELEC ELECTRICAL EQUAL FLOOR DRAIN** FACE OF **FACE OF CONCRETE** FACE OF FINISH FACE OF STUD **GFIC GROUND FAULT INTERCEPTOR CIRCUIT**

GWB GYPSUM WALL BOARD **HVAC** HEATING, VENTILATING, AND AIR CONDITIONING HOSE BIB

HOLLOW METAL MAX MAXIMUM MASONRY OPENING MECH **MECHANICAL** MIN MINIMUM MISC **MISCELLANEOUS** MTL METAL **NOT IN CONTRACT** NUMBER NTS NOT TO SCALE OVER ON CENTER

OD OUTSIDE DIAMETER **OPNG** OPENING OPP OPPOSITE PAINT GRADE PLYWD PLYWOOD PTD PAINTED **ROOF DRAIN** REQ'D REQUIRED **ROUGH OPENING** SCHED SCHEDULE STAIN GRADE SIMILAR

SQUARE SSTL STAINLESS STEEL STL STEEL STOR STORAGE STRUCT STRUCTURAL TONGUE AND GROOVE TO TOP OF TYP **TYPICAL** UON **UNLESS OTHERWISE NOTED** VERIFY IN FIELD

W/O WITHOUT WOOD WPM

(W10) WATERPROOFING MEMBRANE

SYMBOLS

A20 /

A20 /

REFERENCE NUMBER

REFERENCE NUMBER

REFERENCE NUMBER

REFERENCE NUMBER

REFERENCE NUMBER

EXTERIOR ELEVATION

DRAWING SHEET

DRAWING SHEET

NORTH ARROW

WINDOW TAG

WALL TYPE TAG

APPLIANCE TAG

REVISION TAG

CENTER LINE

DESIGN IS BASED ON THE INTERNATIONAL BUILDING CODE (IBC) 2015,

THE INTERNATIONAL RESIDENTIAL CODE (IRC) 2015, THE INTERNATIONAL ENERGY CONSERVATION CODE (IECC) 2018, AND THE MASSACHUSETTS

BUILDING CODE 2015 AMENDMENTS. CONSTRUCTION SHALL CONFORM

DOOR TAG

INTERIOR ELEVATION

DRAWING SHEET

DRAWING SHEET

DRAWING

DRAWING SHEET

DETAIL

BUILDING SECTION

SHEET#	SHEET NAME	REVISION	REVISION DATE	
A000	COVER			
C1	CIVIL SITE PLAN - DETAILS			
C2	CIVIL SITE PLAN			
C3	SITE PLAN PROPOSED			
A001	BUILDING INFORMATION			
A002	BUILDING INFORMATION			
A010	ARCH SITE PLAN - PROPOSED			
A100	GROUND FLOOR - DEMO/PROPOSED			
A101	LEVEL 1 - DEMO/PROPOSED			
A102	LEVEL 2 - DEMO/PROPOSED			
A103	LEVEL 3 - DEMO/PROPOSED			
A104	LEVEL 4 - DEMO/PROPOSED			
A105	ROOF - DEMO/PROPOSED			
A200	ELEVATIONS - DEMO/PROPOSED			
A201	ELEVATIONS - DEMO/PROPOSED			
A202	EXTERIOR FINISHES			
A300	BUILDING SECTIONS			
A500	AXONS			
AM100	MECH LAYOUT - LEVEL G,1			
AM101	MECH LAYOUT - LEVEL 2,3			
S100	STRUCTURAL FRAMING PLANS - LEVEL G & 1			
S101	STRUCTURAL FRAMING PLANS - LEVEL 2 & 3			
S102	STRUCTURAL FRAMING PLANS - LEVEL 4 & ROOF			
FA-0	FIRE ALARM NOTES & DETAILS			
FA-1	FIRE ALARM PLANS			
FA-2	FIRE ALARM PLANS			
FP-0	NOTES & DETAILS			
FP-1	FIRE PROTECTION PLANS			
FP-2	FIRE PROTECTION PLANS			

GENERAL REQUIREMENTS

ALL WORK SHALL BE IN COMPLIANCE WITH ALL APPLICABLE LOCALS BUILDING CODES AND REGULATIONS. CONTRACTOR SHALL BE

2. CONTRACTOR SHALL EXAMINE THE PREMISES AND SITE SO AS TO COMPARE THEM TO THE CONTRACT DRAWINGS AND WILL BE FAMILIAR WITH THE EXISTING CONDITIONS OF THE BUILDING AND ADJACENT PROPERTY PRIOR TO SUBMISSION OF BID NUMBER. ALLOWANCES ARE TO BE MADE TO INCLUDE ALL ITEMS OF WORK INCLUDING BOTH LABOR OR MATERIALS FOR ALL NOTED, DETAILS, OR IMPLIED ITEMS REQUIRED TO ATTAIN THE COMPLETED CONDITIONS PROPOSED IN THE DRAWINGS AND SPECIFICATIONS.

ALL SUBCONTRACTORS SHALL INSPECT THE SITE AND CONVEY ANY QUESTIONS REGARDING DESIGN INTENT AND SCOPE OF WORK TO THE

CONTRACTOR SHALL COORDINATE THE WORK OF ALL TRADES AND SUBCONTRACTORS AND SHALL BE RESPONSIBLE FOR ANY ACTS,

5. CONTRACTOR SHALL ASSUME SOLE RESPONSIBILITY FOR JOB SITE CONDITIONS INCLUDING THE SAFETY OF PERSONS AND PROPERTY FOR

CONTRACTOR SHALL CONFORM TO ALL NEIGHBORHOOD ASSOCIATION RULES AND GUIDELINES.

7. CONTRACTOR SHALL NOTIFY ARCHITECT IMMEDIATELY AND PRIOR TO ORDERING OF ALL LONG LEAD TIME ITEMS AND OF APPROXIMATE

NUMBER OF ADJUSTMENTS TO BE NECESSARY TO MEET THE DESIGN OBJECTIVES AND SHOULD CONSIDER SUCH ADJUSTMENTS AS

12. ALL DIMENSIONS ARE TO BE TAKEN FROM NUMERIC DESIGNATIONS ONLY; DIMENSIONS ARE NOT TO BE SCALED OFF OF THE DRAWINGS.

APPLICABLE TO PARTICULAR DIVISIONS OF THE WORK. SEE SPECIFICATIONS AND GENERAL NOTES IN THE INDIVIDUAL SUBSECTIONS OF CONTRACT DOCUMENTS FOR ADDITIONAL INFORMATION.

14. ALL DIMENSIONS ARE TO FACE OF FINISH UNLESS OTHERWISE NOTED.

PROVIDE WEATHERSTRIPPING AT ALL DOORS LEADING FROM HEATED TO UNHEATED AREAS. PROVIDE VINYL BEAD TYPE WEATHERSTRIPPING AT THESE DOORS AND WINDOWS. ALL SIDES OF NEW DOORS ARE TO BE WEATHERSTRIPPED INCLUDING THE

18. ALL WALL FRAMING SHALL BE 3 5/8" AT 16" ON CENTER UNLESS OTHERWISE NOTED.

20. STRUCTURAL WOOD MEMBERS ADJACENT TO CONCRETE ARE TO BE PRESSURE TREATED DOUGLAS FIR.

RESPONSIBLE FOR PERMITS APPLICABLE TO SPECIFIC TRADES OR SUBCONTRACTORS.

GENERAL CONTRACTOR WHO WILL CONVEY THESE TO THE ARCHITECT PRIOR TO SUBMITTING A BID AND PRIOR TO COMMENCING WORK.

OMISSIONS, OR ERRORS OF THE SUBCONTRACTORS AND OR PERSON DIRECTLY OR INDIRECTLY EMPLOYED BY THEM.

ALL CONSTRUCTION MATERIALS AND SUPPLIES ARE TO BE STORED, HANDLED, AND INSTALLED ACCORDING TO MANUFACTURERS'

9. IF ERRORS OR OMISSIONS ARE FOUND IN THE CONTRACT DOCUMENTS, THEY SHALL BE BROUGHT TO THE ATTENTION OF THE ARCHITECT BEFORE PROCEEDING WITH THE WORK.

10. DRAWINGS SCHEMATICALLY INDICATE NEW CONSTRUCTION. THE CONTRACTOR SHALL ANTICIPATE, BASED ON EXPERIENCE, A REASONABLE

WHEN SPECIFIC FEATURES OF CONSTRUCTION ARE NOT FULLY SHOWN ON THE DRAWINGS OR CALLED FOR IN THE GENERAL NOTES, THEIR CONSTRUCTION SHALL BE OF THE SAME CHARACTER AS SIMILAR CONDITIONS.

13. THESE NOTES ARE TO APPLY TO ALL DRAWINGS AND GOVERN UNLESS MORE SPECIFIC REQUIREMENTS ARE INDICATED THAT ARE

16. CAULK AND SEAL OPENINGS IN BUILDING EXTERIOR TO A THICKNESS OF 1/8" OR GREATER TO PREVENT AIR INFILTRATION.

17. ALL WINDOWS ARE TO BE OPERABLE FOR CLEANING UNLESS OTHERWISE NOTED

19. ALL GYPSUM BOARD SHALL BE 5/8" THICK UNLESS OTHERWISE NOTED.

C:\Users\NickCarvello\Design Resource Team, LLC\Active Projects - Documents\221062A-8 Monument Sq\BIM\221062 - 8 Monument Sq 2023.rvt

WITH ALL APPLICABLE SECTIONS.

architecture

interiors

Design Resource Team, LLC

617.804.6117

8-9 Monument Sq LLC

Consultants

Surveyor and Civil

(617) 472-4867

Structural Engineer


Design Resource Team, LLC.


546 East Broadway, Boston, MA 02127


Neponset Valley Survey Associates Inc

95 White St, Quincy, MA 02169

8 MONUMENT SQ **COVER**

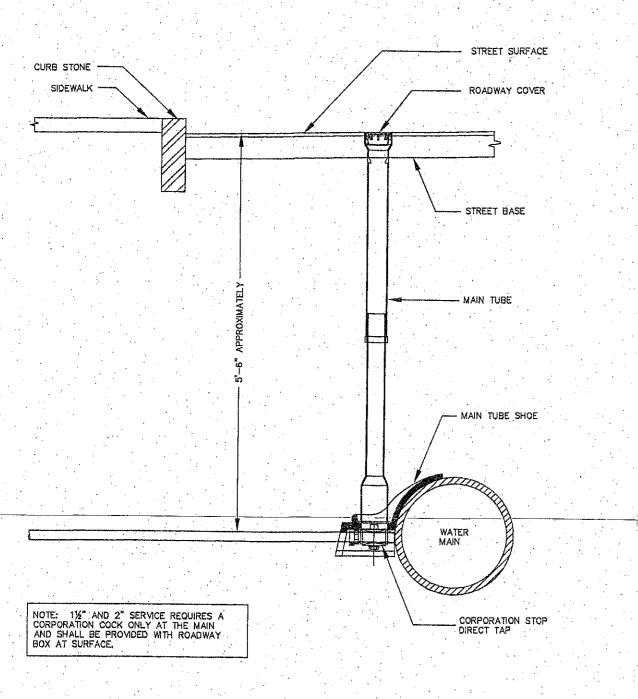


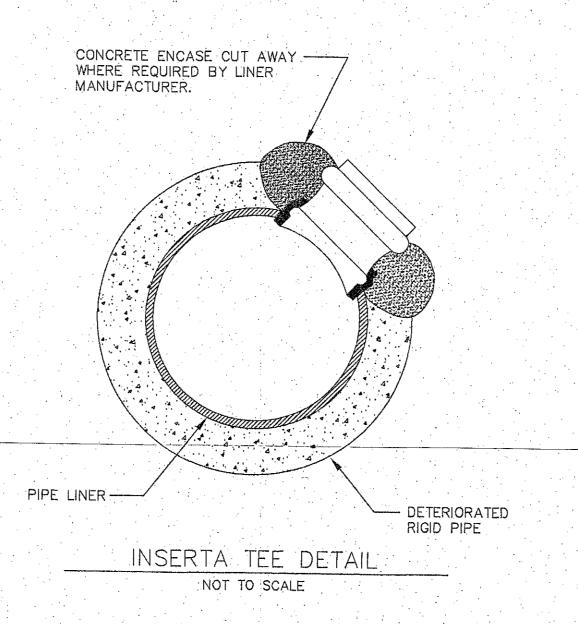

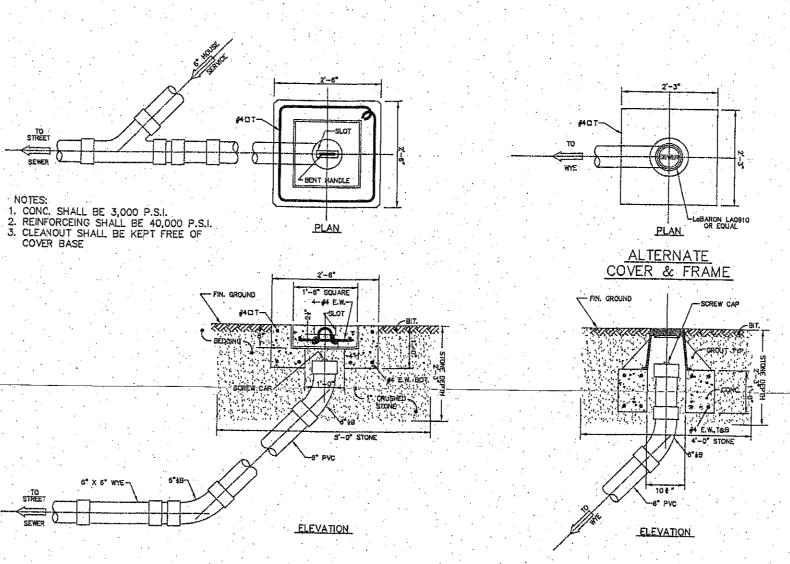


SEWER AND DRAIN CLEANOUT DETAILS NO SCALE

1 1/2" TO 2" WATER CONNECTION DETAIL

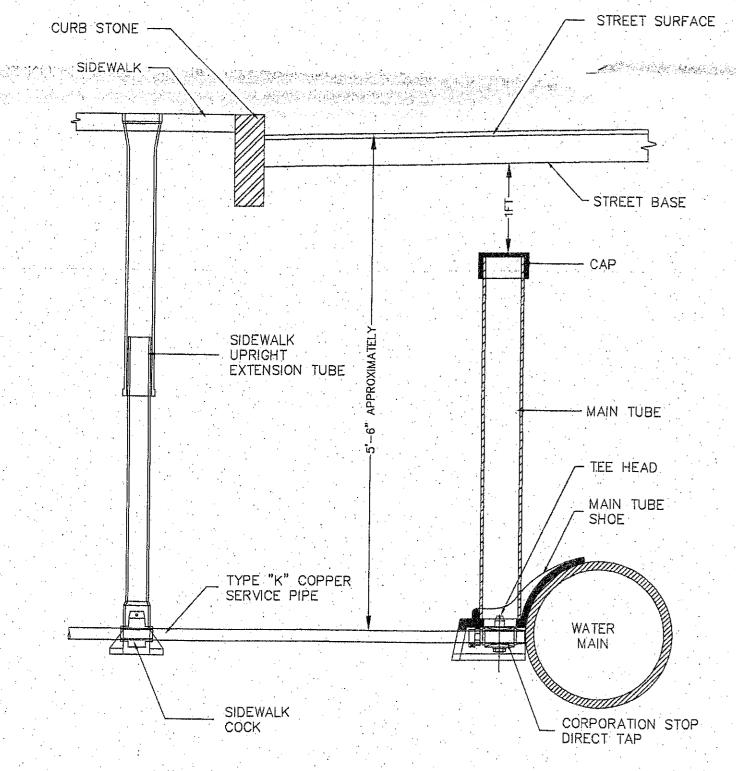

WATER CONNECTION DETAIL NOT TO SCALE

WYE BRANCH IS NOT FOUND IN THE FIELD.

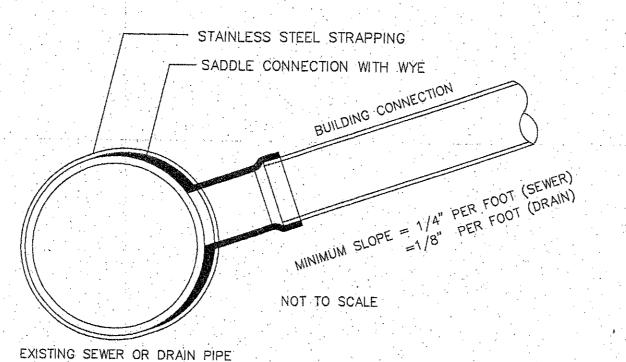


1. FULL PVC OR IRON SADDLE MAY BE USED TO CONNECT TO EXISTING PVC, CLAY, CONCRETE OR IRON PIPE.

2. SADDLES MUST HAVE RUBBER GASKETS AND SHALL BE TIGHTENED WITH STRAPS. SADDLES WILL NOT BE CEMENTED ONTO THE PIPE.

3. FULL WYE CONNECTION FITTINGS MAY BE USED.
4. PIPE SHALL BE CUT TO CONFORM TO THE OPENING IN THE SADDLE.

5. CONNECTIONS DIRECTLY INTO THE EXISTING PIPE WITHOUT A SADDLE OR A FULL WYE FITTING ARE NOT ALLOWED. 6. TO BE USED IF AN EXISTING WYE IS NOT FOUND.

> SEWER CONNECTION DETAIL NOT TO SCALE

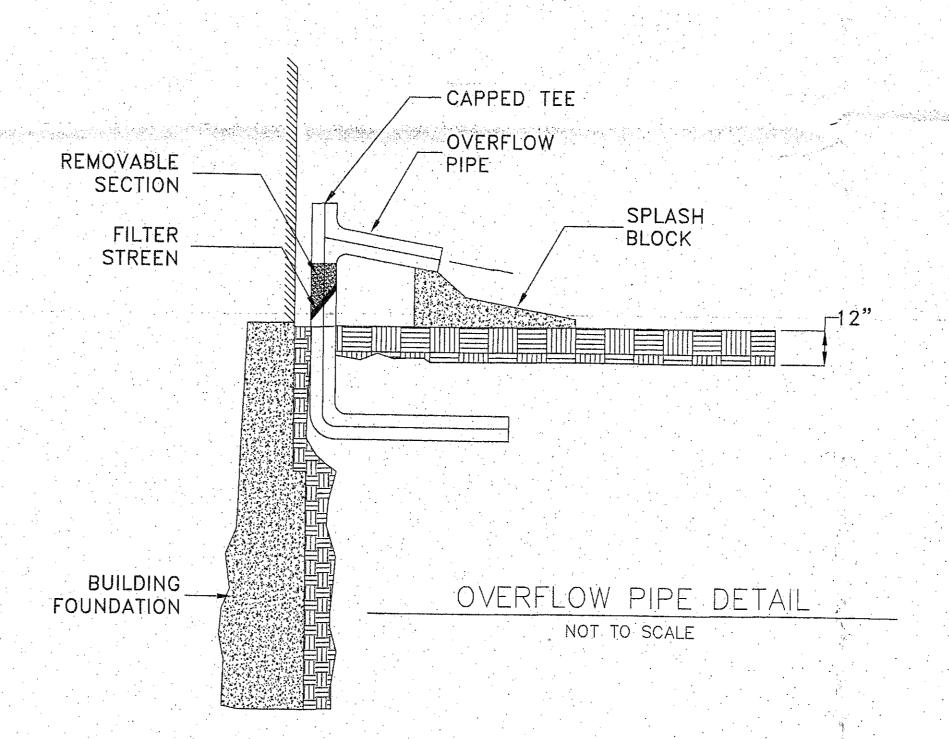

1346926 02792000 PROPERTY LOCATION 8 MONUMENT SQUARE CHARLESTOWN O2129

EDWARD F. KELLY REVOCABLE
TRUST OF 2016 C/O Rob Gatnik OWNERS ADDRESS WEST ROXBURY, MA 02132 OWNERS TELEPHONE NUMBER 617-308-4889 TYPE OF PREMISE _____ 4 FAMILY METER SIZE 22-065 BWSC PROJECT No. LAND USE CODE

PLAN 8 MONUMENT SQUARE BOSTON, (CHAS.) MASS. PREPARED FOR: EDWARD F. KELLEY PREPARED BY: NEPONSET VALLEY SURVEY ASSOC., INC.

95 WHITE STREET (617) 877-8433 NOVEMBER 17, 2022

QUINCY, MA. SCALE 1" = 10' SHEET 2 OF 2

NOTES


A PREREQUISITE FOR FILING A GENERAL SERVICE APPLICATION WITH THE BOSTON WATER AND SEWER COMMISSION FOR NEW CONSTRUCTION IS THE <u>ROUGH CONSTRUCTION SIGN OFF</u> DOCUMENT FROM THE CITY OF BOSTON'S INSPECTIONAL SERVICES DEPARTMENT. - INDICATES 5' WIDE TRENCH, MAXIMUM EXCAVATION IN PUBLIC WAY.


ANY EXISTING WATER AND SEWER SERVICES UNCOVERED ARE TO BE ABANDONED AND SHALL BE CUT AND CAPPED AT THE MAIN IN THE STREET BY THE GENERAL CONTRACTOR, PROPOSED BUILDING CONTAINS 9 BEDROOMS WITH AN AVERAGE DAILY SANITARY SEWAGE FLOW OF 110 GALLONS FOR A TOTAL OF 990 GALLONS PER DAY.


THE LOCATION OF ALL UNDERGROUND UTILITIES SHOWN ARE APPROXIMATE AND ARE BASED UPON A FIELD SURVEY AND COMPILATION OF RECORD UTILITY PLANS, N.V.S.A., INC. DOES NOT WARRANTY NOR GUARANTEE THE LOCATION OF ALL OR ANY OF THE UTILITIES DEPICTED, THE CONTRACTOR SHALL VERIFY THE LOCATION OF ALL UTILITIES BY CONTACTING 'DIG SAFE' AT (800) 322-4844 PRIOR TO COMMENCEMENT OF CONSTRUCTION.

TBM - SMH INV.=59.54 @ STA 0+00


CITY OF BOSTON L-PLAN - NONE (MONUMENT SQUARE)

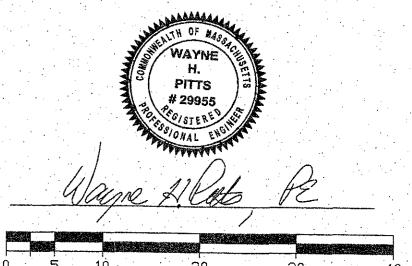

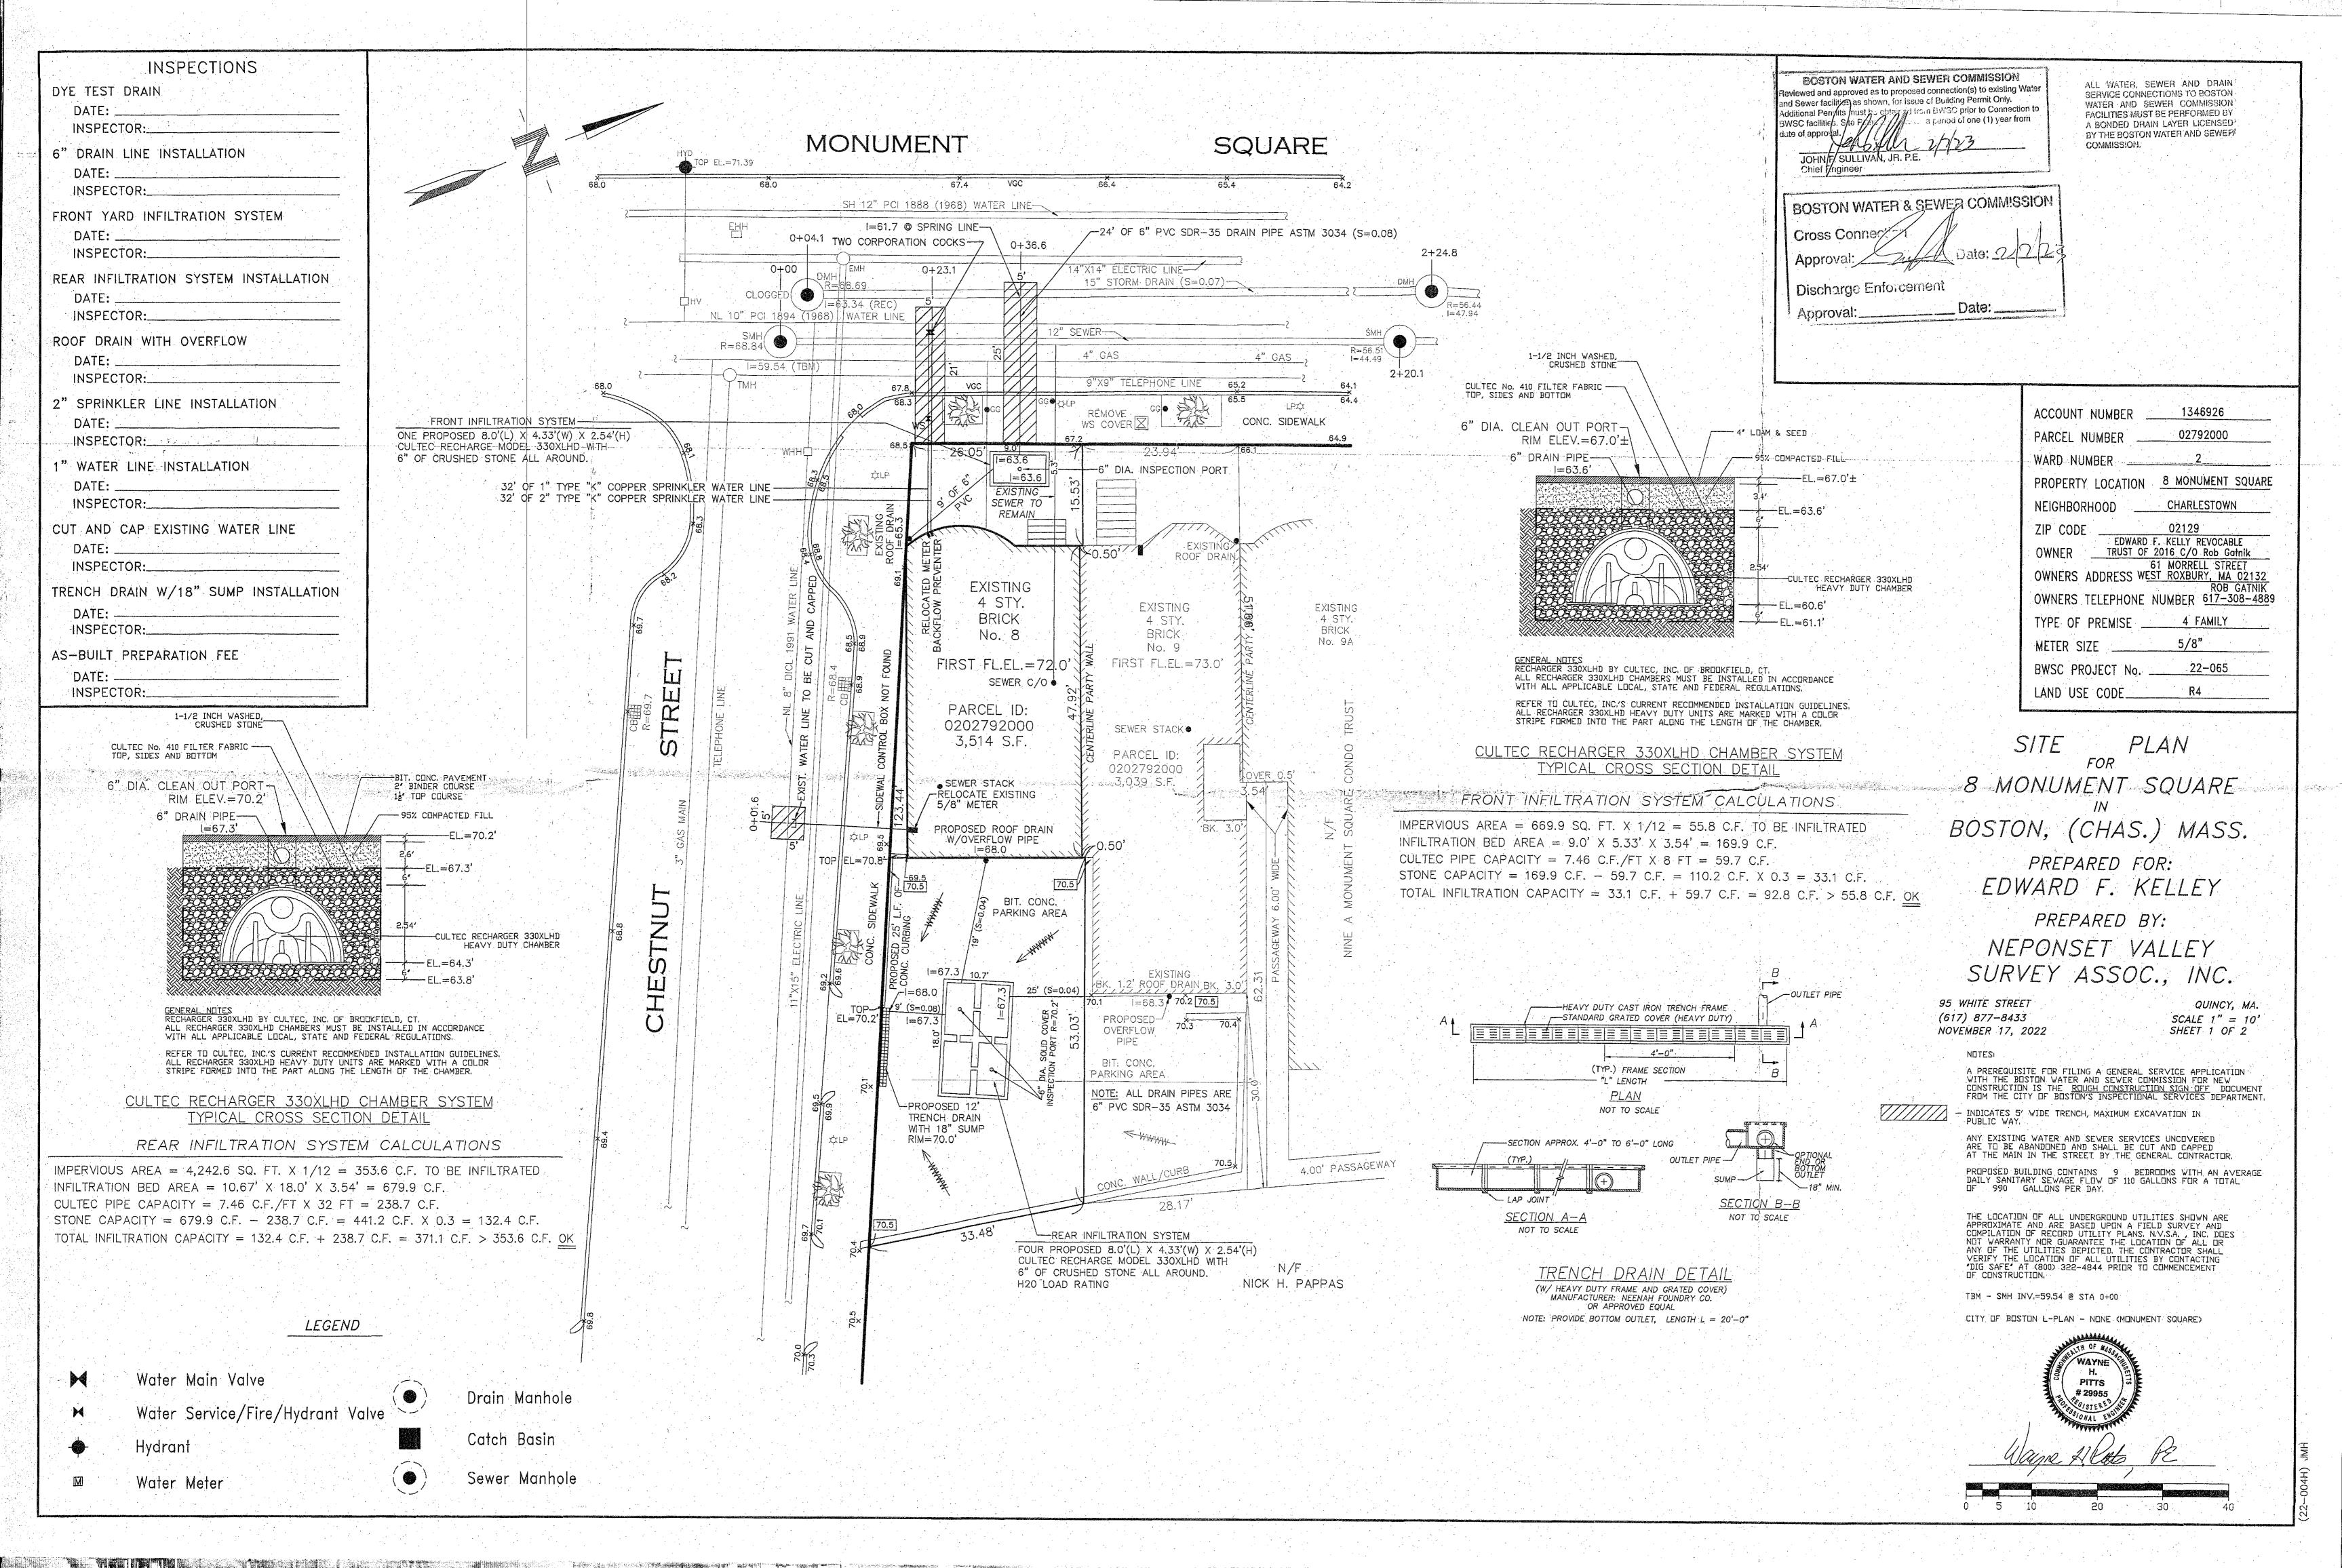

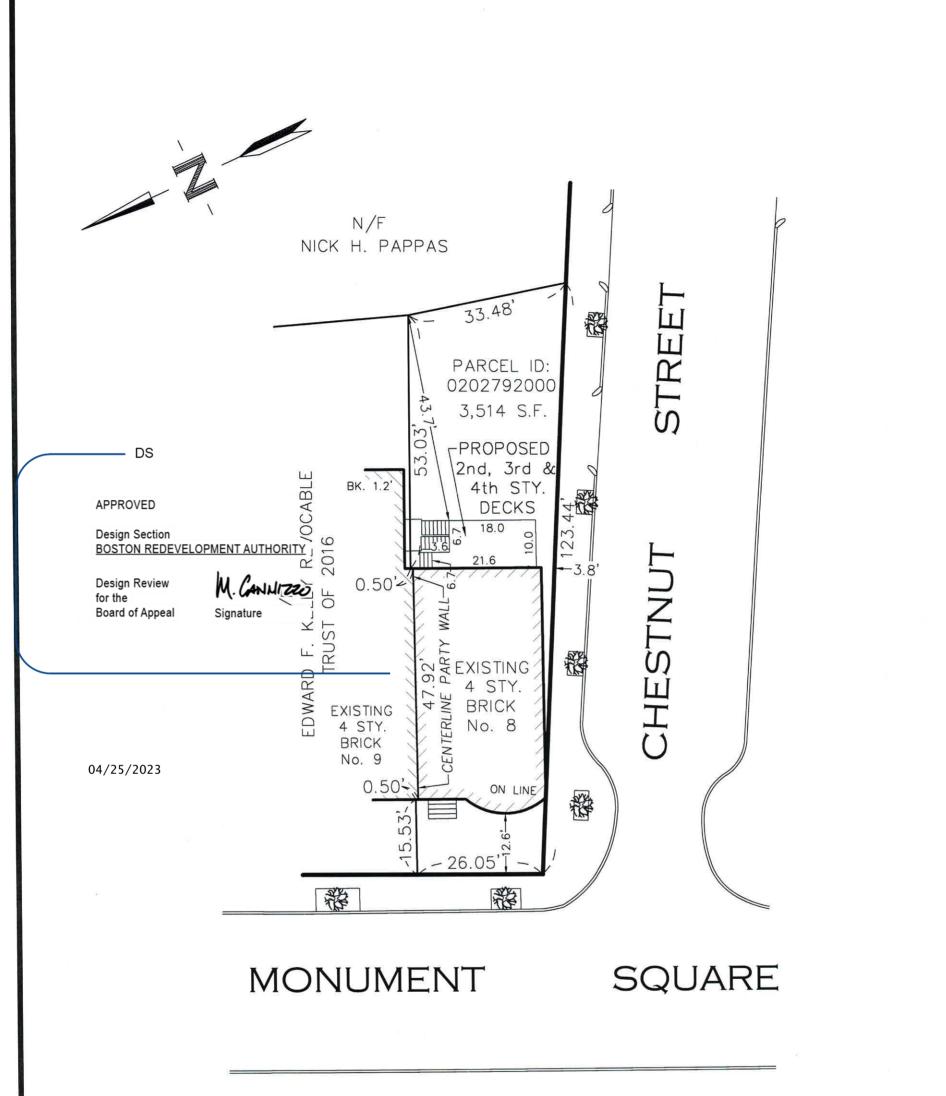

Approved pursuant to Article 80E for projects in a Neighborhood Design Overlay District.

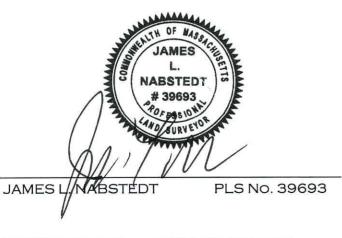

40

10

20

60

PLOT PLAN SHOWING

PROPOSED DECK

8 MONUMENT SQUARE

BOSTON (CHAS.), MASS.

PREPARED BY:

NEPONSET VALLEY SURVEY ASSOC., INC. 95 WHITE STREET QUINCY, MA 02169

SCALE:


DATE:

SHEET 1 OF 1


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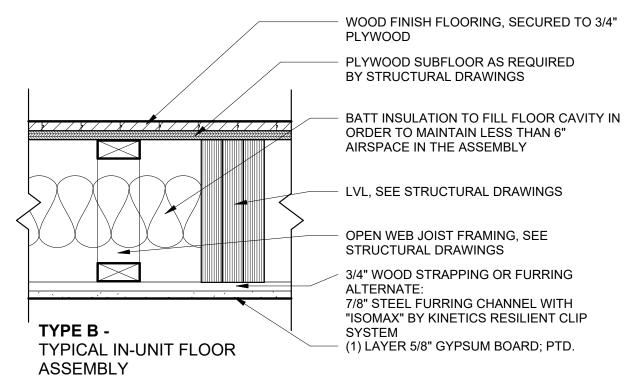
MARCH 27, 2023

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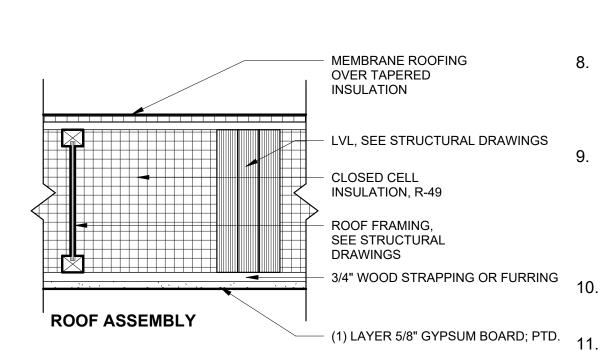


WALL TYPES

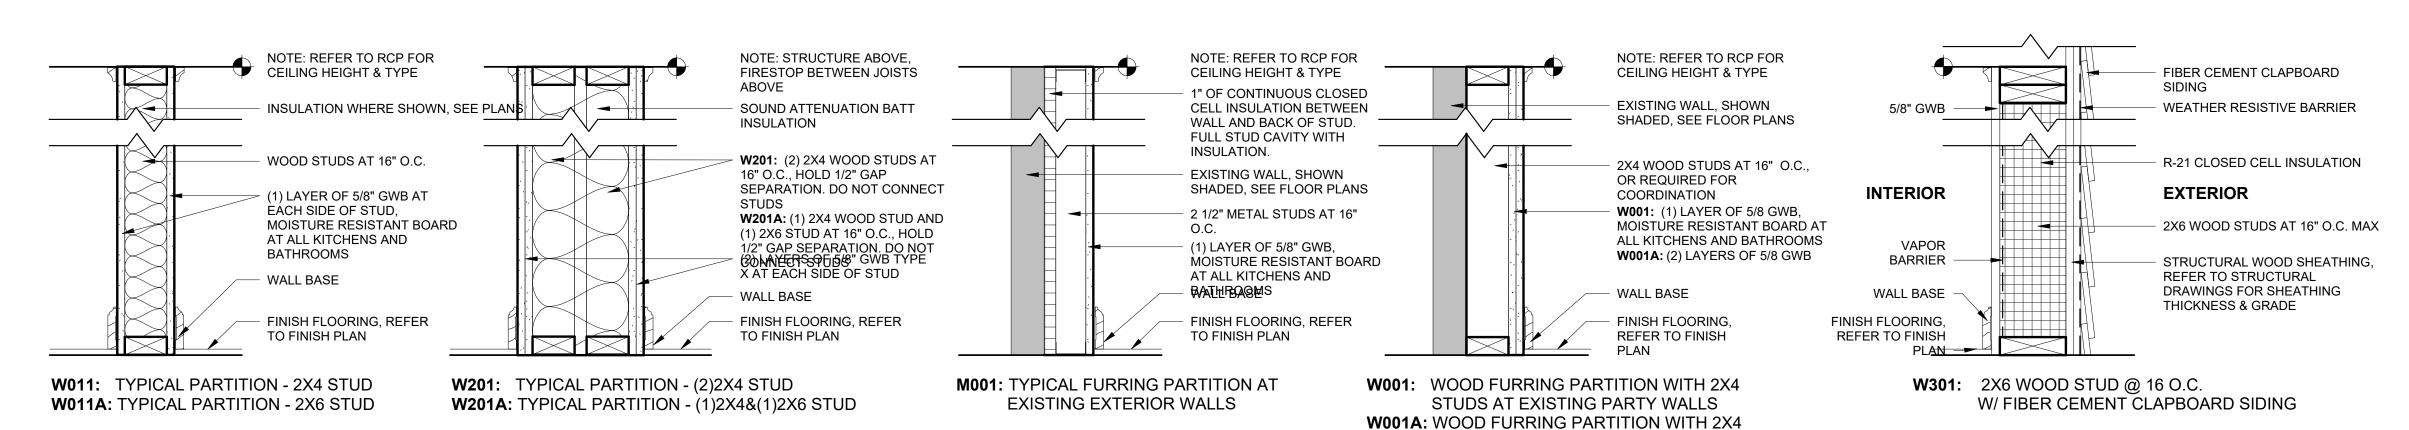

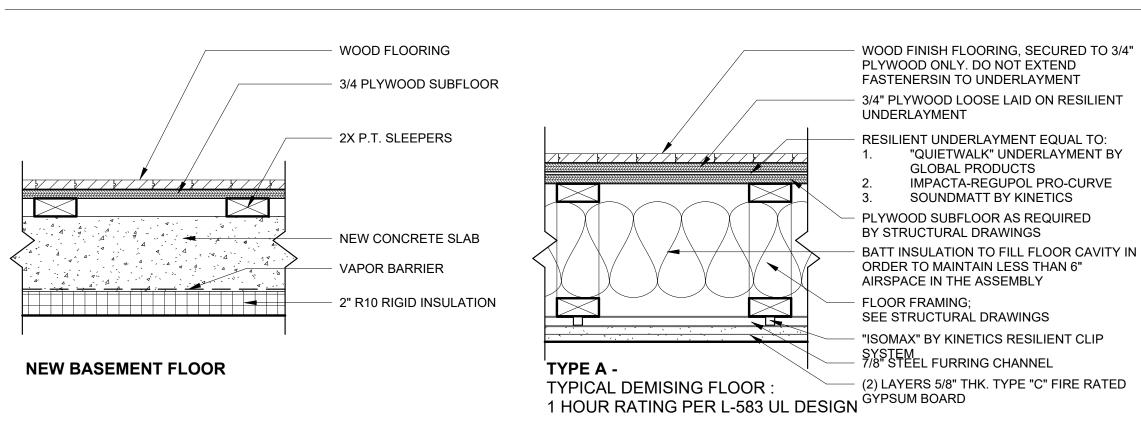

STUDS AT EXISTING PARTY WALLS - (2) LAYERS GWB



- SEE FLOOR PLANS FOR PARTITION TAGS AND LOCATIONS.
- SEE FLOOR PLANS FOR LOCATIONS OF SOUND INSULATION.
- PARTITION TYPE DETAILS SHOW ONLY PRINCIPLE COMPONENTS AND REQUIREMENTS; RATED PARTITIONS WITH U.L. DESIGN NUMBERS MAY HAVE ADDITIONAL COMPONENTS AND REQUIREMENTS; REFER TO U.L. FIRE RESISTANCE DIRECTORY.
- RATED PARTITIONS SHALL HAVE U.L. HEAD DESIGNS, SEALANT, AND FILL MATERIAL OF THE SAME RATING.
- ALL THROUGH-WALL PENETRATIONS MUST BE COMPLETED TO PREVENT DIRECT CONTACT WITH FRAMING MEMBERS AND SHALL BE ACOUSTICALLY SEALED WITH A RESILIENT, NON-HARDENING CAULK. IF THE PENETRATION IS THOUGH A FIRE-RATED PARTITION AN ACOUSTICAL FIRE-RATED CAULK SHALL BE USED.
- SEE SPECIFICATIONS AND STRUCTURAL DRAWINGS FOR REINFORCING, BRACING AND OTHER SPECIAL REQUIREMENTS.
- PROVIDE LATERAL BRACING AND CROSS-BRIDGING AS RECOMMENDED BY STUD MANUFACTURER FOR EACH CONDITION
- COORDINATE FINISHES APPLIED TO PARTITIONS AS INDICATED IN THE FINISH SCHEDULE, INTERIOR **ELEVATIONS AND ELSEWHERE IN THE CONTRACT** DOCUMENTS.
- PROVIDE BLOCKING AT LOCATIONS INCLUDING BUT NOT LIMITED TO CASEWORK, SHELVING, COUNTERS, CABINETS, DOOR STOPS, HANDRAIL BRACKETS, TELEVISION LOCATIONS, BATHROOM ACCESSORIES, ETC. WHERE INDICATED, SPECIFIED OR REQUIRED TO PROVIDE A SOLID BASE.
- SUBSTITUTE MOISTURE-RESISTANT GYPSUM BOARD AT ALL BATHROOMS AND LAUNDRY ROOMS.
- WHERE TWO OR MORE LAYERS OF GYPSUM BOARD ARE USED, BOTH HORIZONTAL AND VERTICAL JOINTS SHALL BE STAGGERED.
- FIBER INSULATION SHOULD BE UN-FACED AND SECURED TO STRUCTURE TO PREVENT SAGGING.



Design Resource Team, LLC 546 East Broadway Boston, MA 02127 617.804.6117 info@drt.boston www.drt.boston



No.	Description	D


8-9 MONUMENT SQ LLC

8 MONUMENT SQ

BUILDING INFORMATION


Project number	221062A
Date	3/23/2023
Drawn by	NC
Checked by	NPL
A001	
Scale	1 1/2" = 1'-0"


FLOOR ASSEMBLIES

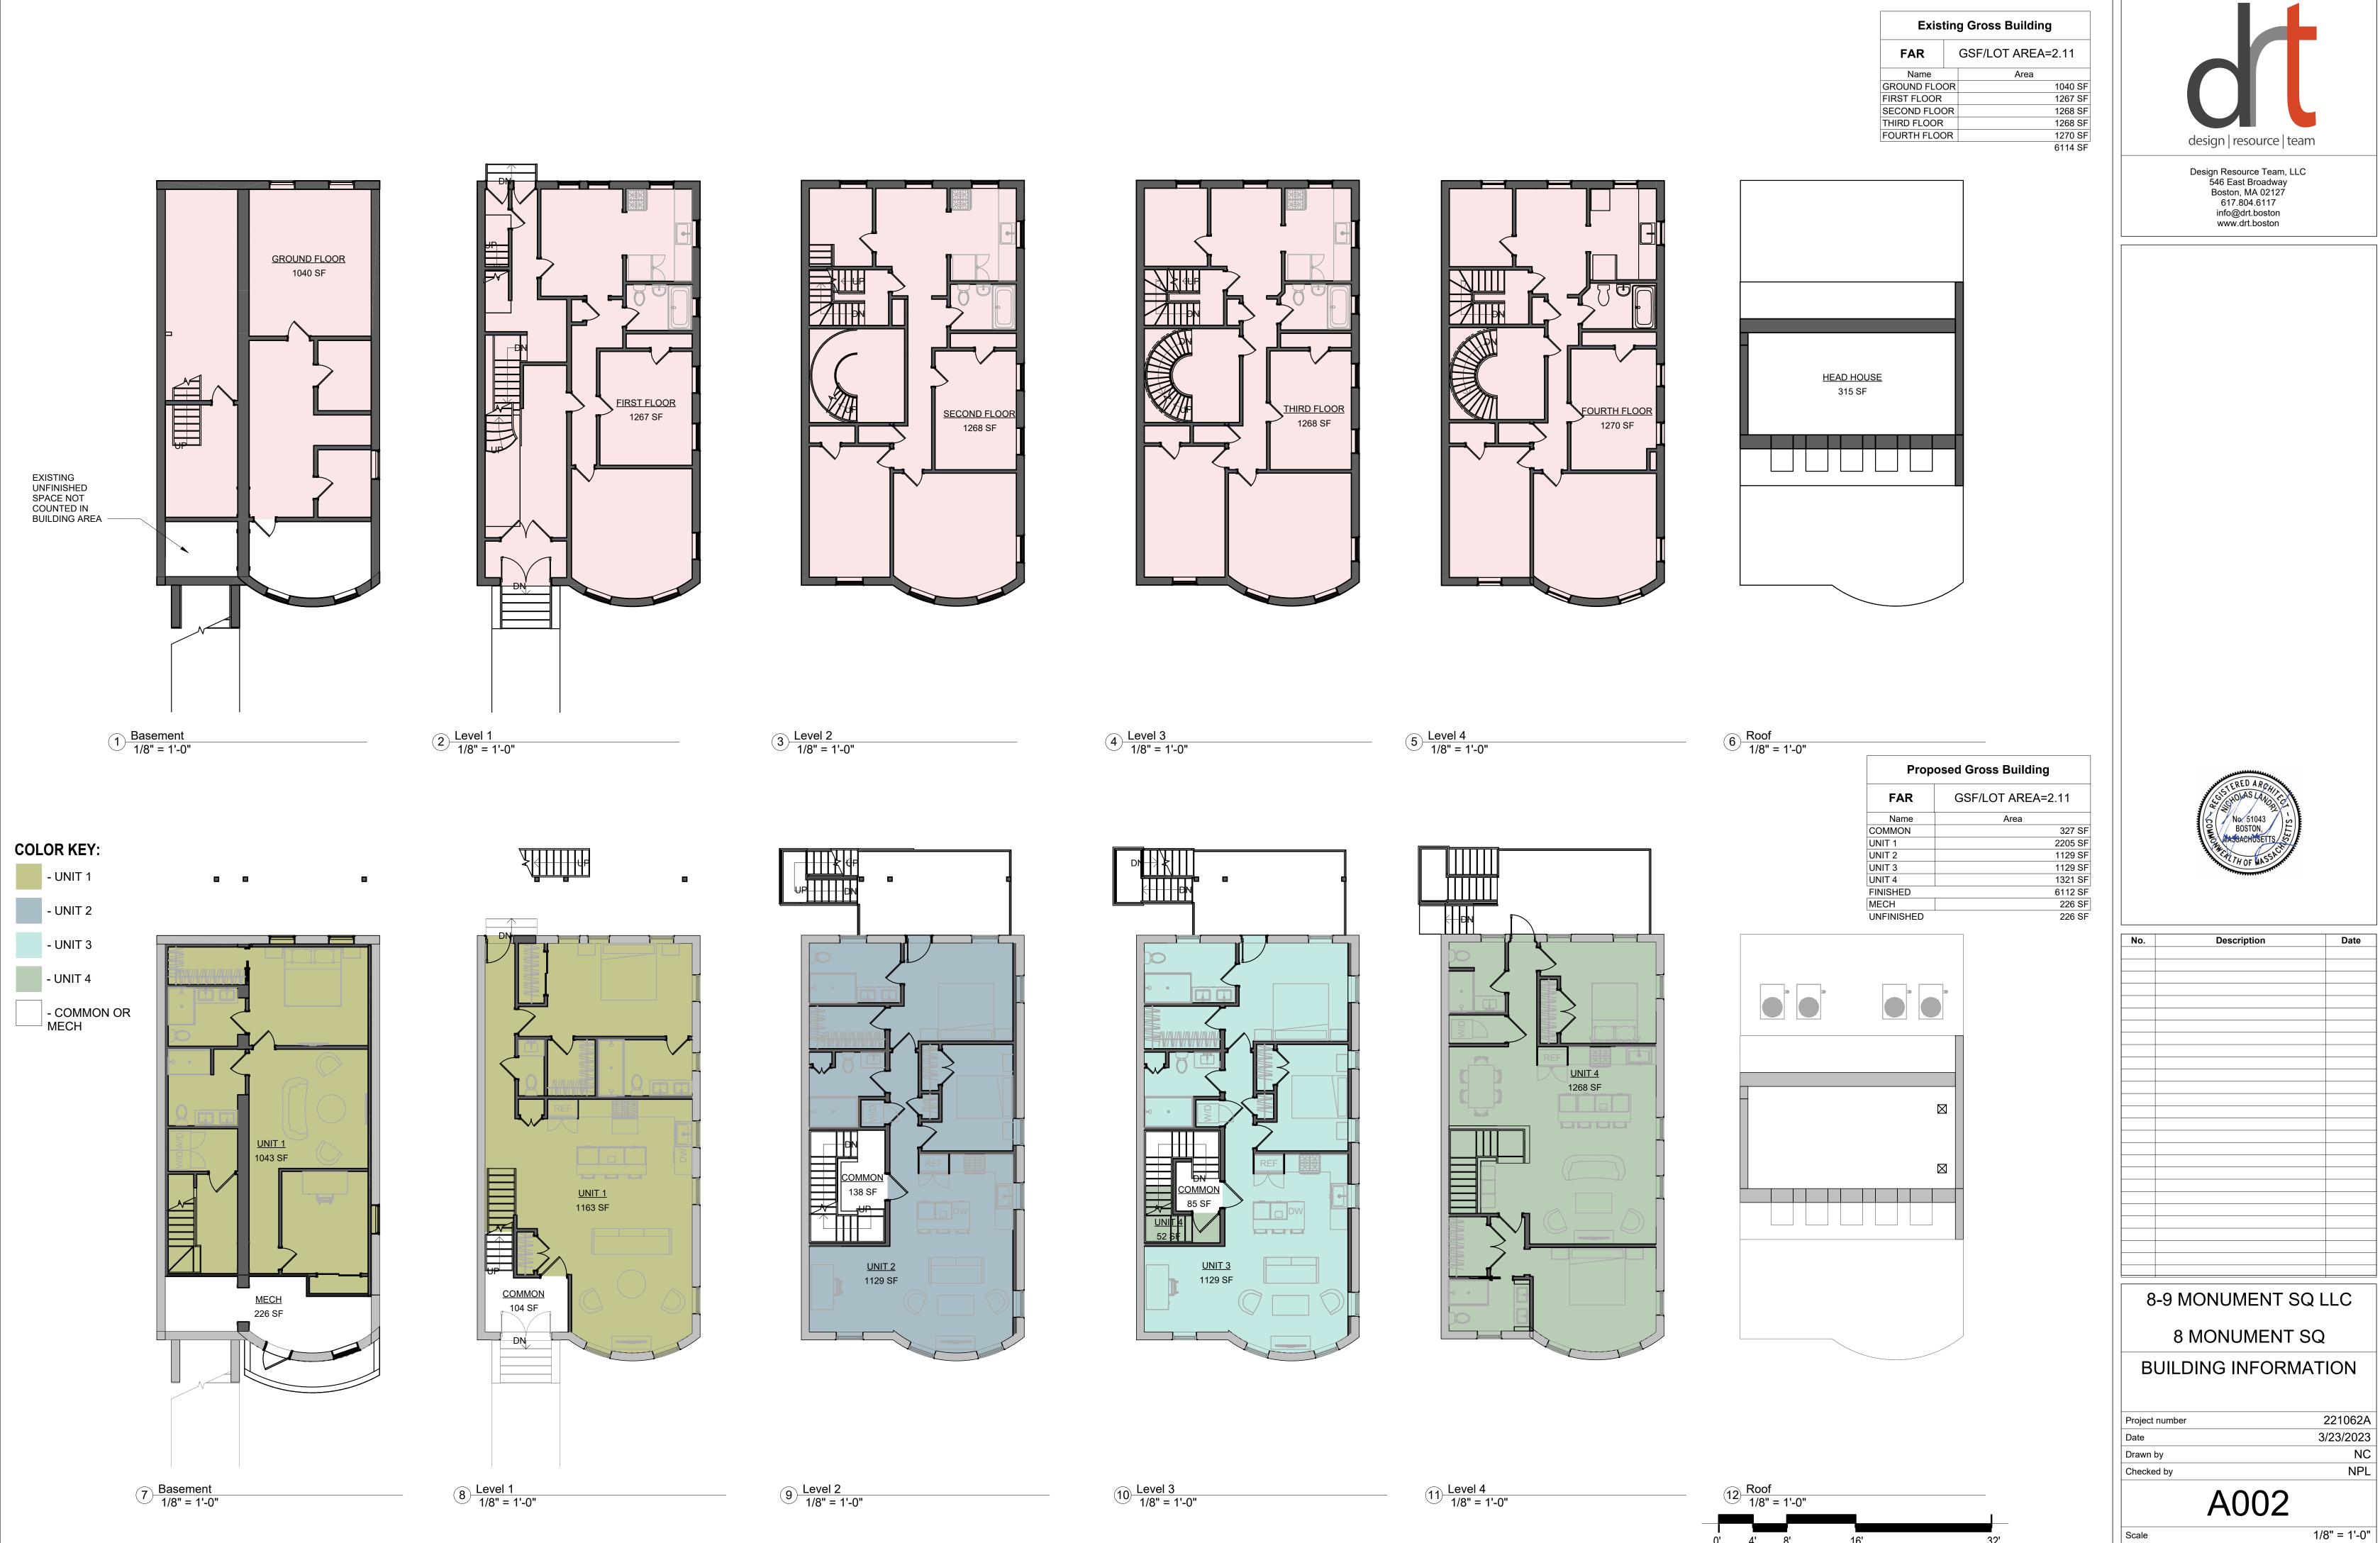



3/23/2023 11:24:04 AM

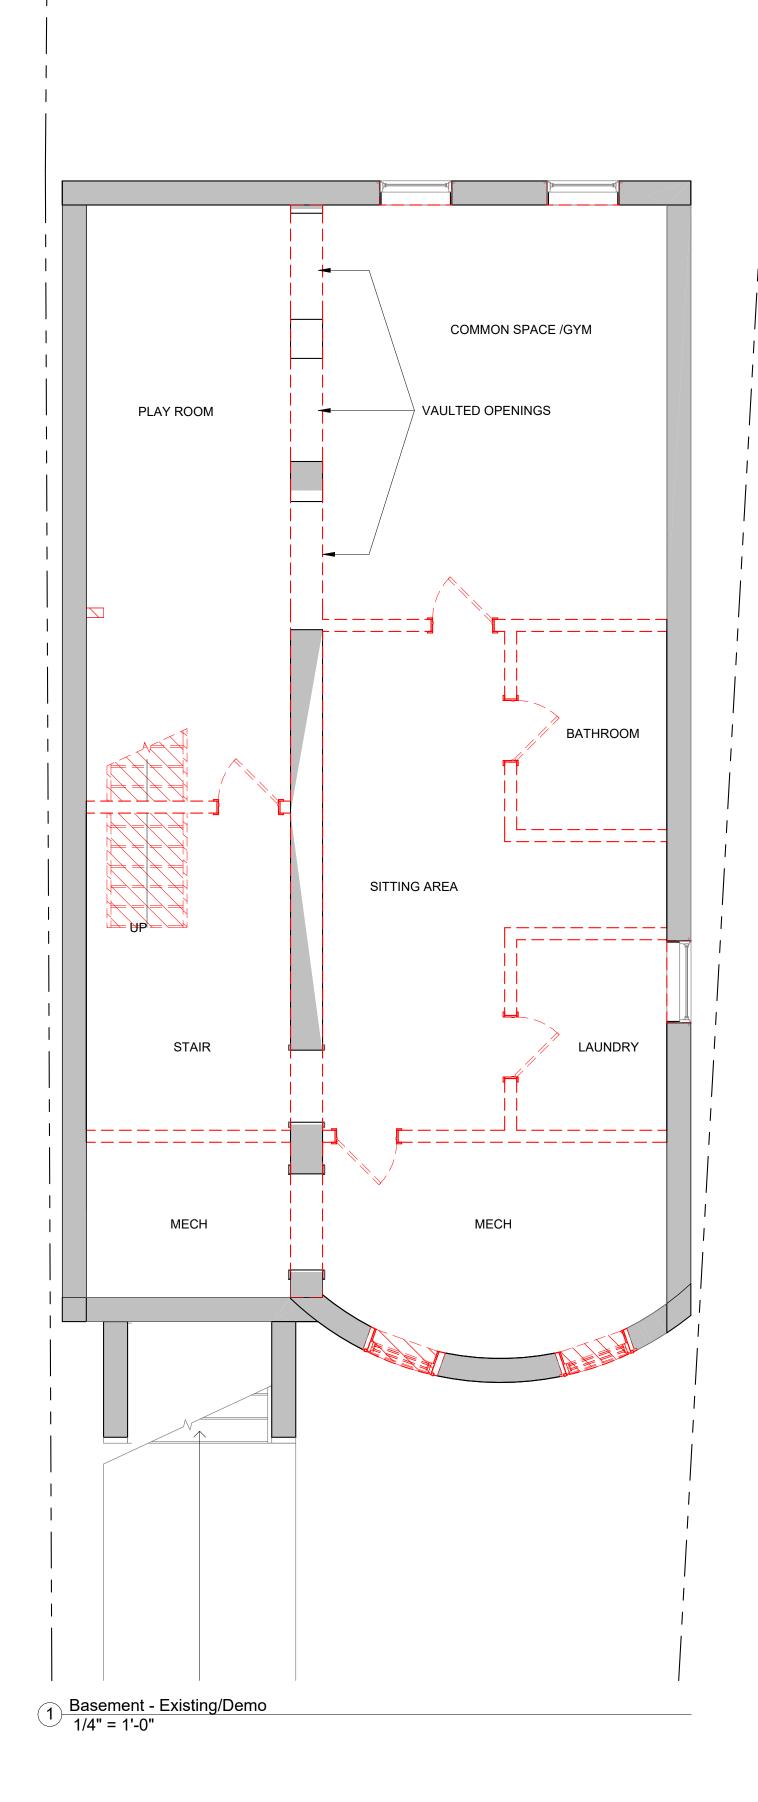

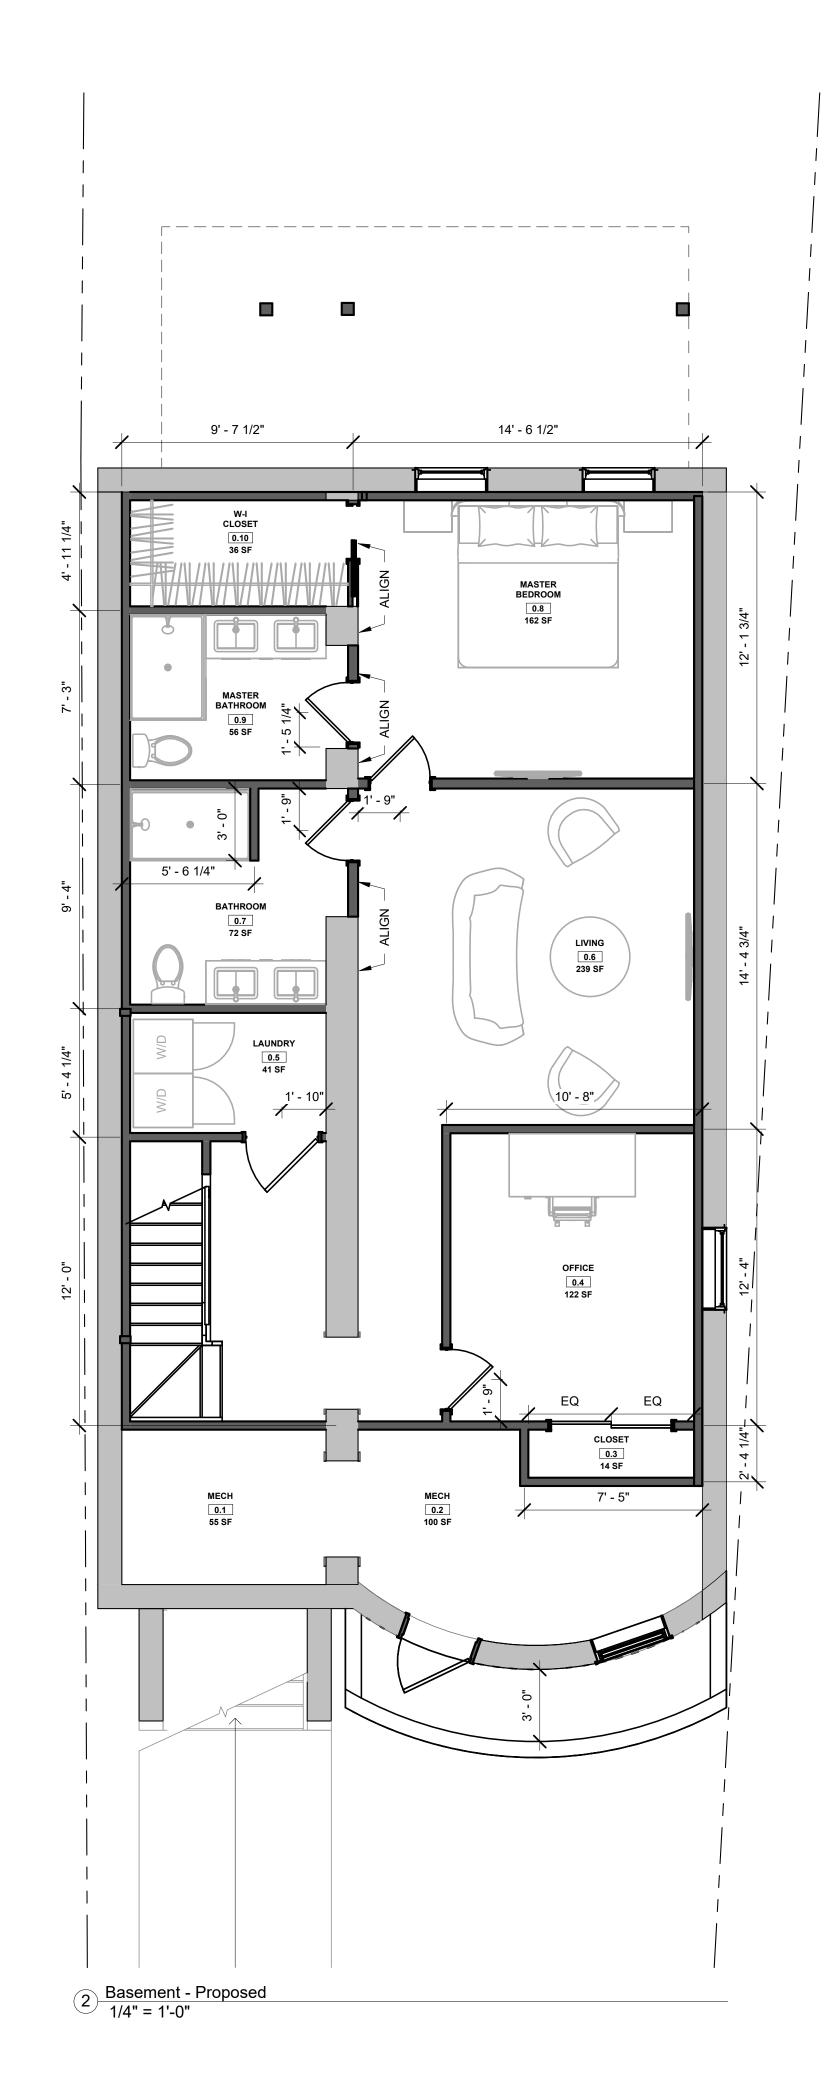

- WHEN SPECIFIC FEATURES OF CONSTRUCTION ARE NOT FULLY SHOWN ON THE DRAWINGS OR CALLED FOR IN THE GENERAL NOTES, THEIR CONSTRUCTION SHALL BE OF THE SAME CHARACTER AS SIMILAR CONDITIONS.
- ALL DIMENSIONS ARE TO BE TAKEN FROM NUMERIC DESIGNATIONS ONLY; DIMENSIONS ARE NOT TO BE SCALED OFF THE DRAWINGS.
- ALL GYPSUM BOARD SURFACES ARE TO BE 5/8" THICK UNLESS OTHERWISE NOTED.
- ALL GYPSUM AND PLASTER FINISHES SHOULD BE SMOOTH, CONTINUOUS, FREE OF IMPERFECTIONS, AND HAVE NO VISIBLE JOINTS.
- PROVIDE GAS, WATER SPIGOT, OUTLET, AND LIGHTING AT ROOF DECKS.
- ALL CLOSETS SHALL HAVE SHELF AND POLE OR SHELVES AS REQUIRED, UNLESS OTHERWISE NOTED.
- ALL REQUIRED LIFE SAFETY DEVICES, INCLUDING SMOKE & CARBON MONOXIDE DETECTORS, SHALL BE INSTALLED BY THE CONTRACTOR IN COMPLIANCE WITH THE 2015 INTERNATIONAL BUILDING CODE

PLAN NOTES

- WALL DIMENSIONS ARE MEASURED FROM FACE OF EXIST. WALL TO C.L. OF NEW WALL, UNLESS OTHERWISE
- 2. ALL DOORS ARE 80" TALL UNLESS OTHERWISE NOTED.


MECHANICAL | SECURITY NOTES

- PROVIDE 5.1 AUDIO WIRING FOR LIVING ROOM AND MASTER BEDROOMS; FOR NUMBER AND LOCATION, SEE REFLECTED CEILING PLANS.
- PROVIDE NEST LEARNING THERMOSTAT AT EACH UNIT. (ZONING PER FLOOR LEVEL IN DUPLEX UNITS)
- HEATING AND AIR CONDITIONING IS TO BE PROVIDED BY HIGH VELOCITY FORCED AIR SPACE PAK HIGH VELOCITY AIR CONDITIONING SYSTEMS WITH HYDRONIC HEATING.
- HOT WATER IS TO BE PROVIDED BY A HIGH EFFICIENCY NAVIEN MODULATING CONDENSING COMBINATION HEATING AND HOT WATER SYSTEM OR EQUAL.
- HARD WIRED SECURITY SYSTEM SHALL BE PROVIDED AT EACH UNIT; CONTACTS SHALL BE PLACED AT EXTERIOR DOORS AND WINDOWS WITH ONE MOTION DETECTOR

ELECTRICAL NOTES

- ELECTRICAL SERVICE POWER IS TO BE EVALUATED FOR MEETING LIGHTING DESIGN AND EQUIPMENT REQUIREMENTS. PROPER POWER LEVEL SHALL BE PROVIDED.
- ALL NEW ELECTRICAL ITEMS ARE TO BE U.L. RATED.
- ALL ELECTRICAL PANELS ARE TO BE RECESSED INTO A WALL WITH A MINIMUM 6" STUD DIMENSION. REVIEW FINAL LOCATION WITH ARCHITECT AND OWNER.
- 4. ALL DISTRIBUTION PANELS ARE TO BE NEW.
- LIVING AREAS, DINING AREAS, AND ALL BEDROOM ARE TO RECEIVE 3-WIRE JUNCTION BOXES.
- PROVIDE ELECTRIC HEAT MATS BY NUHEAT OR EQUAL AT ALL BATHROOMS.
- ALL CLOSET LIGHTING IS TO BE HIGH EFFICIENCY LIGHTING.
- OUTLETS IN BATHROOMS SHALL HAVE GROUND FAULT INTERCEPTORS.
- ALL SMOKE DETECTORS SHALL RECEIVE THEIR PRIMARY SOURCE OF POWER FROM BUILDING WIRING WITH BATTERY BACK-UP.
- ALL DIMENSIONS FOR THE FOLLOWING ITEMS ARE TO FINISH SURFACES UNLESS OTHERWISE NOTED:
 - MOUNT ALL OUTLETS, PHONE JACKS, AND TELEVISION CABLE JACKS VERTICALLY AT 18" TO CENTERLINE ABOVE THE FINISH FLOOR UNLESS OTHERWISE NOTED. WHERE BASE AND TRIM IS LARGER THAN 9-1/2" TALL PROVIDE 6" CLEARANCE FROM BOTTOM OF PLATE TO TOP OF BASEBOARD
 - MOUNT ALL SWITCHES AT 42" TO CENTERLINE ABOVE FINISH FLOOR UNLESS OTHERWISE NOTED.
 - VERTICALLY ALIGN SWITCHES AND OUTLETS WHERE POSSIBLE.

DEMO/PROPOSED PLAN GRAPHIC KEY

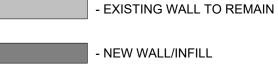



- AREA NOT IN CONTRACT



- DEMOLISHED BUILDING ELEMENT

- DEMOLISHED FLOOR FINISH/CEILING



TRIPLE DASHED RED LINE INDICATES REQUIRED (1) HOUR FIRE RESISTANCE RATED SEPARATION, UL NO. U314 AT WALLS AND UL NO. L501 AT CEILING



Design Resource Team, LLC 546 East Broadway Boston, MA 02127 617.804.6117 info@drt.boston www.drt.boston



Description


8-9 MONUMENT SQ LLC


8 MONUMENT SQ

GROUND FLOOR -DEMO/PROPOSED

221062A Project number 3/23/2023 Drawn by

A100

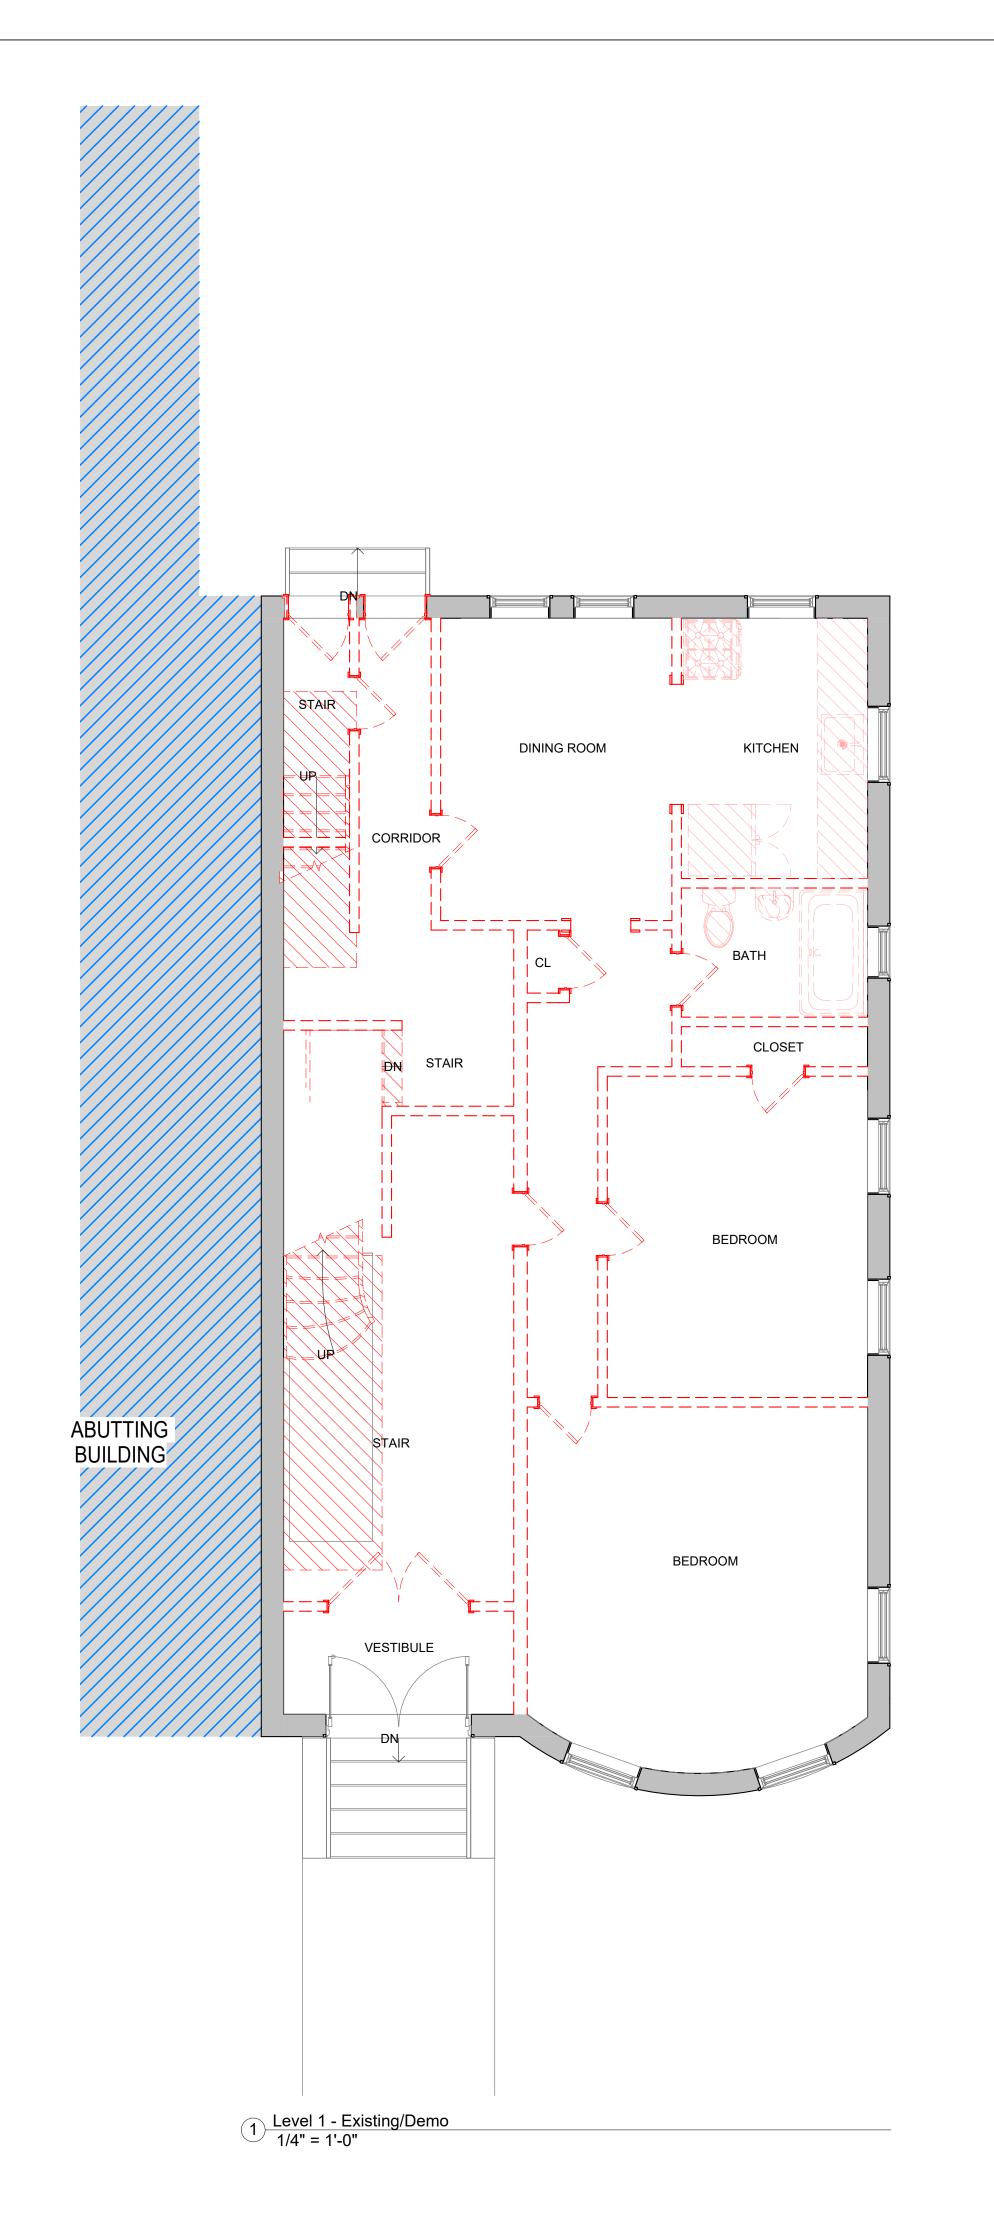

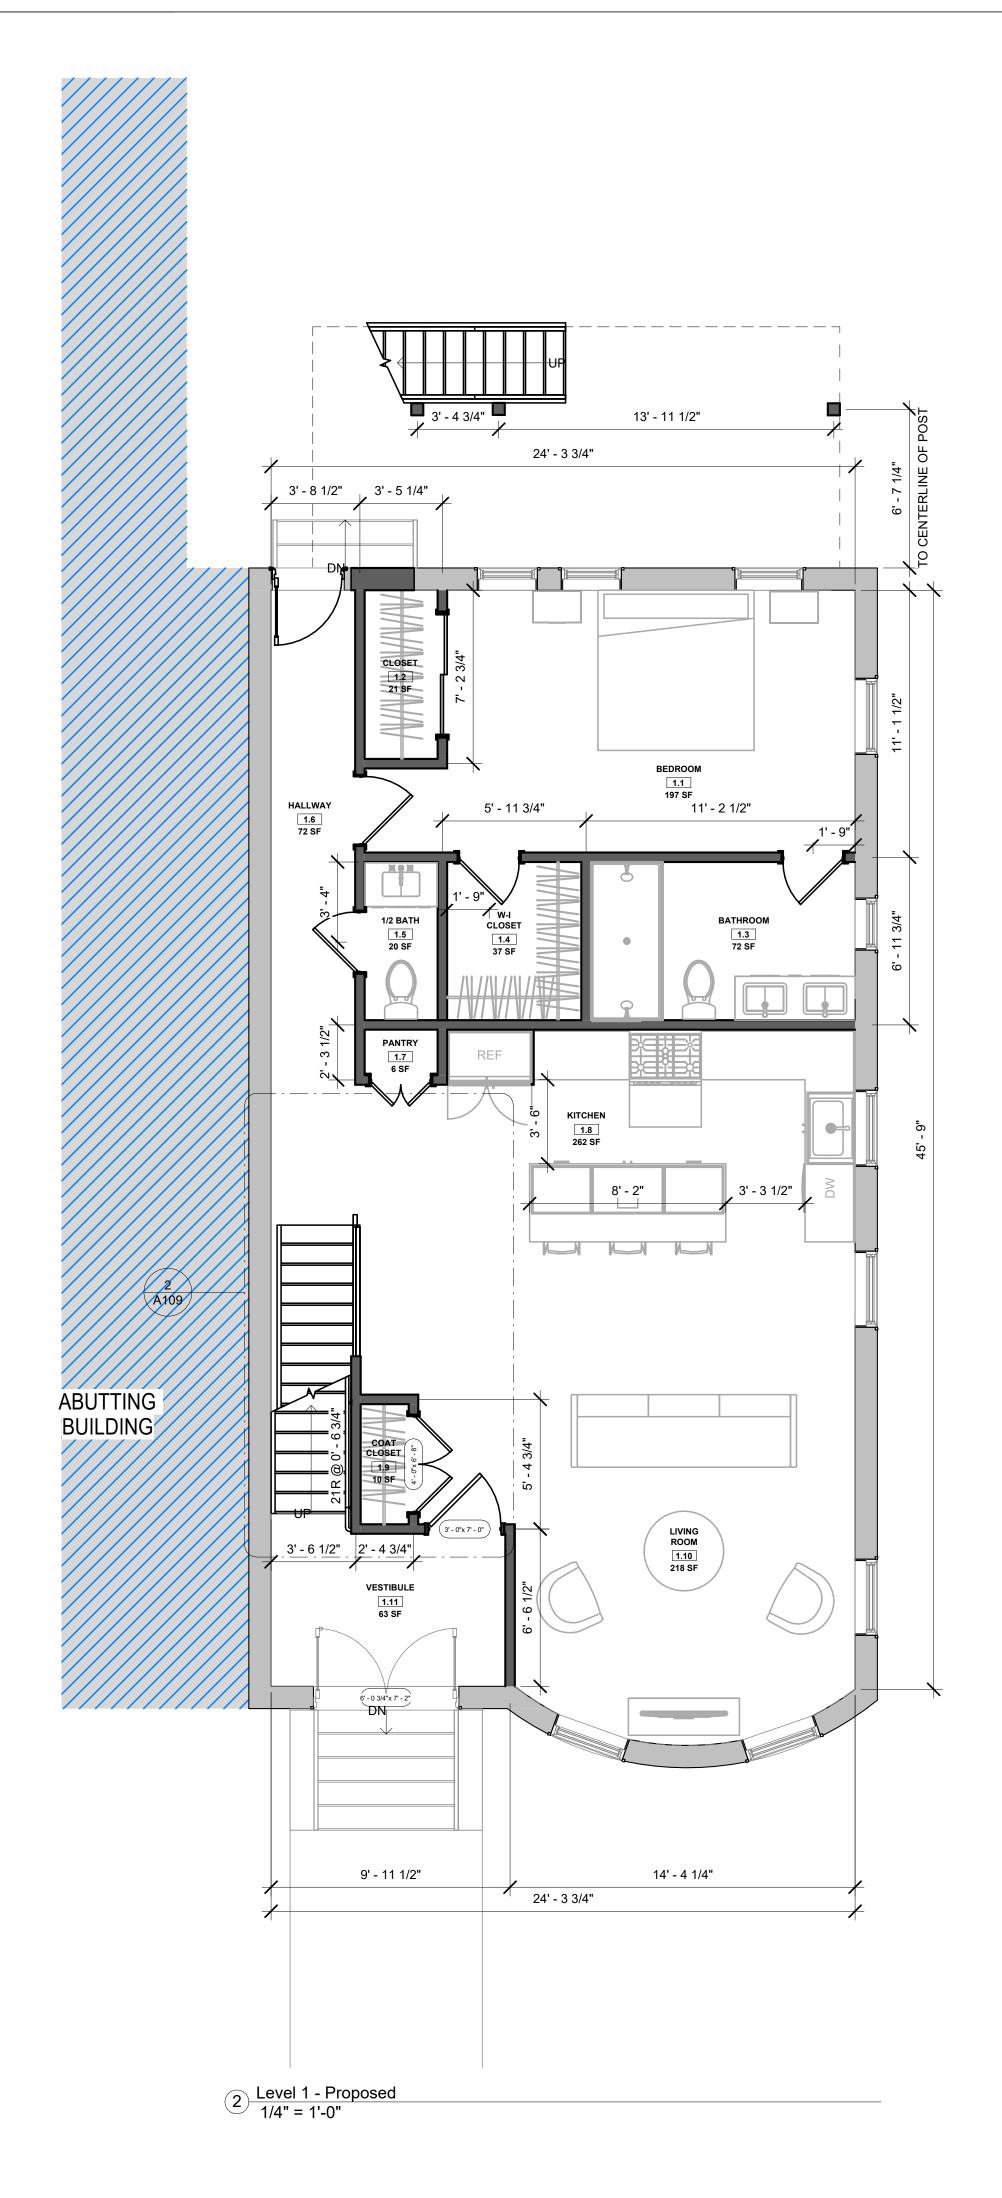

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- ALL DIMENSIONS ARE TO BE TAKEN FROM NUMERIC DESIGNATIONS ONLY; DIMENSIONS ARE NOT TO BE SCALED OFF THE DRAWINGS.
- ALL GYPSUM BOARD SURFACES ARE TO BE 5/8" THICK UNLESS OTHERWISE NOTED.
- ALL GYPSUM AND PLASTER FINISHES SHOULD BE SMOOTH, CONTINUOUS, FREE OF IMPERFECTIONS, AND HAVE NO VISIBLE JOINTS.
- PROVIDE GAS, WATER SPIGOT, OUTLET, AND LIGHTING AT ROOF DECKS.
- ALL CLOSETS SHALL HAVE SHELF AND POLE OR SHELVES AS REQUIRED, UNLESS OTHERWISE NOTED.
- ALL REQUIRED LIFE SAFETY DEVICES, INCLUDING SMOKE & CARBON MONOXIDE DETECTORS, SHALL BE INSTALLED BY THE CONTRACTOR IN COMPLIANCE WITH THE 2015 INTERNATIONAL BUILDING CODE

PLAN NOTES

- WALL DIMENSIONS ARE MEASURED FROM FACE OF EXIST. WALL TO C.L. OF NEW WALL, UNLESS OTHERWISE
- 2. ALL DOORS ARE 80" TALL UNLESS OTHERWISE NOTED.

MECHANICAL | SECURITY NOTES

- PROVIDE 5.1 AUDIO WIRING FOR LIVING ROOM AND MASTER BEDROOMS; FOR NUMBER AND LOCATION, SEE REFLECTED CEILING PLANS.
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- HOT WATER IS TO BE PROVIDED BY A HIGH EFFICIENCY NAVIEN MODULATING CONDENSING COMBINATION HEATING AND HOT WATER SYSTEM OR EQUAL.
- HARD WIRED SECURITY SYSTEM SHALL BE PROVIDED AT EACH UNIT; CONTACTS SHALL BE PLACED AT EXTERIOR DOORS AND WINDOWS WITH ONE MOTION DETECTOR

ELECTRICAL NOTES

- ELECTRICAL SERVICE POWER IS TO BE EVALUATED FOR MEETING LIGHTING DESIGN AND EQUIPMENT REQUIREMENTS. PROPER POWER LEVEL SHALL BE PROVIDED.
- ALL NEW ELECTRICAL ITEMS ARE TO BE U.L. RATED.
- ALL ELECTRICAL PANELS ARE TO BE RECESSED INTO A WALL WITH A MINIMUM 6" STUD DIMENSION. REVIEW FINAL LOCATION WITH ARCHITECT AND OWNER.
- ALL DISTRIBUTION PANELS ARE TO BE NEW.
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OUTLETS IN BATHROOMS SHALL HAVE GROUND FAULT

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 - VERTICALLY ALIGN SWITCHES AND OUTLETS WHERE POSSIBLE.

DEMO/PROPOSED PLAN GRAPHIC KEY



- EXISTING WALL TO REMAIN



- AREA NOT IN CONTRACT



- DEMOLISHED BUILDING ELEMENT

- DEMOLISHED FLOOR FINISH/CEILING



TRIPLE DASHED RED LINE INDICATES REQUIRED (1) HOUR FIRE RESISTANCE RATED SEPARATION, UL NO. U314 AT WALLS AND UL NO. L501 AT CEILING



Design Resource Team, LLC 546 East Broadway Boston, MA 02127 617.804.6117 info@drt.boston www.drt.boston



Description

8-9 MONUMENT SQ LLC

8 MONUMENT SQ

LEVEL 1 -DEMO/PROPOSED

221062A Project number 3/23/2023 Drawn by A101



- WHEN SPECIFIC FEATURES OF CONSTRUCTION ARE NOT FULLY SHOWN ON THE DRAWINGS OR CALLED FOR IN THE GENERAL NOTES, THEIR CONSTRUCTION SHALL BE OF THE SAME CHARACTER AS SIMILAR CONDITIONS.
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MECHANICAL | SECURITY NOTES


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DEMO/PROPOSED PLAN GRAPHIC KEY



- EXISTING WALL TO REMAIN



- AREA NOT IN CONTRACT

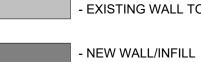

- DEMOLISHED BUILDING ELEMENT



- DEMOLISHED FLOOR FINISH/CEILING

TRIPLE DASHED RED LINE INDICATES REQUIRED (1) HOUR FIRE RESISTANCE RATED SEPARATION, UL NO. U314 AT WALLS AND UL NO. L501 AT CEILING



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Description


8-9 MONUMENT SQ LLC


8 MONUMENT SQ

LEVEL 2 -DEMO/PROPOSED

221062A Project number 3/23/2023 Author Drawn by Checker Checked by

A102

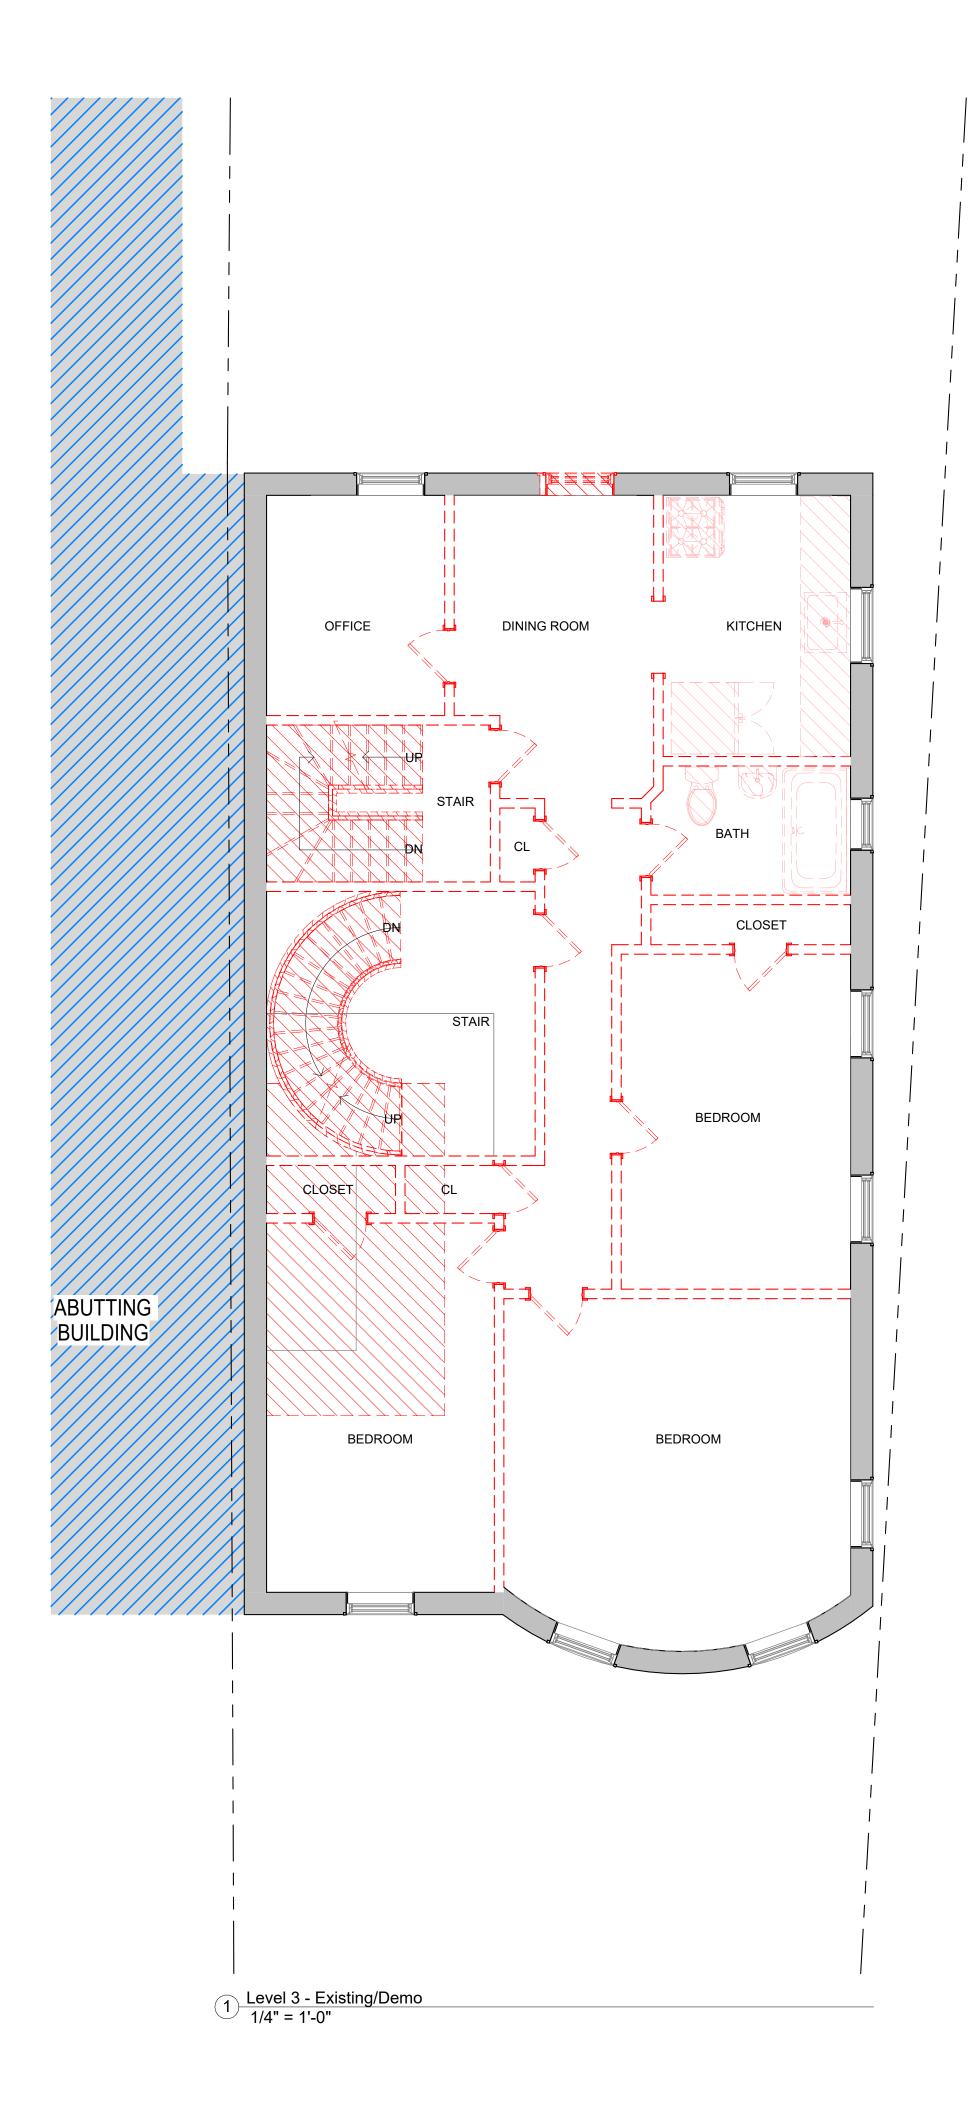

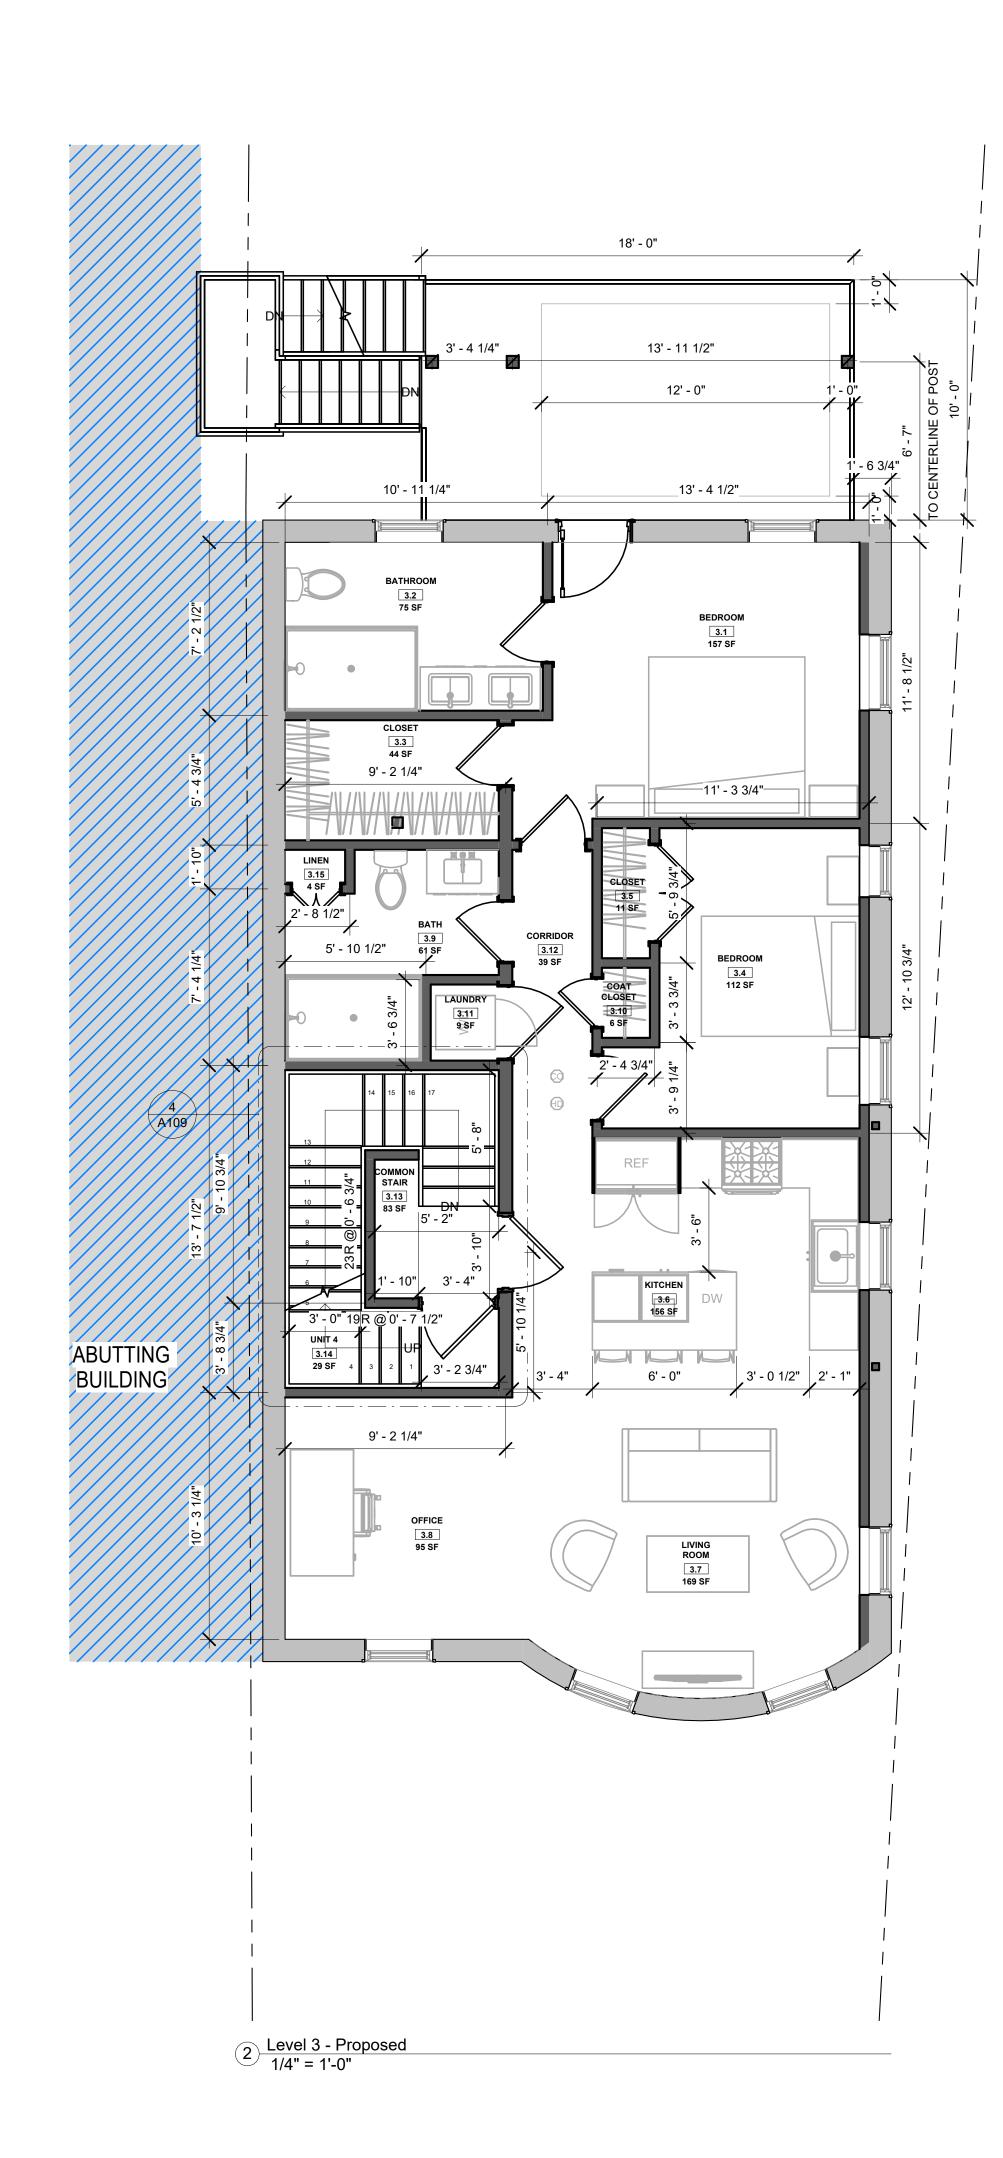

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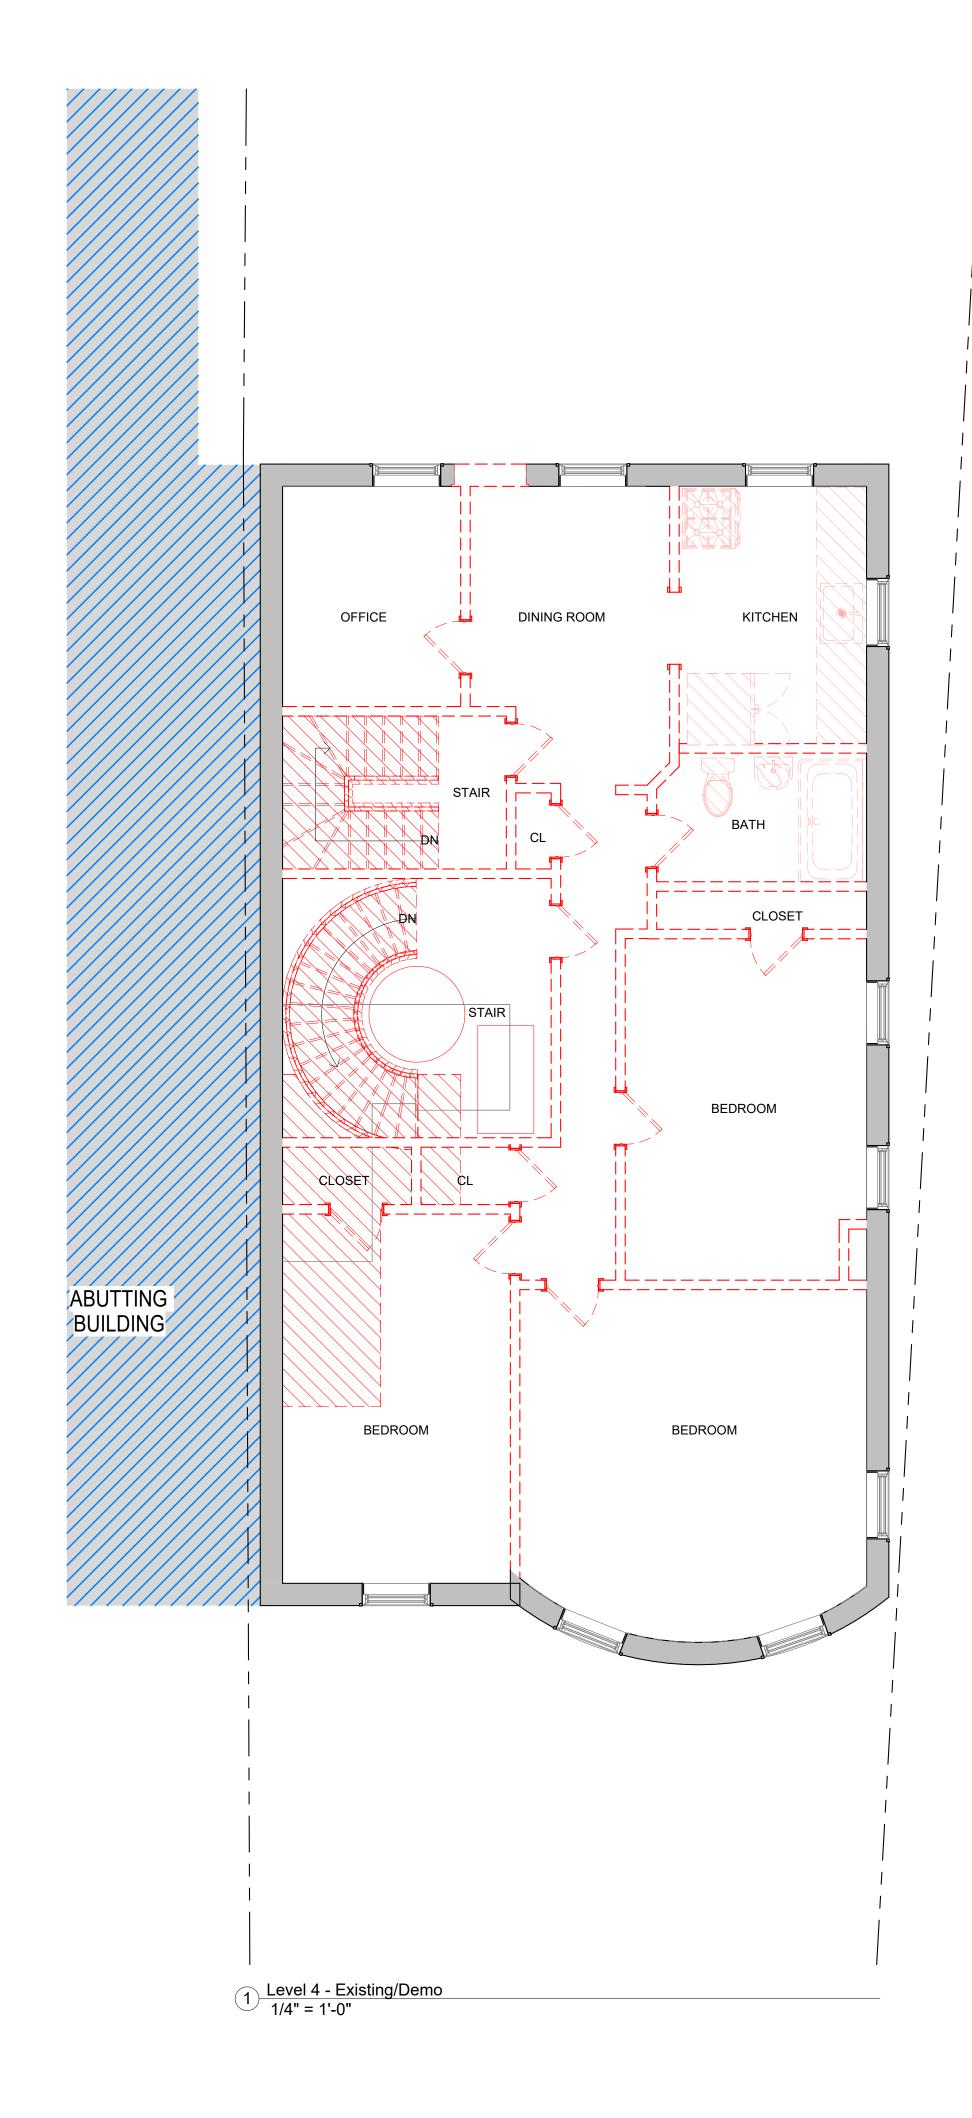
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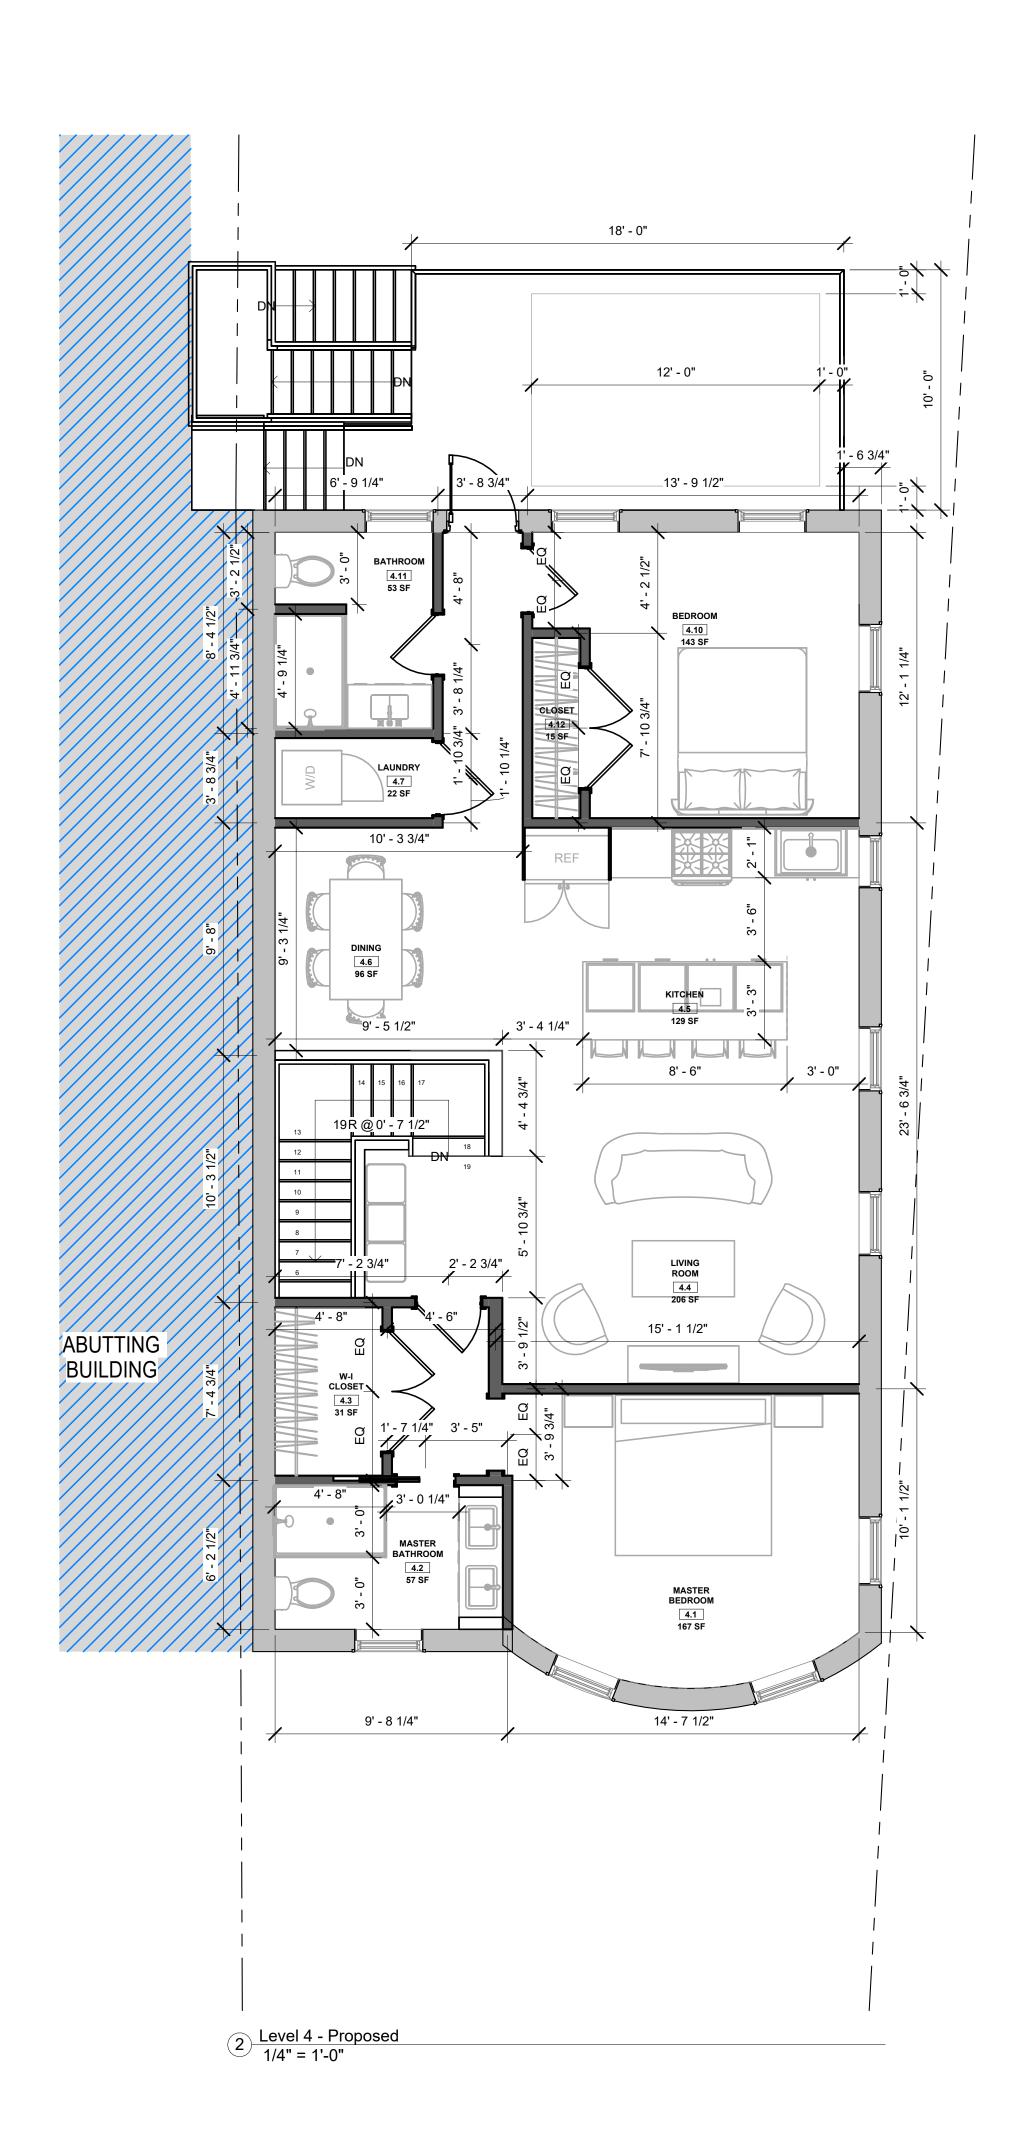
8-9 MONUMENT SQ LLC

8 MONUMENT SQ

LEVEL 3 -DEMO/PROPOSED

221062A Project number 3/23/2023 Drawn by Checked by A103





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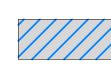
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DEMO/PROPOSED PLAN GRAPHIC KEY



- EXISTING WALL TO REMAIN



- AREA NOT IN CONTRACT



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TRIPLE DASHED RED LINE INDICATES REQUIRED (1) HOUR FIRE RESISTANCE RATED SEPARATION, UL NO. U314 AT WALLS AND UL NO. L501 AT CEILING



Design Resource Team, LLC 546 East Broadway Boston, MA 02127 617.804.6117 info@drt.boston www.drt.boston



Description


8-9 MONUMENT SQ LLC

8 MONUMENT SQ

LEVEL 4 -DEMO/PROPOSED

221062A Project number 3/23/2023 Drawn by Checked by

A104

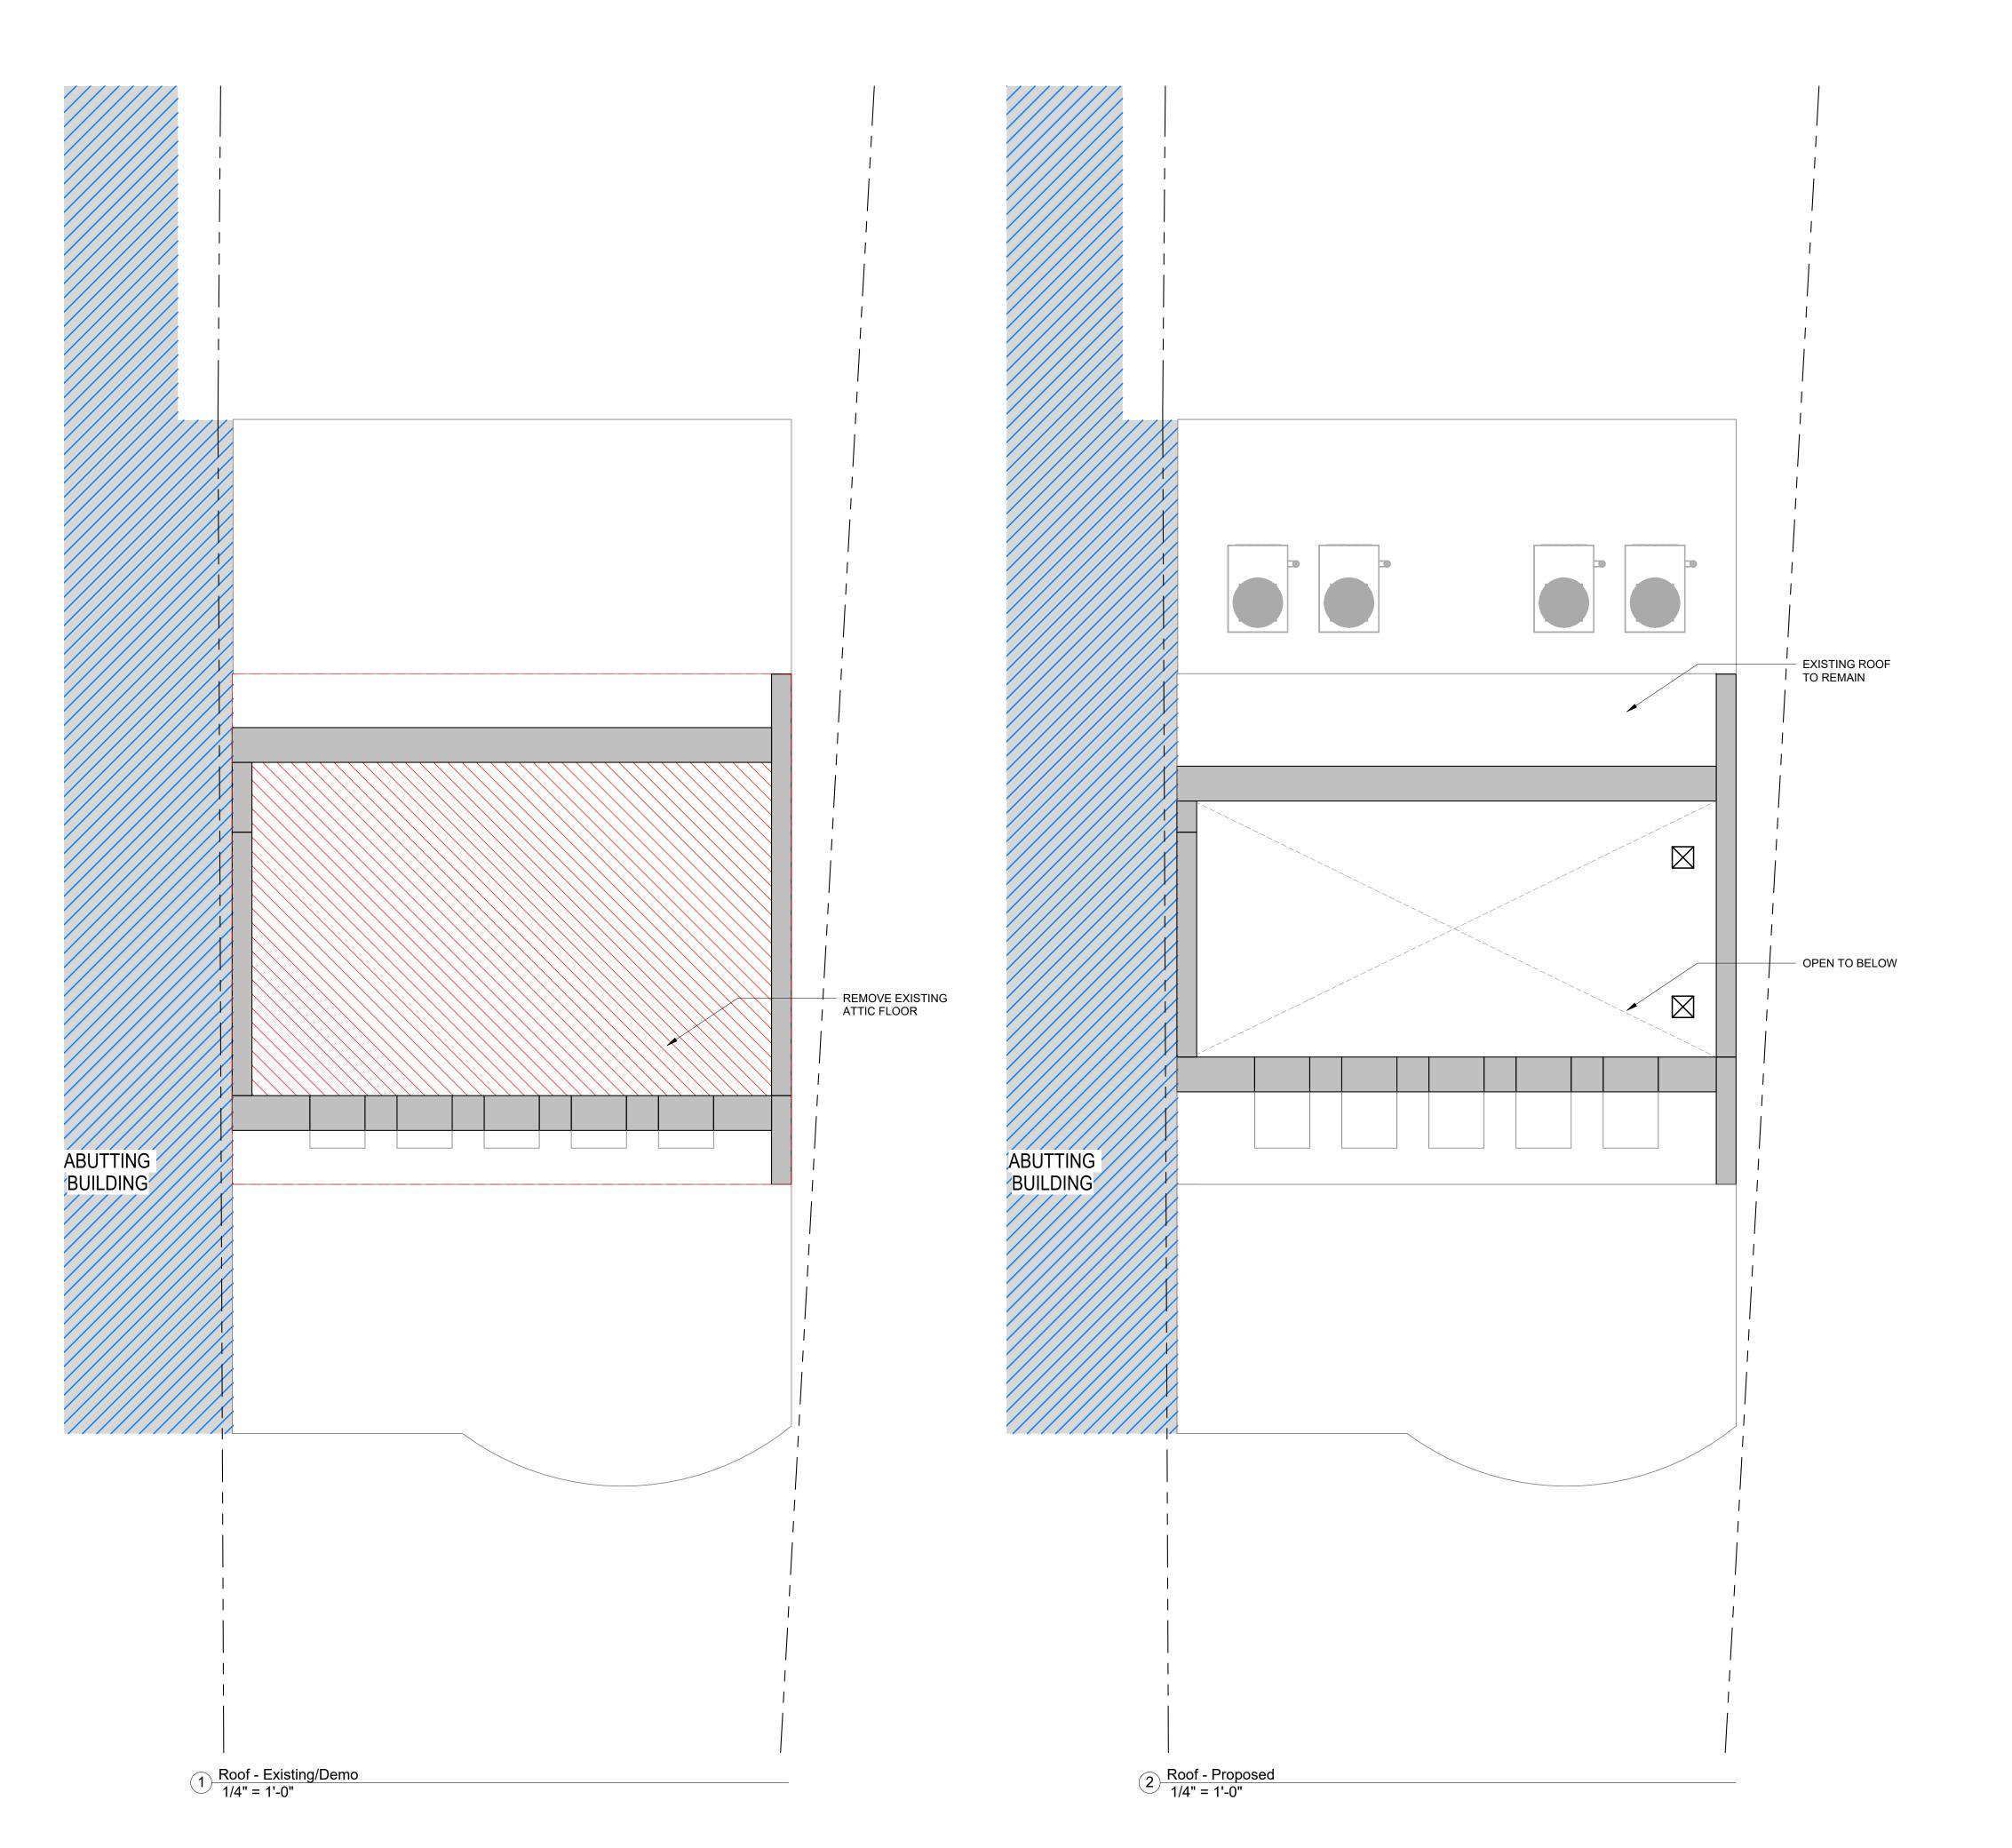

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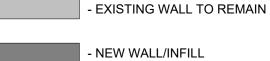
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Description

8-9 MONUMENT SQ LLC

8 MONUMENT SQ

ROOF - DEMO/PROPOSED


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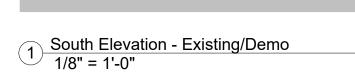
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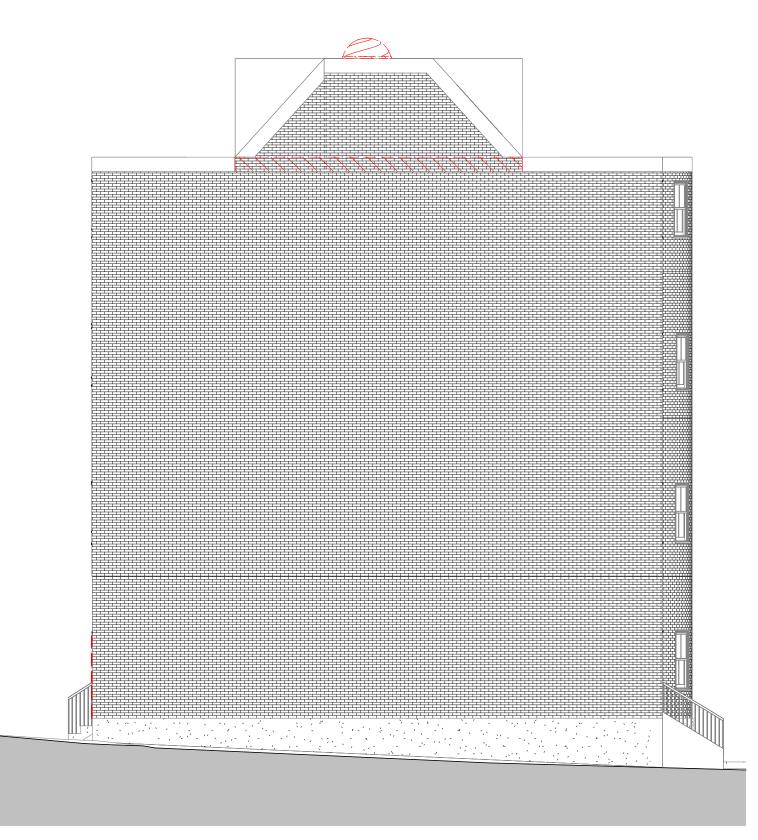
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FINISH GRADE NOTE:


ALL GRADING SHOWN ON THE ELEVATIONS SHALL BY NO MEANS BE ASSUMED AS THE ACTUAL GRADING CONDITIONS AROUND THE BUILDING. REFER TO SITE PLAN PREPARED BY OTHERS FOR FINAL GRADING.






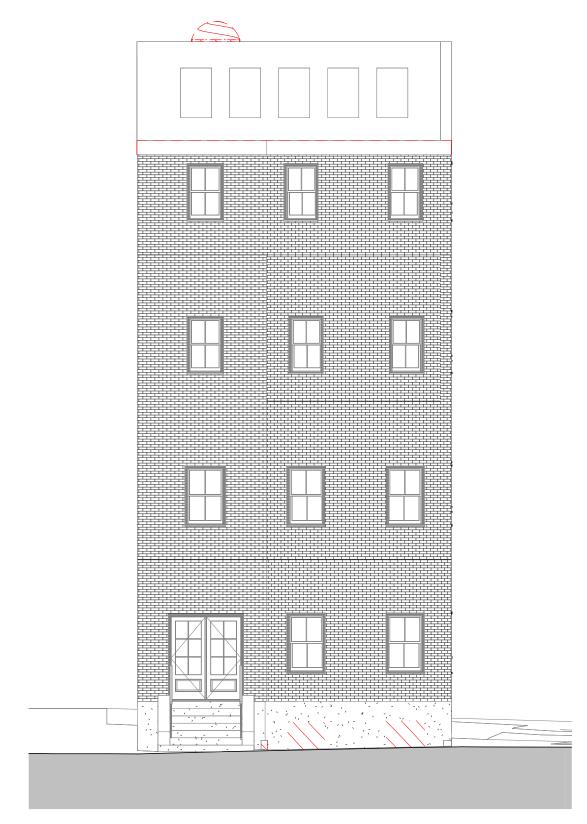

3 West Elevation - Existing/Demo 1/8" = 1'-0"

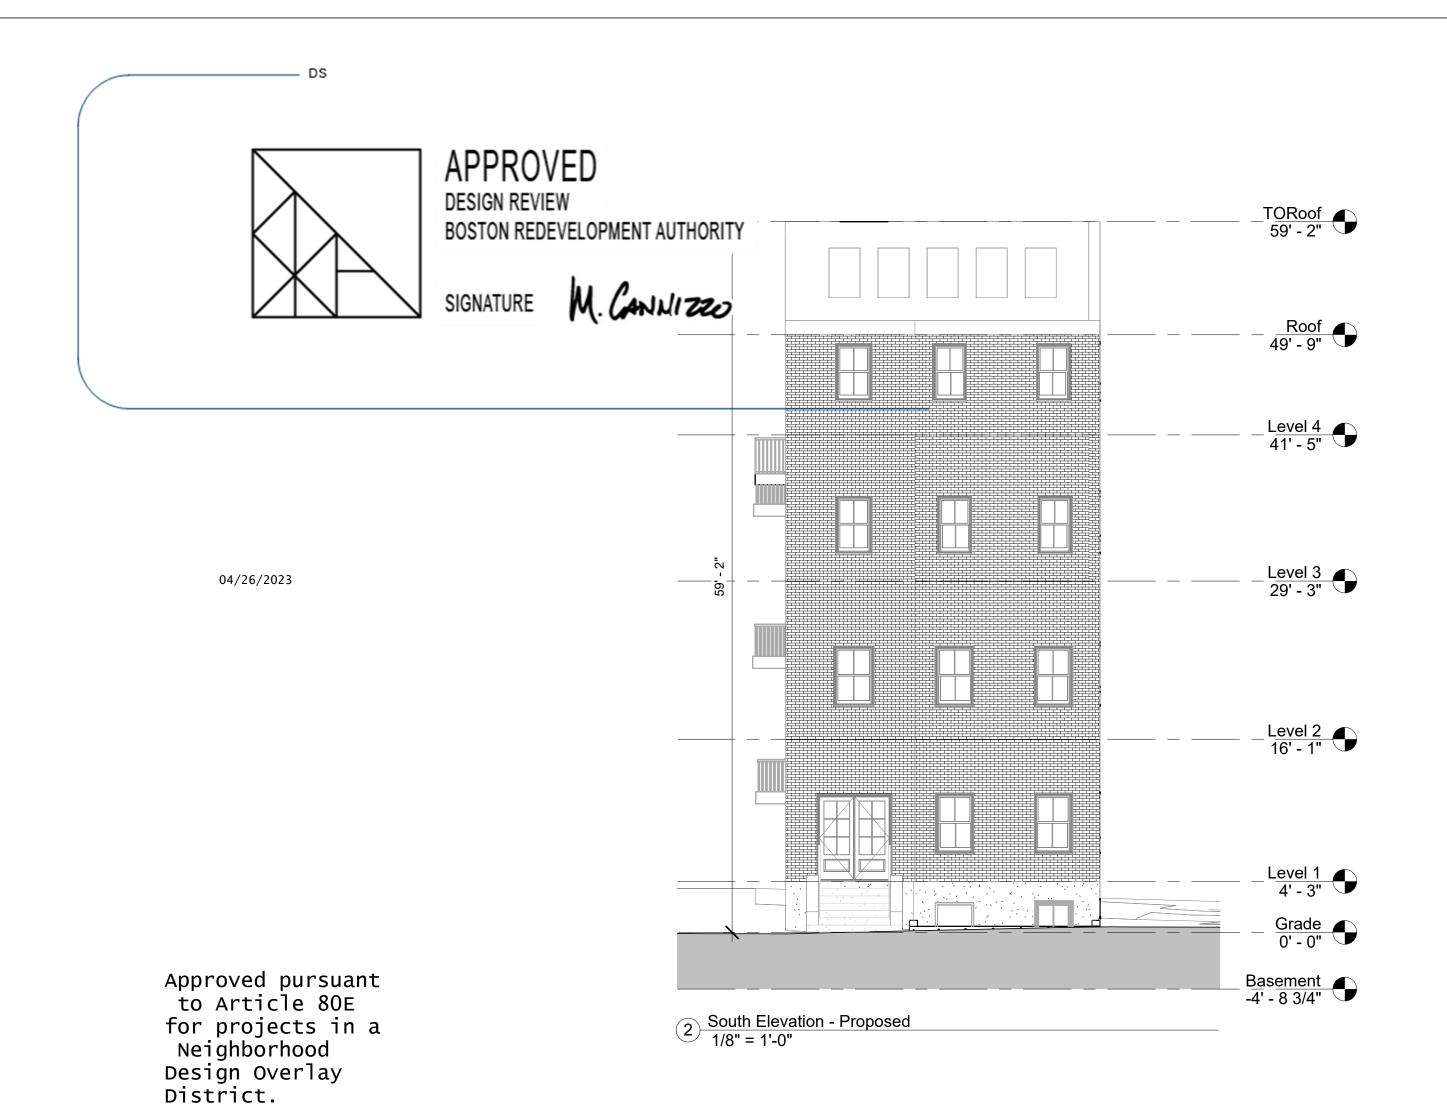

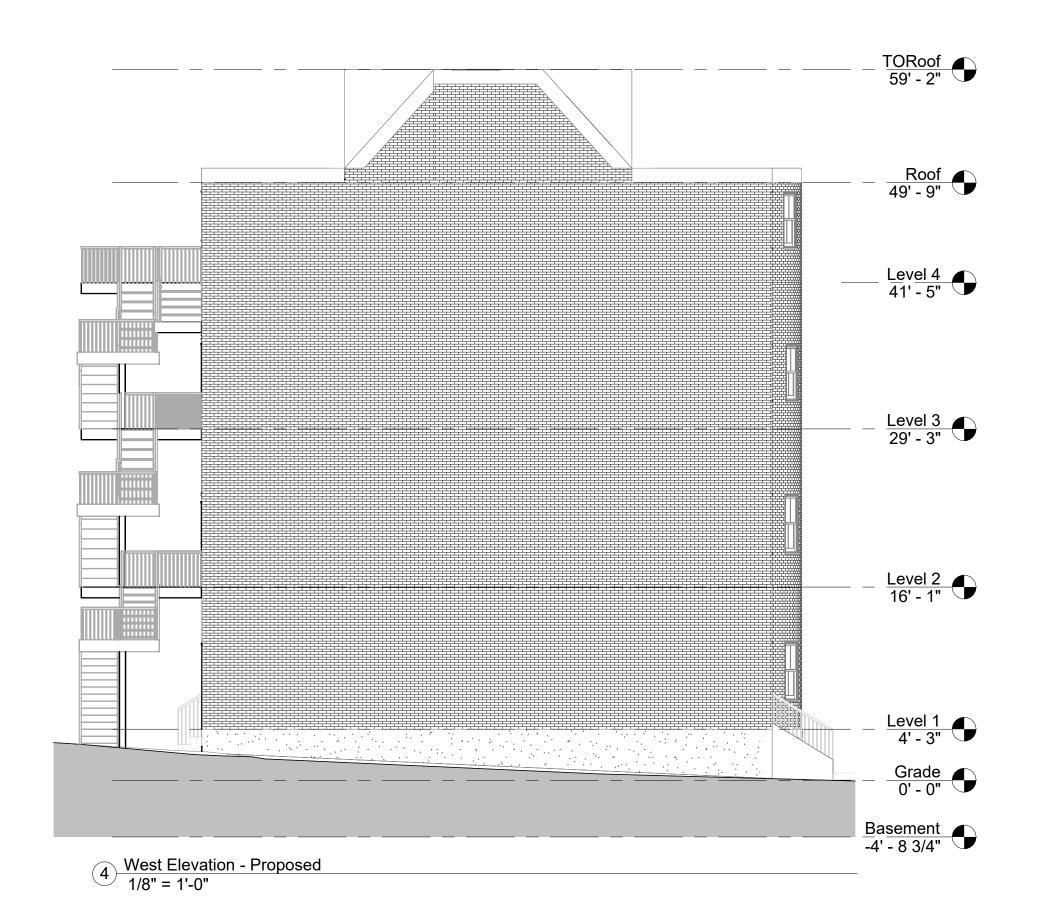



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о.	Description	Date
		-
8-9	MONUMENT SC	LLC

Project number 221062A

Date 3/23/2023

Drawn by NC

Checked by NPL

A200

Scale 1/8" = 1'-0"


8 MONUMENT SQ


ELEVATIONS -


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North Elevation - Existing/Demo
1/8" = 1'-0"



Approved pursuant to Article 80E for projects in a Neighborhood Design Overlay District.

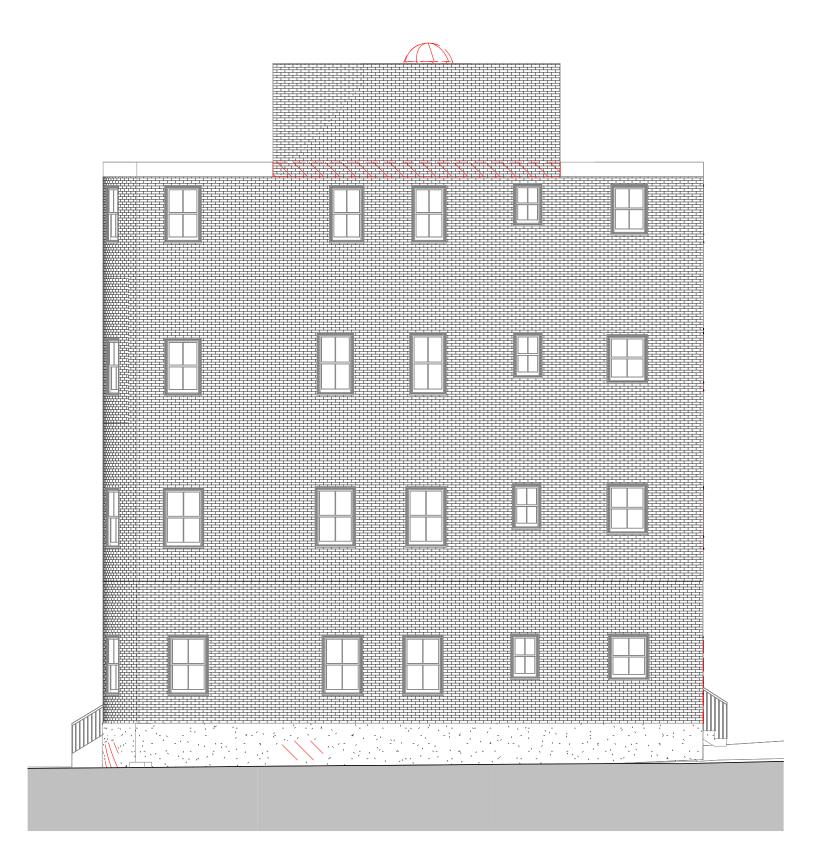

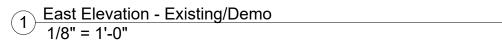
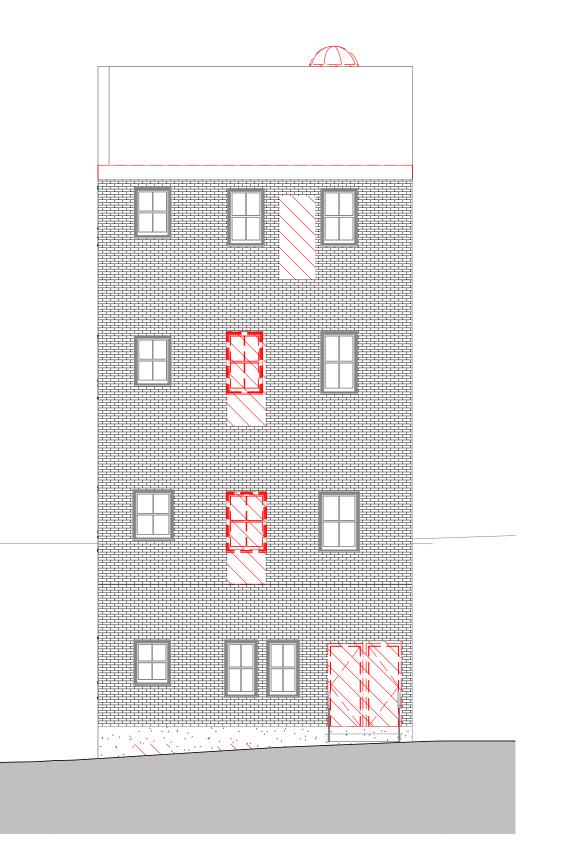
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No.	Description	Date	
8	8-9 MONUMENT SQ LLC		

 Project number
 221062A

 Date
 3/23/2023

 Drawn by
 NC


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 NPL


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 Scale

8 MONUMENT SQ

ELEVATIONS -

DEMO/PROPOSED

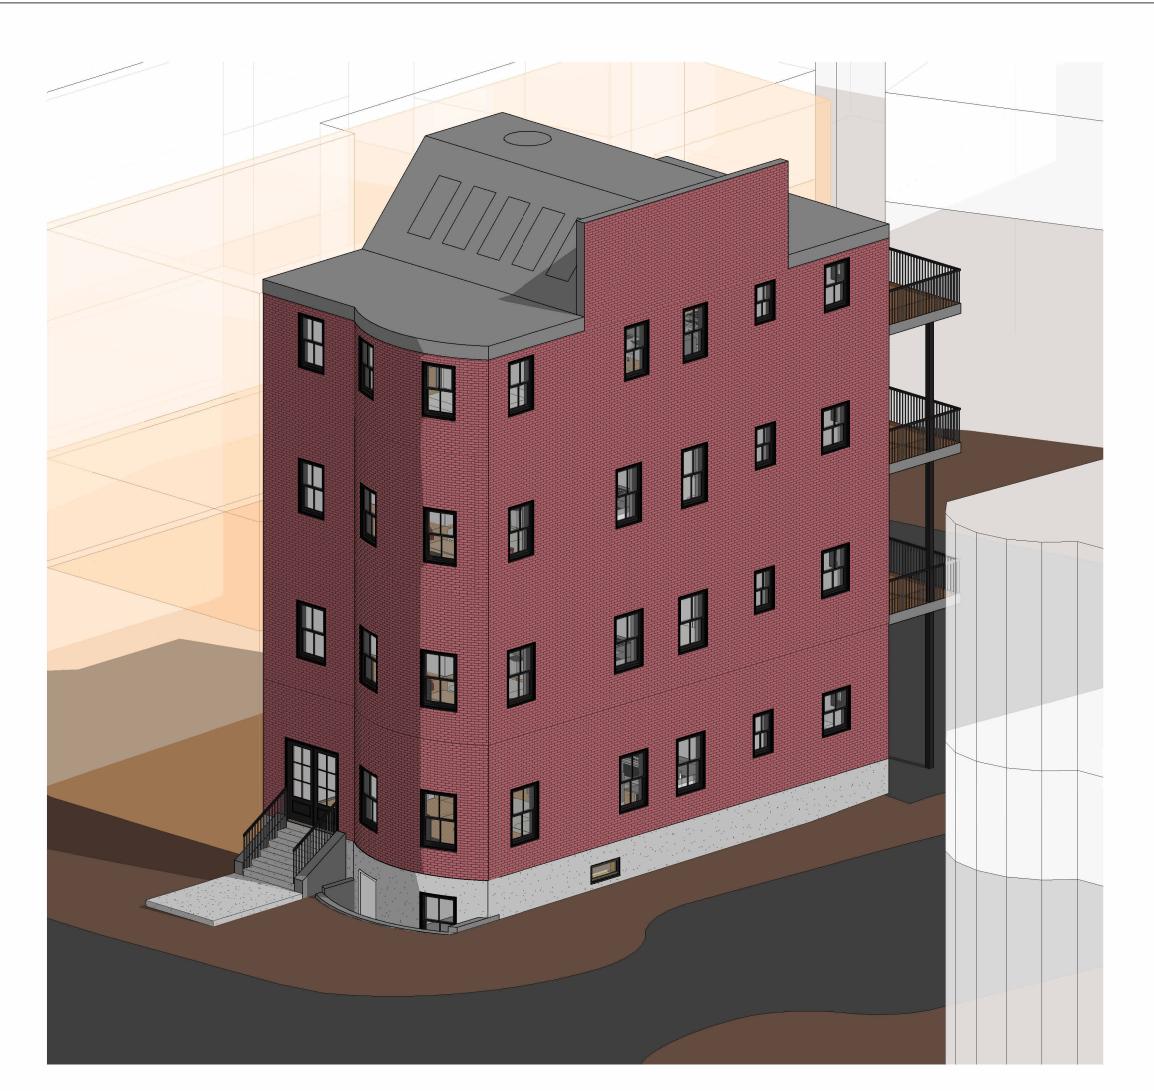

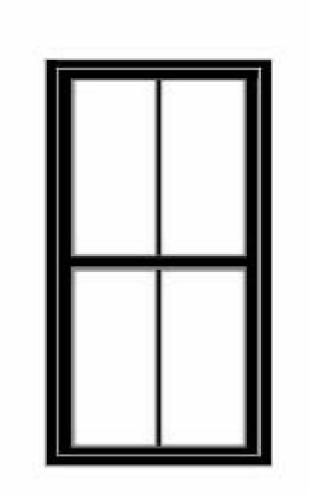


design | resource | team

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PELLA LIFESTYLE CLAD WINDOWS - BLACK EXTERIOR



TREX SELECT COMPOSITE DECKING
- WOODLAND BROWN

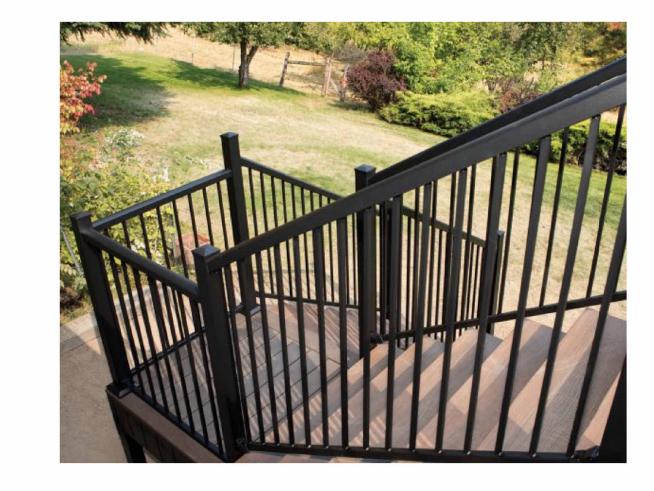

AL 13 ALUMINUM RAILING - BLACK

West Elevation - Proposed.


1/8" = 1'-0"


BROSCO FIBERGLASS DOORS -BLACK

6 x 6 PRESSURE TREATED WOOD WRAPPED WITH PVC - BLACK

1 3D VIEW - Front.



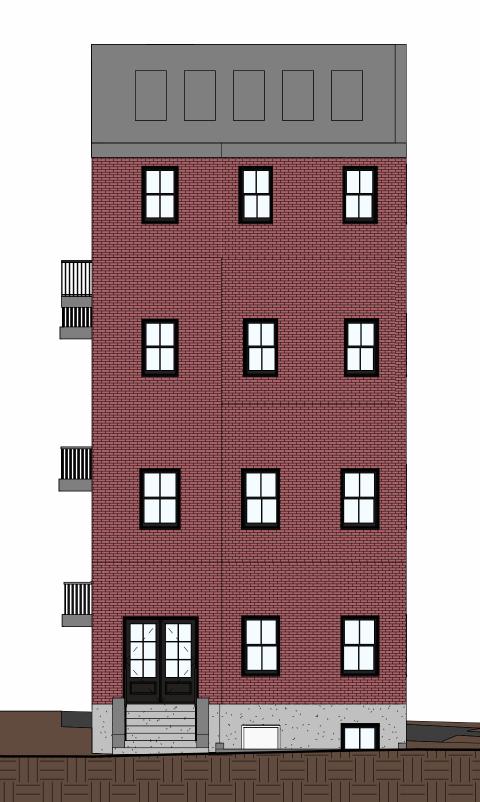

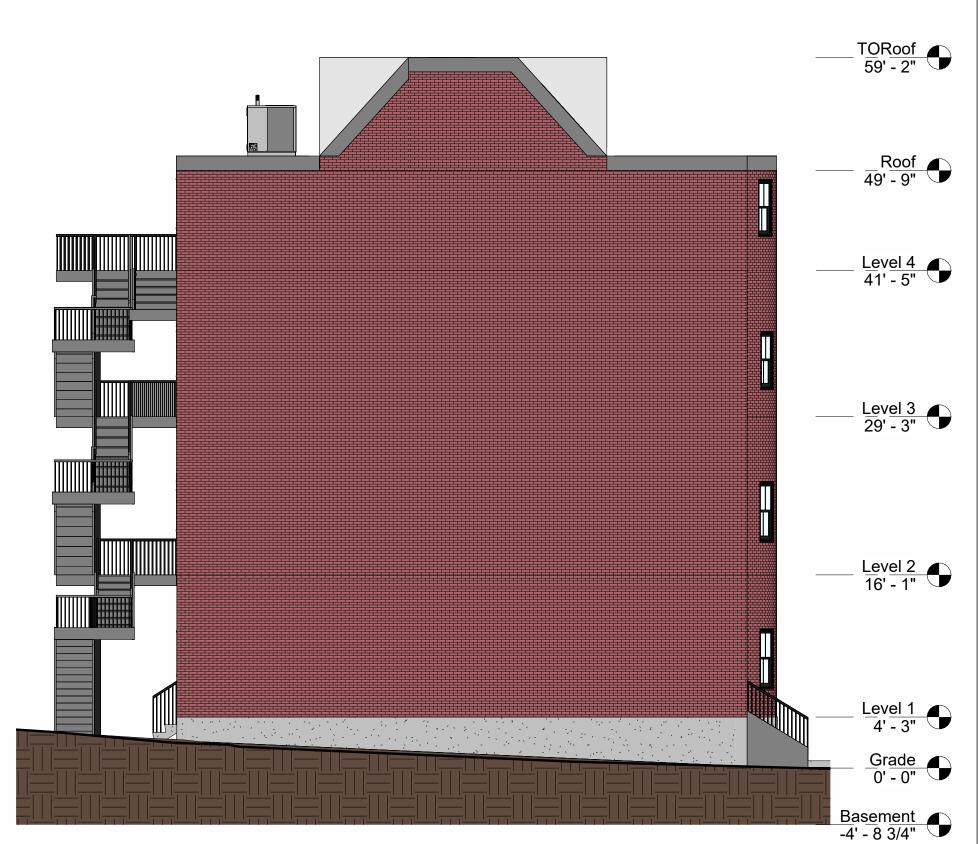

Scale

8-9 MONUMENT SQ LLC

Description

8 MONUMENT SQ **EXTERIOR FINISHES**

221062A Project number 3/23/2023 Drawn by NPL Checked by A202 1/8" = 1'-0"

2 East Elevation - Proposed. 1/8" = 1'-0" APPROVED Design Section
BOSTON REDEVELOPMENT AUTHORITY Design Review M. CANUTZO for the Board of Appeal Signature

North Elevation- Proposed.

1/8" = 1'-0"

04/25/2023

South Elevation - Proposed.

1/8" = 1'-0"

Approved pursuant to Article 80E for projects in a Neighborhood Design Overlay District. Consider screening HVAV units, especially if street trees on Chestnut St. are removed.

Date

ENERGY CODE REQUIREMENTS (IECC 2018 EDITION)

TABLE R402.1.2 INSULATION AND FENESTRATION REQUIREMENTS BY COMPONENT (a)

ZONE	FENESTRATI ON U-FACTOR (b)	,	GLAZED FENESTRATIO N SHGC (b, e)	CEILING R-VALUE	WOOD FRAME WALL R-VALUE	MASS WALL R-VALUE (i)	FLOOR R-VALUE	BASEMENT (c) WALL R-VALUE	SLAB (d) R-VALUE & DEPTH	CRAWL SPACE (c) WALL R-VALUE
5 and Marine 4	0.30	0.55	NR	49	20 or 13+5(h)	13/17	30(g)	15/19	10, 2 ft	15/19

NR - Not Required; For SI: 1 foot = 304.8 mm.

a. R-values are minimums. U-factors and SHGC are maximums. When insulation is installed in a cavity which is less than the label or design thickness of the insulation, the installed R-value of the insulation shall not be less than the R-value specified in the table.

b. The fenestration U-factor column excludes skylights. The SHGC column applies to all glazed fenestration. Exception: Skylights may be excluded from glazed fenestration SHGC requirements in climate zones 1 through 3 where the SHGC for such skylights does not exceed 0.30.

c. "15/19" means R-15 continuous insulation on the interior or exterior of the home or R-19 cavity insulation at the interior of the basement wall. "15/19" shall be permitted to be met with R-13 cavity insulation on the interior of the basement wall plus R-5 continuous insulation on the interior or exterior of the home. "10/13" means R-10 continuous insulation on the interior or exterior of the home or R-13 cavity insulation at the interior of the basement wall.

d. R-5 shall be added to the required slab edge R-values for heated slabs. Insulation depth shall be the depth of the footing or 2 feet, whichever is less in Climate Zones 1 through 3 for heated slabs.

e. There are no SHGC requirements in the Marine Zone.

f. Basement wall insulation is not required in warm-humid locations as defined by Figure R301.1 and Table R301.1.

g. Or insulation sufficient to fill the framing cavity, R-19 minimum.

h. The first value is cavity insulation, the second value is continuous insulation, so "13+5" means R-13 cavity insulation plus R-5 continuous insulation.

i. The second R-value applies when more than half the insulation is on the interior of the mass wall.

INSULATION NOTES - Section 1

1. PRESCRIPTIVE CONFORMANCE TO IECC SECTION 402 SELECTED FOR COMPLIANCE WITH IRC CHAPTER 11 N1101.2

2. MINIMUM WINDOW PERFORMANCE: U-0.30 OR BETTER

3. MINIMUM SKYLIGHT PERFORMANCE: U-0.55 OR BETTER


4. ROOF AND CEILING INSULATION: PERFORMANCE R-49 OR BETTER. EXTEND FULL DEPTH INSULATION TO EXTERIOR WALL SHEATHING TO ELIMINATE COLD CORNERS AND PREVENT ICE DAM FORMATIONS

5. WOOD FRAME EXTERIOR WALLS: HIGH PERFORMANCE R-21 WALL INSULATION IN 2x6 WD STUD WALLS OR FLASH AND BATT WITH SPRAY FOAM AND FIBERGLAS ATT INSULATION TO MEETMINIMUM REQUIREMENT IN TABLE 402.1.1

6. MASS WALLS: R-17 MINIMUM PERFORMANCE IF INSTALLED INSIDE OF WALL CENTERLINE, R-13 MINIMUM IF INSTALLED ON THE OUTSIDE AS MEASURED FROM THE WALL CENTERLINE

7. FLOOR INSULATION: R-30 INSULATION BETWEEN JOISTS. INSULATION MUST BE INSTALLED FOR PERMANENT DIRECT CONTACT BETWEEN SUB-FLOOR AND INSULATION. INSTALLATIONS THAT ALLOW FUTURE SAGGING OF INSULATION AWAY FROM FLOOR DECK NOT PERMITTED

8. FOUNDATION AND SLAB INSULATION AT BASEMENT: R-30 INSULATION UNDER SLAB

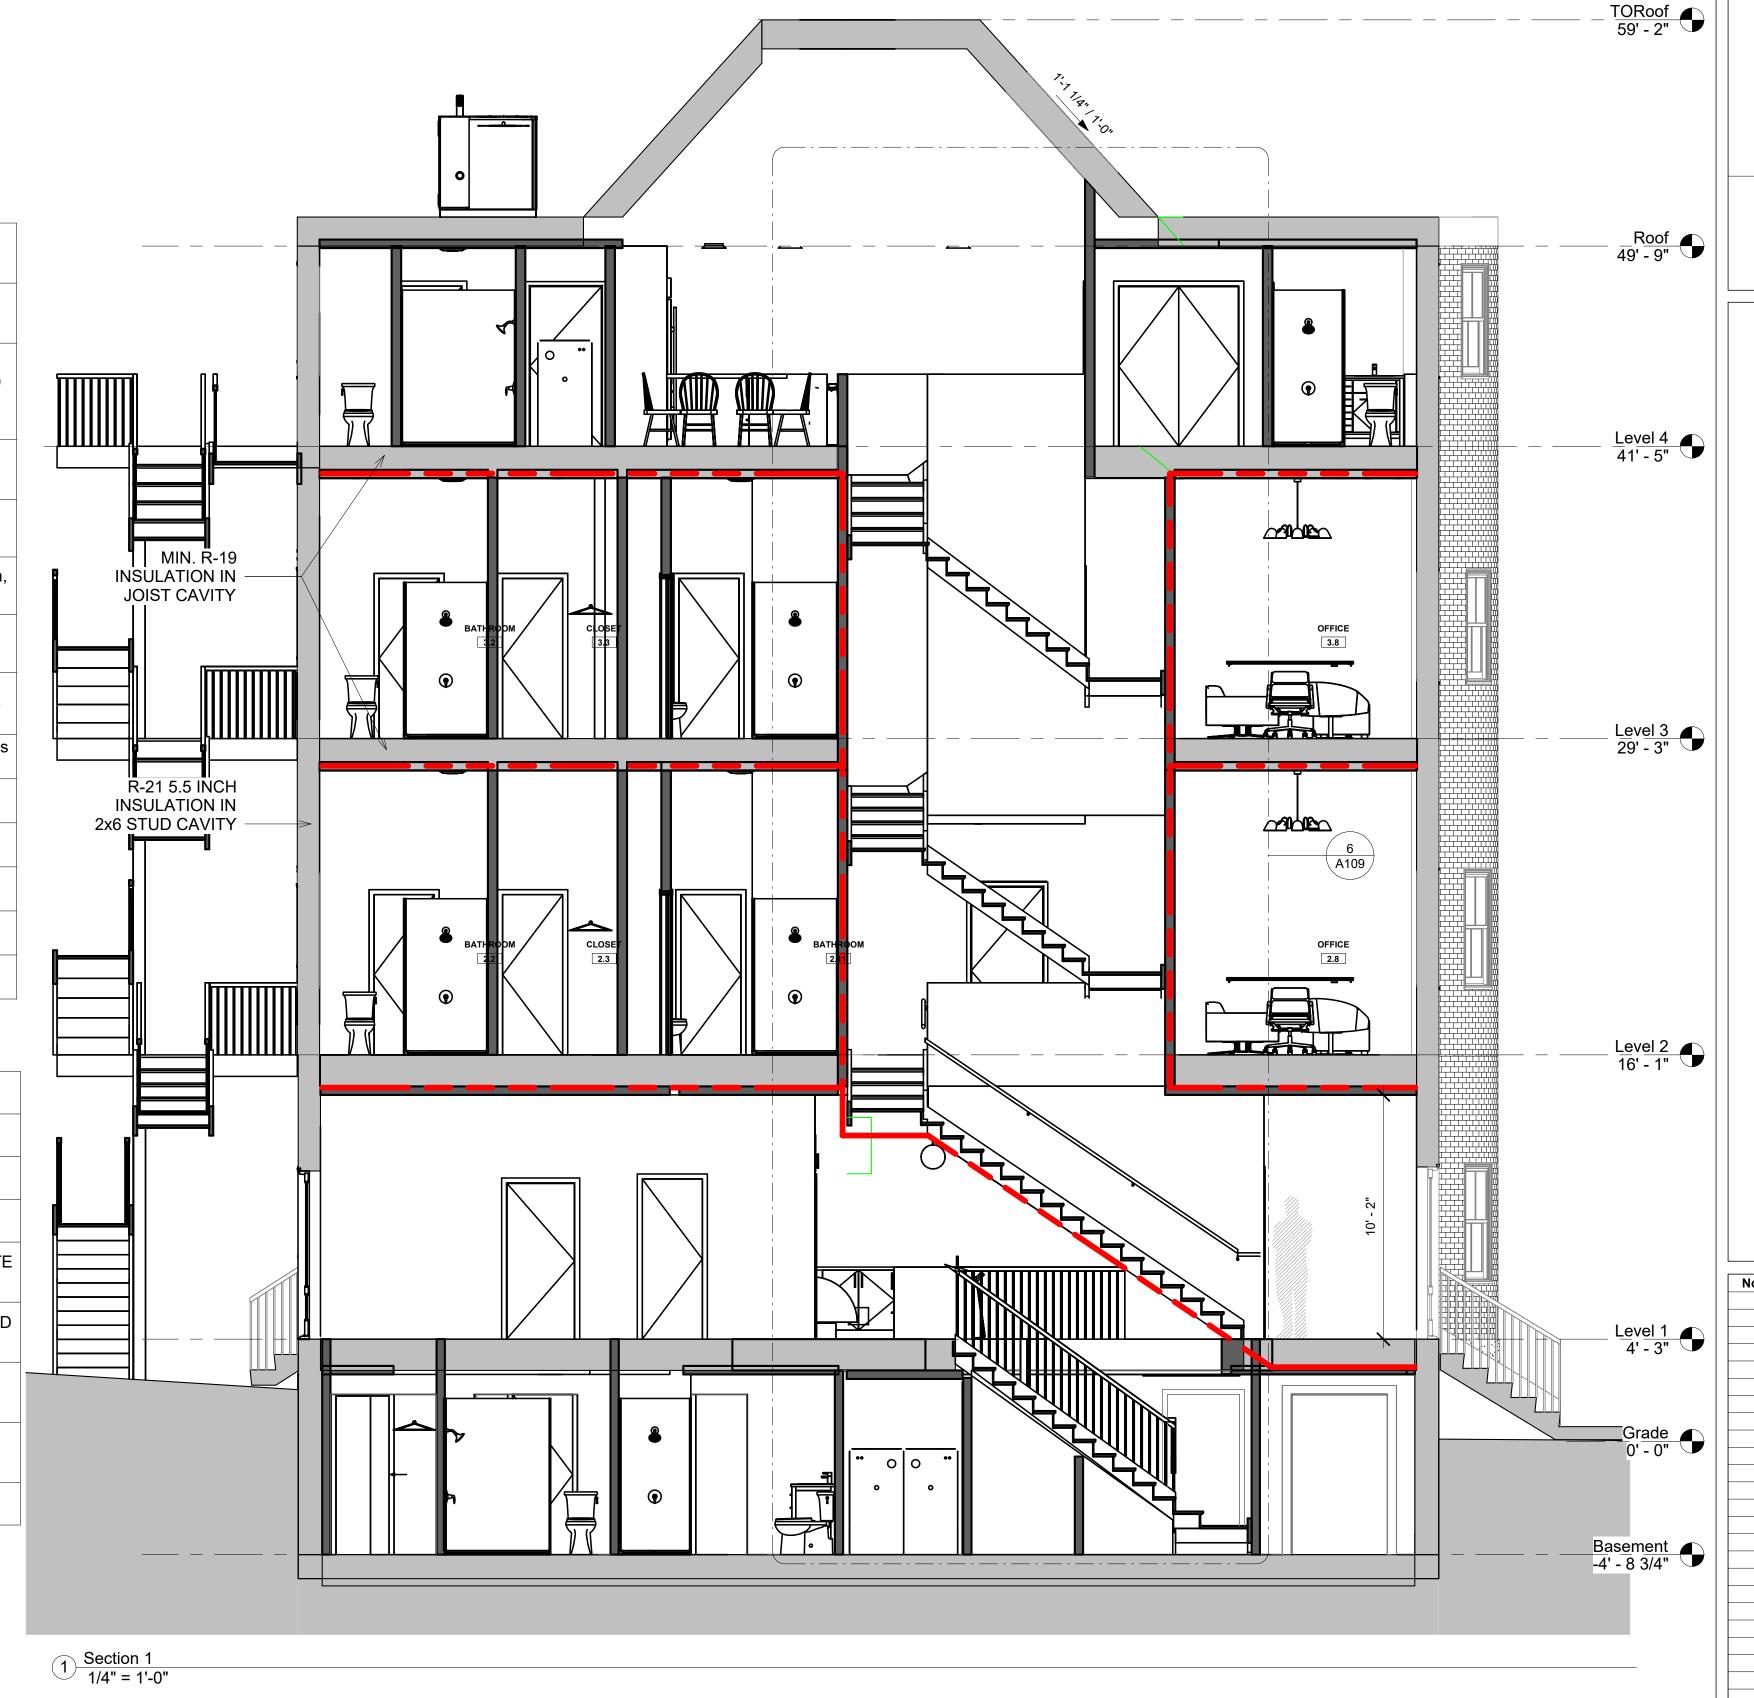

DEMO/PROPOSED PLAN GRAPHIC KEY

- EXISTING WALL TO REMAIN - NEW WALL/INFILL

- AREA NOT IN CONTRACT - DEMOLISHED BUILDING ELEMENT

- DEMOLISHED FLOOR FINISH/CEILING

TRIPLE DASHED RED LINE INDICATES REQUIRED (1) HOUR FIRE RESISTANCE RATED SEPARATION, UL NO. U314 AT WALLS AND UL NO. L501 AT CEILING 8-9 MONUMENT SQ LLC 8 MONUMENT SQ

No. 51043 BOSTON,

Description

design | resource | team

Design Resource Team, LLC 546 East Broadway Boston, MA 02127

617.804.6117 info@drt.boston www.drt.boston

221062A Project number 3/23/2023

BUILDING SECTIONS


Checked by

Drawn by

Scale

A300

NPL

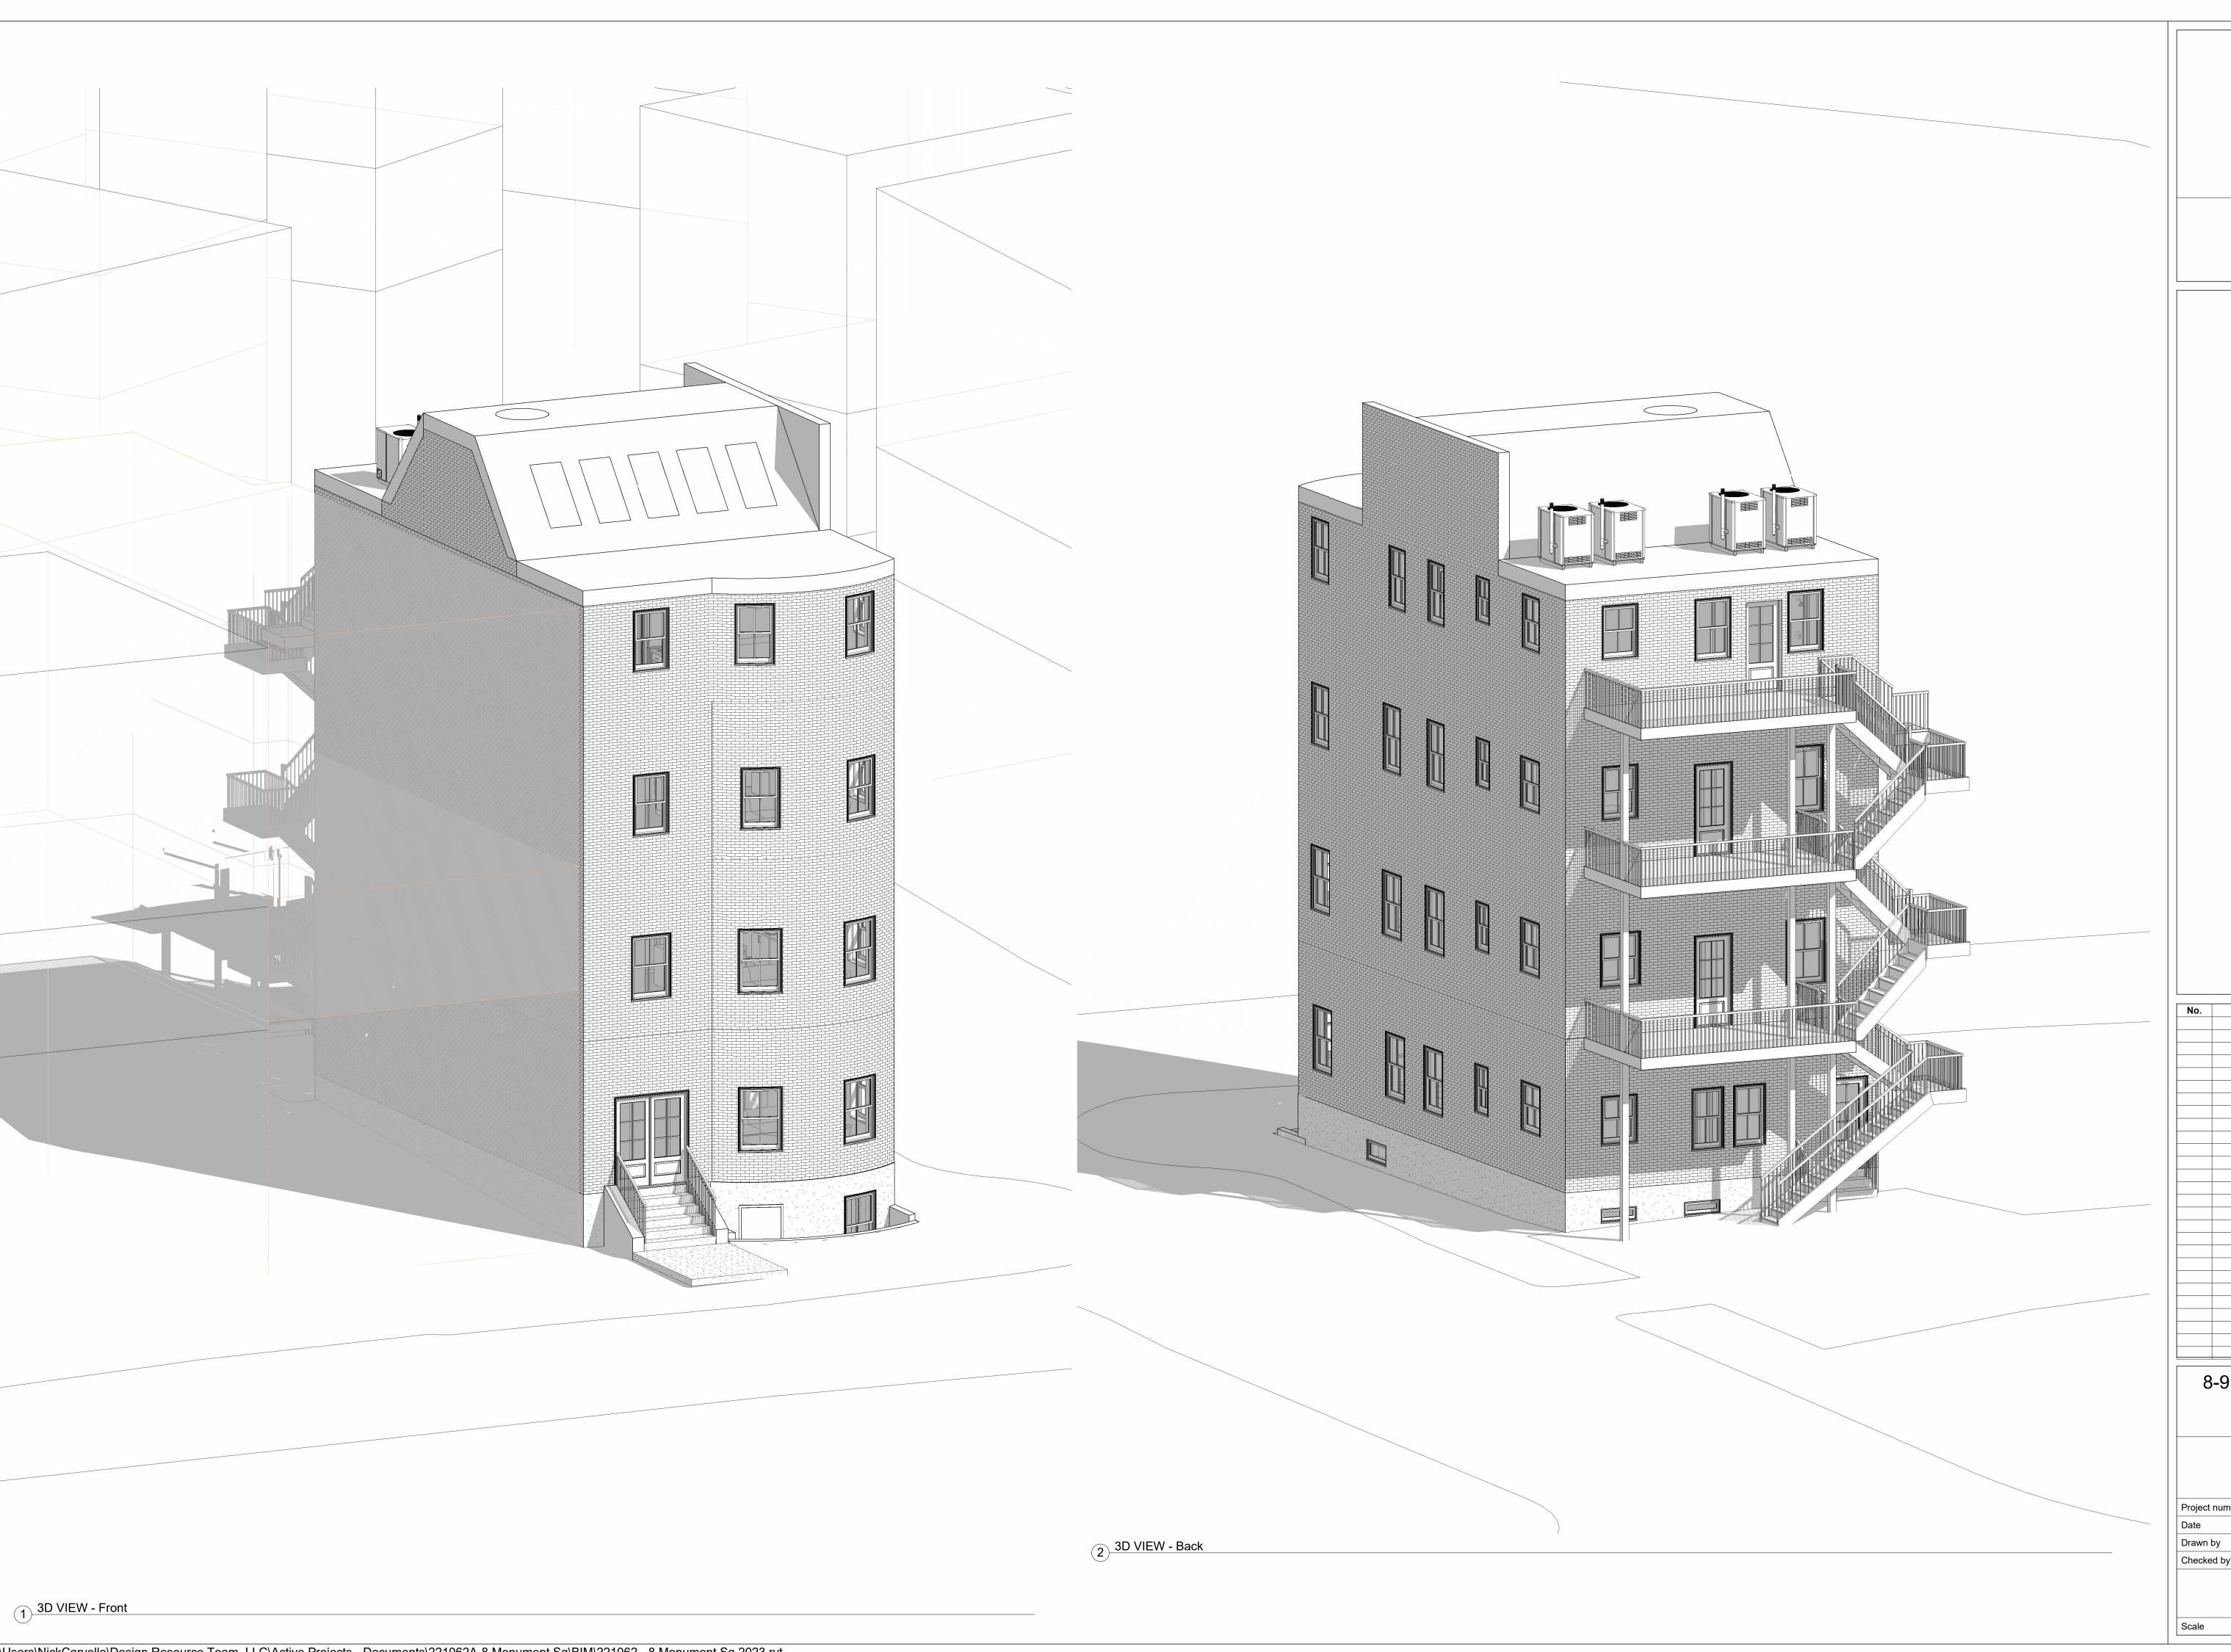



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8-9 MONUMENT SQ LLC 8 MONUMENT SQ

AXONS


 Project number
 221062A


 Date
 3/23/2023

 Drawn by
 NC

 Checked by
 NPL

A500

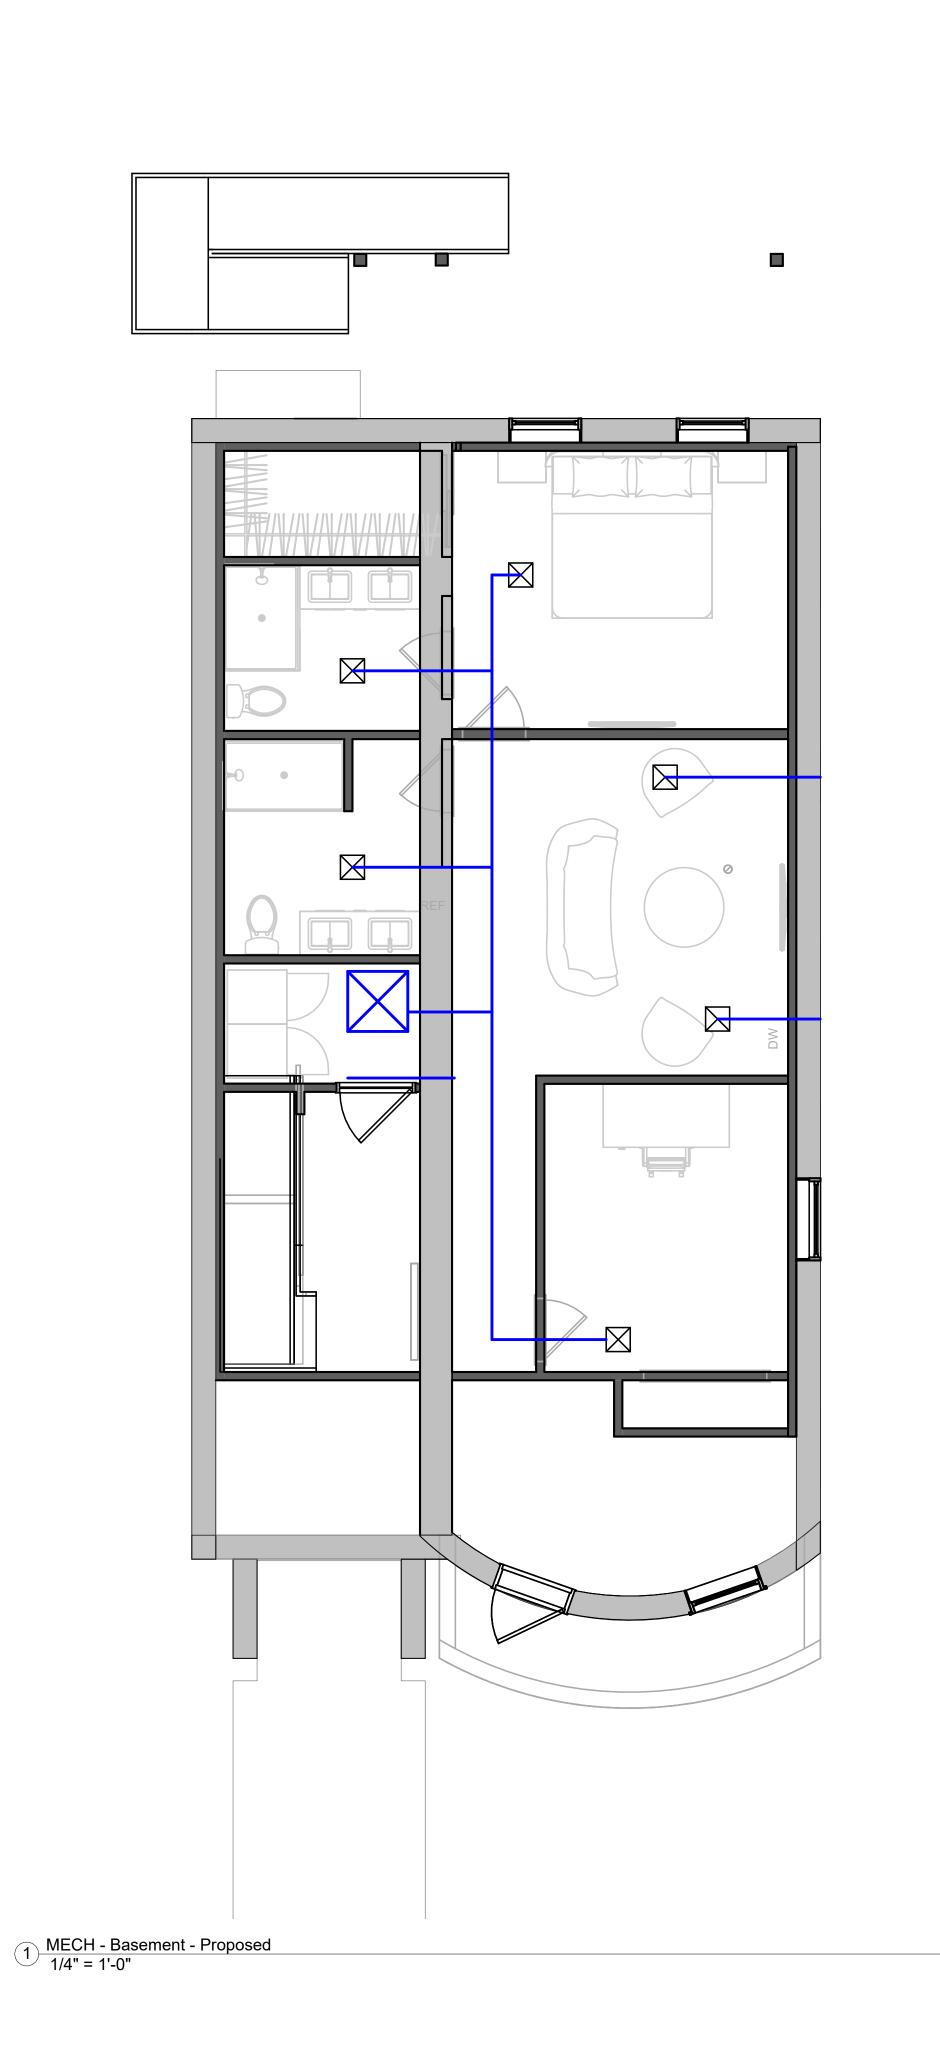

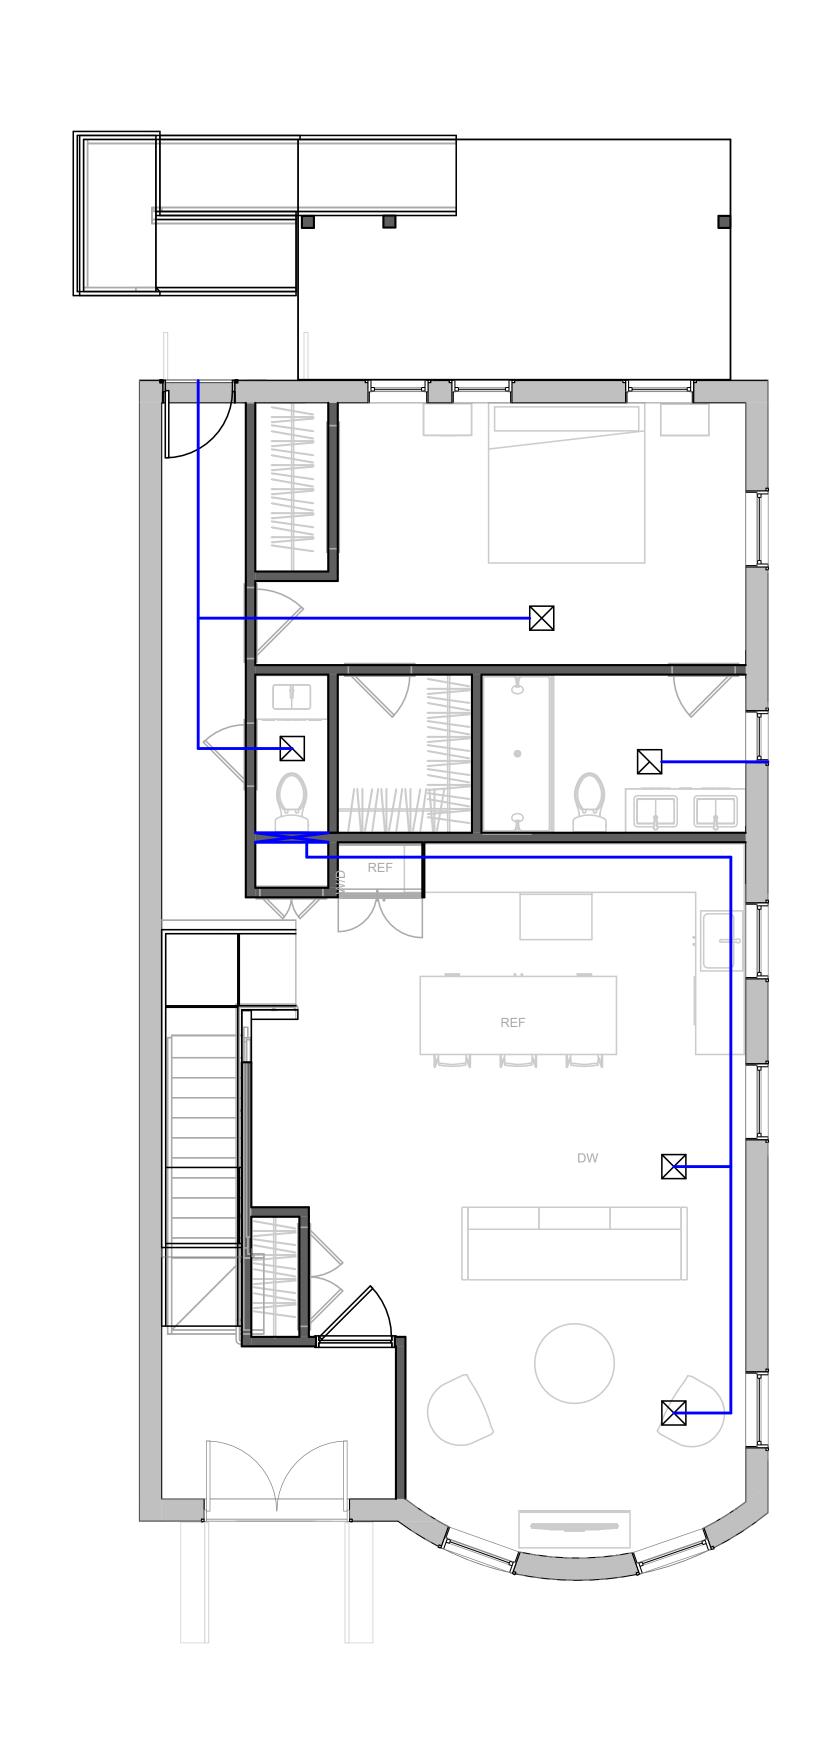

HVAC GRAPHIC KEY

SUPPLY DIFFUSER



EXHAUST FAN

AIR SUPPLY DUCT PATH





REFER TO HVAC NOTES AND PLANS FOR PLACEMENT REQUIREMENTS, TYP.



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No.	Description	Date
	-	


8-9 MONUMENT SQ LLC


8 MONUMENT SQ

MECH LAYOUT - LEVEL G,1

Project number	221062A
Date	3/23/2023
Drawn by	NC
Checked by	NPL
AM10	0
Scale	1/4" = 1'-0"

2 MECH - Level 1 - Proposed 1/4" = 1'-0"

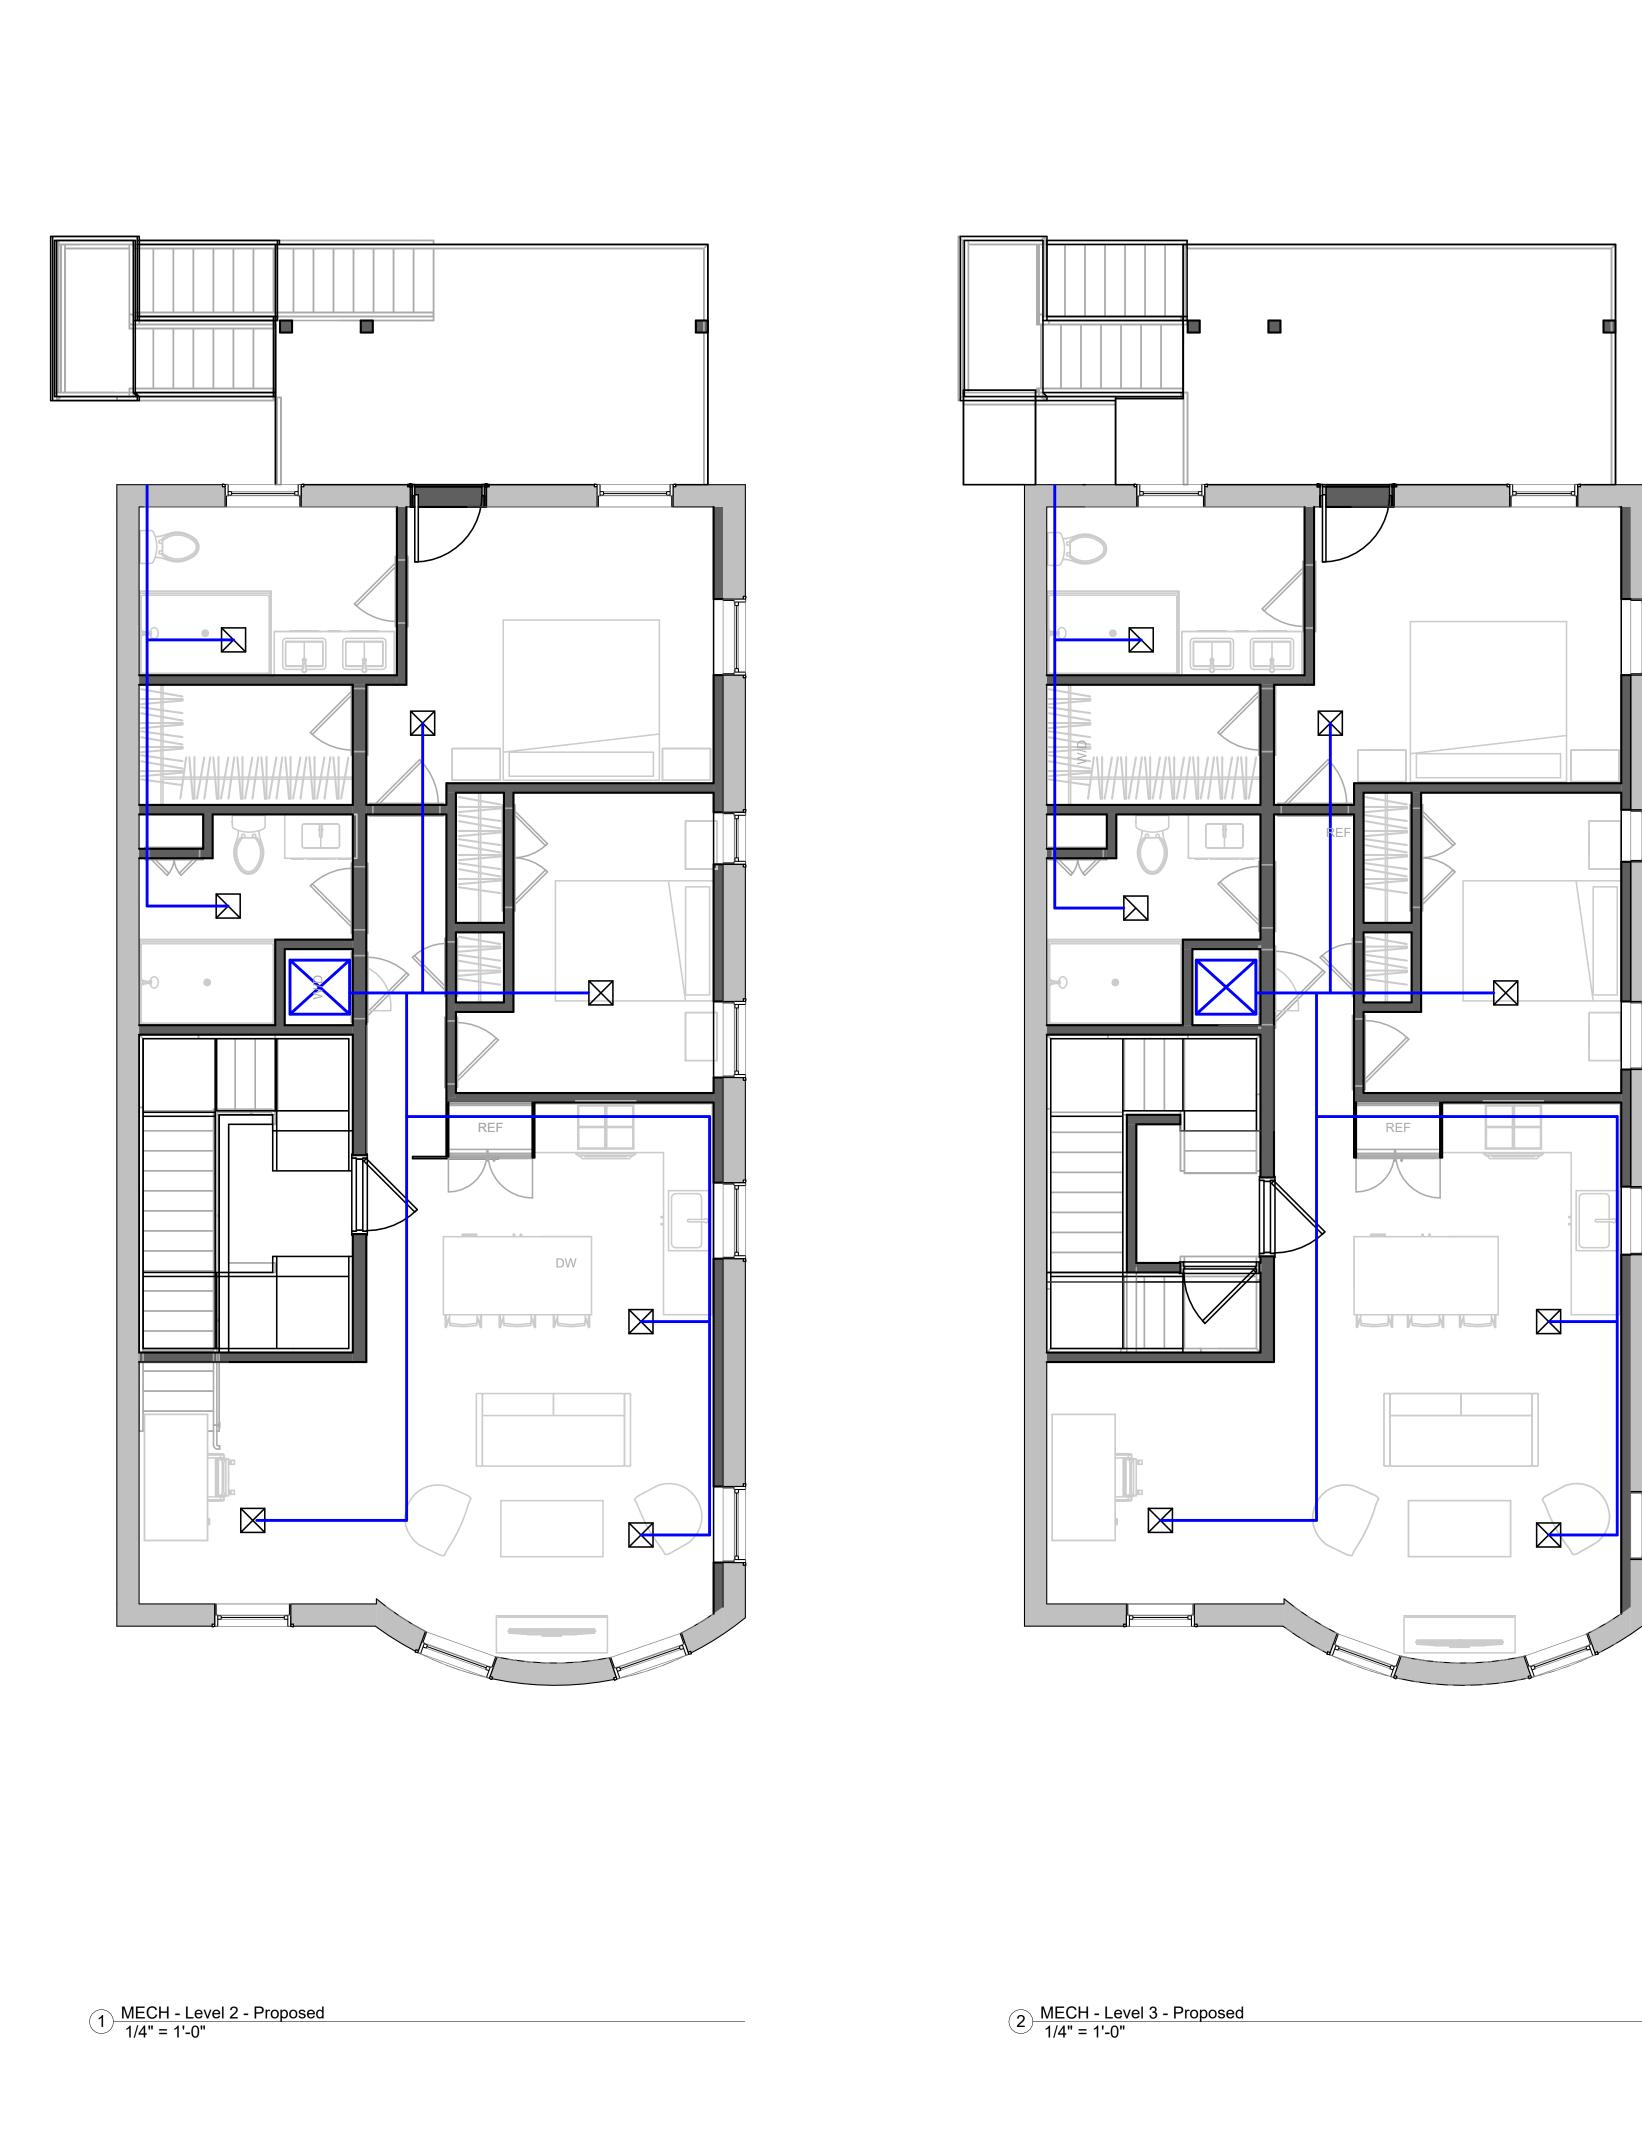

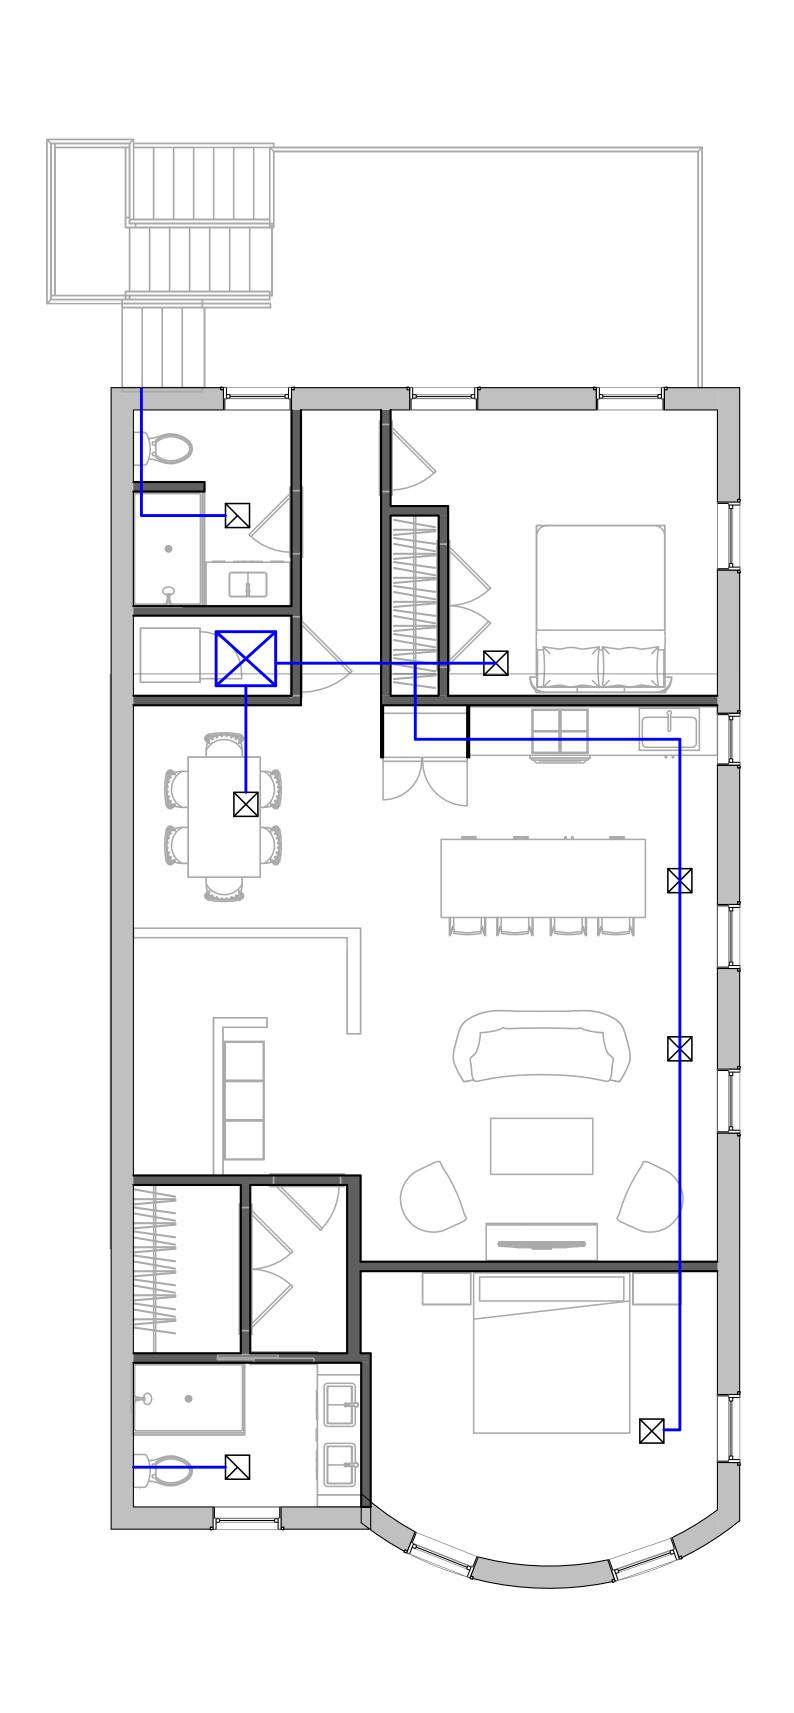

3 MECH - Level 4 - Proposed 1/4" = 1'-0"

HVAC GRAPHIC KEY

SUPPLY DIFFUSER



EXHAUST FAN





MECH UNITS

AIR SUPPLY DUCT PATH

REFER TO HVAC NOTES AND PLANS FOR PLACEMENT REQUIREMENTS,TYP.





No.	Description	Date
	-	


8-9 MONUMENT SQ LLC


8 MONUMENT SQ MECH LAYOUT - LEVEL 2,3

221062A Project number 3/23/2023 Drawn by

AM101

1/4" = 1'-0"

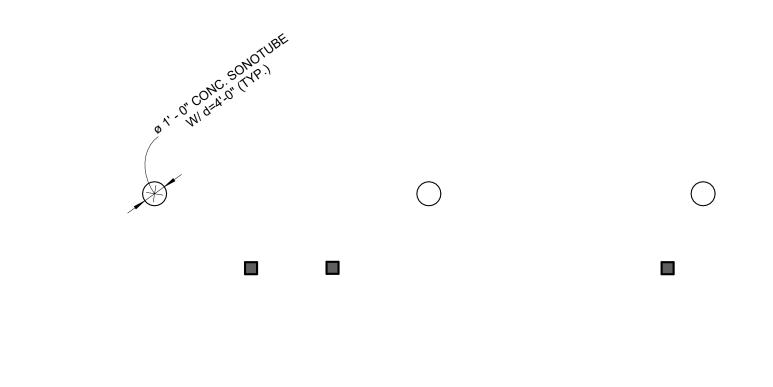

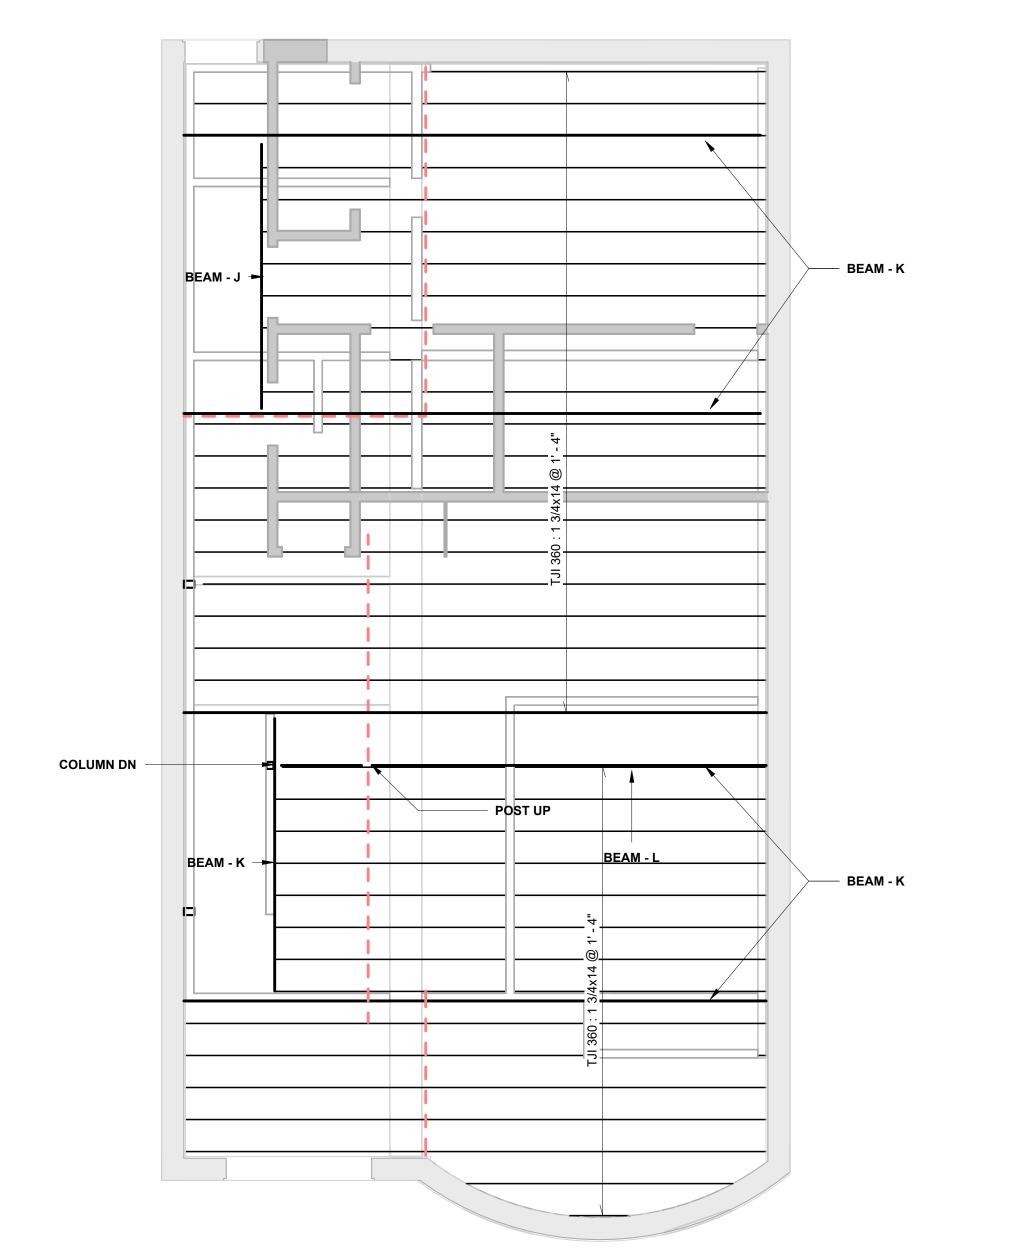

BEAM - SIZE

J - 2 - 1 3/4"x14" LVL K - 3 - 1 3/4"x14" LVL L - 3 - 1 3/4"x14" LVL

STRUCTURAL NOTES

- 1. All work shall be done in accordance with the MSBC, 9th edition.
- 2. Provide temporary support prior to demolition.
- 3. Allowable soil beaing pressure: 1.50 ksf.
- 4. Loading: LL = 40 psf.; LL(deck) = 100 psf.; P_g = 40 psf.; P_f = 30 psf. V_{ult} = 128 mph. (Cat II) Ss = 0.217; S_1 = 0.069
- Material:

a. Lumber: LVL: $F_b = 2,800 \text{ psi}$; $E = 2.0 \times 10^6 \text{ psi}$. Posts: PSL Wood (joists & rafters): Hem-Fir No.1 & btr.; Studs (bearing wall): construction grade; P.T. at ext. exposure

b. Metal connectors: Simpson or approved equal; Corrosion resistant @ ext.exposure.

c. Concrete: f'_c = 3,500 psi; Re-bar: GR 60.
d. Structural Steel: A36;A500; and A992 if needed

HEADER SCHEDULE		
R.O.	SIZE	
<= 4'-0"	2 - 2x8	
<= 6'-0"	2 - 2x10	
<= 8'-0"	2 - 2x12	

- - - - - BEARING PARTITION BELOW

- PROVIDE 3/4" PLYWOOD SUBFLOORING INFILL FLR FRAMING W/ 2x12 @16" O.C. @
- STAIR OPENINGS (TYP)

 DBL FLR JOISTS @ PARALLEL PARTITIONS

2 - #5 T&B

4" CONC. BASEMENT SLAB

NEW 6" CLEAN COMPACTED CRUSHED STONE

Basement -4' - 8 3/4"



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> Evan Hankin 617.839.9690 elhankin@me.com



No.	Description	Date
		1
8	8-9 MONUMENT SQ L	LC.
	8 MONUMENT SQ	

[₹] @ 12" O.C.

8 MONUMENT SQ

3/23/2023

As indicated

STRUCTURAL FRAMING PLANS - LEVEL G & 1 221062A Project number

Checked by S100

Drawn by

Scale


1) Basement 1/4" = 1'-0"


2 Level 1 1/4" = 1'-0" 3 Section B 1/2" = 1'-0"

- 4" CONC. SLAB ON GRADE ON 6" WELL-COMPACTED GRAVEL ——

3'-0" x 3'-0" x 12" DP CONC. FTG. W/ 5 - #5 EA WAY

STL COL: HSS 3 1/2 x 3 1/3 x 1/4
 W/1/2" CAP PLATE & BASE PLATE 3/4" x 11" x 11"
 W/ 3/4" DIAM ANC. BOLTS

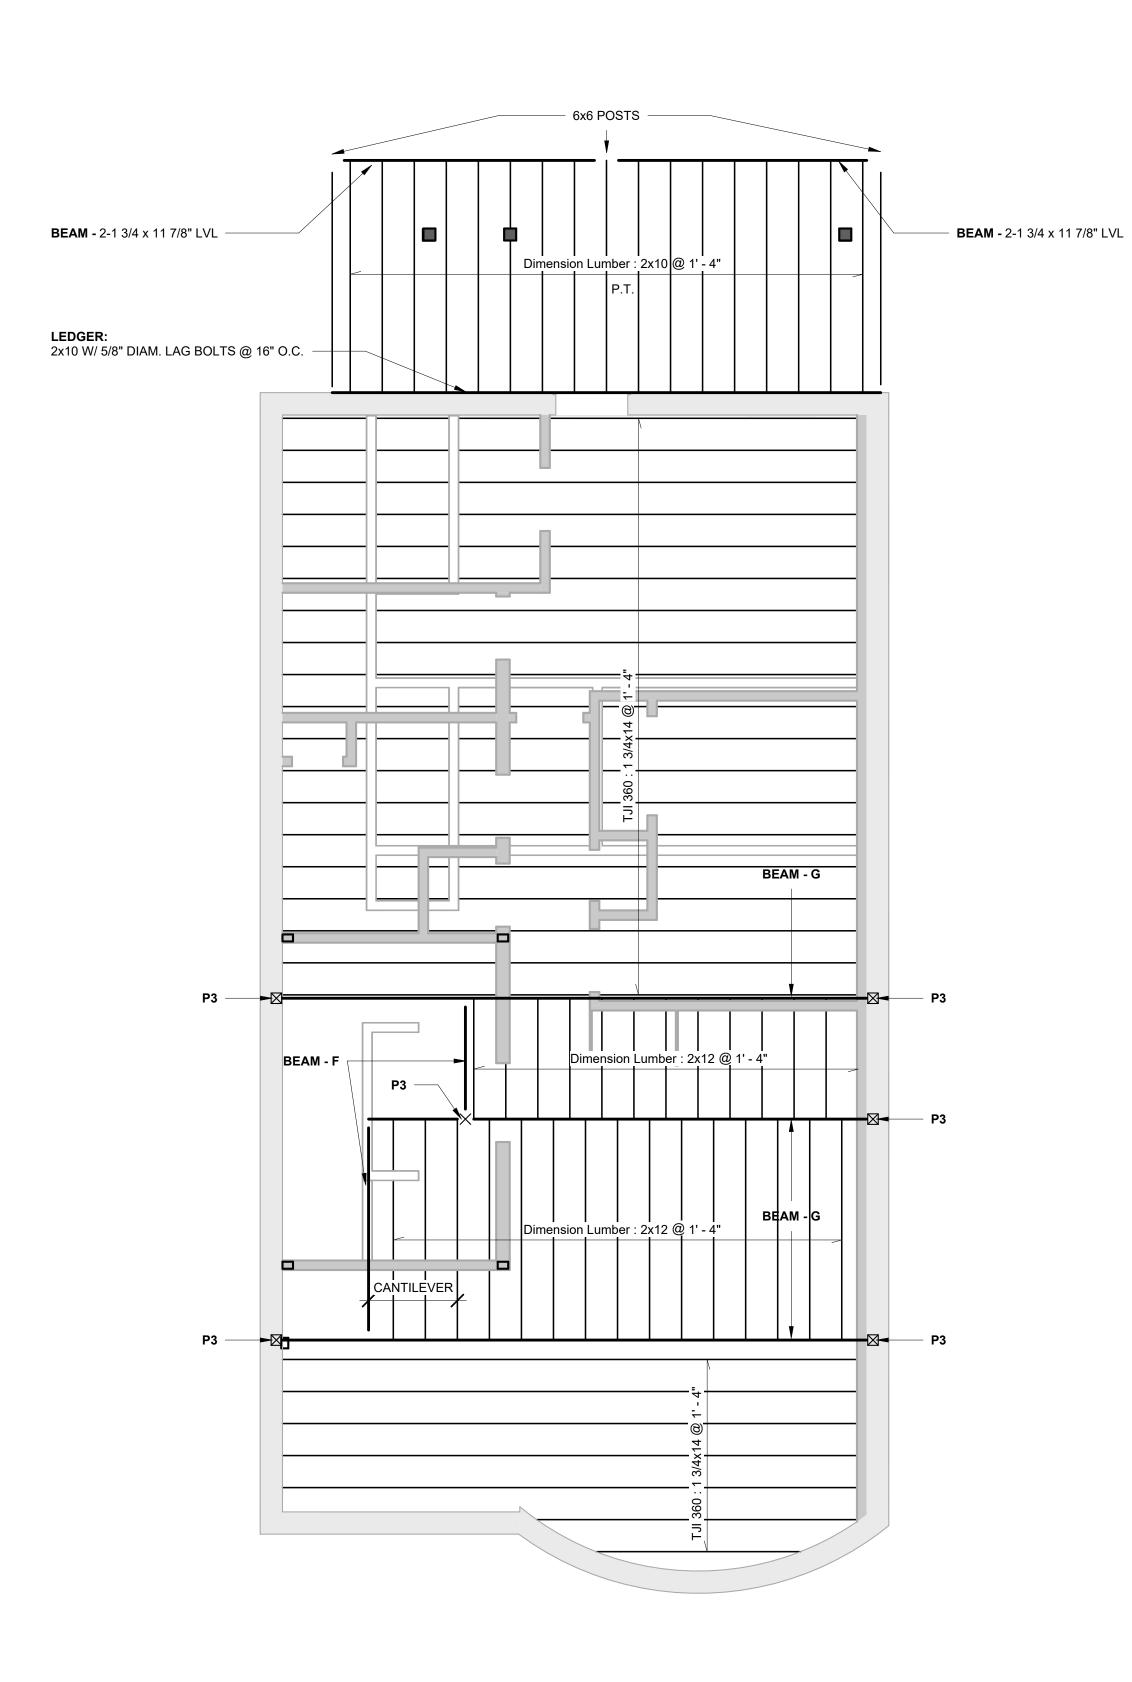

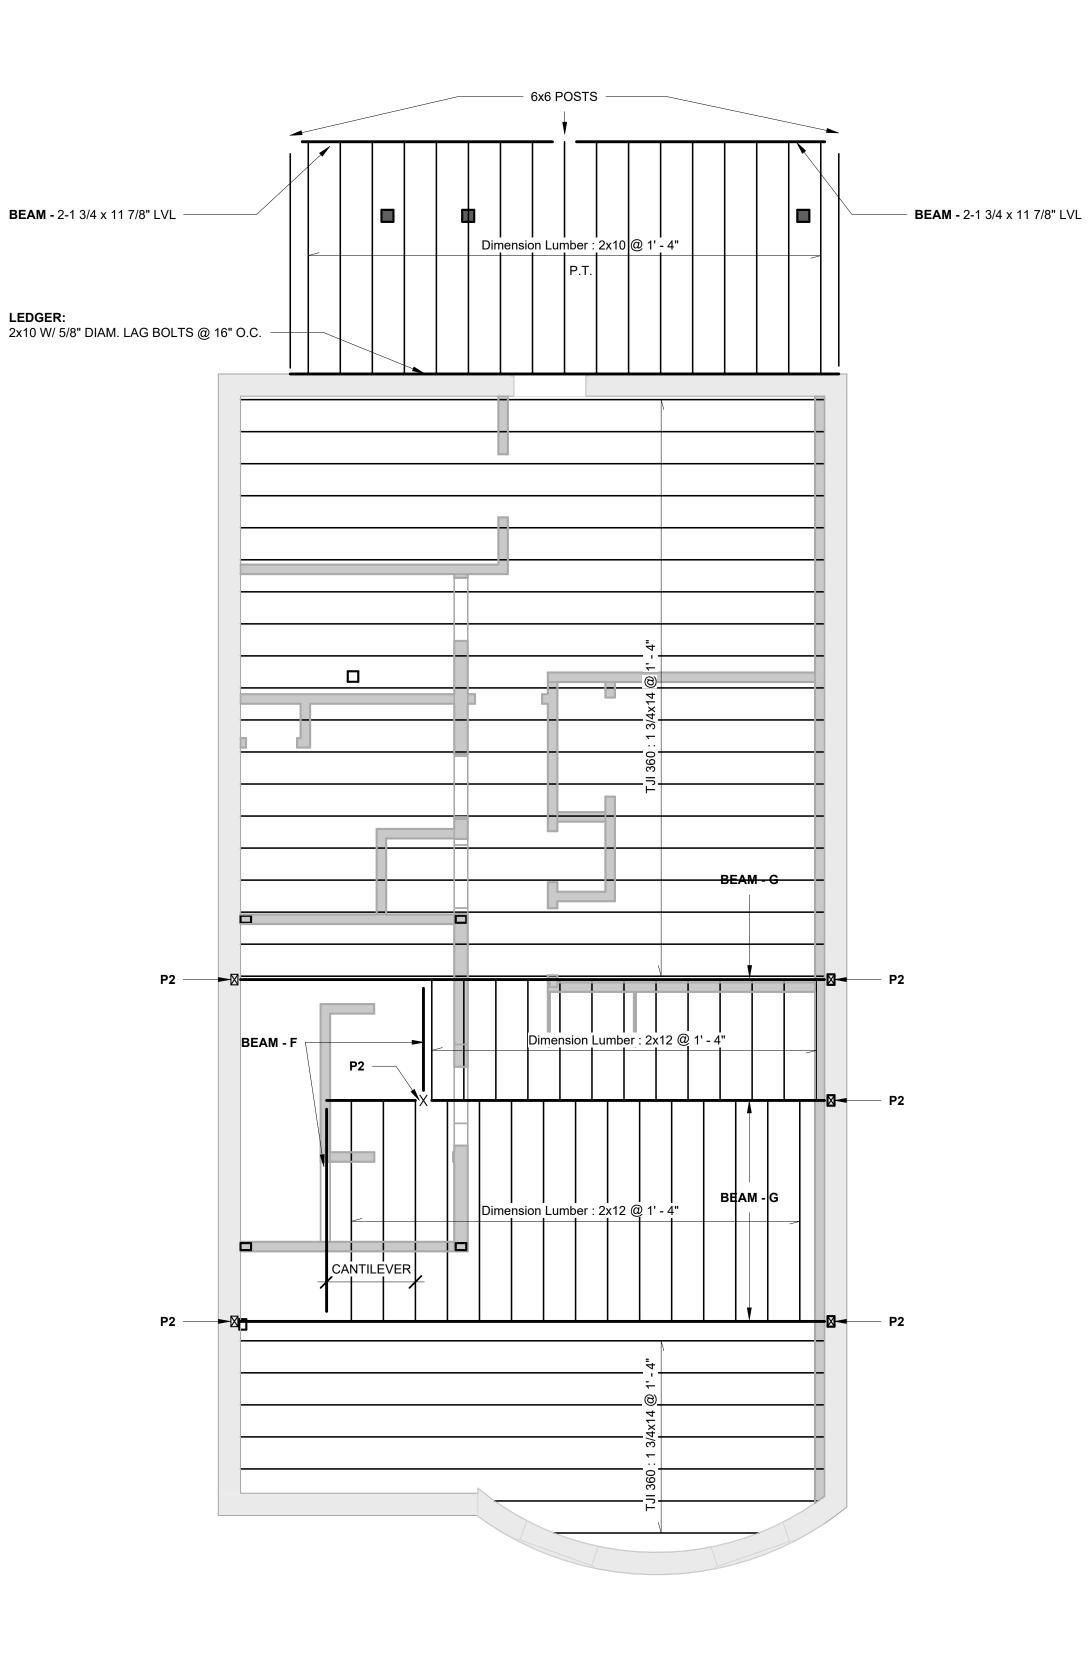

- SIZE

- 3 1/2" x 5 1/4" PSL

I	BEAM	-	SIZE	POST
	-		2 - 1 3/4" x 11 7/8" LVL 2 - 1 3/4" x 11 7/8" LVL	P2

STRUCTURAL NOTES

- 1. All work shall be done in accordance with the MSBC, 9th edition.
- 2. Provide temporary support prior to demolition.
- 3. Allowable soil beaing pressure : 1.50 ksf.
- 4. Loading: LL = 40 psf.; LL(deck) = 100 psf.; P_g = 40 psf.; P_f = 30 psf. V_{ult} = 128 mph. (Cat II) Ss = 0.217; S_1 = 0.069
- Material:

a. Lumber: LVL: $F_b = 2,800 \text{ psi}$; $E = 2.0 \times 10^6 \text{ psi}$. Posts: PSL Wood (joists & rafters): Hem-Fir No.1 & btr.; Studs (bearing wall): construction grade; P.T. at ext. exposure

b. Metal connectors: Simpson or approved equal; Corrosion resistant @ ext.exposure.

c. Concrete: f'_c = 3,500 psi; Re-bar: GR 60.
d. Structural Steel: A36;A500; and A992 if needed

HEA	DER SCHEDULE
R.O.	SIZE
<= 4'-0"	2 - 2x8
<= 6'-0"	2 - 2x10
<= 8'-0"	2 - 2x12

- - - - - BEARING PARTITION BELOW

PROVIDE 3/4" PLYWOOD SUBFLOORING INFILL FLR FRAMING W/ 2x12 @16" O.C. @ STAIR OPENINGS (TYP)

• DBL FLR JOISTS @ PARALLEL PARTITIONS design | resource | team

Design Resource Team, LLC. 546 E Broadway Boston, MA 02127 617.804.6117 nlandry@d-r-t.co www.d-r-t.co

> Evan Hankin 617.839.9690 elhankin@me.com



No.	Description	Date
0 0 1	MONUMENT S	\sim 110

0-9 MONUMENT SQ LLC

8 MONUMENT SQ

STRUCTURAL FRAMING PLANS - LEVEL 2 & 3

221062A Project number 3/23/2023 Drawn by

S101

As indicated

2 Level 3 1/4" = 1'-0"

P3 - 5 1/4" x 5 1/4" PSL

- 2 - 1 3/4" x 11 7/8" LVL - 2 - 1 3/4" x 11 7/8" LVL

1 Level 2 1/4" = 1'-0"

STRUCTURAL NOTES

- 1. All work shall be done in accordance with the MSBC, 9th edition.
- 2. Provide temporary support prior to demolition.
- 3. Allowable soil beaing pressure : 1.50 ksf.
- 4. Loading: LL = 40 psf.; LL(deck) = 100 psf.; P_g = 40 psf.; P_f = 30 psf. V_{ult} = 128 mph. (Cat II) Ss = 0.217; S_1 = 0.069
- 5. Material:

a. Lumber: LVL: $F_b = 2,800 \text{ psi}$; $E = 2.0 \times 10^6 \text{ psi}$. Posts: PSL Wood (joists & rafters): Hem-Fir No.1 & btr.; Studs (bearing wall): construction grade; P.T. at ext. exposure

b. Metal connectors: Simpson or approved equal; Corrosion resistant @ ext.exposure.

c. Concrete: f'_c = 3,500 psi; Re-bar: GR 60.
d. Structural Steel: A36;A500; and A992 if needed

HEADER SCHEDULE						
R.O.	SIZE					
<= 4'-0"	2 - 2x8					
<= 6'-0"	2 - 2x10					
<= 8'-0"	2 - 2x12					

- STAIR OPENINGS (TYP)

 DBL FLR JOISTS @ PARALLEL PARTITIONS

R.O. SIZE <= 4'-0" 2 - 2x8 <= 6'-0" 2 - 2x10
<= 6'-0" 2 - 2x10
2 2 2 2 2 2 2 2 2 2 2 2 2 2 2 2 2 2 2 2
<= 8'-0" 2 - 2x12



Evan Hankin 617.839.9690 elhankin@me.com



No.	Description	Date
1		1
8-9	MONUMENT S	$O \cup C$


8 MONUMENT SQ

STRUCTURAL FRAMING PLANS - LEVEL 4 & ROOF

221062A Project number 3/23/2023 Drawn by

S102


As indicated

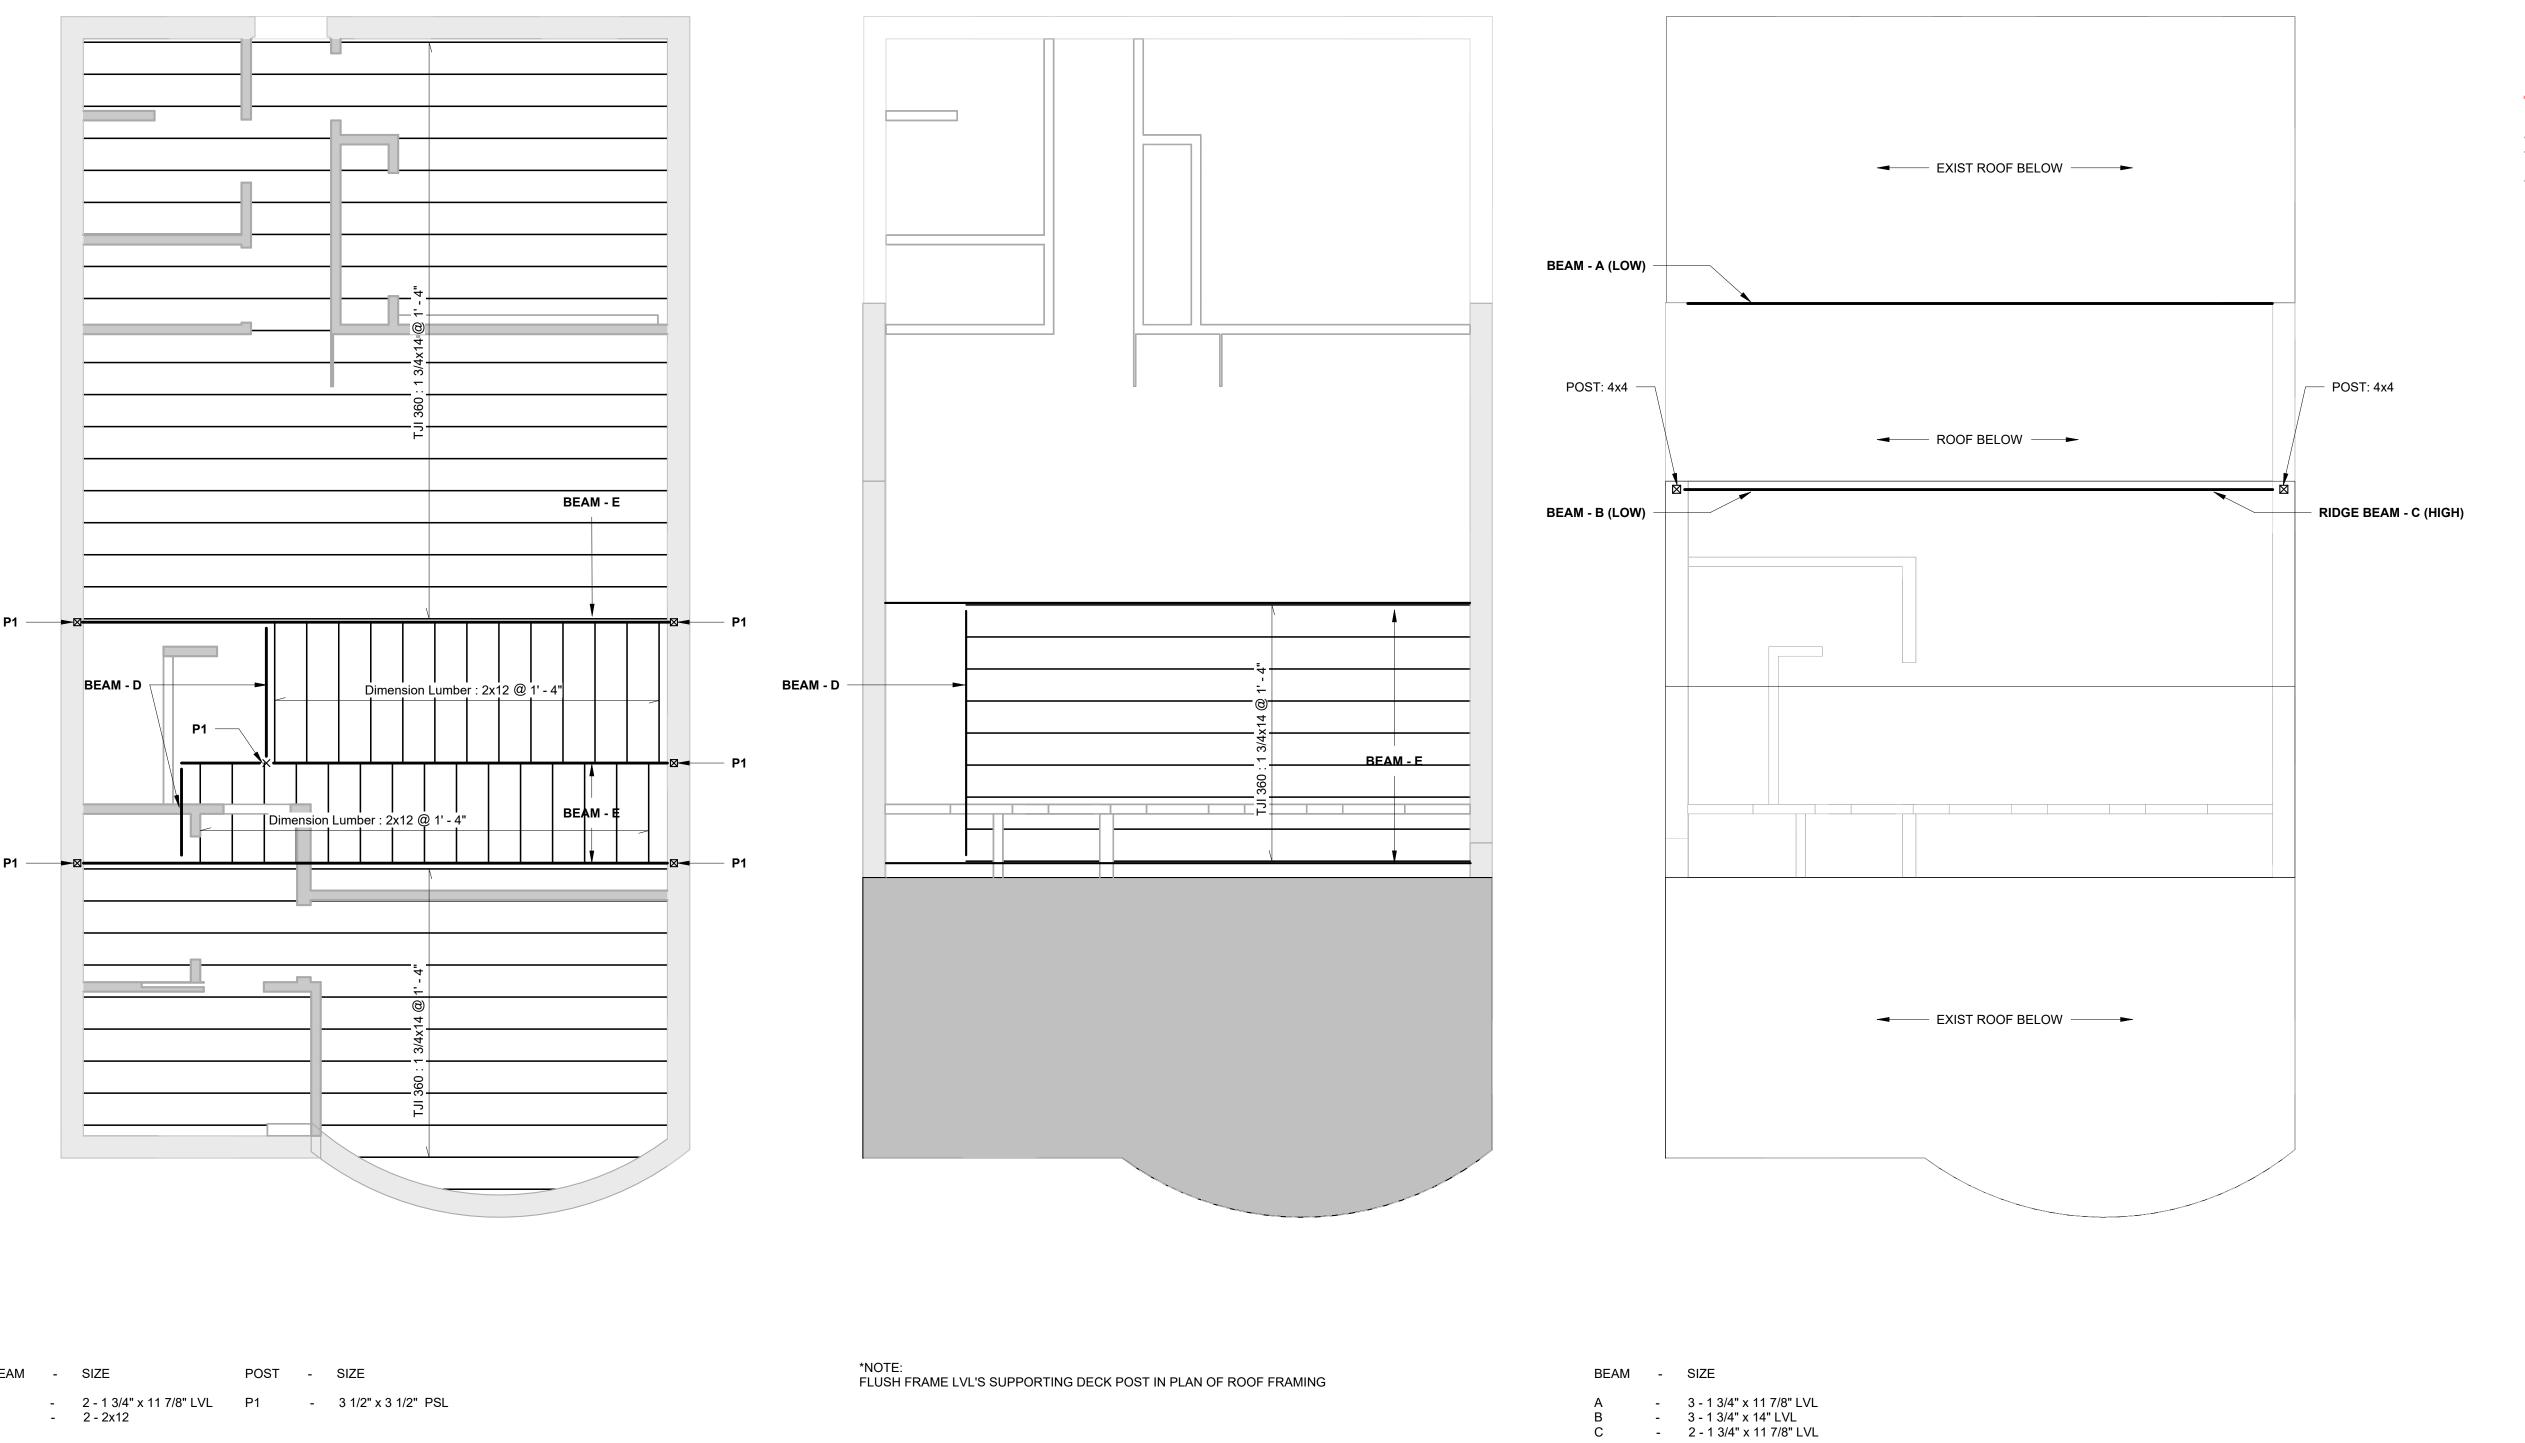

3 TORoof 1/4" = 1'-0"

2 Level 4 1/4" = 1'-0"

1 Roof 1/4" = 1'-0"

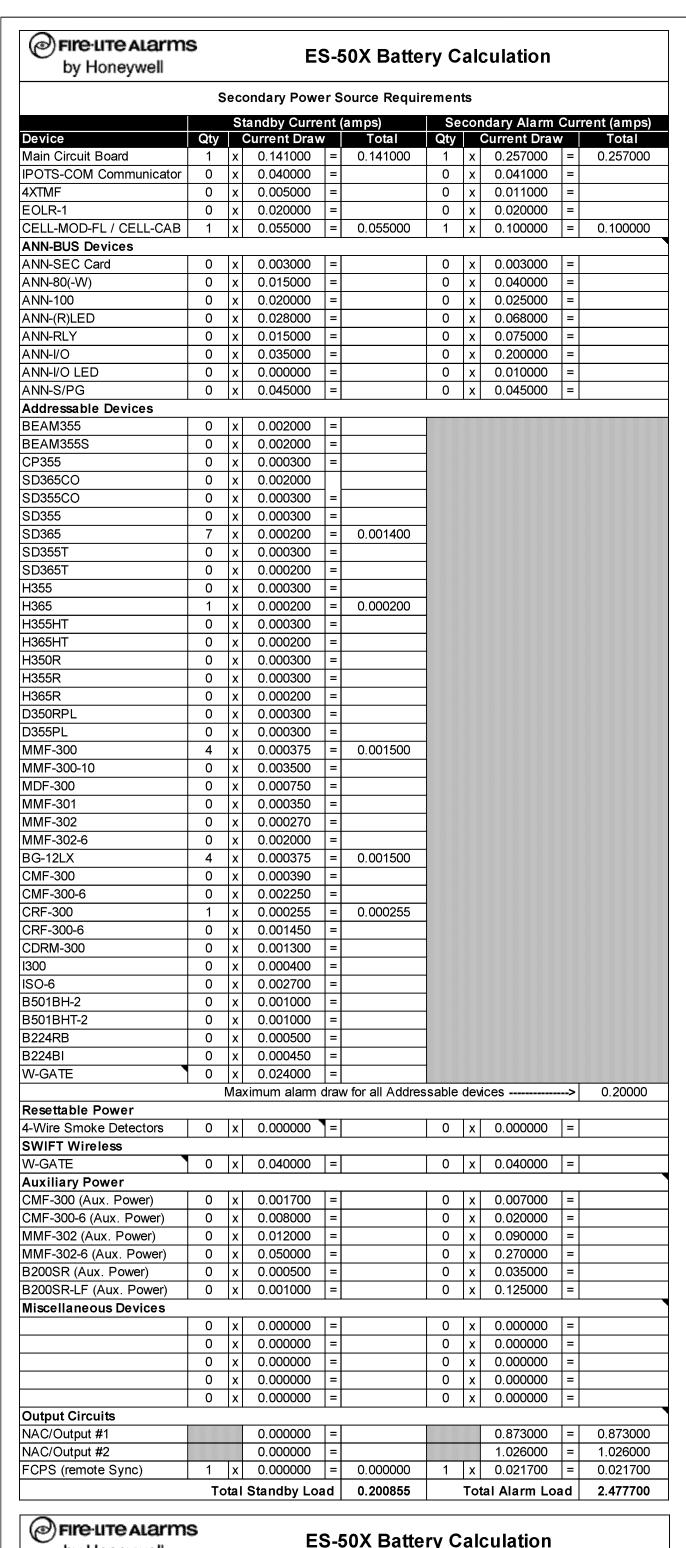

ES-50X Battery Calculation							
Calculation in Total Sheet							
	Req			in Hours			
		24 Ho	ours	`*			
0.2009 Amps	х	24	=	4.821 AH			
	Req	uired Alarm [•]	Time i	n Minutes			
		5 Min	utes				
2.4777 Amps	Х	0.084		0.208 AH			
	То	tal Current Lo	oad	5.029 AH			
Multiply by the Derating Factor		1.2	=	x 1.20			
Total A	Ampere	Hours Requi	red	6.03 AH			
Recommended Batteries:		BAT-1270 - 7	λΗ Bat	teries			
	Calculation in Total Sheet 0.2009 Amps 2.4777 Amps Multiply by the Derating Factor Total A	Calculation in Total Sheet Req 0.2009 Amps	Calculation in Total Sheet Required Standb 24 Ho 24 Ho 25 Min 2.4777 Amps x 0.084 Total Current Lo Multiply by the Derating Factor 1.2 Total Ampere Hours Required Total Ampere Hours Required	Calculation in Total Sheet Required Standby Time 24 Hours 0.2009 Amps			

FIRE ALARM SYMBOLS

COMBINATION SPEAKER/STROBE, ADA APPROVED,

LF MINIHORN (GENTEX GHLF 24 VDC SERIES)

FIRE ALARM CONTROL PANEL WITH BATTERY BACKUP; FIRE-LITE OR APPROVED EQUAL

ADDRESSABLE SYSTEM SMOKE DETECTOR

ADDRESSABLE SYSTEM CO DETECTOR

HEAT DETECTOR 135° FIXED TEMP

TRANSIENT PROTECTIVE DEVICE

NOTE: NOT ALL DEVICES USED IN THIS SYSTEM PRODUCTS SHALL BE AS INDICATED OR EQUAL

LOCAL HARDWIRED SMOKE (PHOTO)

LOCAL HARDWIRED SMOKE (PHOTO) /CO

80" AFF; 15/75 CANDELLA, SET AT 15 cd U.O.N.

TS TAMPER SWITCH

FS FLOW SWITCH

MM MONITOR MODULE

CM CONTROL MODULE

IM ISOLATOR MODULE

ON FLOOR PLANS.

PER FIRE DEPARTMENT.

ANN REMOTE ANNUNCIATOR PANEL

REMOTE TEST @FACP

AUTOMATIC DAMPER

DIGITAL UL DIALER

ELECTRIC BELL

BEACON (OVER FDC)

RT

(EB)

─ DESIGNATES CANDELLA RATING;

EXTERIOR WEATHERPROOF HORN/STROBE EXACT LOCATION AND HEIGHT


ADDRESSABLE MANUAL PULL STATION 48" AFF

The batteries can be charged by the ES-50X Charger.
The batteries can be housed in the ES-50X Cabinet.

Current Draw Check
NAC#1 current is within the limitations of the circuit.
NAC#2 current is within the limitations of the circuit.

NAC#2 current is within the ES-50X current draw:


STANDBY & LOAD BATTERY CALCULATIONS

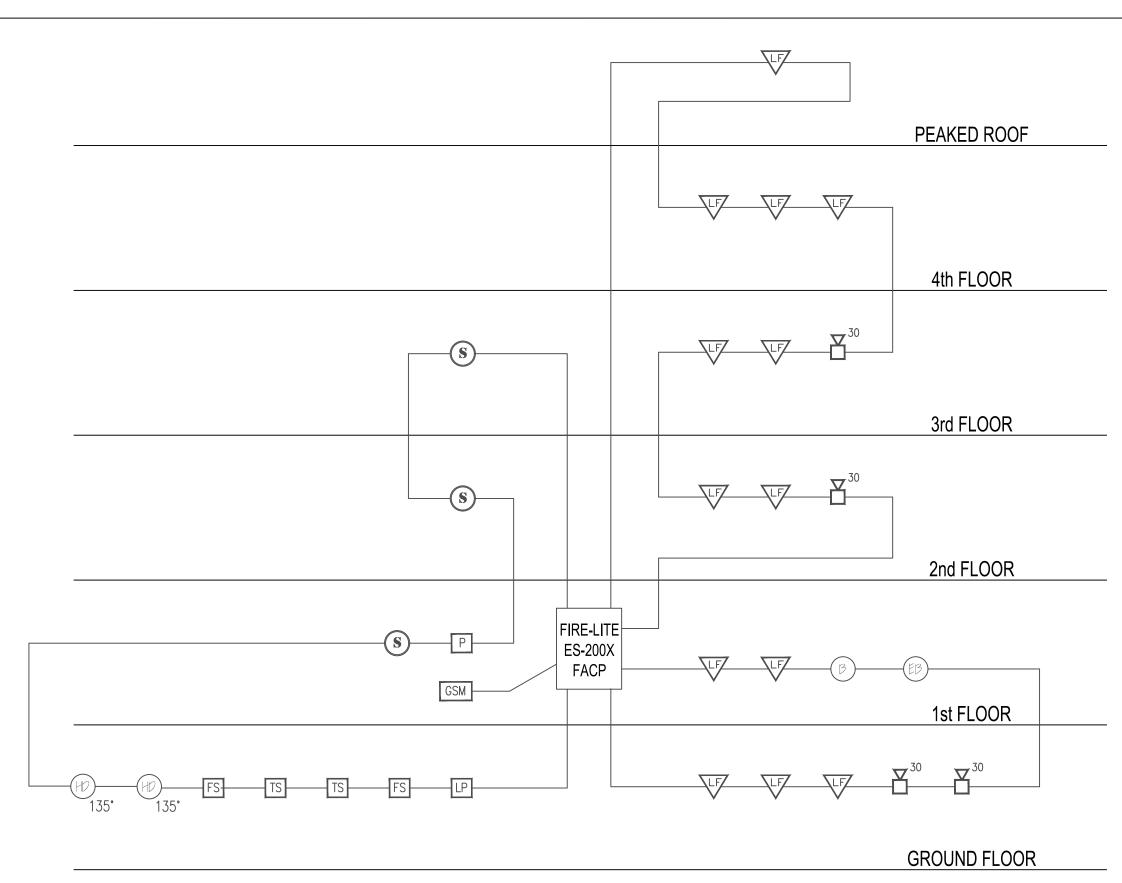


FIRE ALARM RISER DIAGRAM

Fire-LITE ALARMS by Honeywell			ES-50X Circuit Detail							
			NAC	C/O	utput #1					
Device	Qty	N	on-Alarm Dra	aw	Total	Qty		Alarm Draw		Total
SRL 15	0	х	0.000000	T=1		0	х	0.043000	=	
P2RL 15	2	х	0.000000	=	0.000000	2	х	0.054000	=	0.108000
P2RL 110	0	х	0.000000	=		0	х	0.162000	=	
P2RK 110	0	х	0.000000	=		0	х	0.212000	=	
SYSTEM SENSOR HR-LF	5	х	0.000000	=	0.000000	5	х	0.153000	=	0.765000
	0	х	0.000000	=		0	х	0.000000	=	
	0	х	0.000000	=		0	х	0.000000	=	
	0	х	0.000000	=		0	х	0.000000	=	
	0	х	0.000000	=		0	х	0.000000	=	
	0	х	0.000000	=		0	х	0.000000	=	
	To	tal	Standby Loa	ad	0.000000		Tot	al Alarm Loa	d	0.873000

NAC/Output #2										
Device	Qty	N	on-Alarm Dra	ıw	Total	Qty		Alarm Draw		Total
SRL 15	0	Х	0.000000	=		0	Х	0.043000	=	
P2RL 15	2	Х	0.000000	=	0.000000	2	Х	0.054000	=	0.108000
P2RL 110	0	Х	0.000000	=		0	Х	0.162000	=	
PC2RK 30	0	Х	0.000000	=		0	Х	0.107000	=	
PC2RK 75	0	Х	0.000000	=		0	Х	0.176000	=	
SYSTEM SENSOR HR-LF	6	Х	0.000000	=	0.000000	6	Х	0.153000	=	0.918000
	0	Х	0.000000	=		0	Х	0.000000	=	
	0	Х	0.000000	=		0	Х	0.000000	=	
	0	Х	0.000000	=		0	Х	0.000000	=	
	0	Х	0.000000	=		0	х	0.000000	=	
	0.000000	-	Γot	al Alarm Loa	d	1.026000				
·										

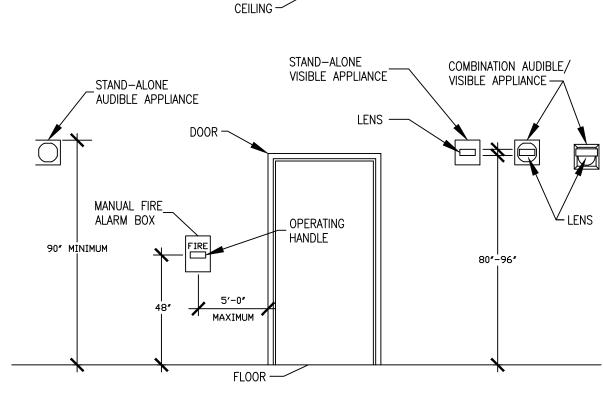

TYPICAL MOUNTING HEIGHT DETAIL FOR WALL MOUNTED DEVICES

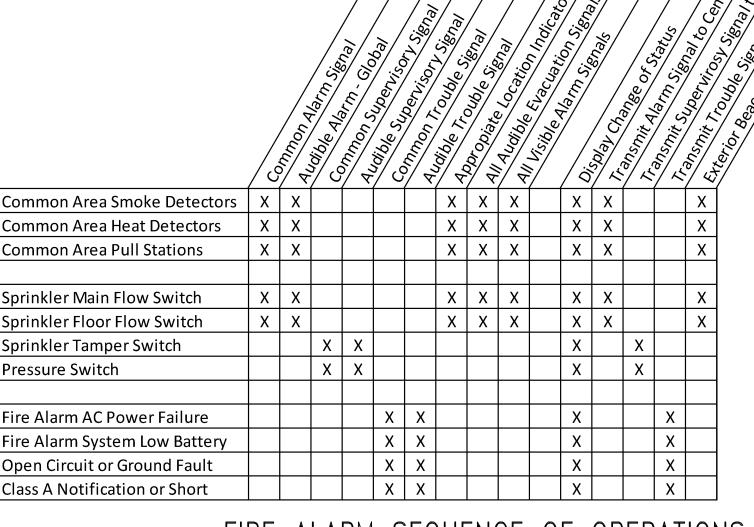

FIRE ALARM SEQUENCE OF OPERATIONS

- 1. ALL FIRE ALARM SYSTEM WIRING SHALL COMPLY WITH THE NATIONAL ELECTRICAL CODE, APPLICABLE STATE AND LOCAL FIRE AND SAFETY CODES, AS WELL AS BEING COORDINATED WITH THE LOCAL AUTHORITY HAVING JURISDICTION.
- 2. <u>CAUTION</u>: DO NOT CONNECT ANY POWER TO CONTROL PANEL (BATTERIES OR 120VAC) UNTIL ALL OTHER FIELD WIRING IS TESTED AND CONNECTED
- 3. DO NOT INSTALL ANY A.C. CURRENT CARRYING CONDUCTORS CLOSE TO OR IN THE SAME RACEWAY WITH FIRE ALARM SYSTEM CONDUCTORS
- 4. THE ENTIRE FIRE ALARM SYSTEMS SHALL BE A CLASS "A" ADDRESSABLE SYSTEMS.
- 5. THE RATING OF THE CONTROL MODULE CONTRACTS ARE: 20 WATTS AUDIO AT 25 OF 70 VOLTS
- 2.0 AMPS DC (BELLS, HORNS AND DC CONTROL CIRCUITS)
 0.3 AMPS INDUCTIVE
- 6. ALL OUTPUT (SIGNAL) CIRCUITS ARE SHOWN IN ALARM CONDITION. POLARITY IS REVERSED WHEN THE SYSTEM IS IN SUPERVISORY CONDITION.
- 7. OWNER TO PROVIDE DESIGNATIONS FOR DEVICE PROGRAMMING LANGUAGE
- 8. REFER TO FLOOR PLANS FOR EXACT LOCATIONS AND QUANTITY OF ALL DEVICES.
- 9. FIRE ALARM CONTRACTOR SHALL FIELD VERIFY THE LENGTHS AND FEASIBILITY OF ALL ROUTING BEFORE BEGINNING WORK.
- 10. ALL JUNCTION BOX COVERS IN THE FIRE ALARM SYSTEM SHALL BE PAINTED RED, BY THE FIRE ALARM CONTRACTOR, BEFORE THEY ARE INSTALLED.
- 11. ALL EQUIPMENT SHALL BE UL LISTED AND/OR FM APPROVED.
- 12. ELECTRICAL SUBCONTRACTOR SHALL INSTALL ALL WIRING TO THE FIRE ALARM CONTROL PANELS; TERMINATIONS SHALL BE MADE BY THE FIRE ALARM SUPPLIER OR UNDER SUPERVISION OF A
- REPRESENTATIVE FROM THE FIRE ALARM MANUFACTURER

 13. GROUND ALL EQUIPMENT PER N.E.C. REQUIREMENTS

 14. ALL PERMITS AND INSPECTION FEES SHALL BE OBTAINED AND PAID FOR BY THE FIRE ALARM CONTRACTOR.
- 15. ALL CUTTING, PATCHING AND CORE DRILLING FOR THE FIRE ALARM SYSTEMS SHALL BE THE RESPONSIBILITY

 OF THE ELECTRICAL CONTRACTOR.


 16. THE LOCATIONS OF ALL SMOKE DETECTORS AND HEAT DETECTORS SHOWN ARE CONSIDERED TO BE
- 16. THE LOCATIONS OF ALL SMOKE DETECTORS AND HEAT DETECTORS SHOWN ARE CONSIDERED TO BE SCHEMATIC ONLY. THE ACTUAL LOCATIONS (SPACING TO ADJACENT DETECTORS, WALLS, ETC.) ARE REQUIRED TO MEET NFPA 72
- 17. ALL SMOKE AND CARBON MONOXIDE DETECTORS TO HAVE BATTERY BACKUP
- 18. CARBON MONOXIDE DETECTORS SHALL BE LOCATED WITHIN 10FT OF BEDROOM DOOR. MINIMUM OF (1) CARBON MONOXIDE DETECTOR SHALL BE LOCATED ON EACH FLOOR.
- 19. (1) CARBON MONOXIDE DETECTOR SHALL BE INSTALLED IN EACH ROM USED BY CHILDREN FOR SLEEPING. VERIFY IN FIELD.

SYSTEM OPERATION:

- THE ACTIVATION OF ANY MANUAL FIRE ALARM STATION OR THE AUTOMATIC ACTUATION OF ANY SYSTEM SMOKE DETECTOR, SPRINKLER SYSTEM WATER FLOW SWITCH OR ANY OTHER APPROVED ALARM INITIATION DEVICE SHALL IMMEDIATELY RESULT IN THE FOLLOWING:
- 1. THE DEVICE IN ALARM SHALL BE LISTED ON A DISPLAY AT THE FIRE ALARM PANEL AND REMOTE ANNUNCIATOR
- 2. THE AUDIBLE HORNS SHALL SOUND A TEMPORAL PATTERN AT ALL LOCATIONS
- 3. ALL VISUAL ALARM SIGNALS SHALL FLASH AT A RATE OF 120 FLASHES PER MINUTE 4. IF ALARM SIGNALS ARE SILENCED FOR ANY REASON, THEY SHALL AUTOMATICALLY RESOUND IF ANOTHER
- ADDRESS IS TRIPPED.
- 5. OUTDOOR BEACON LIGHTS WILL ILLUMINATE.
- 6. IN THE EVENT OF A COMMERCIAL POWER INTERRUPTION, THE SYSTEM SHALL AUTOMATICALLY TRANSFER TO AN EMERGENCY BATTERY SOURCE.
- THIS TIER 1 DRAWING IS FOR DIAGRAMMATICAL USE ONLY. FIRE ALARM CONTRACTOR TO SUBMIT TIER II SHOP DRAWINGS, BATTERY CALCULATIONS AND PRODUCT CUTS TO BE REVIEWED BY THE OWNER, ARCHITECT AND ENGINEER AND REVIEWED AND APPROVED BY BOSTON FIRE DEPARTMENT AND INSPECTIONS SERVICES DEPARTMENT.
- THE FIRE ALARM SYSTEMS FOR THIS BUILDING IS MADE UP OF THE FOLLOWING;

AND SIGNAL SENT VIA RADIO SIGNAL (WILL NOT TRIP MASTER BOX)

- 1. FIRE ALARM CONTROL PANEL (ADDRESSABLE TYPE) LOCATED IN VICINITY OF MAIN ENTRANCE.
- 2. PULL STATIONS AT MAIN EGRESS LOCATIONS.
- 3. HORN STROBE LOCATED ON 1ST LEVEL COMMON AREA AND LOW FREQUENCY SOUNDERS IN ALL APARTMENTS (75 dB MIN AT PILLOW OF SLEEPING ROOMS)
- 4. LOCAL SMOKE DETECTORS IN ALL BEDROOMS AND COMBINATION SMOKE AND CARBON MONOXIDE DETECTORS WITHIN 10-FT OF ALL BEDROOM DOORS, INTERCONNECTED WITHIN UNIT.
- 5. SYSTEM SMOKE DETECTORS IN ALL COMMON AREAS
- 6. FLOW SWITCH FOR SPRINKLER SYSTEM
- 7. ELECTRIC BELL, LOCATED OUTSIDE OF THE BUILDING ABOVE THE FIRE DEPARTMENT CONNECTION.
- 8. KNOX BOX AT MAIN ENTRANCE
 9. CARBON MONOXIDE DETECTOR SHALL BE LOCATED IN ALL AREAS THAT CONTAIN FOSSIL FUEL AND ADJACENT AREAS AND CONNECTED TOT EH FIRE ALARM SYSTEM. TROUBLE ONLY ON FIRE ALARM PANEL

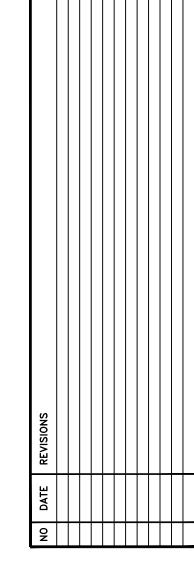



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Drawing Date: 3-21-2023
Drawn By: KR
Scale: 1/4" = 1'-0"
Contractor: LANDWORDS LLC



Project Name and Address

3-UNIT RESIDENCE

8 MONUMENT SQUARE


BOSTON, MA

Sheet Title


FIRE ALARM NOTES & DETAILS

FA-0



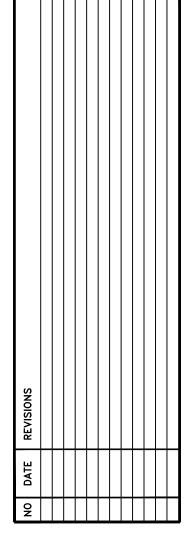





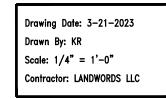





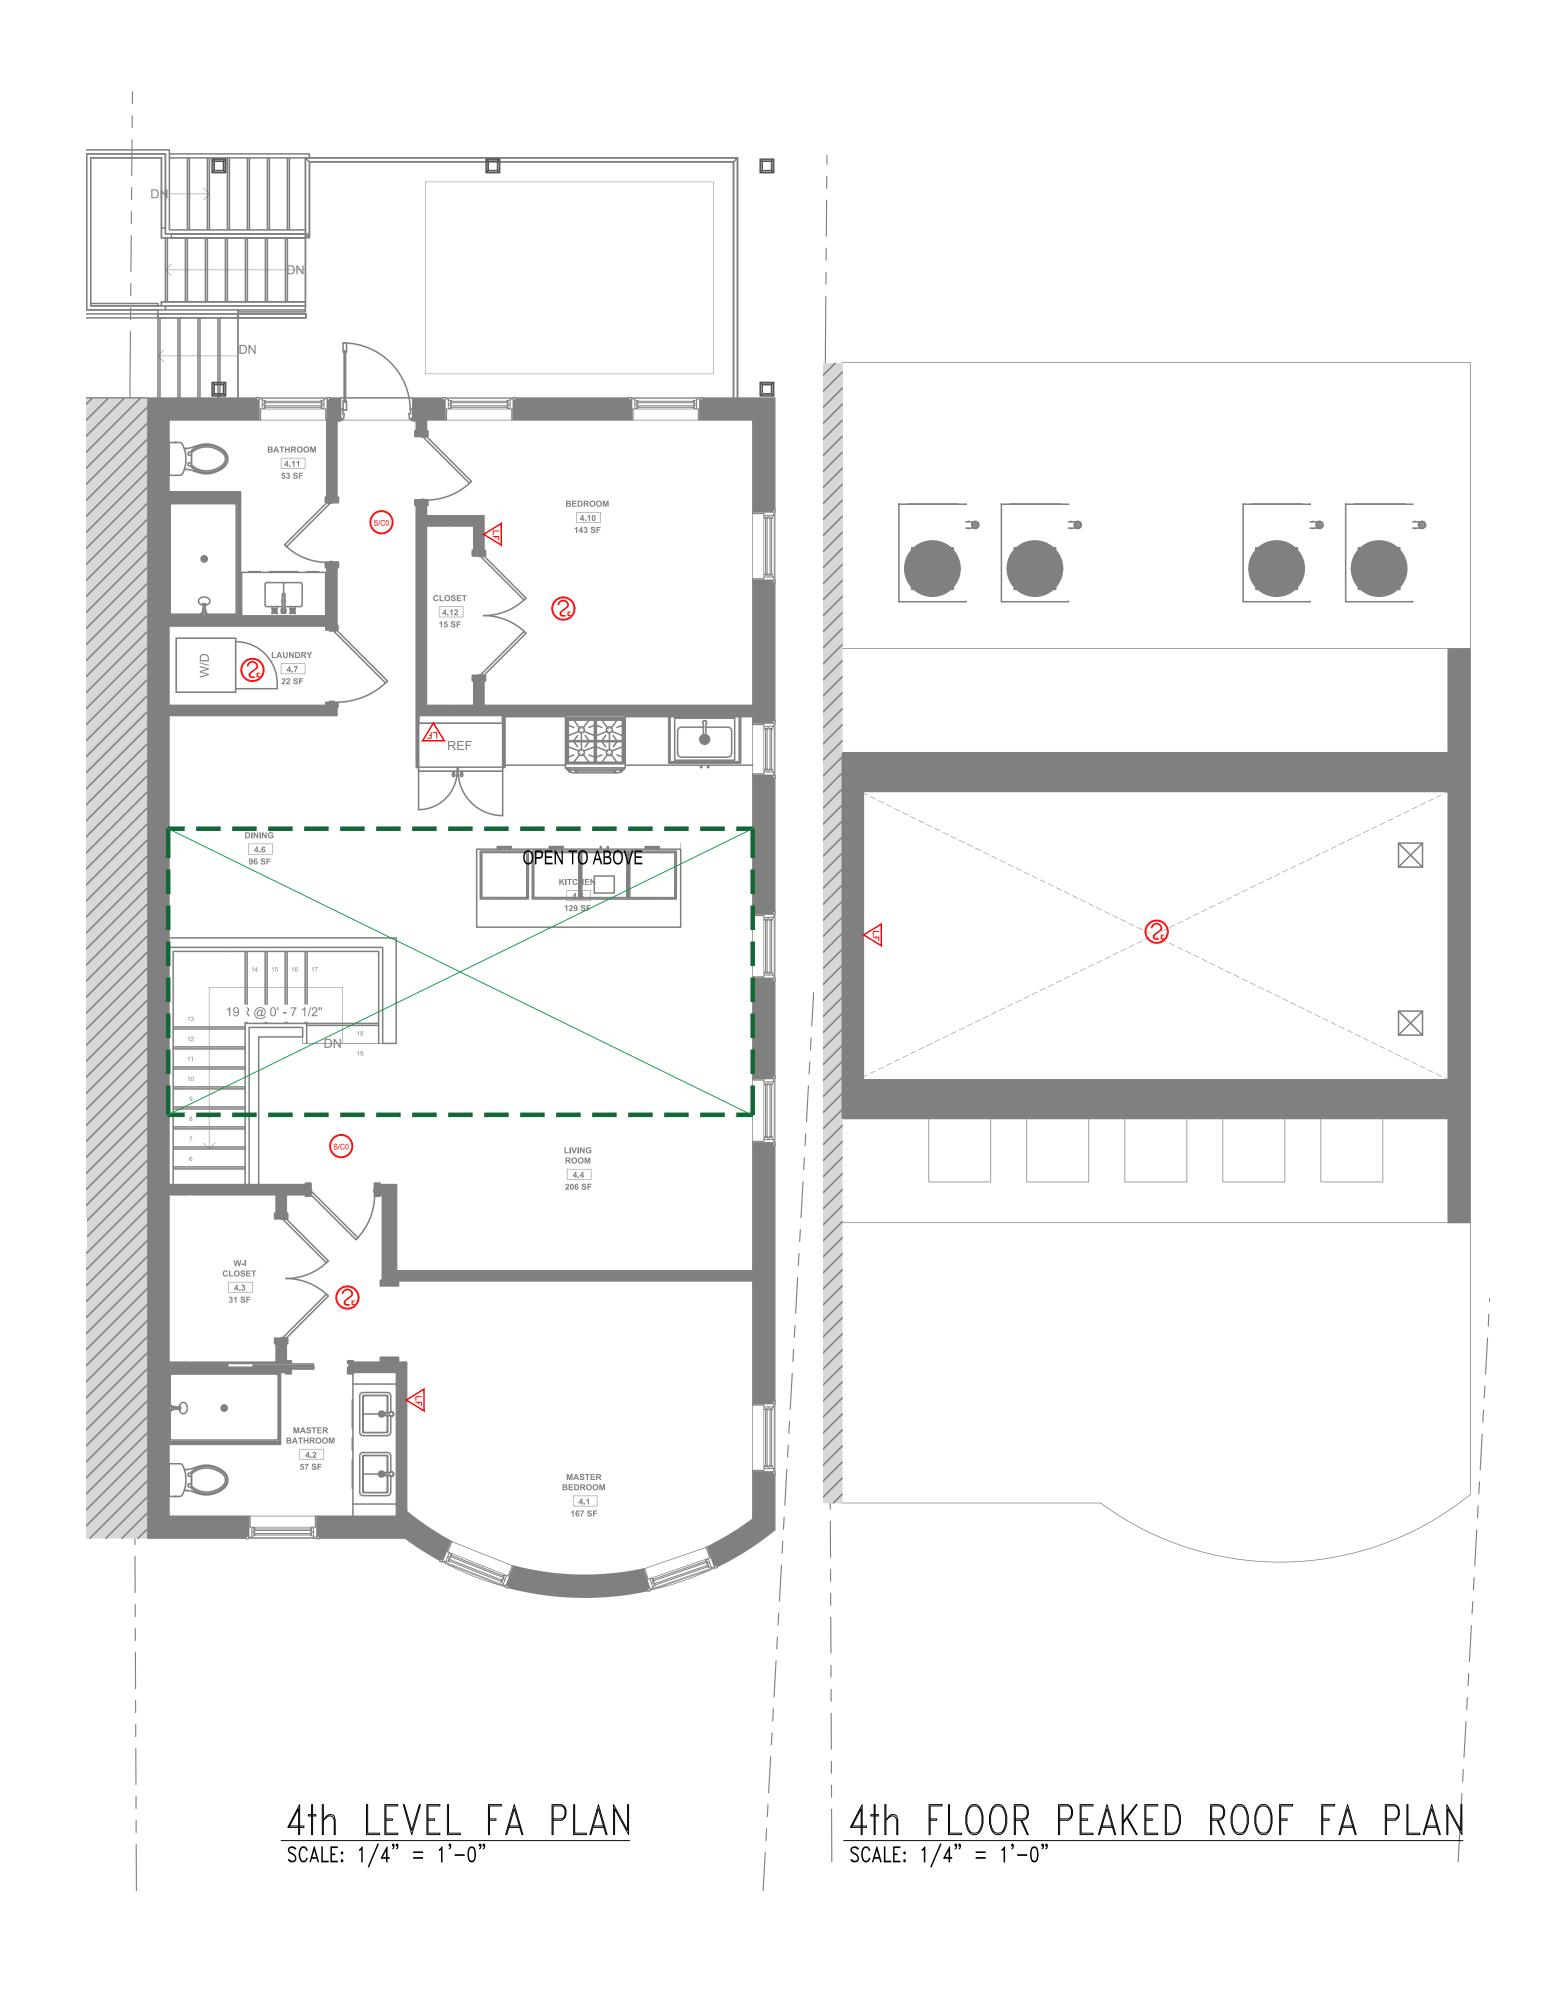

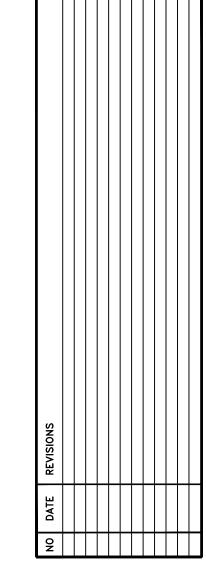



Drawing Date: 3-21-2023

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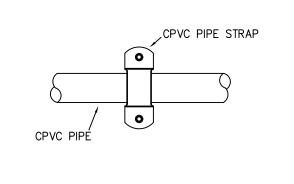



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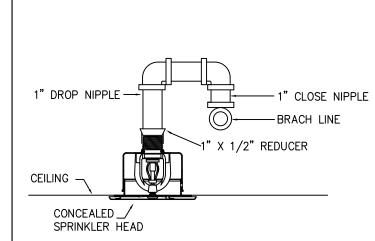
3-UNIT RESIDENCE
8 MONUMENT SQUARE
BOSTON, MA


FA PLANS

FA-2





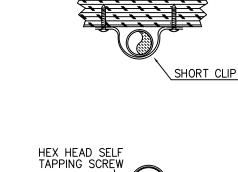

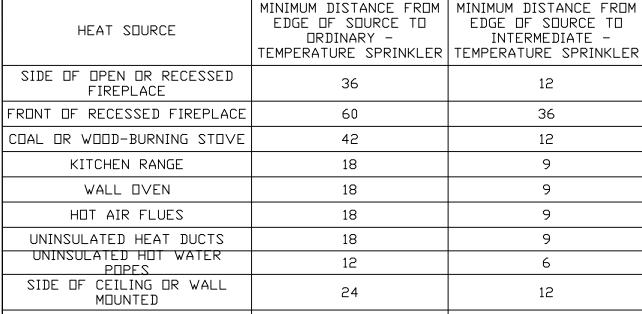

36

6

6

12

18

3

3

6

HOT AIR DIFFUSERS

HOT WATER HEATER OR

FURNACE LIGHT FIXTURE 0W - 250W


LIGHT FIXTURE 250W - 499W

TABLE 8.3.2.5(C) TEMPERATURE RATINGS OF SPRINKLER IN SPECIFIED RESIDENTIAL



<u>DETAIL</u>

CONCEALED SPRINKLER HEAD SCALE: NOT TO SCALE

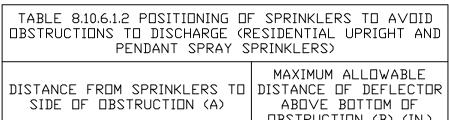

DISTANCE FROM SPRINKLERS TO SIDE OF OBSTRUCTION (A)	MAXIMUM ALLOWABLE DISTANCE OF DEFLECTOR ABOVE BOTTOM OF OBSTRUCTION (B) (IN.)
LESS THAN 1 FT	0
1 FT TO LESS THAN 1 FT 6 IN	0
1 FT 6 IN TO LESS THAN 2 FT	1
2 FT TO LESS THAN 2 FT 6 IN	1
2 FT 6 IN TO LESS THEN 3 FT	1
3 FT TO LESS THAN 3 FT 6 IN	3
3 FT 6 IN TO LESS THAN 4 FT	3
4 FT TO LESS THAN 4 FT 6 IN	5
4 FT 6 IN TO LESS THAN 5 FT	7
5 FT TO LESS THAN 5 FT 6 IN	7
5 FT 6 IN TO LESS THAN 6 FT	7
6 FT TO LESS THAN 6 FT 6 IN	9
6 FT 6 IN TO LESS THAN 7 FT	11
7 FT AND GREATER	14
FOR SI UNITS, 1 IN = 25.41	MM, 1 FT = 0.3048 M

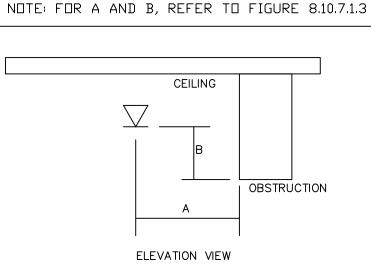
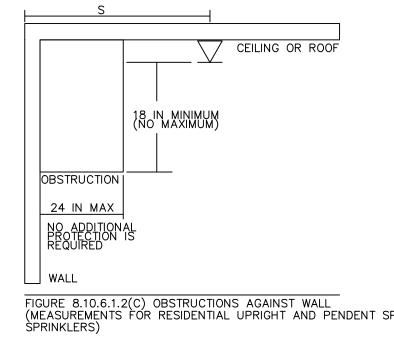


FIGURE 8.10.6.1.2(A) POSITIONING OF SPRINKLER TO AVOID OBSTRUCTION TO DISCHARGE (RESIDENTIAL UPRIGHT AND PENDENT SPRAY SPRINKLERS)



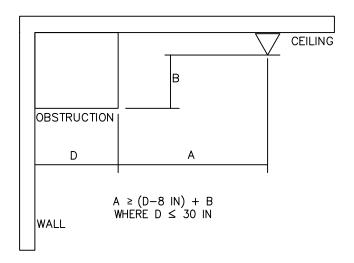


FIGURE 8.10.6.1.2(B) OBSTRUCTIONS AGAINST WALL (RESIDENTIAL UPRIGHT AND PENDENT SPRAY SPRINKLERS)


CEILING OR ROOF	Calculation results for Design Area 1 - 4th Floor					
	This system as shown on co	ompany print no dated <u>11-14-22</u>				
	for 8 Monument Sq at 8 Monumnet Sq					
	contract no is designed to discharge at a rate of	0.05 gpm/ft² (L/min/m²) of floor area over				
10 101 101 101	a maximum area of 4 ft ² when supplied with water at a rate of 53	3.5 gpm at 46.3 psi at the base of the riser.				
18 IN MINIMUM (NO MAXIMUM)	Hose stream allowance of is included in the above.					
	Occupancy classification: Residential	Number of heads flowing: 4				
	Commodity classification:	System Type: Wet				
OCTOLICATION I	Maximum storage height:	Maximum velocity: 8.79 ft/s				
STRUCTION	Storage arrangement:					
24 IN MAX	Flow from In-Rack sprinklers: 0 gpm Pressure Re	quired at Source: 46.3 psi				
O ADDITIONAL	9. 1.10000.01.10	ailable at Source: 53.9 psi				
O ADDITIONAL ROTECTION IS EQUIRED		sure at Source: 7.6 psi				
LQOINED	Flow from Outside Hoses: 0 gpm	·				
	Other fixed flows: 0 gpm					
/ALL	Total flow in system piping: 53.5 gpm					
RE 8.10.6.1.2(C) OBSTRUCTIONS AGAINST WALL	Additional flow at/beyond source: 100 gpm					
SUREMENTS FOR RESIDENTIAL UPRIGHT AND PENDENT SPRAY NKLERS)	Total of all flows: 153.5 gpm					

Total of all flows:

This system as shown on	company	company print no			
for 8 Monument Sq	at <u>8 Mo</u>	numnet Sq			
contract no is de	signed to dischar	ge at a rate of 0.05	gpm/ft² (L/min/	/m²) of floor a	area over
a maximum area of 2 ft ² when s	upplied with wate	r at a rate of 24.2 gpm	_ at <u>45.5 psi</u> at	t the base of	the riser.
Hose stream allowance of	is included in the	e above.			
Occupancy classification: Residential			Number of he	eads flowing:	: 2
Commodity classification:			System Type:		Wet
Maximum storage height:			Maximum velocity		4.12 ft/s
Storage arrangement:					
Flow from In-Rack sprinklers:	0 gpm	Pressure Required a	nt Source: 45.	.5 psi	
Flow from Overhead sprinklers:	24.2 gpm	Pressure Available a		.9 psi	
Flow from Inside Hoses:	0 gpm	Surplus Pressure at	Source: 8.	.4 psi	
Flow from Outside Hoses:	0 gpm				
Other fixed flows:	0 gpm				
Total flow in system piping:	24.2 gpm				
Additional flow at/beyond source:	100 gpm				
Total of all flows:	124.2 gpm				

Calculation results for Design Are	ea <u>3</u>	- 3rd Floor		
This system as shown on	company	dated 11-14-22		
for 8 Monument Sq	at <u>8 Mo</u>	numnet Sq		
contract no	is designed to dischar	ge at a rate of <u>0.05</u>	gpm/ft² (L/min/m²)	of floor area over
a maximum area of 4 ft2 wh	en supplied with wate	r at a rate of 53.6 gpm	_ at <u>42 psi</u> at the	e base of the riser.
Hose stream allowance of	is included in the	e above.		
Occupancy classification: Reside	ntial		Number of head	s flowing: 4
Commodity classification:		System Type:	Wet	
Maximum storage height:			Maximum veloci	ty: 13.24 ft/s
Storage arrangement:				
Flow from In-Rack sprinklers:	0 gpm	Pressure Required a	at Source: 42 p	si
Flow from Overhead sprinklers:	53.6 gpm	Pressure Available a		
Flow from Inside Hoses:	0 gpm	Surplus Pressure at		
Flow from Outside Hoses:	0 gpm	•	•	
Other fixed flows:	0 gpm			
Total flow in system piping:	53.6 gpm			
Additional flow at/beyond source	e:100 gpm			


153.6 gpm

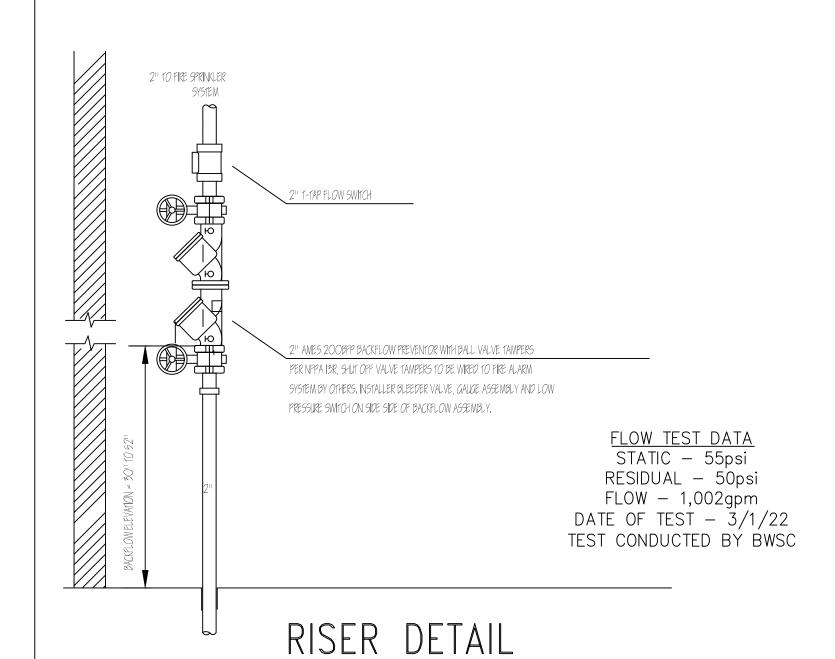

SCALE: NTS

HEAD BLOCK

SYM	CNT	POSITION	FINISH	TEMP	K	NPT	SIN	MFG.	MDDEL#
	57	PEND	WHITE	155	4.90	1/2"	VK494	VIKING	FREEDOM
•	2	SIDEWALL	WHITE	155	4.20	1/2"	VK486	VIKING	FREEDOM
Å	7	SIDEWALL	WHITE	155	5,60	1/2"	VK156	VIKING	DRY

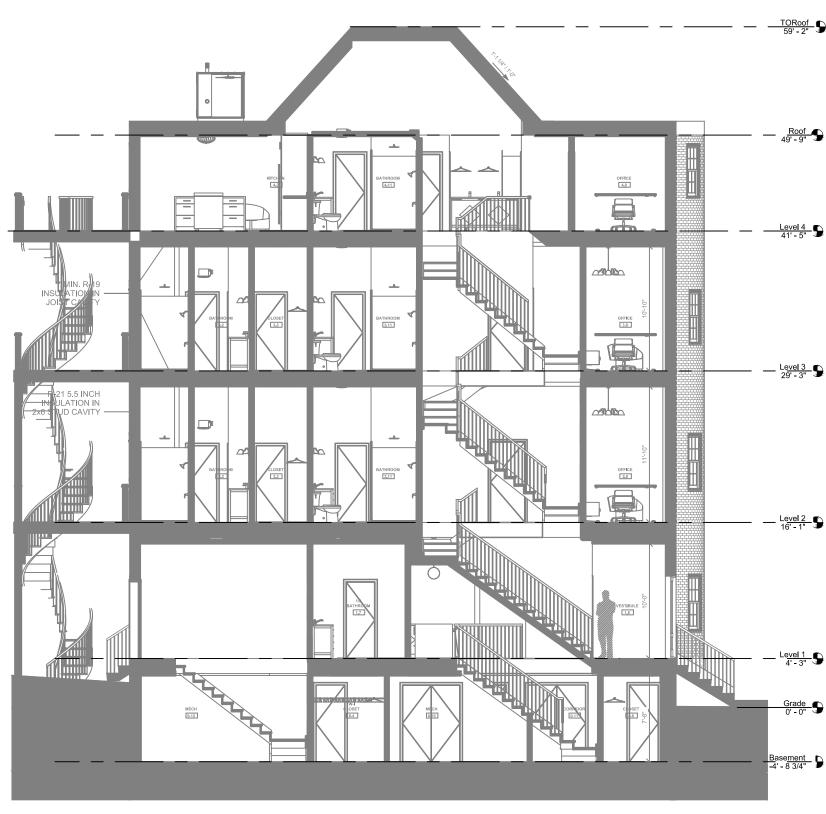


ELEVATION PLAN

GENERAL NOTES:

- THESE DRAWINGS ARE TIER 1 DRAWINGS ISSUED FOR THE PURPOSE OF OBTAINING A BUILDING LOCATIONS ARE SHOWN. INSTALLING CONTRACTOR SHALL DEVELOP FULLY COORDINATED TIER 2 DRAWINGS FOR SUBMITTAL AND APPROVAL BY OWNER, ARCHITECTURAL AND ENGINEERING TEAM.
- 2. REMOTE AREA 1 RESIDENTIAL 4th FLOOR WET PIPE HYDRAULICALLY CALCULATED PER NFPA 13R & MA STATE BUILDING CODE, 8TH EDITION OVER A FOUR SPRINKLER HEAD REMOTE AREA TO PROVIDE 13GPM @ 7PSI WITH SPRINKLERS SPACED AT 16'x'16' MAXIMUM WITH 100GPM OUTSIDE HOSE ALLOWANCE.
- REMOTE AREA 2 RESIDENTIAL 4th FLOOR RAISED CEILING WET PIPE HYDRAULICALLY CALCULATED PER NFPA 13R & MA STATE BUILDING CODE, 8TH EDITION OVER A TWO SPRINKLER HEAD REMOTE AREA TO PROVIDE 12GPM @ 9PSI WITH SIDEWALL SPRINKLERS SPACED AT 14'x'14' MAXIMUM WITH 100GPM OUTSIDE HOSE ALLOWANCE.
- REMOTE AREA 3 RESIDENTIAL 3rd FLOOR WET PIPE HYDRAULICALLY CALCULATED PER NFPA 13R & MA STATE BUILDING CODE, 8TH EDITION OVER A FOUR SPRINKLER HEAD REMOTE AREA TO PROVIDE 13GPM @ 7PSI WITH SPRINKLERS SPACED AT 16'x'16' MAXIMUM WITH 100GPM OUTSIDE HOSE ALLOWANCE.
- 3. INSTALLING CONTRACTOR TO PRODUCE FIRE PROTECTION PLANS AND HYDRAULIC CALCULATIONS FOR TIER 2 SUBMITTAL. THE CONTRACTOR SHALL FOR, SECURE AND PAY FOR ALL PERMITS, FEES AND APPROVALS REQUIRED. CONTRACTOR SHALL BEAR RESPONSIBILITY FOR ANY ADDITIONAL ITEMS REQUIRED BY ANY AUTHORITY HAVE JURISDICTIONS.
- 4. INSTALLING CONTRACTOR SHALL COMPLETE A CURRENT HYDRANT FLOW TEST AND MAKE ANY/ALL ADJUSTMENTS BASED ON DEGRADATION OF WATER SOURCE SINCE FLOW PROVIDED BY BWSC.
- 5. SPRINKLER SYSTEM SHALL BE INSTALLED AND TESTED IN ACCORDANCE WITH NFPA 13R, BOSTON FIRE PREVENTION, THE MA BUILDING CODE, 9TH EDITION AND ANY OTHER APPLICABLE AUTHORITIES.
- 6. CONTRACTOR SHALL BE RESPONSIBLE FOR ALL COORDINATION AND FINAL PIPING LAYOUT AND DIMENSIONS. INCLUDING LOCATION AND QUANTITY OF SPRINKLER HEADS AND/OR PIPING
- 7. OCCUPANCY IS RESIDENTIAL
- 8. PIPING SCHEDULE:
 - ALL EXPOSED PIPING SHALL BE BLK. STEEL SCHEDULE 10 OR SCHEDULE 40 WITH
 - THREADED OR GROOVED FITTINGS. - ALL CONCEALED PIPING SHALL BE CPVC PIPE WITH CPVC FITTINGS (BLAZEMASTER OR EQUIVALENT)

8. SPRINKLER HEADS.

- 8.1. SPRINKLER HEADS SHALL BE QUICK RESPONSE OR RESIDENTIAL TYPE 155°F UNLESS NOTED
- 8.2. SPRINKLER HEAD SHALL BE FULLY CONCEALED TYPE WITH WHITE COVER PLATES. 8.3. SPRINKLER PROTECTION SHALL BE OMITTED IN CLOTHES CLOSETS, LINEN CLOSETS AND PANTRIES THAT DO NOT EXCEED 24 SF, THE LEAST DIMENSION DOES NOT EXCEED 3'-0" AND THE WALLS AND
- CEILINGS ARE SURFACED WITH NON-COMBUSTIBLE OR LIMITED COMBUSTIBLE MATERIALS. 8.4. SPRINKLERS SHALL NOT BE REQUIRED IN ATTICS, CRAWL SPACES AND OTHER CONCEALED SPACES THAT ARE NOT USED OR INTENDED FOR LIVING PURPOSES.
- 9. IT IS THE OWNERS RESPONSIBILITY TO MAINTAIN A TEMPERATURE AT OR ABOVE 40°F IN AREAS WITH WATER FILLED SPRINKLER PIPING.

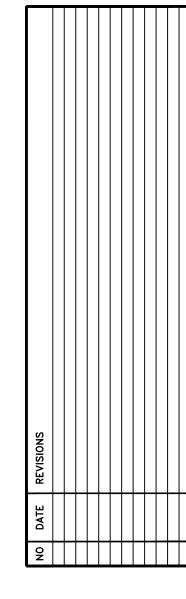





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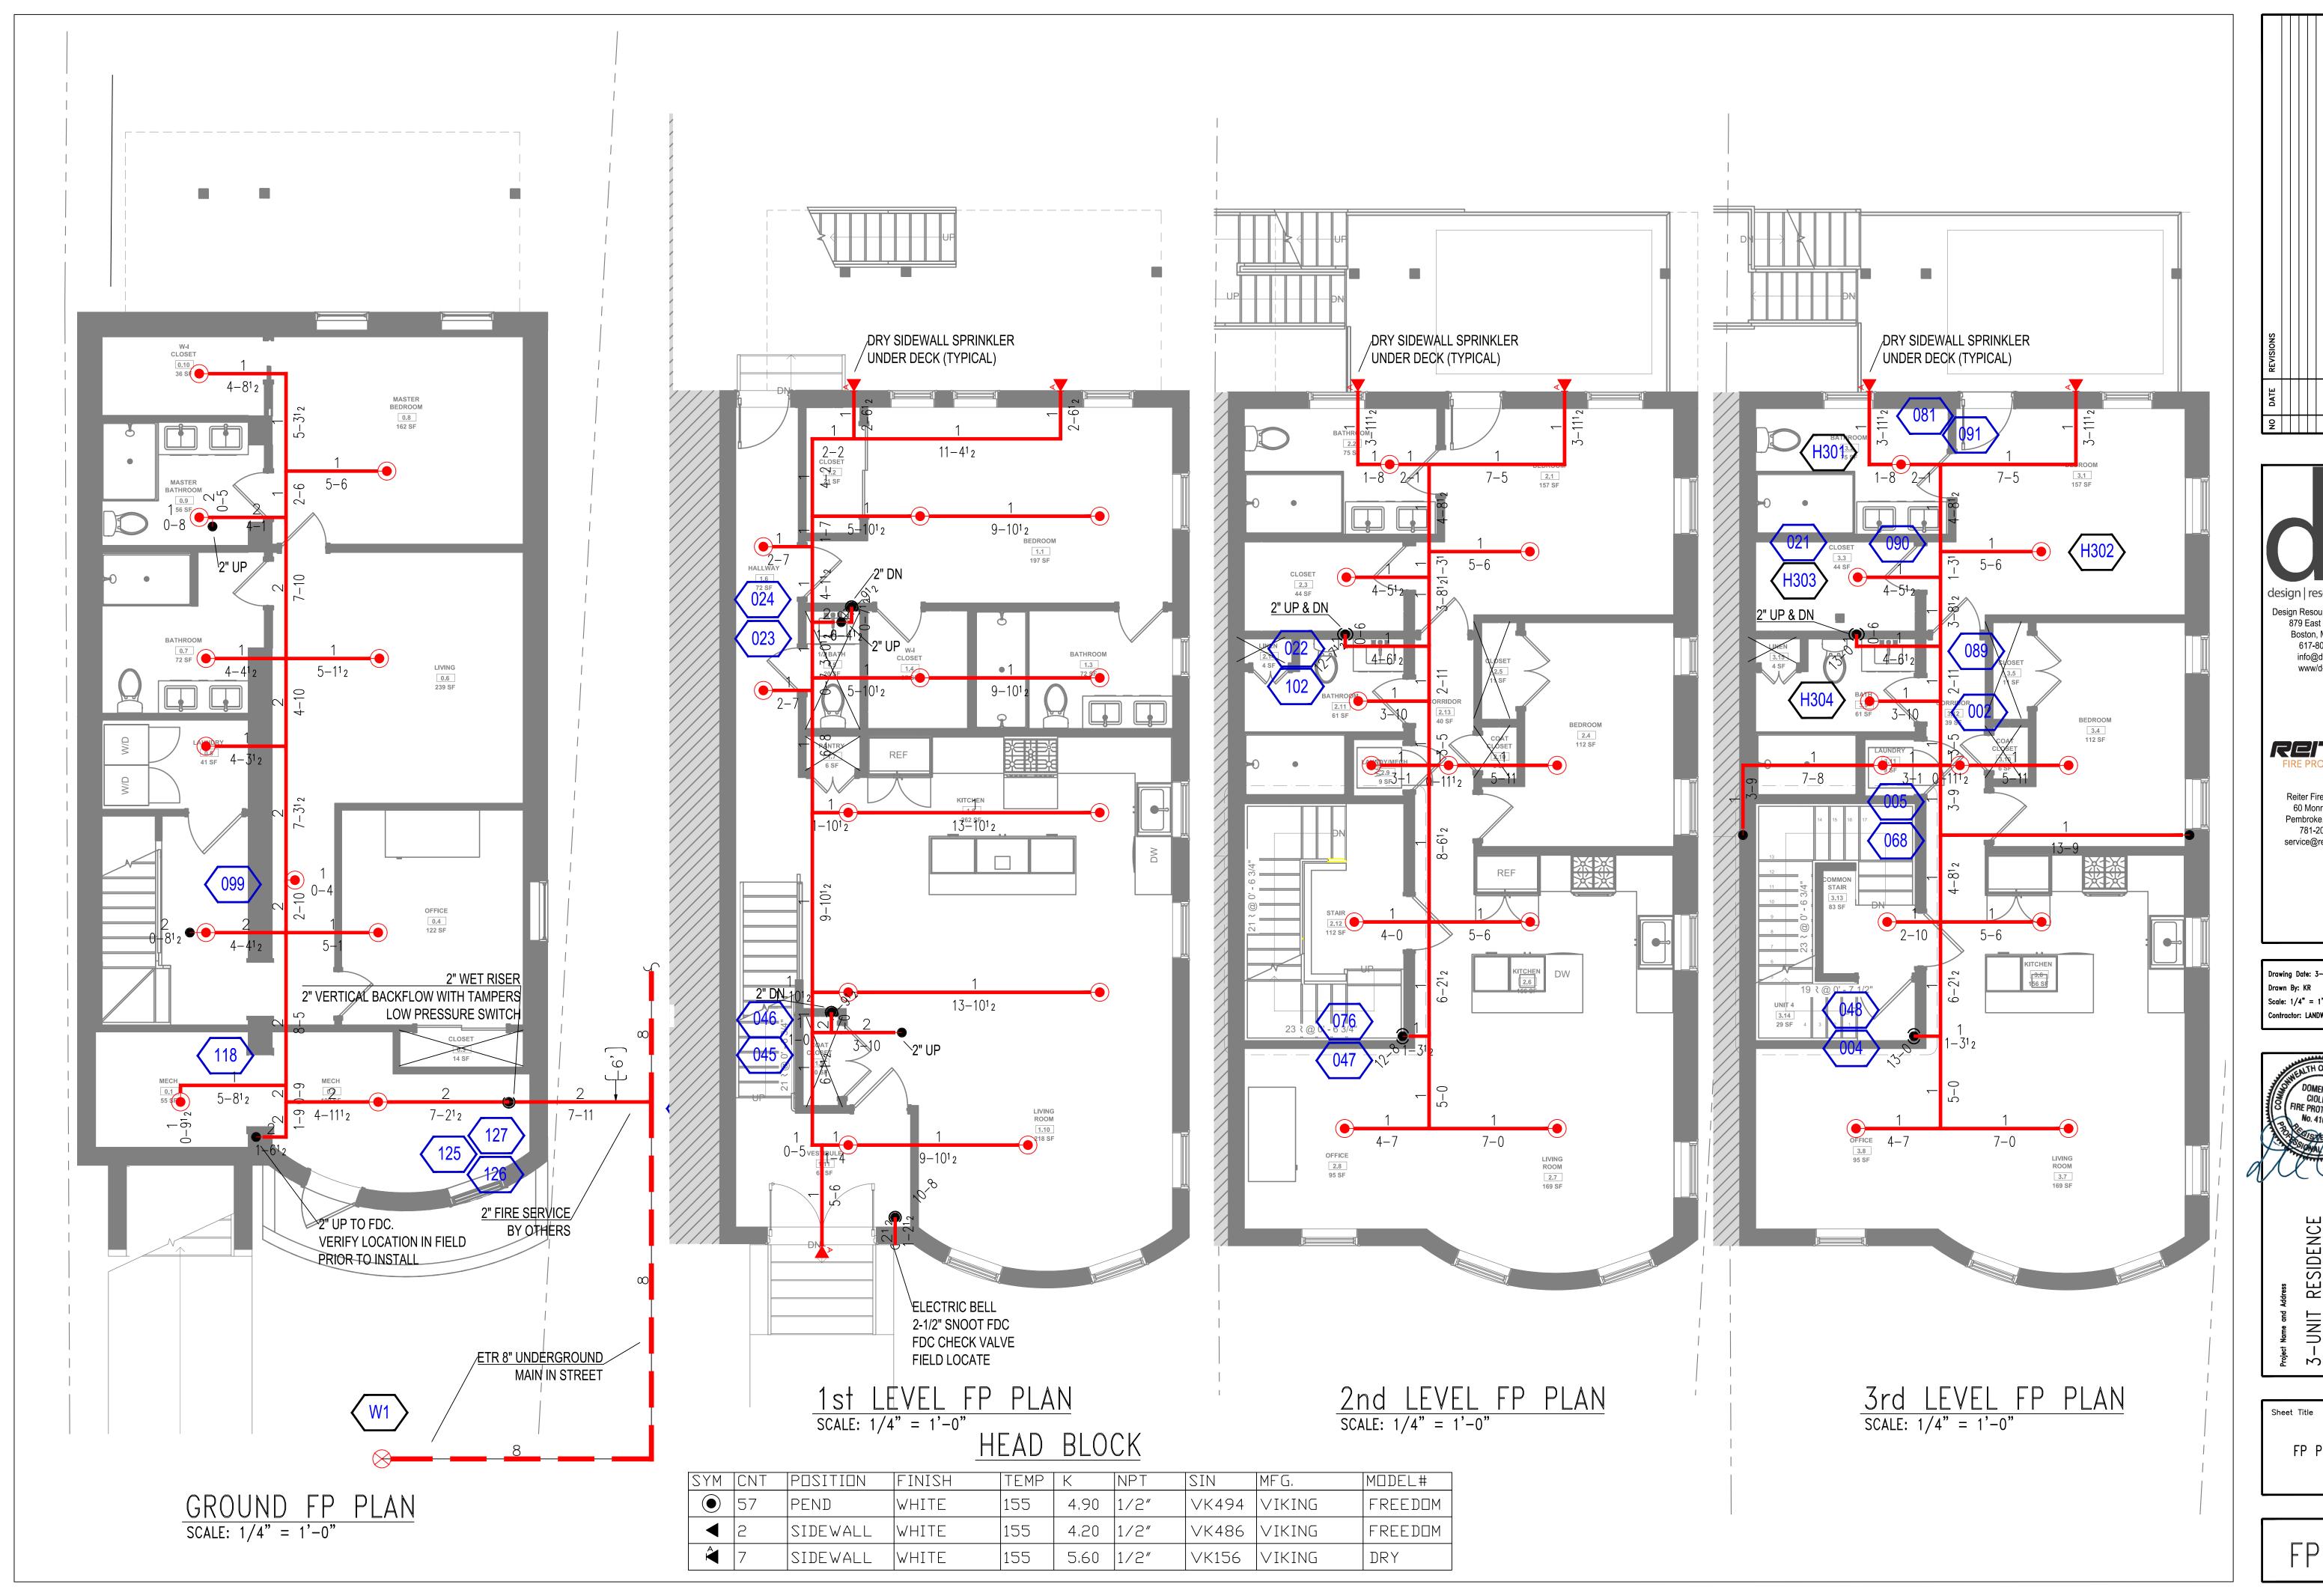
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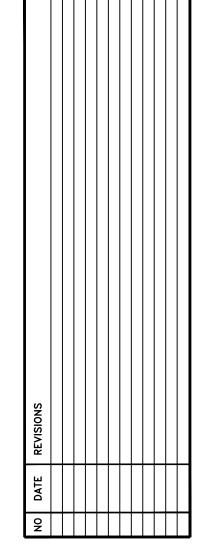


3-UNIT RESIDENCE 8 MONUMENT SQUARE BOSTON, MA

Sheet Title NOTES & DETAILS

FP-0





design | resource | team Design Resource Team, LLC 879 East Broadway Boston, MA 02127 617-804-6117 info@d-r-t.com www/d-r-t/com REITER Reiter Fire Protection 60 Monroe Street Pembroke, MA 02359 781-205-9440 service@reiterfire.com


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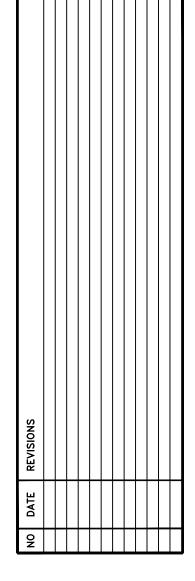


3-UNIT RESIDENCE 8 MONUMENT SQUARE BOSTON, MA

FP PLANS

FP-1



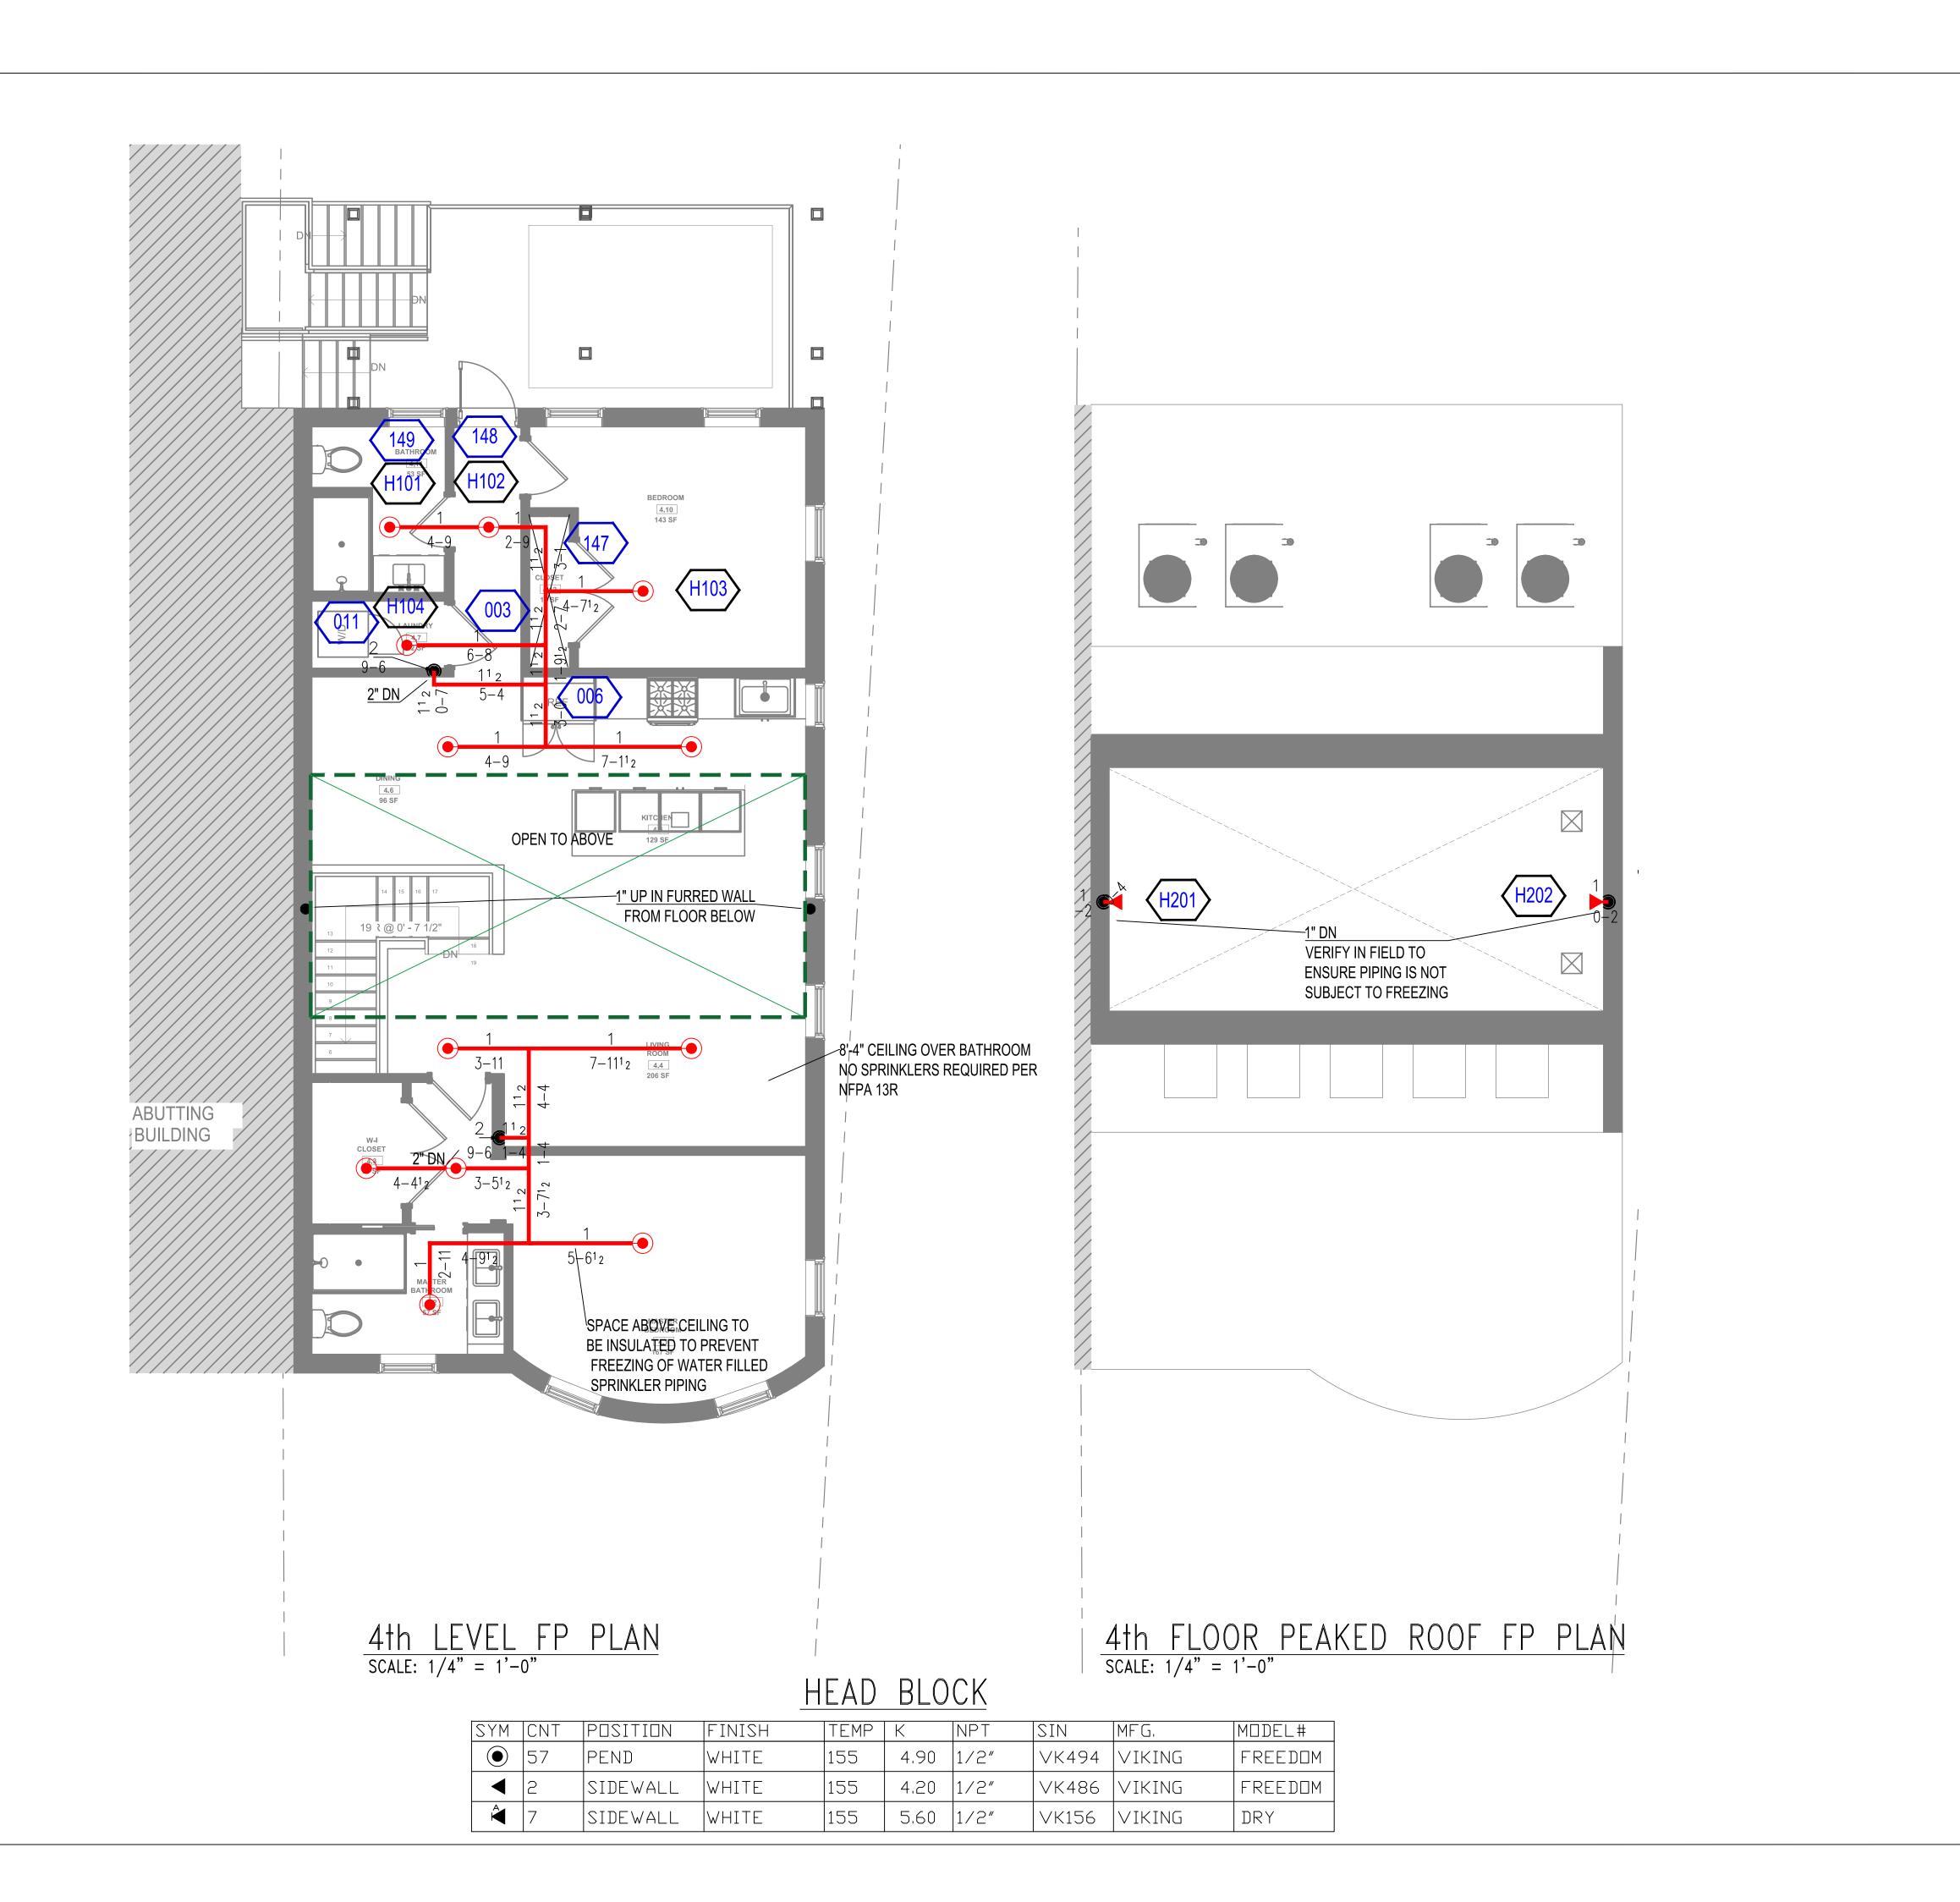




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Drawn By: KR

Scale: 1/4" = 1'-0"

Contractor: LANDWORDS LLC

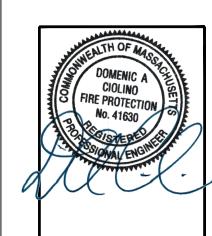

Project Name and Address

3-UNIT RESIDENCE

8 MONUMENT SQUARE

BOSTON, MA

Sheet Title
FP PLANS

FP-2