BOSTON WATER AND SEWER COMMISSION
Reviewed and approved as to proposed connection(s) to existing Water and Sewer facilities as shown, for Issue of Building Permit Only. Additional Permits must be obtained from BWSC prior to Connection to BWSC facilities. Site Plans are valid for a period of one (1) year from date of approval.
JOHN P. SULLIVAN, JR. P.E.
Chief Engineer
POSTONI WATER & SEWER COMMISSION
BOSTON WATER & SEWER COMMISSION
Cross Connection
Approval: Date:

BOST	ON WATE	R & SEWER COMMISSION	
ıckwater rain)	Valve	Installation	
proval:		Date:	

ALL WATER. SEWER AND DRAIN SERVICE CONNECTIONS TO BOSTON WATER AND SEWER COMMISSION FACILITIES MUST BE PERFORMED BY A BONDED DRAIN LAYER LICENSED BY THE BOSTON WATER AND SEWER COMMISSION

Discharge Enforcement

| Approval:

RESERVED FOR BWSC USE ONLY

LEGEND				
— а —	PROPOSED DRAIN LINE			
S	SEWER MANHOLE			
	EXISTING WATER LINE			
—— G ——	EXISTING GAS LINE			
D	UTILITY POLE			
GV ⊠	GAS VALVE			
—— Е ——	OVERHEAD ELECTRIC SERVICE			
wv 	WATER VALVE			
	CATCH BASIN			
<u> </u>	FENCE			
205	CONTOUR LINE (MJR)			
— — —195— — —	CONTOUR LINE (MNR)			
¹⁹⁵ X	SPOT GRADE			
0	DRAIN MANHOLE			
X	HYDRANT			
	TREE			
	RETAINING WALL			

Calculations by: MI Date: 11/22/2024

STORMWATER MANAGEMENT CALCULATIONS **SYSTEM (PAVEMENT)**

Design Criteria: Impervious Roof = 2,324.42 SF Impervious Pavement = 765.45 SF Total = 3089.87SFDesign For 1" Rainstorm Lot Size: 10,000 SF

Storage Volume Required: $V_R = (1"/12) (3089.87 \text{ SF}) = 257.48 \text{ CF}$

CAPACITY OF PROPOSED STORM TECH SYSTEM

Storage Capacity of single Storm Tech UNIT = 49 CF

Void Ratio =0.3

Total Volume= (11'x 7.0 x 4.0'depth (2.5ft for Storm Tech unit) 3 UNITS) = 924 CF

Storage Capacity for 3 UNITS = 147 CF Storage Capacity in Crushed Stone = (Total Volume – Capacity of Units) x Void Ratio =

 $(924-147) \times 0.3 = 233.1 \text{ CF}$ Total Storage Provided = Capacity in Crushed Stone + Total Capacity in Units =

233.1 CF + 147 CF = 380.1 CF

Since Total Storage Provided (380.1 CF) > Total Storage Required (257.48 CF/D) Therefore, utilize 3-Storm-Tech Chamber with 1.0 ft. of Crushed Stone Beneath to Contain 1" Storm Event

		GRA	APHIC SC	ALE
10 	o :	5 1 I I	0 2 I	0 I
		1	(IN FEET) inch = 10 f	't.

1" WATER LINE	(4) TRENCH DRAIN W/ 18" SU
DATE:	DATE:
INSPECTOR:	INSPECTOR:

(2) 6" PVC SEWER LINE

DATE: ____

DATE: ____

INSPECTOR:_

INSPECTOR:_

(3) DYE TEST (SEWER)

EXISTING D.M.F

ولا<u>V=168.93</u>

EXISTING S.M.H.

RIM = 177.21

INV=167.53

SMH STA


0+04.5

(5) PROPOSED CLEANOUT (3)

(6) INFILTRATION SYSTEM DATE: _____ INSPECTOR:__

(7) AS BUILT PREPARATION FEE DATE: _____ INSPECTOR: _____

LOCUS MAP

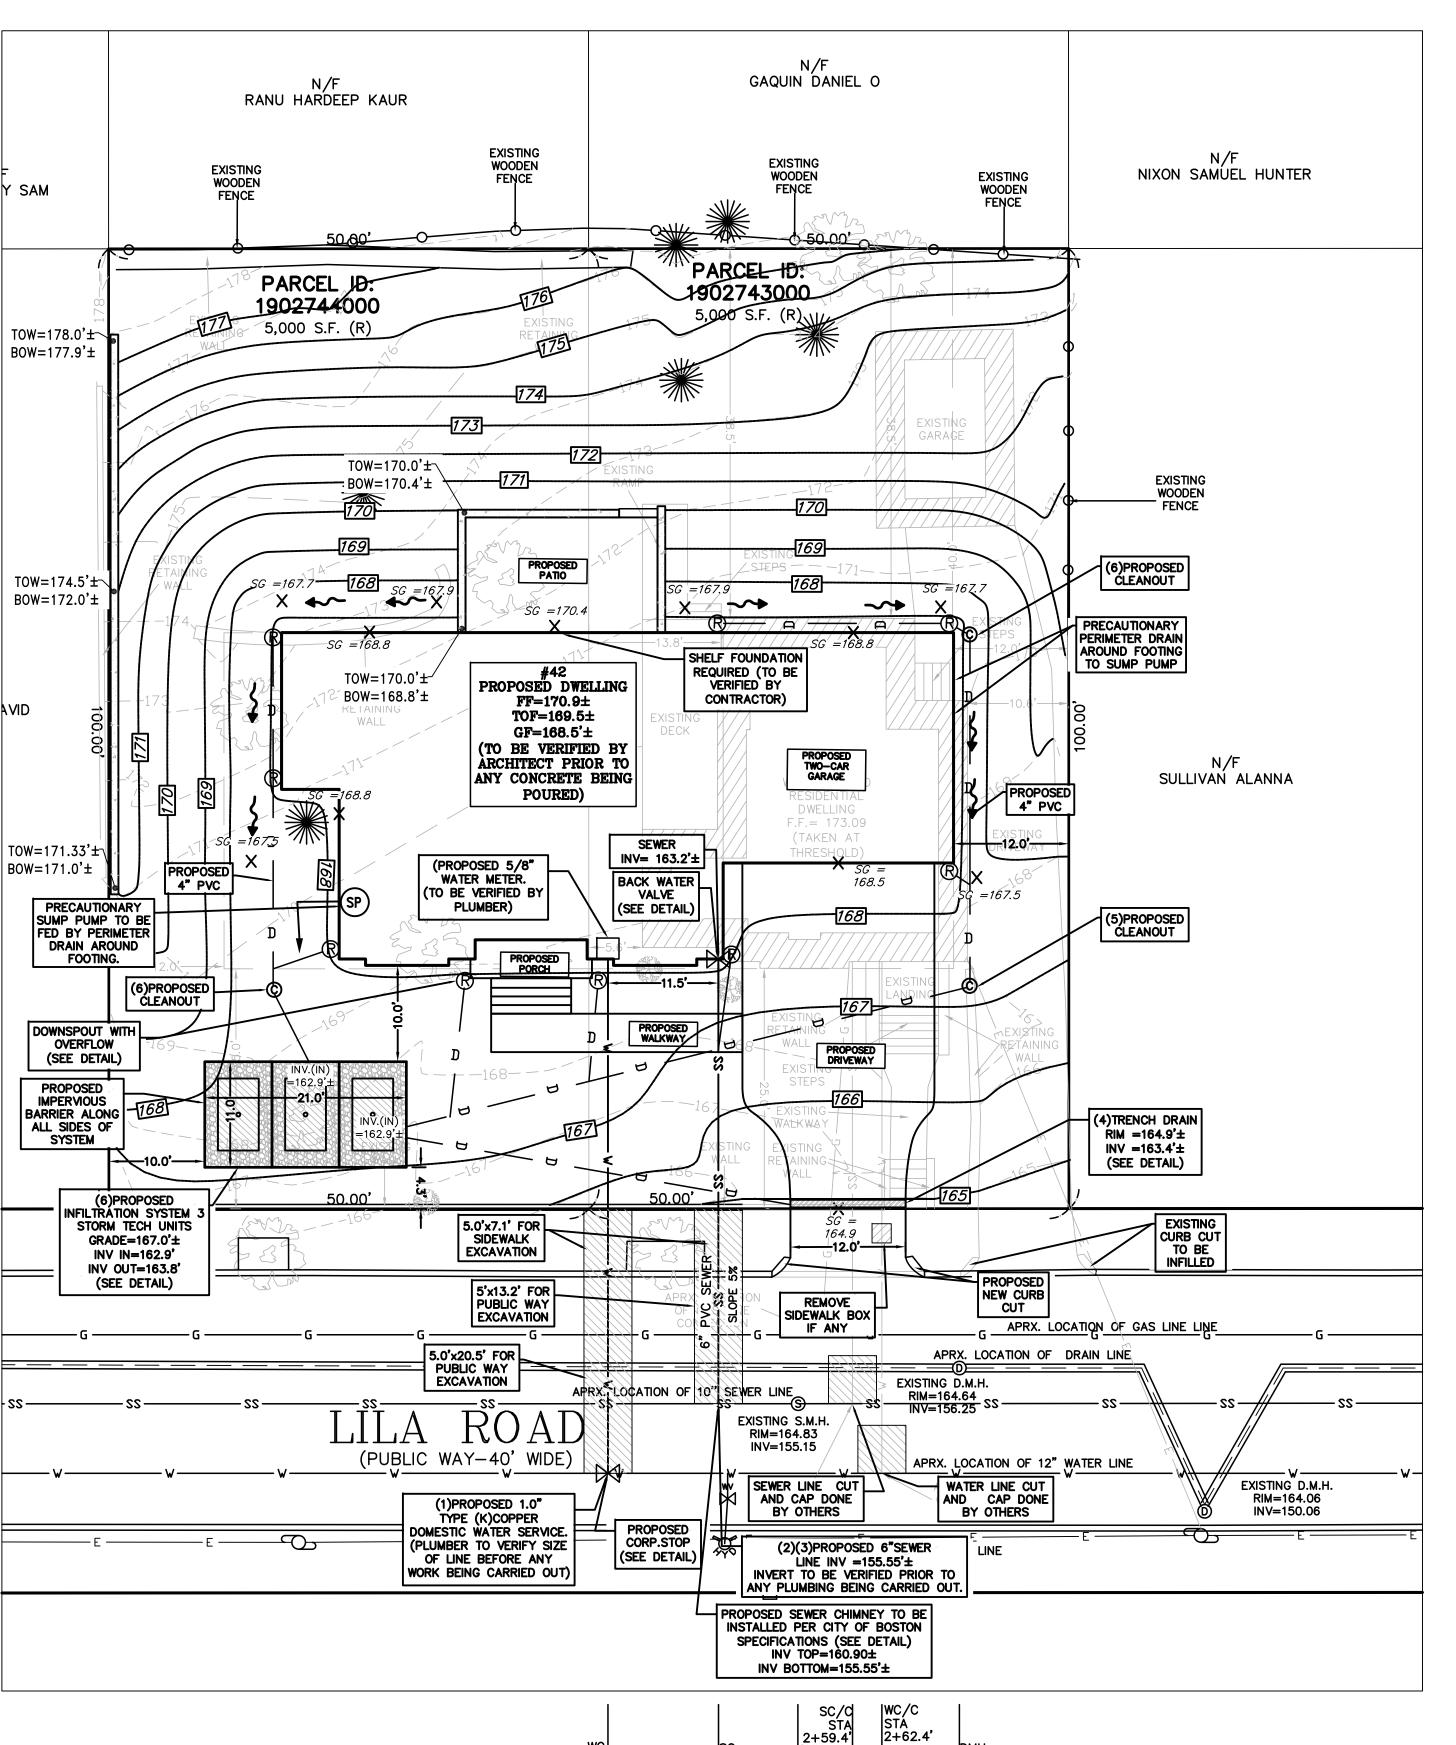

2+62.4

2+33.9

CONSTRUCTION NOTES

1. THE CONTRACTOR SHALL REPORT TO THE OWNER AND ENGINEER OF ANY SIGNIFICANT VARIATIONS IN EXISTING SITE CONDITIONS FROM THOSE SHOWN ON THESE PLANS. ANY PROPOSED REVISIONS TO THE WORK, IF REQUIRED BY THESE SITE CONDITIONS, SHALL NOT BE UNDERTAKEN UNTIL REVIEWED AND APPROVED BY THE OWNER AND THE ENGINEER.

2. IN ORDER TO PROTECT THE PUBLIC SAFETY DURING CONSTRUCTION, THE CONTRACTOR I RESPONSIBLE FOR INSTALLING AND MAINTAINING AT ALL TIMES ALL NECESSARY SAFETY DEVICES AND PERSONNEL, WARNING LIGHTS, BARRICADES, AND POLICE OFFICERS.

3. ALL WORK SHALL CONFORM TO CITY OF BOSTON GENERAL CONSTRUCTION STANDARDS. 4. THE CONTRACTOR SHALL REGULARLY INSPECT THE PERIMETER OF THE PROPERTY TO CLEAN UP AND REMOVE LOOSE CONSTRUCTION DEBRIS BEFORE IT LEAVES THE SITE. ALL

DEMOLITION DEBRIS SHALL BE PROMPTLY REMOVED FROM THE SITE TO A LEGAL DUMP SITE

5. IT SHALL BE THE RESPONSIBILITY OF THE CONTRACTOR TO INSTITUTE EROSION CONTROL MEASURES ON AN AS NECESSARY BASIS, SUCH THAT EXCESSIVE SOIL EROSION DOES NOT

ALL TRUCKS LEAVING THE SITE SHALL BE COVERED.

- 6. THE LOCATION OF UNDERGROUND UTILITIES AS REPRESENTED ON THESE PLANS IS BASED UPON PLANS AND INFORMATION PROVIDED BY THE RESPECTIVE UTILITY COMPANIES OR MUNICIPAL DEPARTMENTS SUPPLEMENTED BY FIELD IDENTIFICATION WHEREVER POSSIBLE. NO WARRANTY IS MADE AS TO THE ACCURACY OF THESE LOCATIONS OR THAT ALL UNDERGROUND UTILITIES ARE SHOWN. THE CONTRACTOR SHALL CONTRACT DIG SAFE AT LEAST 72 HOURS PRIOR TO THE START OF CONSTRUCTION. DIG SAFE TELEPHONE NUMBER IS 1-800-322-4844.
- 7. THE CONTRACTOR SHALL VERIFY THE LOCATION, SIZE AND DEPTH OF EXISTING UTILITIES PRIOR TO TAPPING INTO, CROSSING OR EXTENDING THEM. IF THE NEW WORK POSES A CONFLICT WITH EXISTING UTILITIES, THE ENGINEER SHALL BE NOTIFIED PRIOR TO THE CONTRACTOR CONTINUING.
- 8. NO LEDGE, BOULDERS, OR OTHER UNYIELDING MATERIALS ARE TO BE LEFT WITHIN 6" OF THE WATER IN THE TRENCH, NOR ARE THEY TO BE USED FOR BACKFILL FOR THE FIRST 12"
- 9. PAVEMENT AREA SHALL BE PAVED TO A THICKNESS AS SHOWN ON THE PLANS MEASURED AFTER COMPACTION, WITH A BINDER COURSE AND TOP COURSE OF CLASS I BITUMINOUS CONCRETE PAVEMENT, TYPE I-1.
- 10. BASE MATERIAL SHALL BE CLEAN BANK RUN GRAVEL, CONFORMING TO M.D.P.W. M1.03.1 WITH NO STONES LARGER THAN THREE (3) INCHES IN DIAMETER AND SHALL BE PLACED AND ROLLED WITH AT LEAST A TEN TON ROLLER. THE SURFACES SHALL BE WET DURING ROLLING TO BIND THE MATERIAL. ALL STONES OF 4" DIAMETER OR LARGER SHALL BE REMOVED FROM THE SUB-BASE PRIOR TO PLACING BASE MATERIAL.
- 11. ALL EXISTING PAVING TO BE DISTURBED SHALL BE CUT ALONG A STRAIGHT LINE THROUGH ITS ENTIRE THICKNESS. BUTT THE NEW PAVING INTO THE EXISTING PAVEMENT TO
- 12. ANY PAVEMENT REMOVED FOR UTILITY TRENCH EXCAVATION OR OTHERWISE DAMAGED DURING CONSTRUCTION SHALL BE REPLACED WITH A PAVEMENT SECTION CONSISTING OF 1 1/2" WEAR COURSE OVERLYING A 1/2" BINDER COURSE OVERLYING A 12" COMPACTED GRAVEL BASE COURSE.
- 13. THE CONTRACTOR SHALL APPLY FOR A STREET OPENING AND UTILITY CONNECTION PERMITS AND SIDEWALK CROSSING PERMIT WITH THE CITY OF BOSTON DPW.
- 14. A PREREQUISITE FOR FILING A GENERAL SERVICE APPLICATION WITH THE BOSTON WATER AND SEWER COMMISSION FOR NEW CONSTRUCTION IS THE ROUGH CONSTRUCTION SIGN-OFF DOCUMENT FROM THE CITY OF BOSTON'S INSPECTIONAL SERVICES DEPARTMENT.
- 15. THE OWNER IS RESPONSIBLE TO MAINTAIN THE DRAINAGE SYSTEM FOR PROPER OPERA INCLUDING KEEPING THE DRAIN FREE FROM DEBRIS AND ICE BLOCKAGE.

- 1. INFORMATION SHOWN ON THIS PLAN IS THE RESULT OF A FIELD SURVEY PERFORMED BY PETER NOLAN & ASSOCIATES LLC AS OF 06/22/2023.
- 2. DEED REFERENCE: BOOK 68410 PAGE 114 PLAN REFERENCE 1: BOOK 4831 PAGE 423
- SUFFOLK COUNTY DISTRICT REGISTRY OF DEEDS 3. THIS PLAN IS NOT INTENDED TO BE RECORDED
- 4. I CERTIFY THAT THE DWELLING SHOWN IS NOT LOCATED WITHIN A SPECIAL FLOOD HAZARD ZONE. IT IS LOCATED IN ZONE X, ON FLOOD HAZARD BOUNDARY MAP NUMBER 25025C0067G, IN COMMUNITY NUMBER: 250286, DATED 9/25/2009.
- 5. THIS PLAN DOES NOT SHOW ANY UNRECORDED OR UNWRITTEN EASEMENTS WHICH MAY EXIST. A REASONABLE AND DILIGENT ATTEMPT HAS BEEN MADE TO OBSERVE ANY APPARENT USES OF THE LAND; HOWEVER THIS NOT CONSTITUTE A GUARANTEE THAT NO SUCH EASEMENTS EXIST.
- 6. FIRST FLOOR ELEVATIONS ARE TAKEN AT THRESHOLD.
- 7. NO RESPONSIBILITY IS TAKEN FOR ZONING TABLE AS PETER NOLAN & ASSOCIATES LLC ARE NOT ZONING EXPERTS. TABLE IS TAKEN FROM TABLE PROVIDED BY LOCAL ZONING ORDINANCE. CLIENT AND/OR ARCHITECT TO VERIFY THE ACCURACY OF ZONING ANALYSIS.
- 8. THE ELEVATIONS SHOWN ARE ON CITY OF BOSTON DATUM.
- 9. ZONING DISTRICT: JAMAICA PLAIN NEIGHBORHOOD, ZONING SUBDISTRICT:

 \sim CONTRACTOR TO CONFIRM LOCATION OF DOWN SPOU PRIOR TO CARRYING OU ANY DRAINAGE WORKS SURFACE WATER TO BE DIVERTED FROM ALL SIDES OF FOUNDATION WALL BUILDING OWNER IS RESPONSIBLE FOR THE MAINTENANCE OF THE STORM WATER SYSTEM, TO BE INSPECTED A MINIMUM OF ONCE EVERY 3 MONTHS AND CLEANED A MINIMUM OF ONCE EVERY 6 MONTHS.

PROPOSED SHELF FOUNDATION WHERE NEEDED

0 BEDROOMS 2ND FLOOR 4 BEDROOMS


UNIT SUMMARY

1ST FLOOR

* PER TITLE V, SEWER FLOW RESIDENTIAL 440 G.P.D, (4 BEDROOMS x 110 G.P.D.) =440 G.P.D. (TOTAL SEWER FLOW)

OWNERS INFORMATION:

DOUGLAS AND AMY McCLENNEN 61 LILA ROAD, BOSTON MA 02130 DOUGLAS McCLENNEN 508-237-2316 PARCEL ID= 1902743000 PARCEL ID= 1902744000 ASSESSORS PLAN WARD: 19 LAND USE CODE: R1 (1 FAMILY) WATER ACCOUNT NUMBER: 1611288 COBUCS: 1733299290672 SITEPLAN: 23416

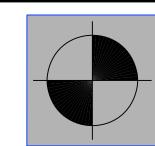

LAND SURVEYORS/CIVIL

80 JEWETT ST, (SUITE 1)

Tel:857-891-7478

617-782-1533

Fax:617-2025691

NEWTON, MA 02458

SPRUHAN ENGINEERING, P.C. PETER NOLAN & ASSOCIATES, LLC

ENGINEERING CONSULTANTS 80 JEWETT ST, (SUITE 1) NEWTON, MA 02458 Tel: 617-816-0722 Email:edmond@spruhaneng.com



42 LILA ROAD, JAMAICA PLAIN, *MASSACHUSETTS*

CIVIL PLAN

REVISION BLOCK

DATE

DESCRIPTION

ΠΟΝ		

limited to, copyright and design patent rights, in the designs, arrangements and plans shown on this document are the property of Peter Nolan & Associates, LLC, or Spruhan Engineering, P.C. They may not be used or reused in whole or in part, except in connection with this project, without the prior written consent of Spruhan Engineering, dimensions on these drawings shall have precedence over dimensions. Contractors shall verify and be responsible dimensions and conditions on this project, and Spruhan Engineering, P.C., must be notified of any variation from the dimensions and conditions shown by drawings.

All legal rights including, but not


DATE:	12/04/2024
DRAWN BY:	M.L
CHECKED BY:	E.S
APPROVED BY:	P.N

PLAN TO ACCOMPANY BWSC APPLICATION

SHEET 1 OF 2

ACCEPTABLE FILL MATERIALS: STORMTECH SC-740 CHAMBER SYSTEMS AASHTO MATERIAL COMPACTION / DENSITY MATERIAL LOCATION DESCRIPTION CLASSIFICATIONS REQUIREMENT FINAL FILL: FILL MATERIAL FOR LAYER 'D' STARTS FROM THE TOP OF THE 'C' LAYER TO THE BOTTOM OF FLEXIBLE PAVEMENT OR UNPAVED FINISHED GRADE ABOVE. NOTE THAT PAVEMENT SUBBASE MAY PLANS. CHECK PLANS FOR PAVEMENT SUBGRADE REQUIREMENTS. PREPARE PER SITE DESIGN ENGINEER'S PLANS. PAVED INSTALLATIONS MAY HAVE STRINGENT MATERIAL AND PREPARATION REQUIREMENTS. N/A BE PART OF THE 'D' LAYER BEGIN COMPACTIONS AFTER 12" (300 mm) OF AASHTO M1451 MATERIAL OVER THE CHAMBERS IS REACHED. A-1, A-2-4, A-3 COMPACT ADDITIONAL LAYERS IN 6" (150 mm) MAX LIFTS TO A MIN. 95% PROCTOR DENSITY FOR WELL INITIAL FILL: FILL MATERIAL FOR LAYER 'C' STARTS GRANULAR WELL-GRADED SOIL/AGGREGATE MIXTURES, <35% FROM THE TOP OF THE EMBEDMENT STONE ('B' FINES OR PROCESSED AGGREGATE. GRADED MATERIAL AND 95% RELATIVE DENSITY FOR LAYER) TO 18" (450 mm) ABOVE THE TOP OF THE CHAMBER. NOTE THAT PAVEMENT SUBBASE MAY BE MOST PAVEMENT SUBBASE MATERIALS CAN BE USED IN LIEU VEHICLE WEIGHT NOT TO EXCEED 12,000 lbs (53 , 357, 4, 467, 5, 56, 57, 6, 67, 68, 78, 8, 89, 9, 10 A PART OF THE 'C' LAYER. kN). DYNAMIC FORCE NOT TO EXCEED 20,000 lbs EMBEDMENT STONE: FILL SURROUNDING THE AASHTO M43¹ 3, 357, 4, 467, 5, 56, 57 CHAMBERS FROM THE FOUNDATION STONE ('A' NO COMPACTION REQUIRED. CLEAN, CRUSHED, ANGULAR STONE LAYER) TO THE 'C' LAYER ABOVE. FOUNDATION STONE: FILL BELOW CHAMBERS FROM AASHTO M43¹ 3, 357, 4, 467, 5, 56, 57 PLATE COMPACT OR ROLL TO ACHIEVE A FLAT SURFACE. 2 3 CLEAN, CRUSHED, ANGULAR STONE THE SUBGRADE UP TO THE FOOT (BOTTOM) OF THE PLEASE NOTE: 1. THE LISTED AASHTO DESIGNATIONS ARE FOR GRADATIONS ONLY. THE STONE MUST ALSO BE CLEAN, CRUSHED, ANGULAR. FOR EXAMPLE, A SPECIFICATION FOR #4 STONE WOULD STATE: "CLEAN, CRUSHED, ANGULAR NO. 4 (AASHTO M43) STONE".


- 2. STORMTECH COMPACTION REQUIREMENTS ARE MET FOR 'A' LOCATION MATERIALS WHEN PLACED AND COMPACTED IN 6" (150 mm) (MAX) LIFTS USING TWO FULL COVERAGES WITH A VIBRATORY COMPACTOR.
- 3. WHERE INFILTRATION SURFACES MAY BE COMPROMISED BY COMPACTION, FOR STANDARD DESIGN LOAD CONDITIONS, A FLAT SURFACE MAY BE ACHIEVED BY RAKING OR DRAGGING WITHOUT COMPACTION EQUIPMENT. FOR SPECIAL LOAD DESIGNS, CONTACT STORMTECH FOR COMPACTION REQUIREMENTS.

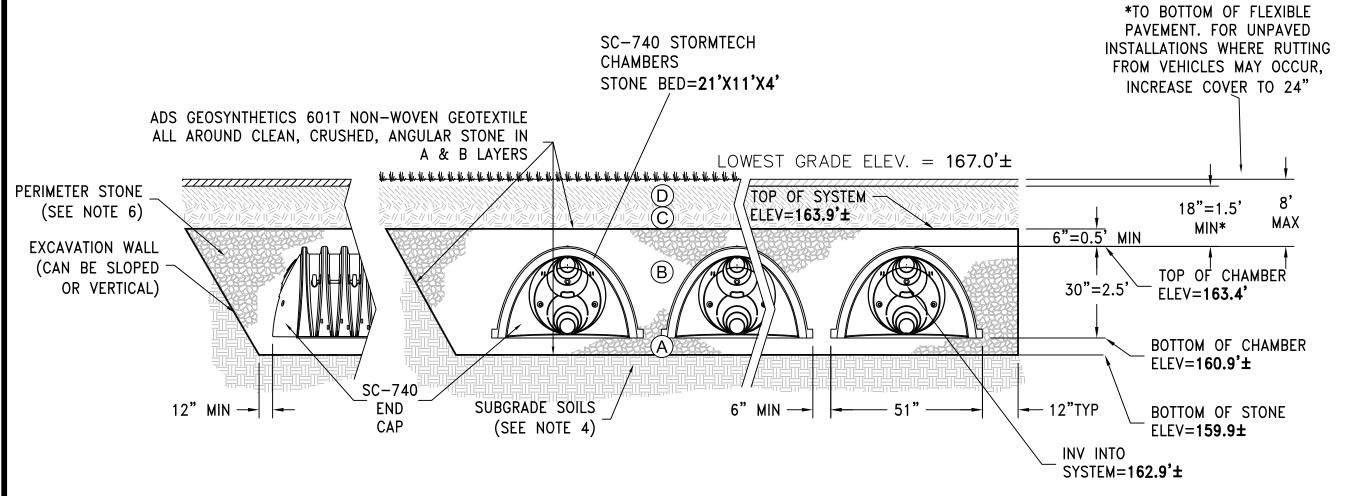


STORMTECH INFILTRATION SYSTEM


NOTES:


- SC-740 CHAMBERS SHALL CONFORM TO THE REQUIREMENTS OF ASTM F2418 "STANDARD SPECIFICATION FOR POLYPROPYLENE (PP) CORRUGATED WALL STORMWATER COLLECTION CHAMBERS", OR ASTM F2922 "STANDARD SPECIFICATION FOR POLYETHYLENE (PE) CORRUGATED WALL STORMWATER COLLECTION
- SC-740 CHAMBERS SHALL BE DESIGNED IN ACCORDANCE WITH ASTM F2787 "STANDARD PRACTICE FOR STRUCTURAL DESIGN OF THERMOPLASTIC CORRUGATED WALL STORMWATER COLLECTION CHAMBERS"
- "ACCEPTABLE FILL MATERIALS" TABLE ABOVE PROVIDES MATERIAL LOCATIONS, DESCRIPTIONS, GRADATIONS, AND COMPACTION REQUIREMENTS FOR FOUNDATION, EMBEDMENT, AND FILL MATERIALS.
- THE SITE DESIGN ENGINEER IS RESPONSIBLE FOR ASSESSING THE BEARING RESISTANCE (ALLOWABLE BEARING CAPACITY) OF THE SUBGRADE SOILS AND THE DEPTH OF FOUNDATION STONE WITH CONSIDERATION FOR THE RANGE OF EXPECTED SOIL MOISTURE CONDITIONS.
- 5. PERIMETER STONE MUST BE EXTENDED HORIZONTALLY TO THE EXCAVATION WALL FOR BOTH VERTICAL AND SLOPED EXCAVATION WALLS.
- ONCE LAYER 'C' IS PLACED, ANY SOIL/MATERIAL CAN BE PLACED IN LAYER 'D' UP TO THE FINISHED GRADE. MOST PAVEMENT SUBBASE SOILS CAN BE USED TO REPLACE THE MATERIAL REQUIREMENTS OF LAYER 'C' OR 'D' AT THE SITE DESIGN ENGINEER'S DISCRETION.

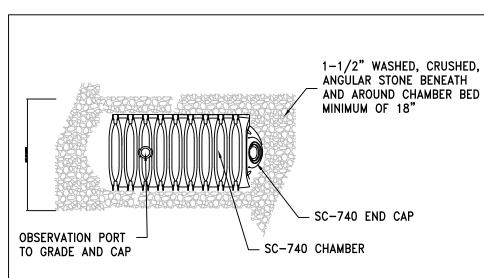



STORMTECH SC-740 CHAMBER SYSTEM <u>PLAN VIEW DETAIL</u> N.T.S.

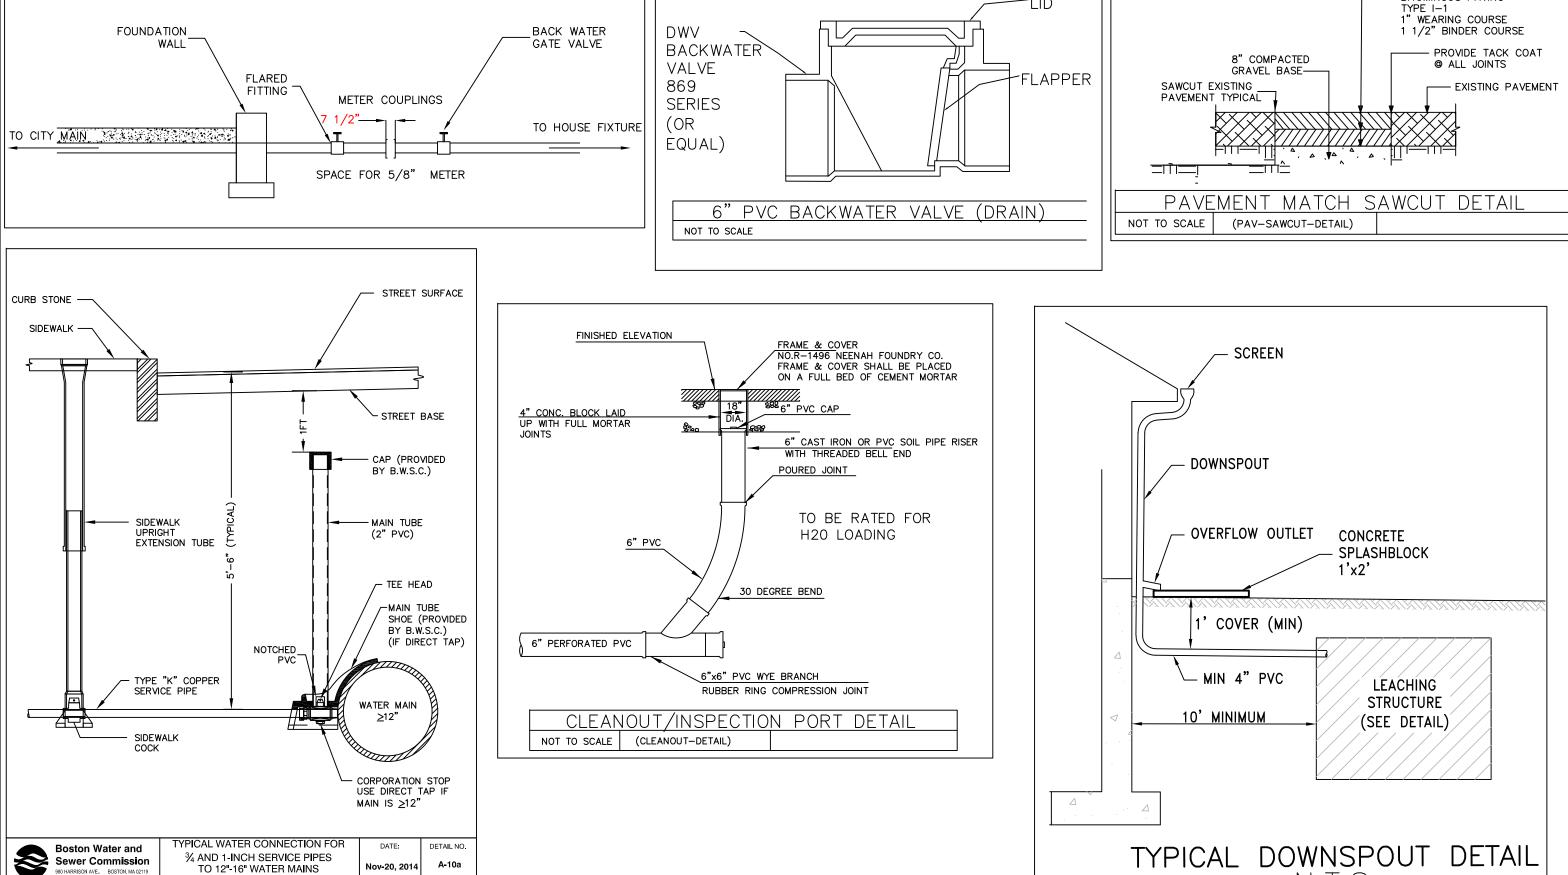


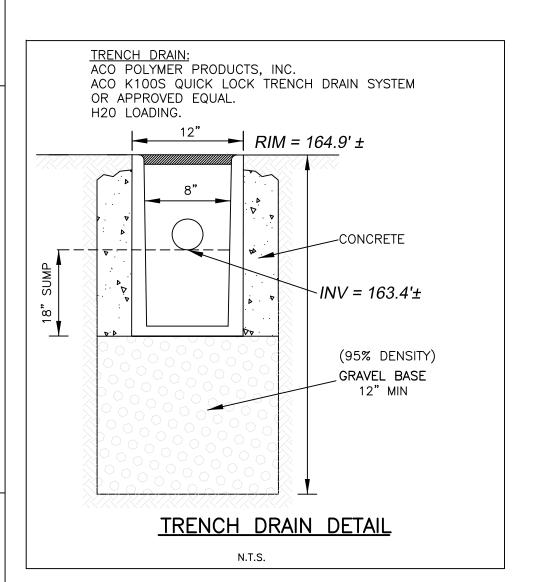


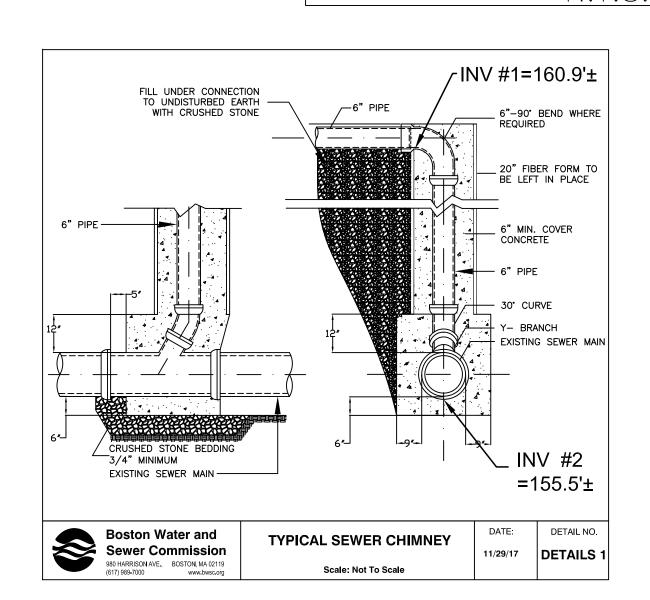

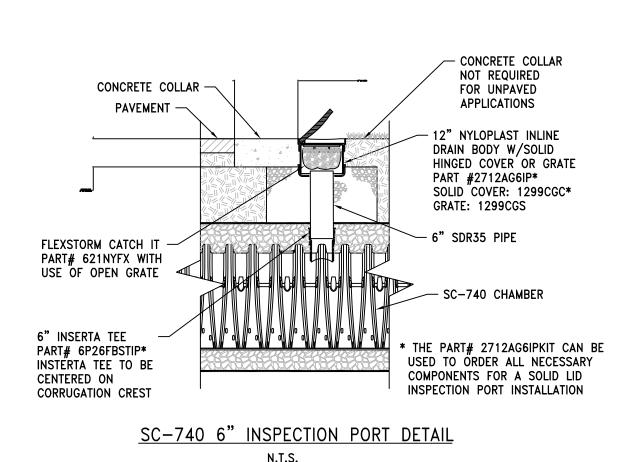

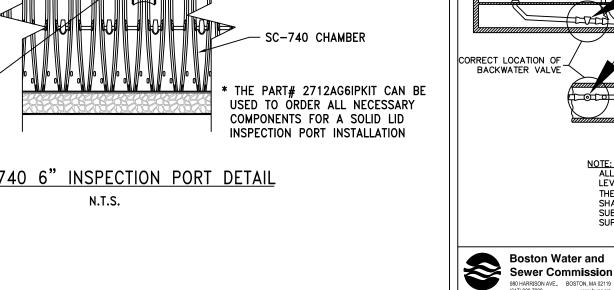


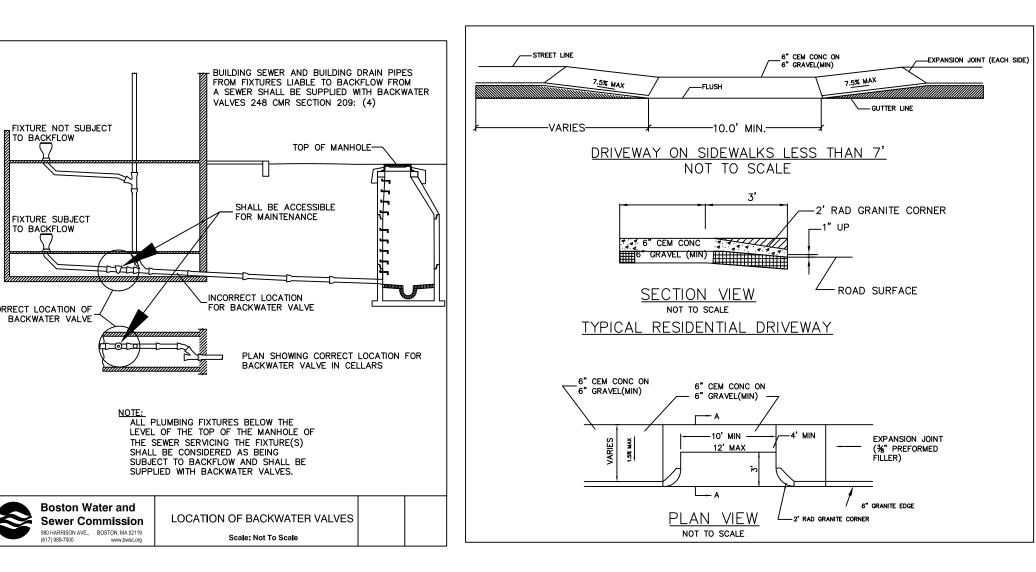

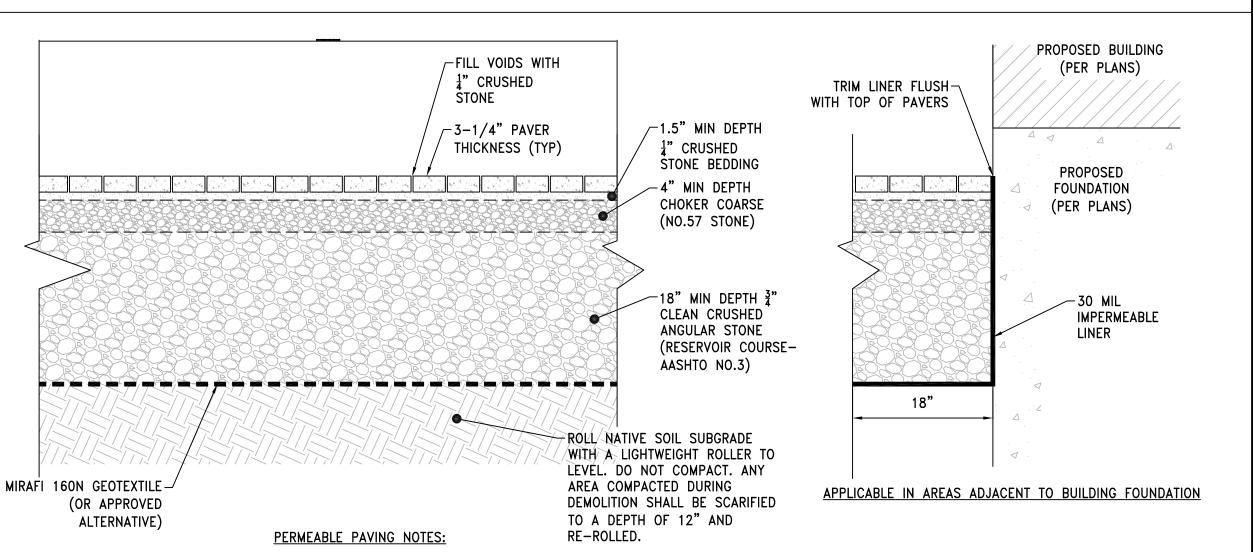

SCALE: NOT TO SCALE

1. PAVERS SHALL BE INSTALLED IN ACCORDANCE WITH MANUFACTURES SPECIFICATIONS. PERVIOUS PAVER DETAIL

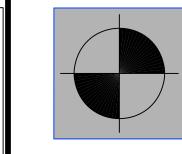




LAND SURVEYORS/CIVIL ENGINEERING CONSULTANTS 80 JEWETT ST, (SUITE 1) NEWTON, MA 02458 Tel:857-891-7478

617-782-1533

Fax:617-2025691

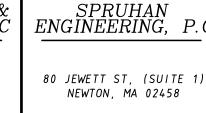

Tel: 617-816-0722 Email:edmond@spruhaneng.com

42 LILA ROAD, JAMAICA PLAIN, *MASSACHUSETTS*

CIVIL PLAN

REVISION BLOCK


BY	DESCRIPTION	DATE

All legal rights including, but not limited to, copyright and design patent rights, in the designs, arrangements and plans shown on this document are the property of Peter Nolan & Associates, LLC, or Spruhan Engineering, P.C. They may not be used or reused in whole or in part, except in connection with this project, without the prior written dimensions on these drawings shall dimensions. Contractors shall verify responsible dimensions and conditions on this and Spruhan Engineering, P.C., must be notified of any variation from the dimensions and conditions shown drawings.

DATE:	12/04/2024
DRAWN BY:	M.L
CHECKED BY:	E.S
APPROVED BY:	P.N

DETAILS

SHEET 2 OF 2

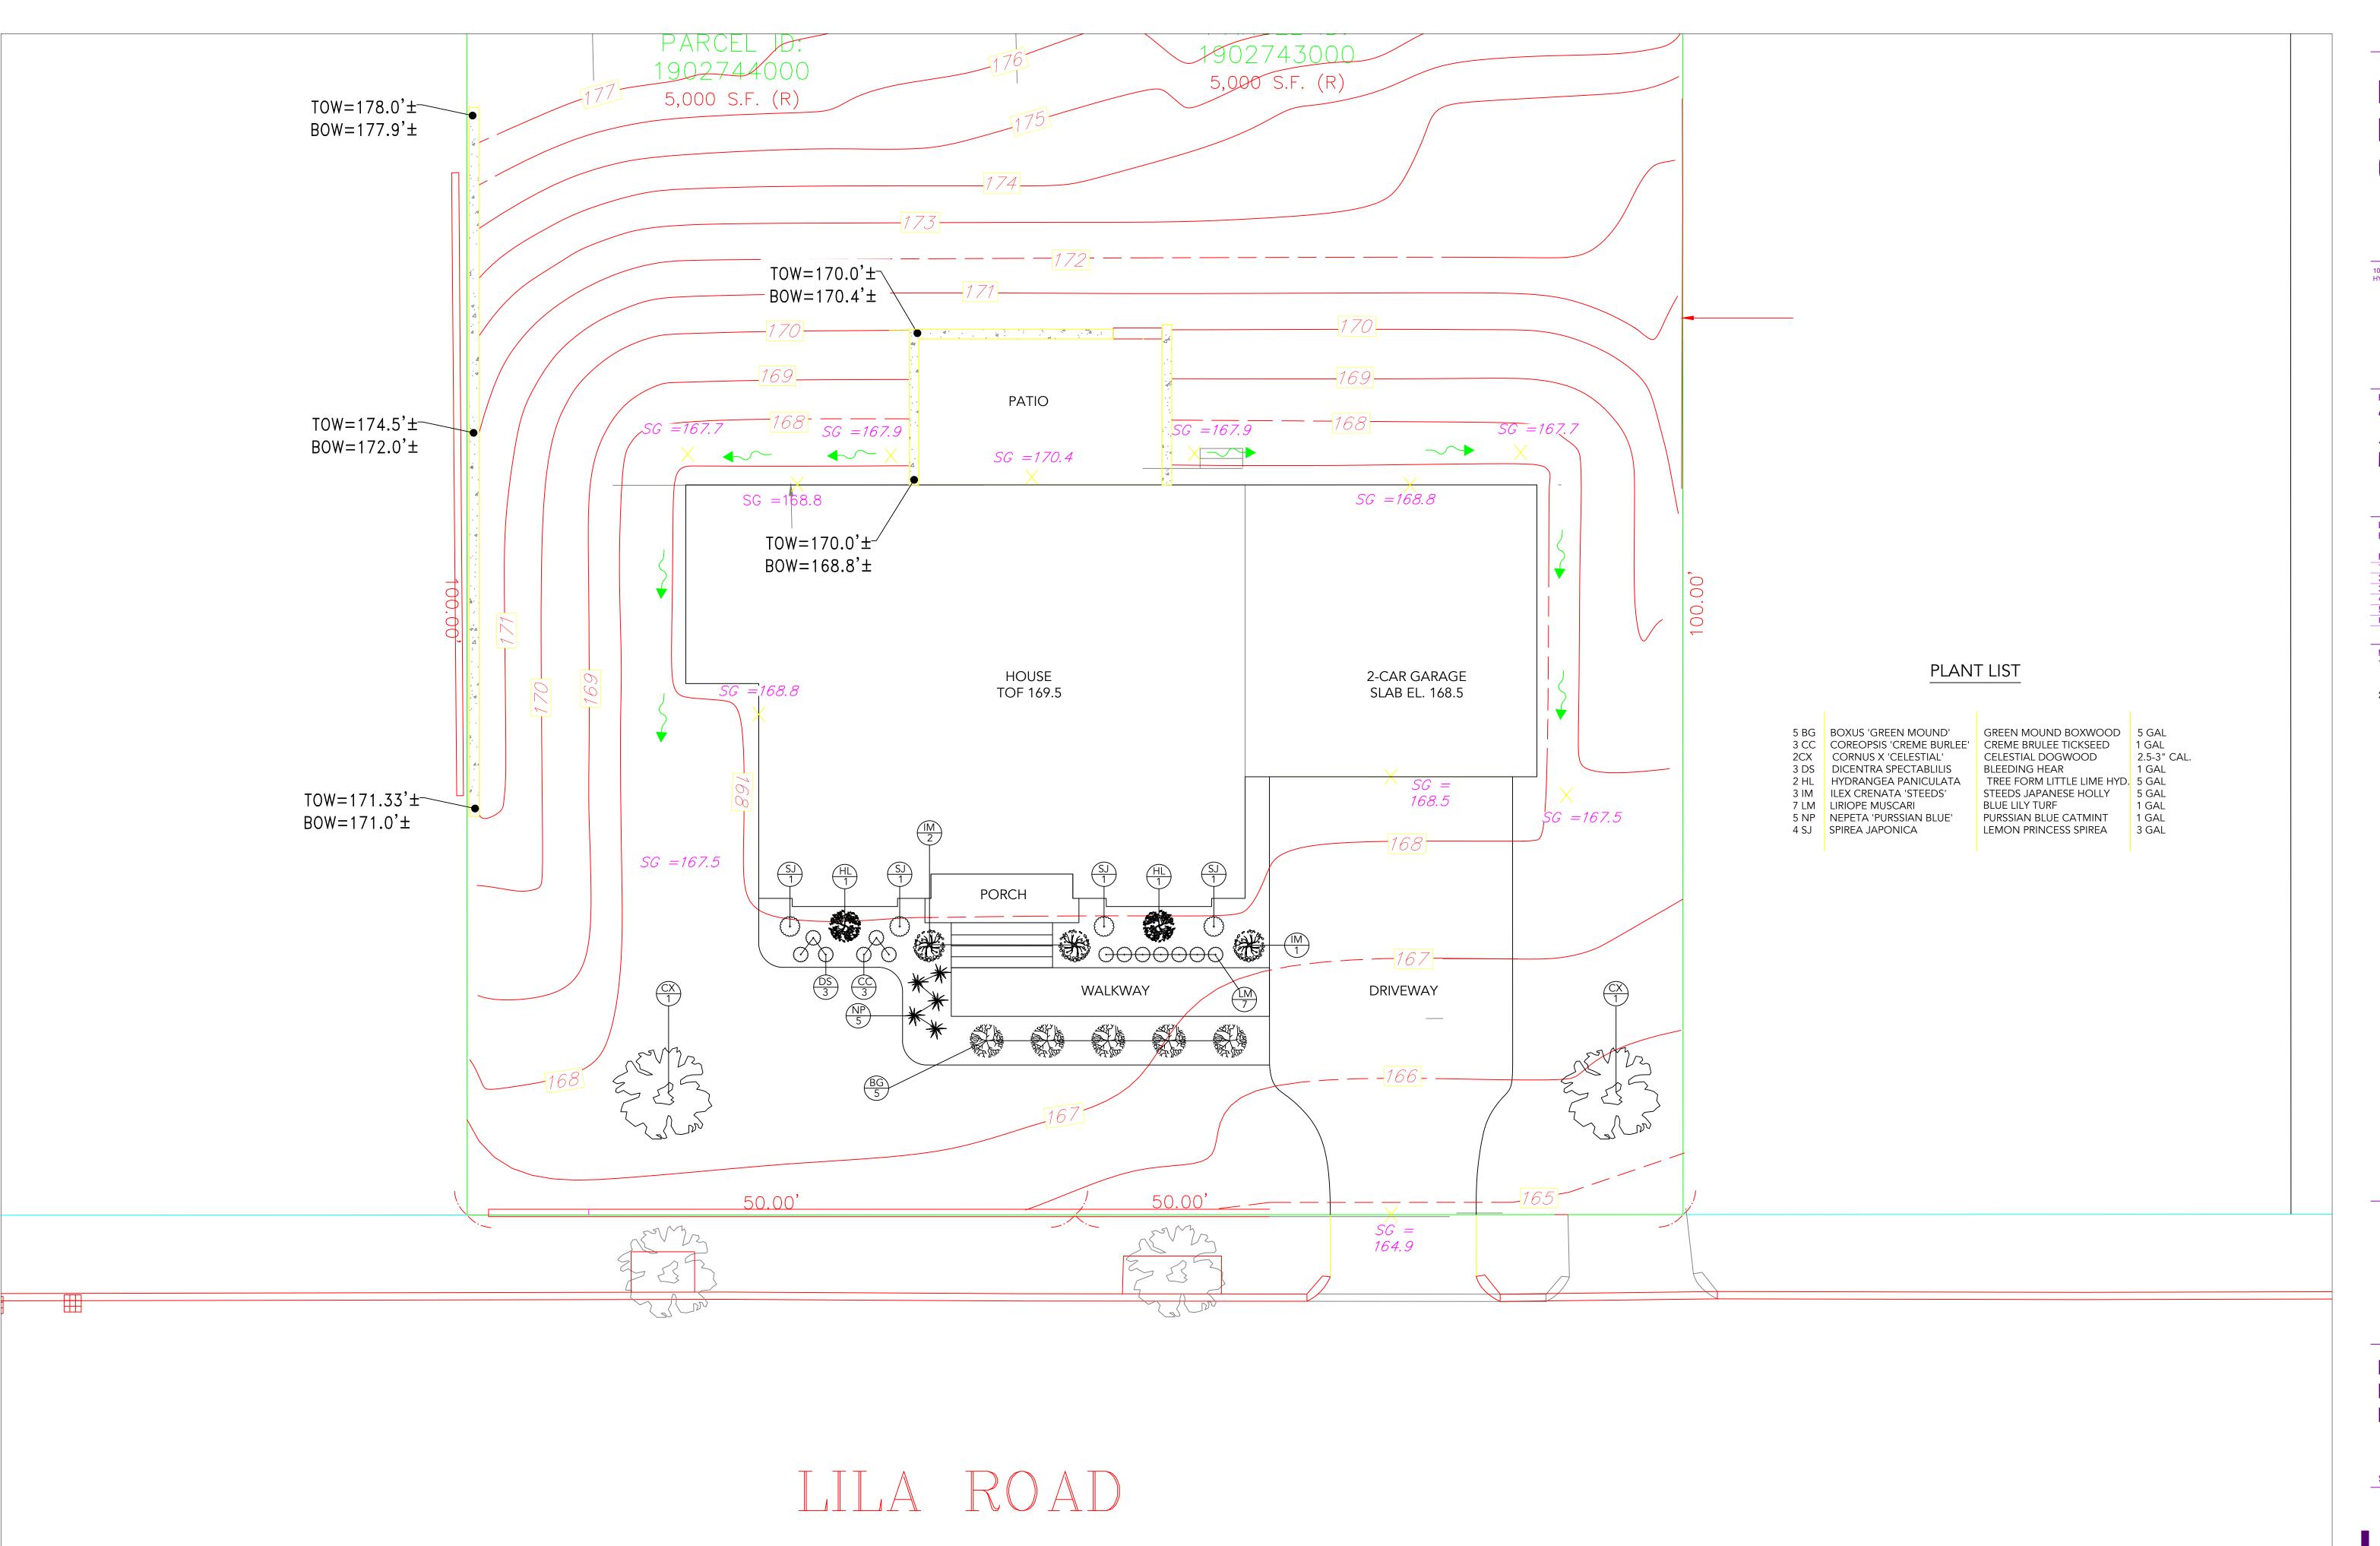

DISIPIO BUILDING GROUP, INC.

105 FAIRMOUNT AVENUE HYDE PARK, MA 02136

42 LILA ROAD JAMAICA PLAIN, MA

DATE: 12/16/2024 DATE PROJECT NO. 24014 NO.

REVISION DATE

1
2
3
4
5


NOTES:
1. ALL DIMENSIONS SHOWN ARE TO
F.O. STUD UNLESS OTHERWISE
NOTED.
2. HOUSE DATUM: X,X' = 0'-0"

PROPOSED LANDSCAPE PLAN

SCALE: SEE DRAW

L1.

DRAWN BY: JAD

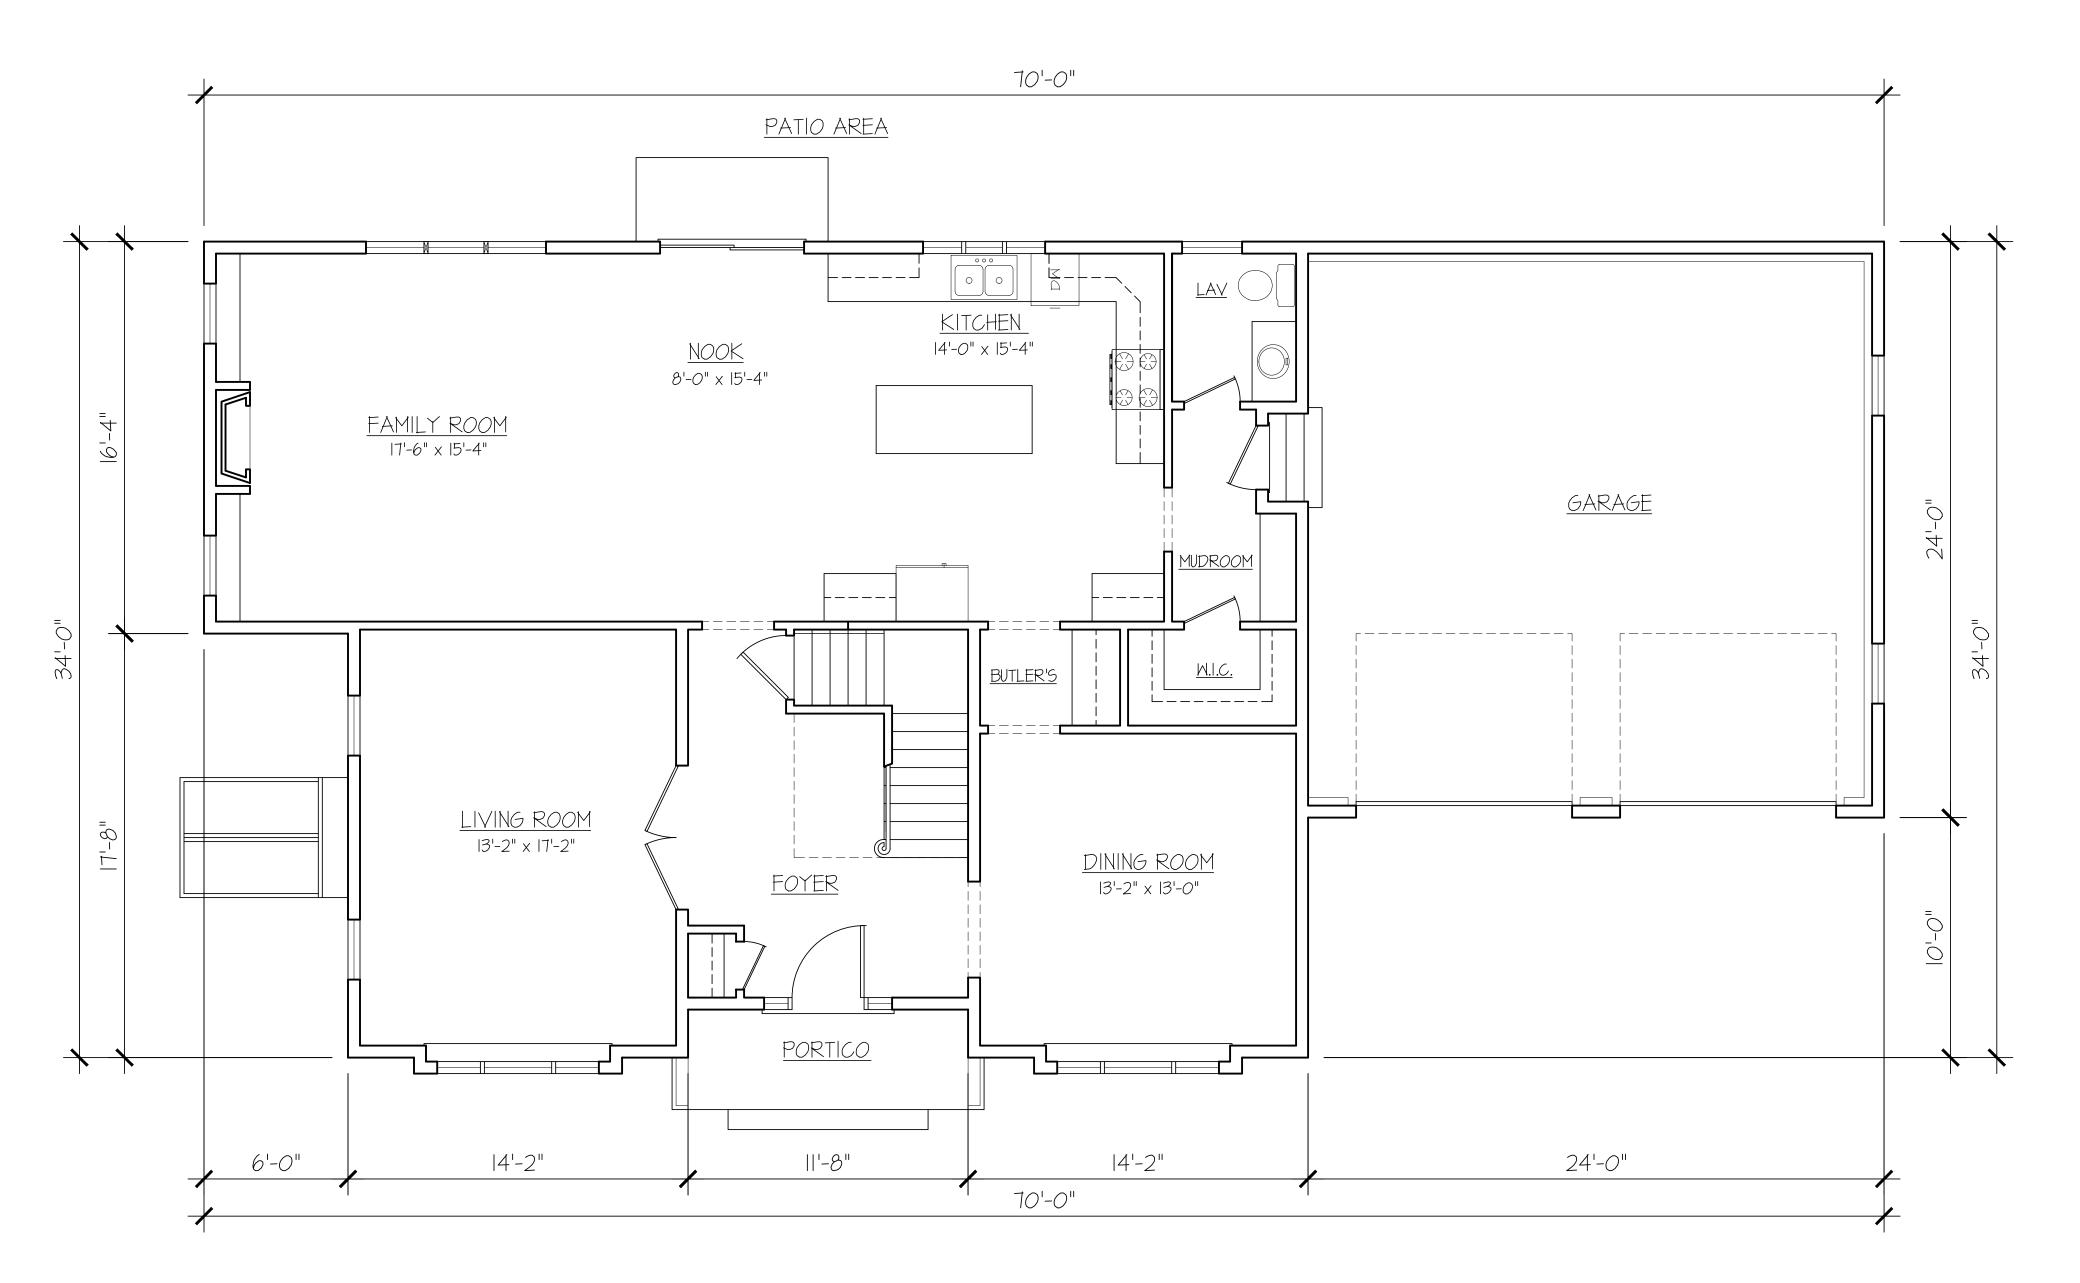

FIRST FLOOR PLAN

1/4" = 1'



35 Main Street Milford, MA 01757 (P) 781.407.0000 (P) 508.384.8838 Contact@HPADesign.com

PROPOSED DWELLING FOR:

DISIPIO BUILDING GROUP

42 LILA RD JAMAICA PLAIN, MA

A 12/16/24 ISS FOR BOARD REVIEW
REVISIONS:

PROJECT #: 20240099

DECEMBER 6, 2024

DRAWN BY: DEY

SCALE:

CHECKED BY: HPA

SEE DRAWING


SHEET TITLE:

FIRST FLOOR PLAN

These drawings and specifications were prepared for use at the location indicated hereon. Publication and use is expressly limited to the identified location. Re—use or reproduction by any method, in whole or in part, is prohibited without the written permission of Architect. © 2024

1st FLOOR LIVING SPACE - 1,428 SF

The square footage indicated is living space calculated from the exterior face of wall stud. It does not include decks, porches, garages, volumes, uninhabitable & unconditioned spaces. All dimensions and square footages are approximate and subject to change without notice. HPA Design, Inc. assumes no responsibility for technical, typographical, and/or other inaccuracies or errors. © 2019 HPA Design, Inc.

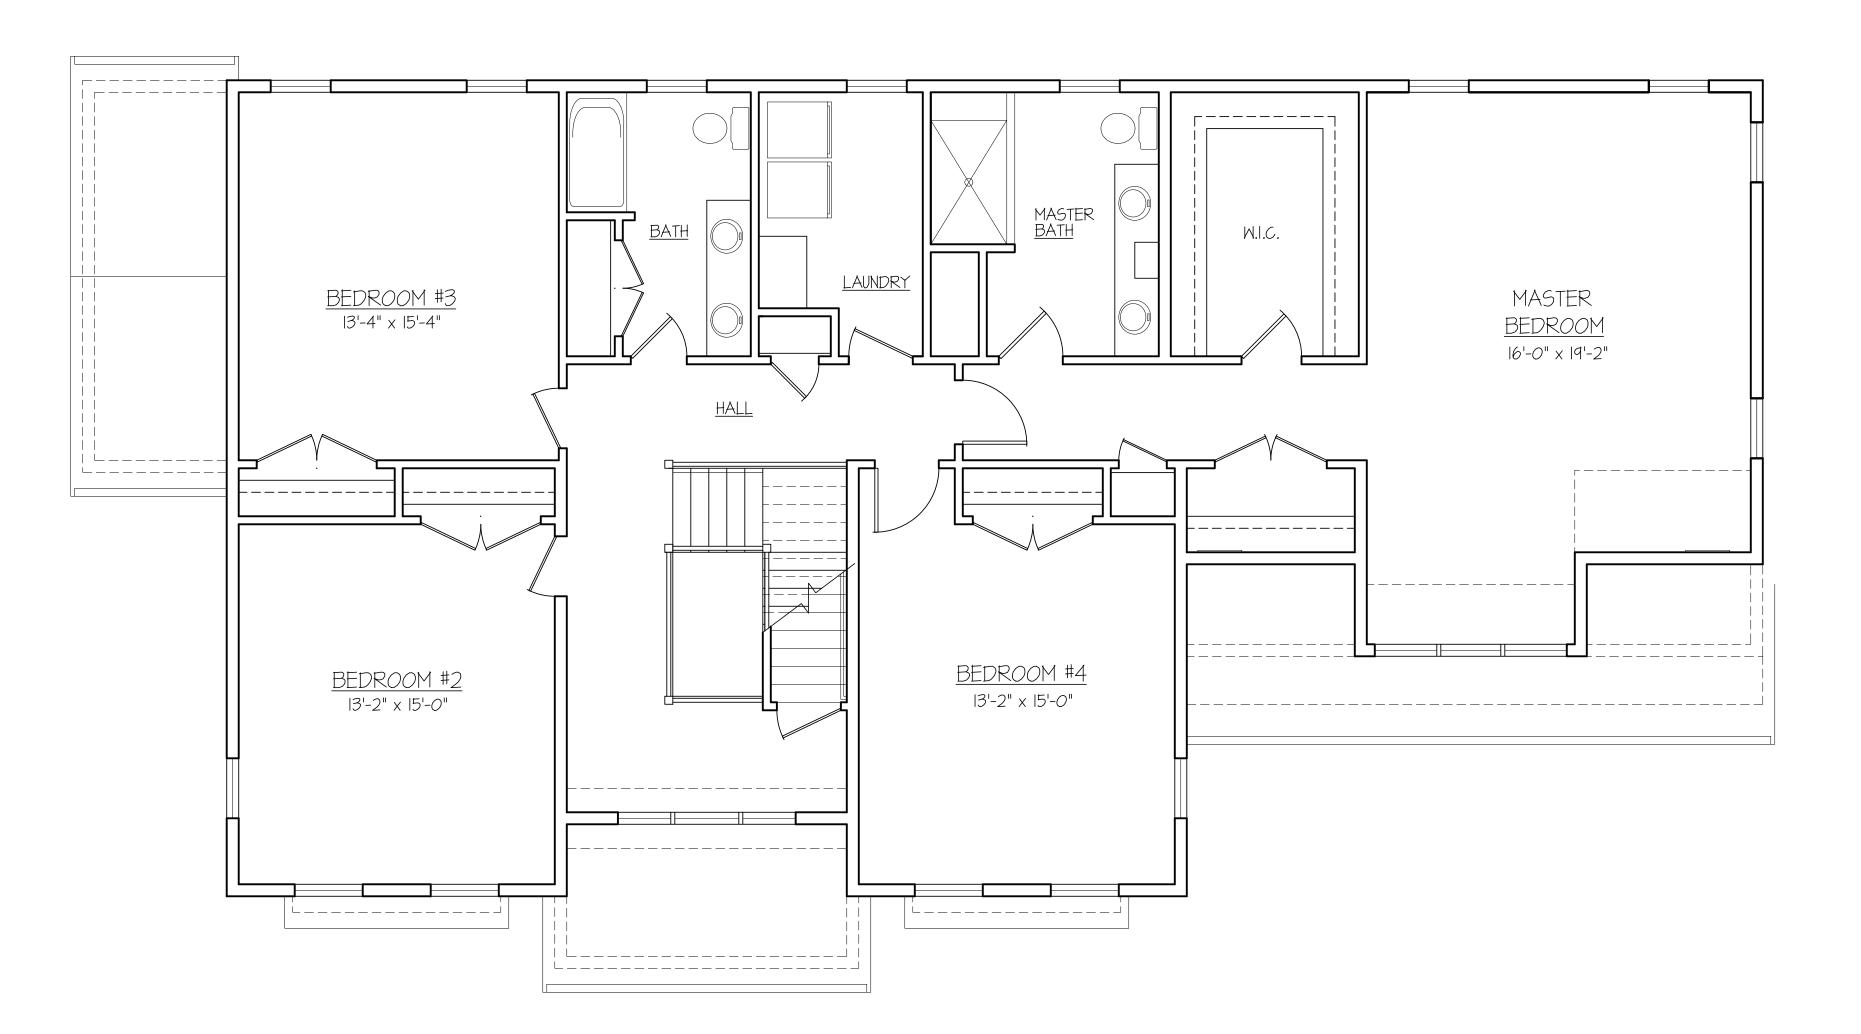

SECOND FLOOR PLAN



35 Main Street
Milford, MA 01757
(P) 781.407.0000
(P) 508.384.8838
Contact@HPADesign.com

PROPOSED DWELLING FOR:

DISIPIO BUILDING GROUP

42 LILA RD JAMAICA PLAIN, MA

A 12/16/24 ISS FOR BOARD REVIEW
REVISIONS:

PROJECT #: 20240099

DECEMBER 6, 2024

DRAWN BY: DEY

CHECKED BY: HPA

SCALE: SEE DRAWING


SHEET TITLE:


SECOND FLOOR PLAN

These drawings and specifications were prepared for use at the location indicated hereon. Publication and use is expressly limited to the identified location. Re—use or reproduction by any method, in whole or in part, is prohibited without the written permission of Architect. © 2024

2nd FLOOR LIVING SPACE - 1,823 SF

The square footage indicated is living space calculated from the exterior face of wall stud. It does not include decks, porches, garages, volumes, uninhabitable & unconditioned spaces. All dimensions and square footages are approximate and subject to change without notice. HPA Design, Inc. assumes no responsibility for technical, typographical, and/or other inaccuracies or errors. © 2019 HPA Design, Inc.

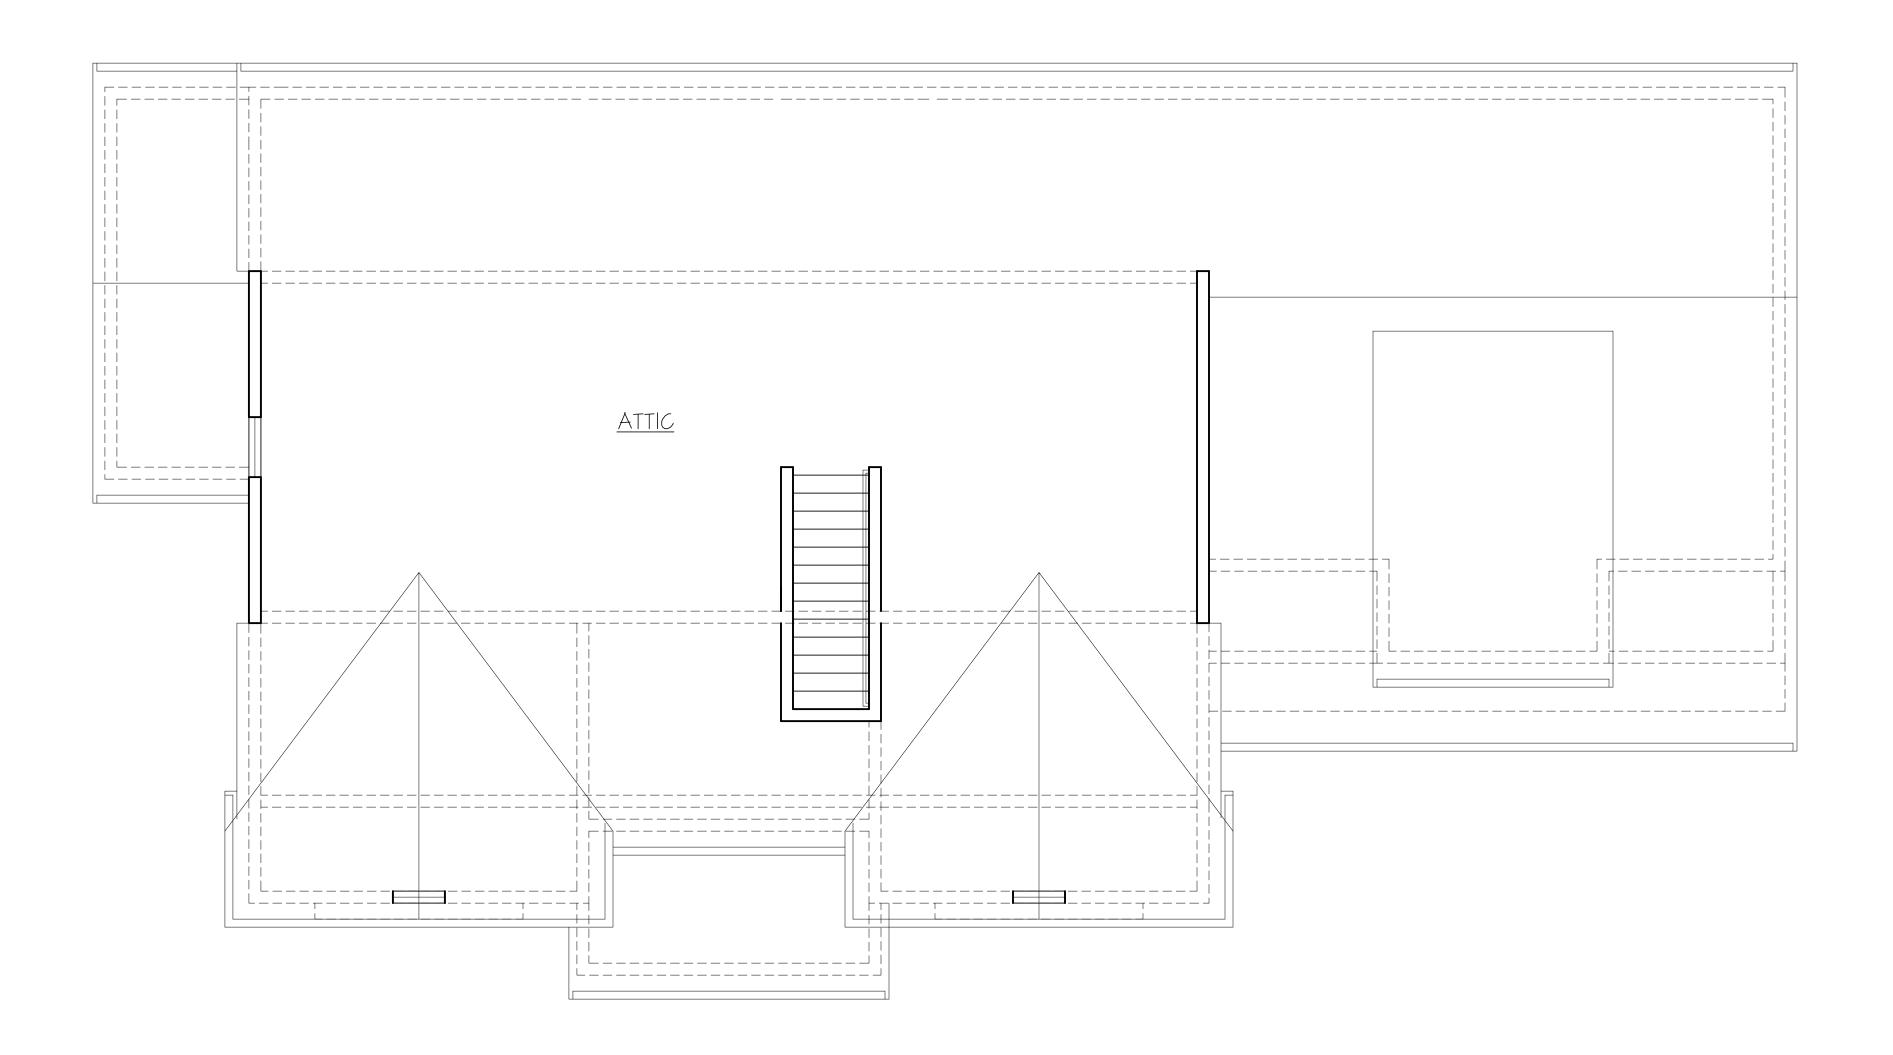

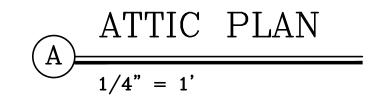



35 Main Street Milford, MA 01757 (P) 781.407.0000 (P) 508.384.8838 Contact@HPADesign.com

PROPOSED DWELLING FOR:

DISIPIO BUILDING GROUP

42 LILA RD JAMAICA PLAIN, MA

A 12/16/24 ISS FOR BOARD REVIEW
REVISIONS:

PROJECT #: 20240099

DECEMBER 6, 2024

DRAWN BY: DEY

CHECKED BY: HPA

SHEET TITLE:

SEE DRAWING

ATTIC PLAN


SCALE:

These drawings and specifications were prepared for use at the location indicated hereon. Publication and use is expressly limited to the identified location. Re—use or reproduction by any method, in whole or in part, is prohibited without the written permission of Architect. © 2024





MANUFACTURER: PELLA LIFESTYLE SERIES - BLACK EXTERIOR			
TAG	MODEL#	DESCRIPTION	
Α	2965	SINGLE DOUBLE-HUNG	
В	7282	SLIDING PATIO DOOR	
C	2165/3765/2165	DOUBLE-HUNG COMBO	
Dt	2941-3	TRIPLE DOUBLE-HUNG (TEMPERED)	
E	2 4 -3	TRIPLE CASEMENT	
F	3232-3	TRIPLE AWNING	
6	2957	SINGLE DOUBLE-HUNG	
Н	2525	AMNING	
J	2953	SINGLE DOUBLE-HUNG	
K	2947	SINGLE DOUBLE-HUNG	
Kt	2947	SINGLE DOUBLE-HUNG (TEMPERED)	

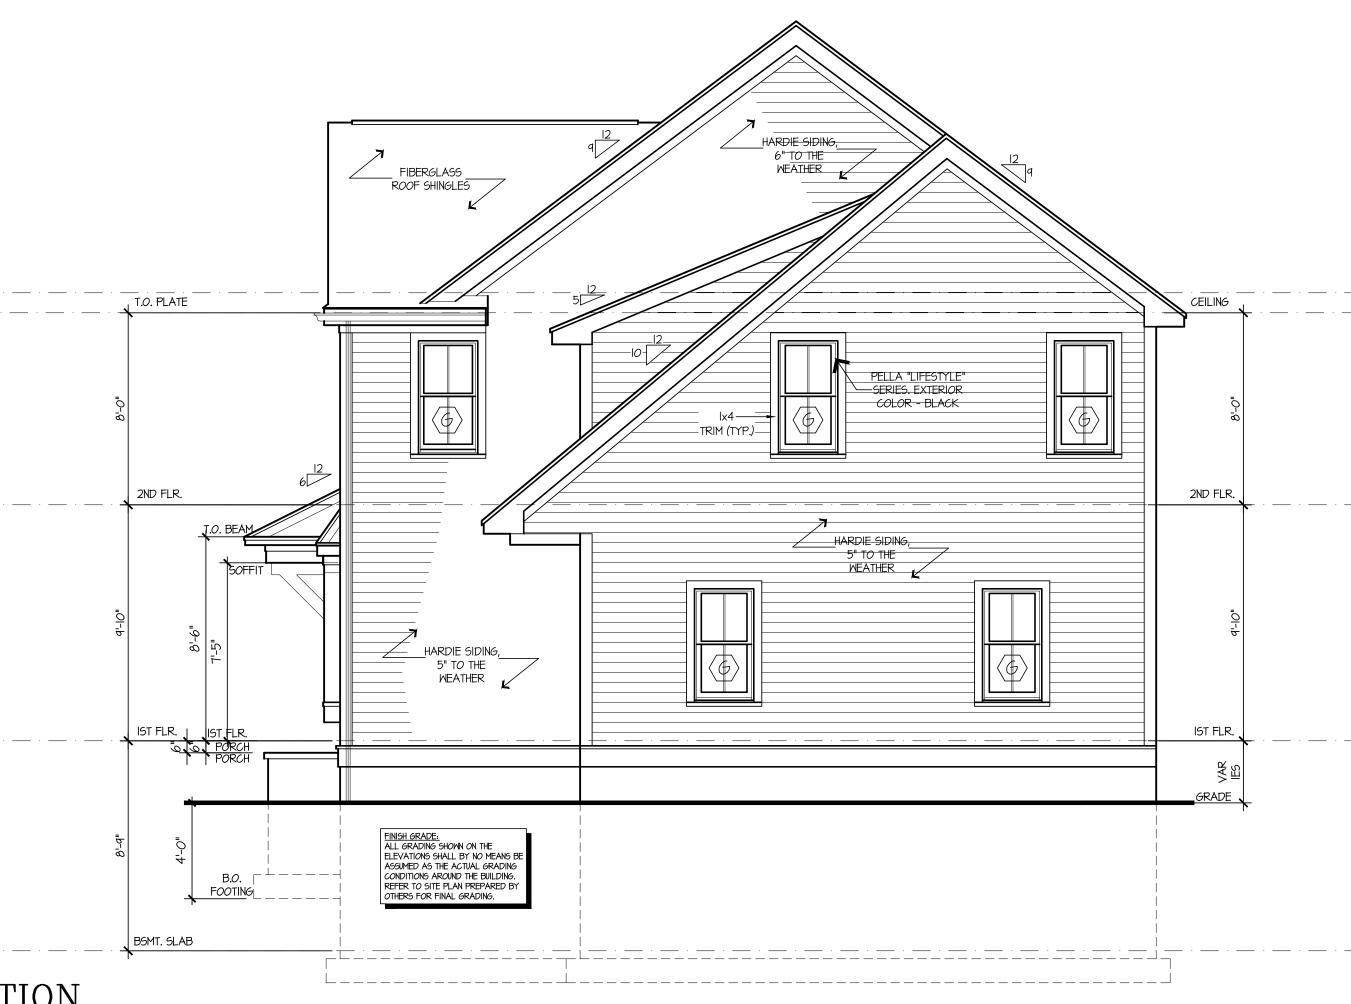

HPA
Design, Inc.
ARCHITECTS

35 Main Street Milford, MA 01757 (P) 781.407.0000 (P) 508.384.8838 Contact@HPADesign.com

PROPOSED DWELLING FOR:

DISIPIO BUILDING GROUP

42 LILA RD JAMAICA PLAIN, MA

	Α	12/16/24	ISS FOR BOARD REVIEW		
R	REVISIONS:				
F	PROJECT #: 20240099				

DECEMBER 6, 2024

DRAWN BY: DEY

CHECKED BY: HPA

SCALE: SEE DRAWING

SHEET TITLE:


ELEVATIONS


These drawings and specifications were prepared for use at the location indicated hereon. Publication and use is expressly limited to the identified location. Re—use or reproduction by any method, in whole or in part, is prohibited without the written permission of Architect. © 2024


RIGHT SIDE ELEVATION

1/4" = 1'



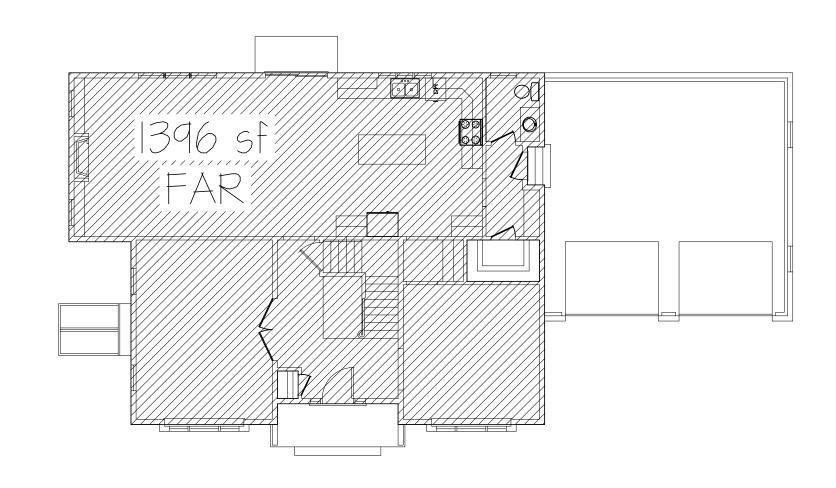

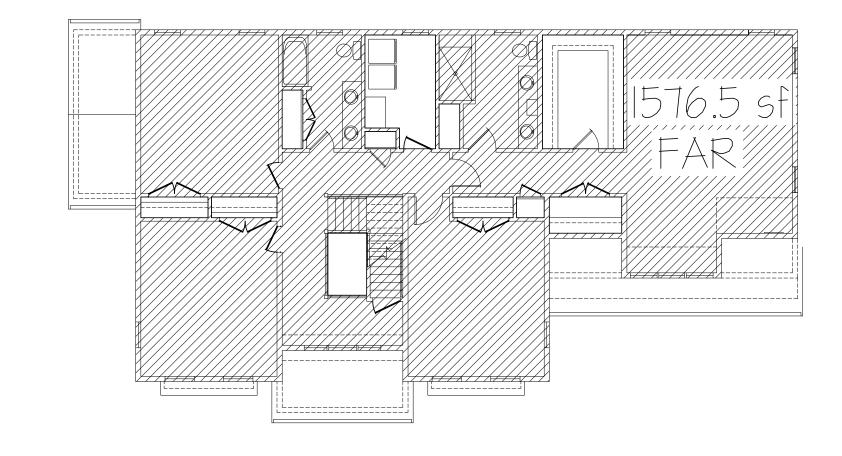

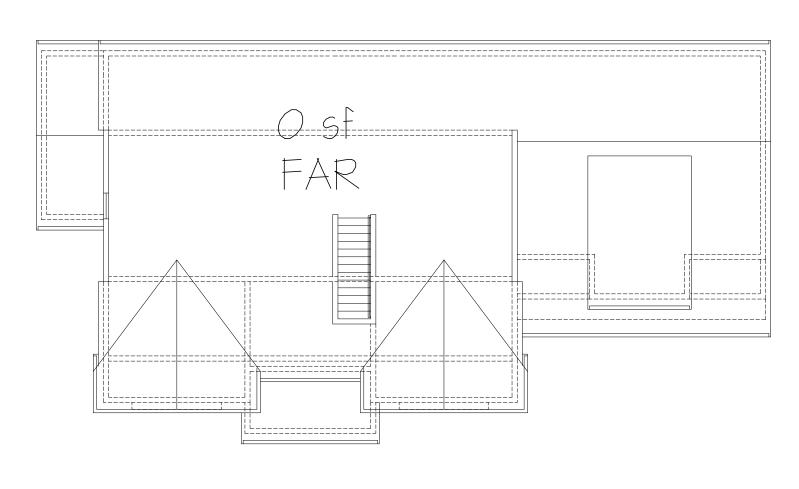

1st FLOOR

2nd FLOOR

ATTIC

LOT INFORMATION

PROPOSED GROSS FLOOR AREA INFORMATION

1396 sf Gross Floor Area Ist Floor Gross Floor Area 2nd Floor 1576.5 sf Gross Floor Area Upper Floor O sf

Total Proposed Gross Floor Area 2,972.5 sf Lot Area 10,000 sf +/-*

Proposed FAR 0.29725 < Max. Allowed FAR 0.30

35 Main Street Milford, MA 01757 (P) 781.407.0000 (P) 508.384.8838 Contact@HPADesign.com

Design, Inc.

ARCHITECTS

PROPOSED DWELLING FOR:

DISIPIO **BUILDING GROUP**

42 LILA RD JAMAICA PLAIN, MA

A 12/16/24 ISS FOR BOARD REVIEW **REVISIONS:** PROJECT #: 20240099

DECEMBER 6, 2024

DRAWN BY: DEY

CHECKED BY: HPA


SEE DRAWING SCALE:

SHEET TITLE:

AREA ANALYSIS

These drawings and specifications were prepared for use at the location indicated hereon. Publication and use is expressly limited to the identified location. Re-use or reproduction by any method, in whole or in part, is prohibited without the written permission of Architect. © 2024

 $\mathbb{Z}1.1$

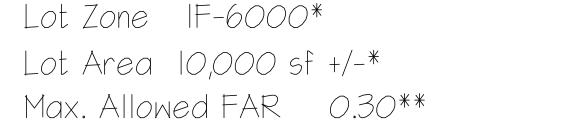

Max. Gross Floor Area Allowed 3,000sf *

* Note: LOT AREA ETC., WAS TRANSFERED FROM DRAWINGS PREPARED BY; PETER NOLAN \$ ASSOCIATES, LLC., dated 11/26/2024

** Note: MAXIMUM ALLOWABLES TRANSFERED FROM BRA CHARTS